
3420 ROCHESTER ROAD

3420 ROCHESTER ROAD
ROCHESTER HILLS, OAKLAND COUNTY, MICHIGAN



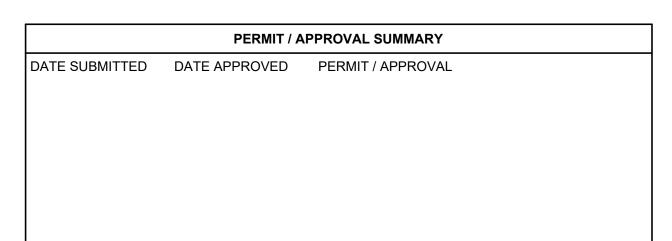

JNRNB2022-0009 PSP2022-0020 Revision #2 Received 4/22/24

City of Rochester
Hills Planning &
Economic
Development



Site Plan Review Reviewed for compliance with City Ordinance, Building and Fire Codes Conditions and mark-ups noted throughout plan set must be addressed prior to final



Department	Reviewer Approved		
Assessing	Assessing	Yes	
Building	Mark Artinian 248-841-2446 ArtinianM@RochesterHills.org	No	
Engineering - Utilities	Jason Boughton 248-841-2490 BoughtonJ@RochesterHills.org	1	
Engineering Legal	Jenny McGuckin 248-841-2494 mcguckinj@rochesterhills.org NO Date: 05/02/2024		
Fire	Lt. Jon Mills 248-841-2708 MillsJ@RochesterHills.org	No	
Natural Resources	Matt Einheuser 248-841-2551 EinheuserM@RochesterHills.org		
Planning	Chris McLeod 248-841-2572 No mcleodc@RochesterHills.org		
Traffic	Keith Depp 248-841-2503	No	





For all conditional uses, a "Conditional Use Proposed Sign" shall be placed onsite no less than fifteen (15) days prior to the public hearing date. Such sign shall be compliant with Section 138-1.203 of City Ordinances.

Next Steps: Submit revised site plans addressing reviewers comments.

DeppK@RochesterHills.org



DESIGN TEAM

OWNER/APPLICANT/DEVELOPER CIVIL ENGINEER

3420 ROCHESTER ROAD, LLC
29200 NORTHWESTERN HWY, SUITE 450
FARMINGTON HILLS, MI 48334
CONTACT: KENNY KOZA
PHONE: 248.770.0204
EMAIL: KENNY@AZOKGROUP.COM

PERCENTAGE
PERCENTAGE
PHONE
PERCENTAGE
PERCENTAGE
PHONE
PERCENTAGE

PEA GROUP
2430 ROCHESTER COURT, STE. 100
TROY, MI 48083-1872
CONTACT: JAMES P. BUTLER, PE
PHONE: 844.813.2949
EMAIL: JBUTLER@PEAGROUP.COM

ARCHITECT

GAV & ASSOCIATES INC. 24001 ORCHARD LAKE RD #180a FARMINGTON, MI 48336 CONTACT: MEL BEBA PHONE: 248.985.9101 EMAIL: MEL@GAVASSOCIATES.COM


LANDSCAPE ARCHITECT

PEA GROUP
7927 NEMCO WAY, STE. 115
BRIGHTON, MI 48116
CONTACT: JANET EVANS, PLA
PHONE: 844.813.2949
EMAIL: JEVANS@PEAGROUP.COM

W. AUBURN ROAD WOOD ROOMESTER ROAD (W-150) NAWAKWA RD NORTH LOCATION MAP NO SCALE

PENA GROUP

INDEX OF DRAWINGS		
NUMBER	TITLE	
	COVER SHEET	
C-1.0	TOPOGRAPHIC SURVEY	
C-3.1	PRELIMINARY SITE PLAN	
C-3.2	FIRE TRUCK TURNING PLAN	
C-4.0	PRELIMINARY GRADING PLAN	
C-6.0	PRELIMINARY UTILITY PLAN	
C-9.1	NOTES AND DETAILS	
C-9.2	NOTES AND DETAILS	
C-9.3	DETAILS	
C-9.4	M.D.O.T. DETAILS	
L-1.0	LANDSCAPE PLAN	
L-1.1	LANDSCAPE DETAILS	
T-1.0	TREE PLAN	
A.101	FLOOR PLAN	
A.102	MEZZ FLOOR PLAN	
A.201	EXTERIOR ELEVATIONS	
A.202	EXTERIOR RENDERINGS	
SP.101	SITE LIGHTING PHOTOMETRIC PLAN	
SP.102	SITE LIGHTING CUT SHEET	

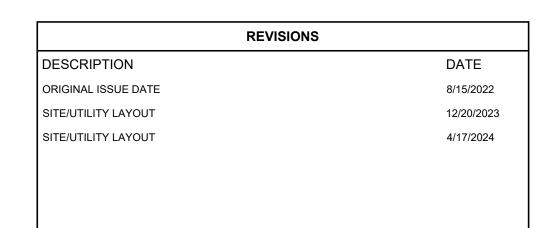



The applicant needs to submit a Land Improvement Permit (LIP) application with engineer's estimate, fee and construction plans to proceed with the construction plan review process.

UL O

BENCHMARKS (GPS DERIVED - NAVD88 DATUM) BM #300 ARROW ON HYDRANT AT THE NORTHWEST CORNER OF ROCHESTER ROAD AND NAWAKWA ELEV. - 740.28 BM #301 SET BENCHTIE IN SOUTH FACE OF UTILITY POLE AT THE NORTHWEST CORNER OF NAWAKWA

ROAD AND CHERRY ROAD. ELEV. - 749.41 BM #302 ARROW ON HYDRANT EAST OF HOUSE #3466

CHERRY ROAD. ELEV. - 748.12

BM #303 DIMPLE ON NORTHWEST BOLT OF STRAIN POLE JUST NORTH OF THE M-59 WEST RAMP. ELEV. - 738.60

FLOODPLAIN NOTE: BY GRAPHICAL PLOTTING, SITE IS WITHIN ZONE 'X', AREA DETERMINED TO BE OUTSIDE OF THE 0.2% ANNUAL CHANCE FLOODPLAIN PER NON-PRINTED PANEL FLOOD INSURANCE RATE MAP NUMBER 26125C-0394F, DATED JANUARY 16


LEGAL DESCRIPTION:

(TAX PARCEL 15-34-277-006) (PER FIRST AMERICAN TITLE INSURANCE COMPANY, POLICY No. OP 405833,


Real property in the City of Rochester Hills, County of Oakland, State of Michigan, described as follows:

Part of Lots 64 and 65 of Avoncrofts Subdivision, as recorded in Uber 19 of Plats, Page 15, Oakland County Records, being more particularly described as follows: Beginning at a point on the South line of Lot 64 of said Avoncrofts Subdivision, said line being also the East and West 1/4 line of Section 34, Township 3 North, Range 11 East, Avon Township, Oakland County, Michigan, said point being S88°41'39"W as measured along said 1/4 Section line, a distance of 90.73 feet from the East 1/4 corner of said Section 34; proceeding thence from said point of beginning, S88°41'39"W along the East and West 1/4 line of said Section 34, said line being also the South line of said Lot 64, a distance of 231.96 feet to the Southwest corner of said Lot 64; thence N05°09'40"E along the West line of Lots 64 and 65 of said Subdivision, a distance of 292.00 feet to the Northwesterly corner of said Lot 65; thence along the Northerly line of Lot 65, said line being also the Southerly line of Nawakwa Road (50 feet wide), along the arc of a curve, concave to the North, Radius 494.00 feet, an arc distance of 266.05 feet (chord bears S68°19'17"E 262.85 feet) to the Southwesterly corner of Nawakwa Road and Rochester Road (M-150) as widened; thence S02°32'47"W along the Westerly line of said Rochester Road (width varies), thru the interior of Lot 65 and into Lot 64, a distance of 158.01 feet to a point; thence S45°56'30"W along a limited access right of way line of the proposed M-59 Freeway, a distance of 43.97 feet to the point of beginning.


LEGEND:	
-OH-ELEC-W-O-<	EX. OH. ELEC, POLE & GUY WIRE
-UG-CATV-TV	EX. U.G. CABLE TV & PEDESTAL
-UG-COMM⊠-Ū-	EX. U.G. COMMUNICATION LINE, PEDESTAL & MANHOLE
-UG-ELEC-E)E(Ê)-	EX. U.G. ELEC, MANHOLE, METER & HANDHOLE
	EX. GAS LINE
© GAS	EX. GAS VALVE & GAS LINE MARKER
T I	EX. TRANSFORMER & IRRIGATION VALVE
	EX. WATER MAIN
V - W	EX. HYDRANT, GATE VALVE & POST INDICATOR VALVE
	EX. WATER VALVE BOX & SHUTOFF
	EX. SANITARY SEWER
© S	EX. SANITARY CLEANOUT & MANHOLE
©	EX. COMBINED SEWER MANHOLE
	EX. STORM SEWER
© §	EX. CLEANOUT & MANHOLE
	EX. SQUARE, ROUND, & BEEHIVE CATCH BASIN
o ^{Y.D.} ®	EX. YARD DRAIN & ROOF DRAIN
?	EX, UNIDENTIFIED STRUCTURE
M → *	EX. MAILBOX, SIGN & LIGHTPOLE
X	EX. FENCE
<u> </u>	EX, GUARD RAIL
*e ³⁶ .5,	EX. SPOT ELEVATION
670	EX. CONTOUR
عاد عاد عاد	EX. WETLAND
• ×	IRON FOUND / SET
ø ø	NAIL FOUND / NAIL & CAP SET
®	BRASS PLUG SET
 \(\overline{\ove	MONUMENT FOUND / SET
	SECTION CORNER FOUND
RMC	RECORDED / MEASURED / CALCULATED
REF	FERENCE DRAWINGS
WATER MAIN	"SKETCH OF UTILITIES" PER CITY OF ROCHESTER HILLS, RECEIVED 10-21-15
SANITARY SEWER	"SKETCH OF UTILITIES" PER CITY OF ROCHESTER HILLS, RECEIVED 10-21-15
STORM SEWER	"SKETCH OF UTILITIES" PER CITY OF ROCHESTER HILLS, RECEIVED 10-21-15
ELECTRIC TELEPHONE	HAVE NOT RECEIVED AS OF 10-30-15 HAVE NOT RECEIVED AS OF 10-30-15
GAS	"CONSUMERS ENERGY - QUARTER SECTION MAP 03-61-34-1, DATED 04-09-15"
CATV	HAVE NOT RECEIVED AS OF 10-30-15

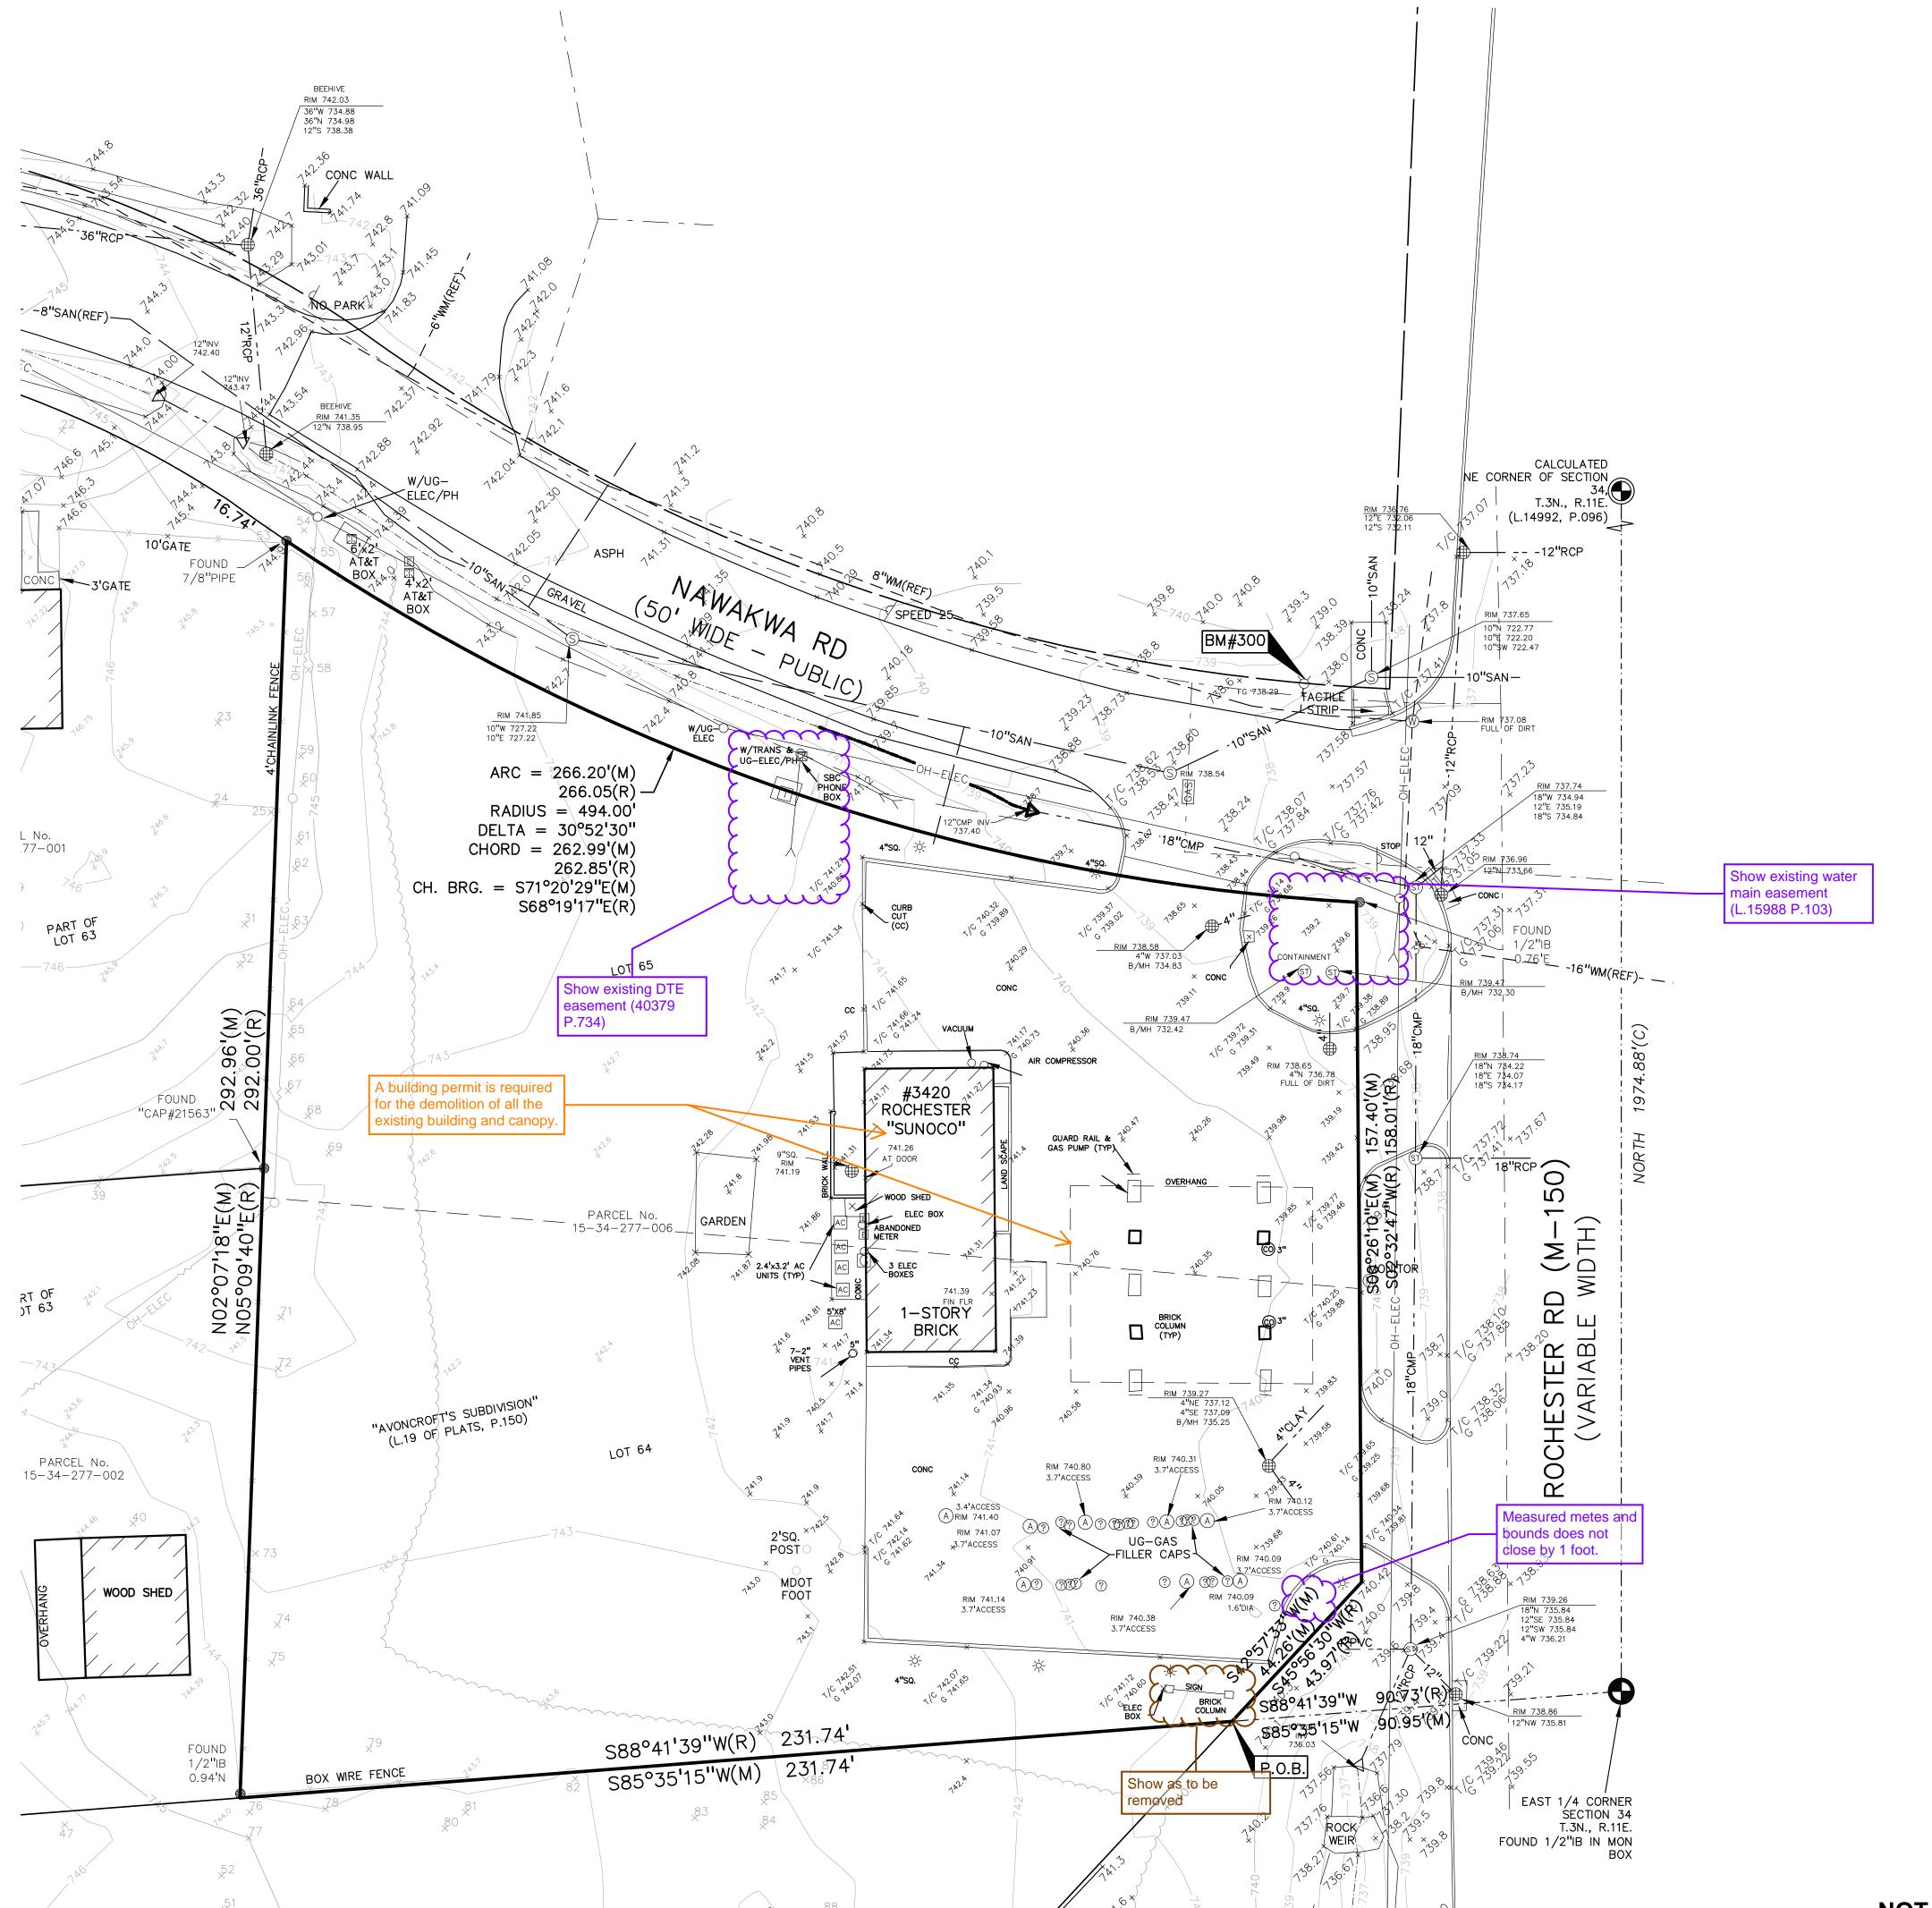



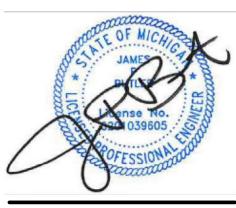



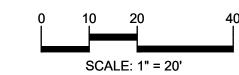



CAUTION!! THE LOCATIONS AND ELEVATIONS OF EXISTING UNDERGROUND UTILITIES AS SHOWN ON THIS DRAWING ARE ONLY APPROXIMATE. NO GUARANTEE IS EITHER EXPRESSED OR IMPLIED AS TO THE COMPLETENESS OR ACCURACY THEREOF. THE CONTRACTOR SHALL BE EXCLUSIVELY RESPONSIBLE FOR DETERMINING THE EXACT UTILITY LOCATIONS AND ELEVATIONS PRIOR TO THE START OF CONSTRUCTION.

CLIENT

3420 ROCHESTER ROAD, LLC 29200 NORTHWESTERN HIGHWAY, SUITE 450 FARMINGTON HILLS, MICHIGAN 48334

PROJECT TITLE

3420 ROCHESTER ROAD 3420 ROCHESTER ROAD ROCHESTER HILLS, OAKLAND COUNTY, MICHIGAN

REVISIONS	
SITE/UTILITY LAYOUT	12/20/23
SITE/UTILITY LAYOUT	04/17/24


ORIGINAL ISSUE DATE AUGUST 15, 2022 DRAWING TITLE

TOPOGRAPHIC SURVEY

	PEA JOB NO.	2021-011
	P.M.	LA
1 4	DN.	M
er Hills	DES.	SW
ent	DRAWING NUMBER	₹:

NOT FOR CONSTRUCTION CITY FILE #22-029 SECTION #34

C-1.0

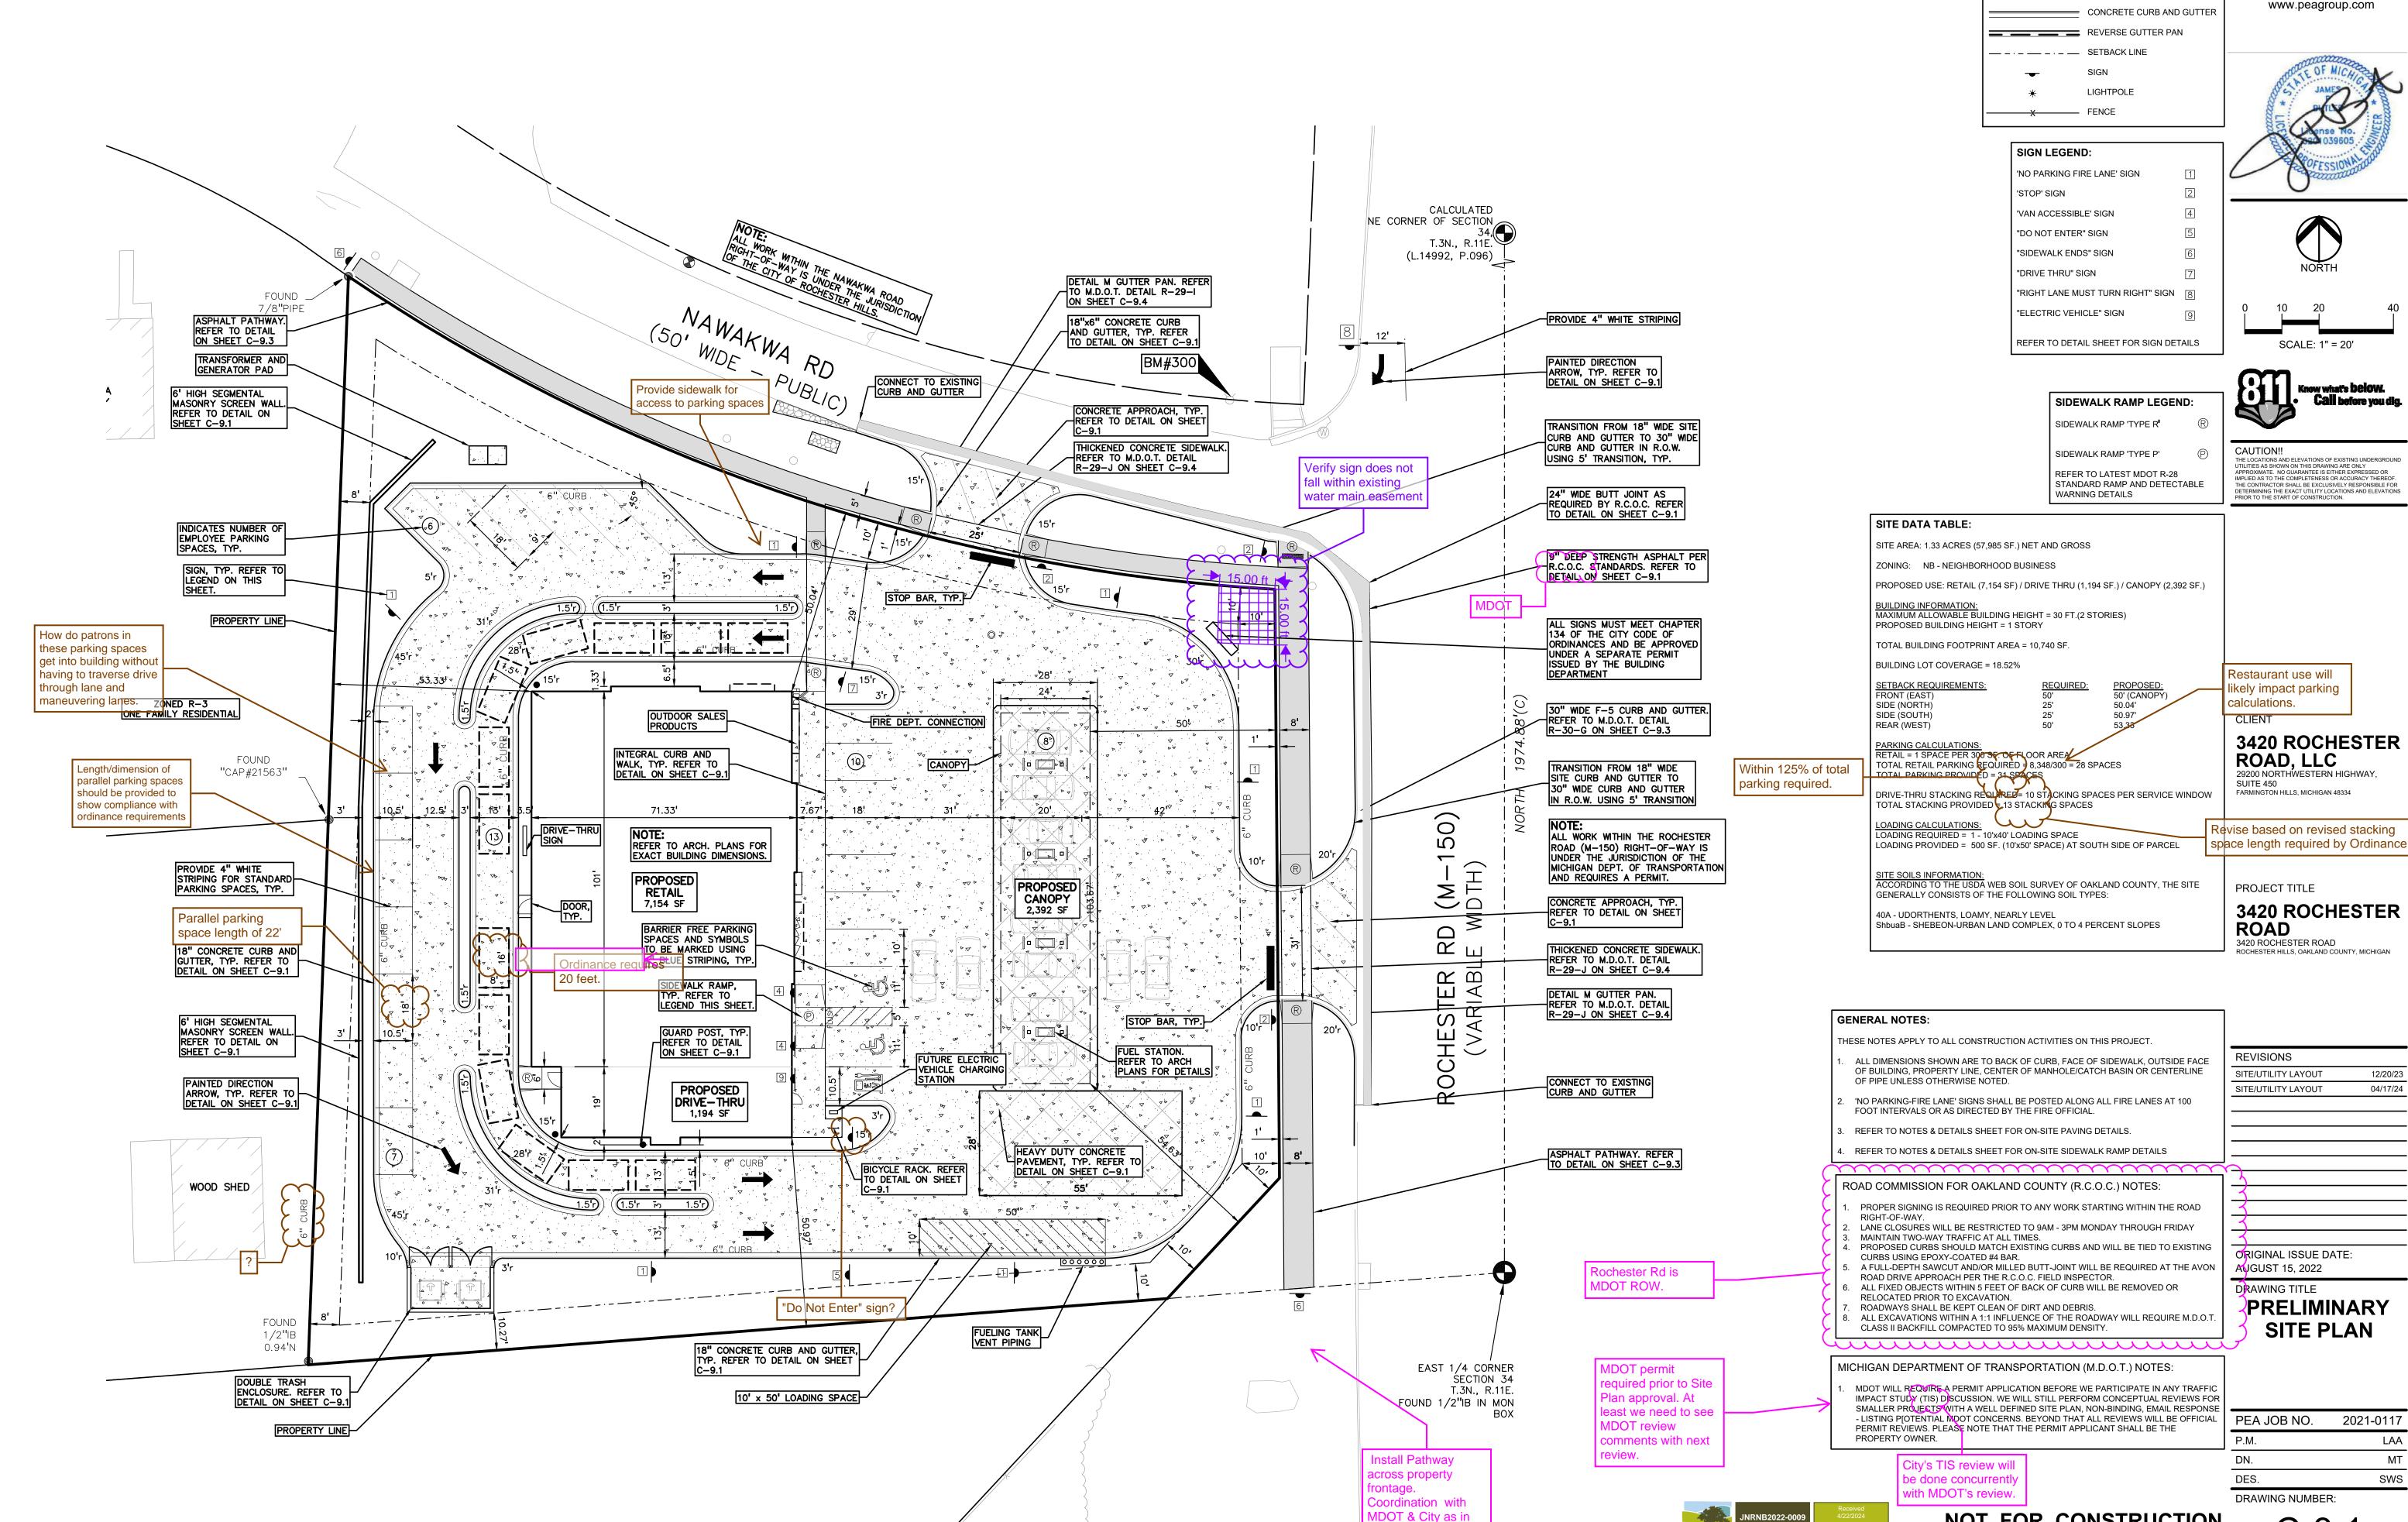

2027 MDOT/City plans to install pathway across the

M-59 bridge.

S:\PROJECTS\2021\2021—0117 ROCH HILLS FUEL RETAIL\ 10:52 AM RY:Leslie Accordo

NOT FOR CONSTRUCTION CITY FILE #22-029 SECTION #34

LEGEND:


CONCRETE PAVEMENT

GRAVEL

ASPHALT PAVEMENT


GROUP

t: 844.813.2949

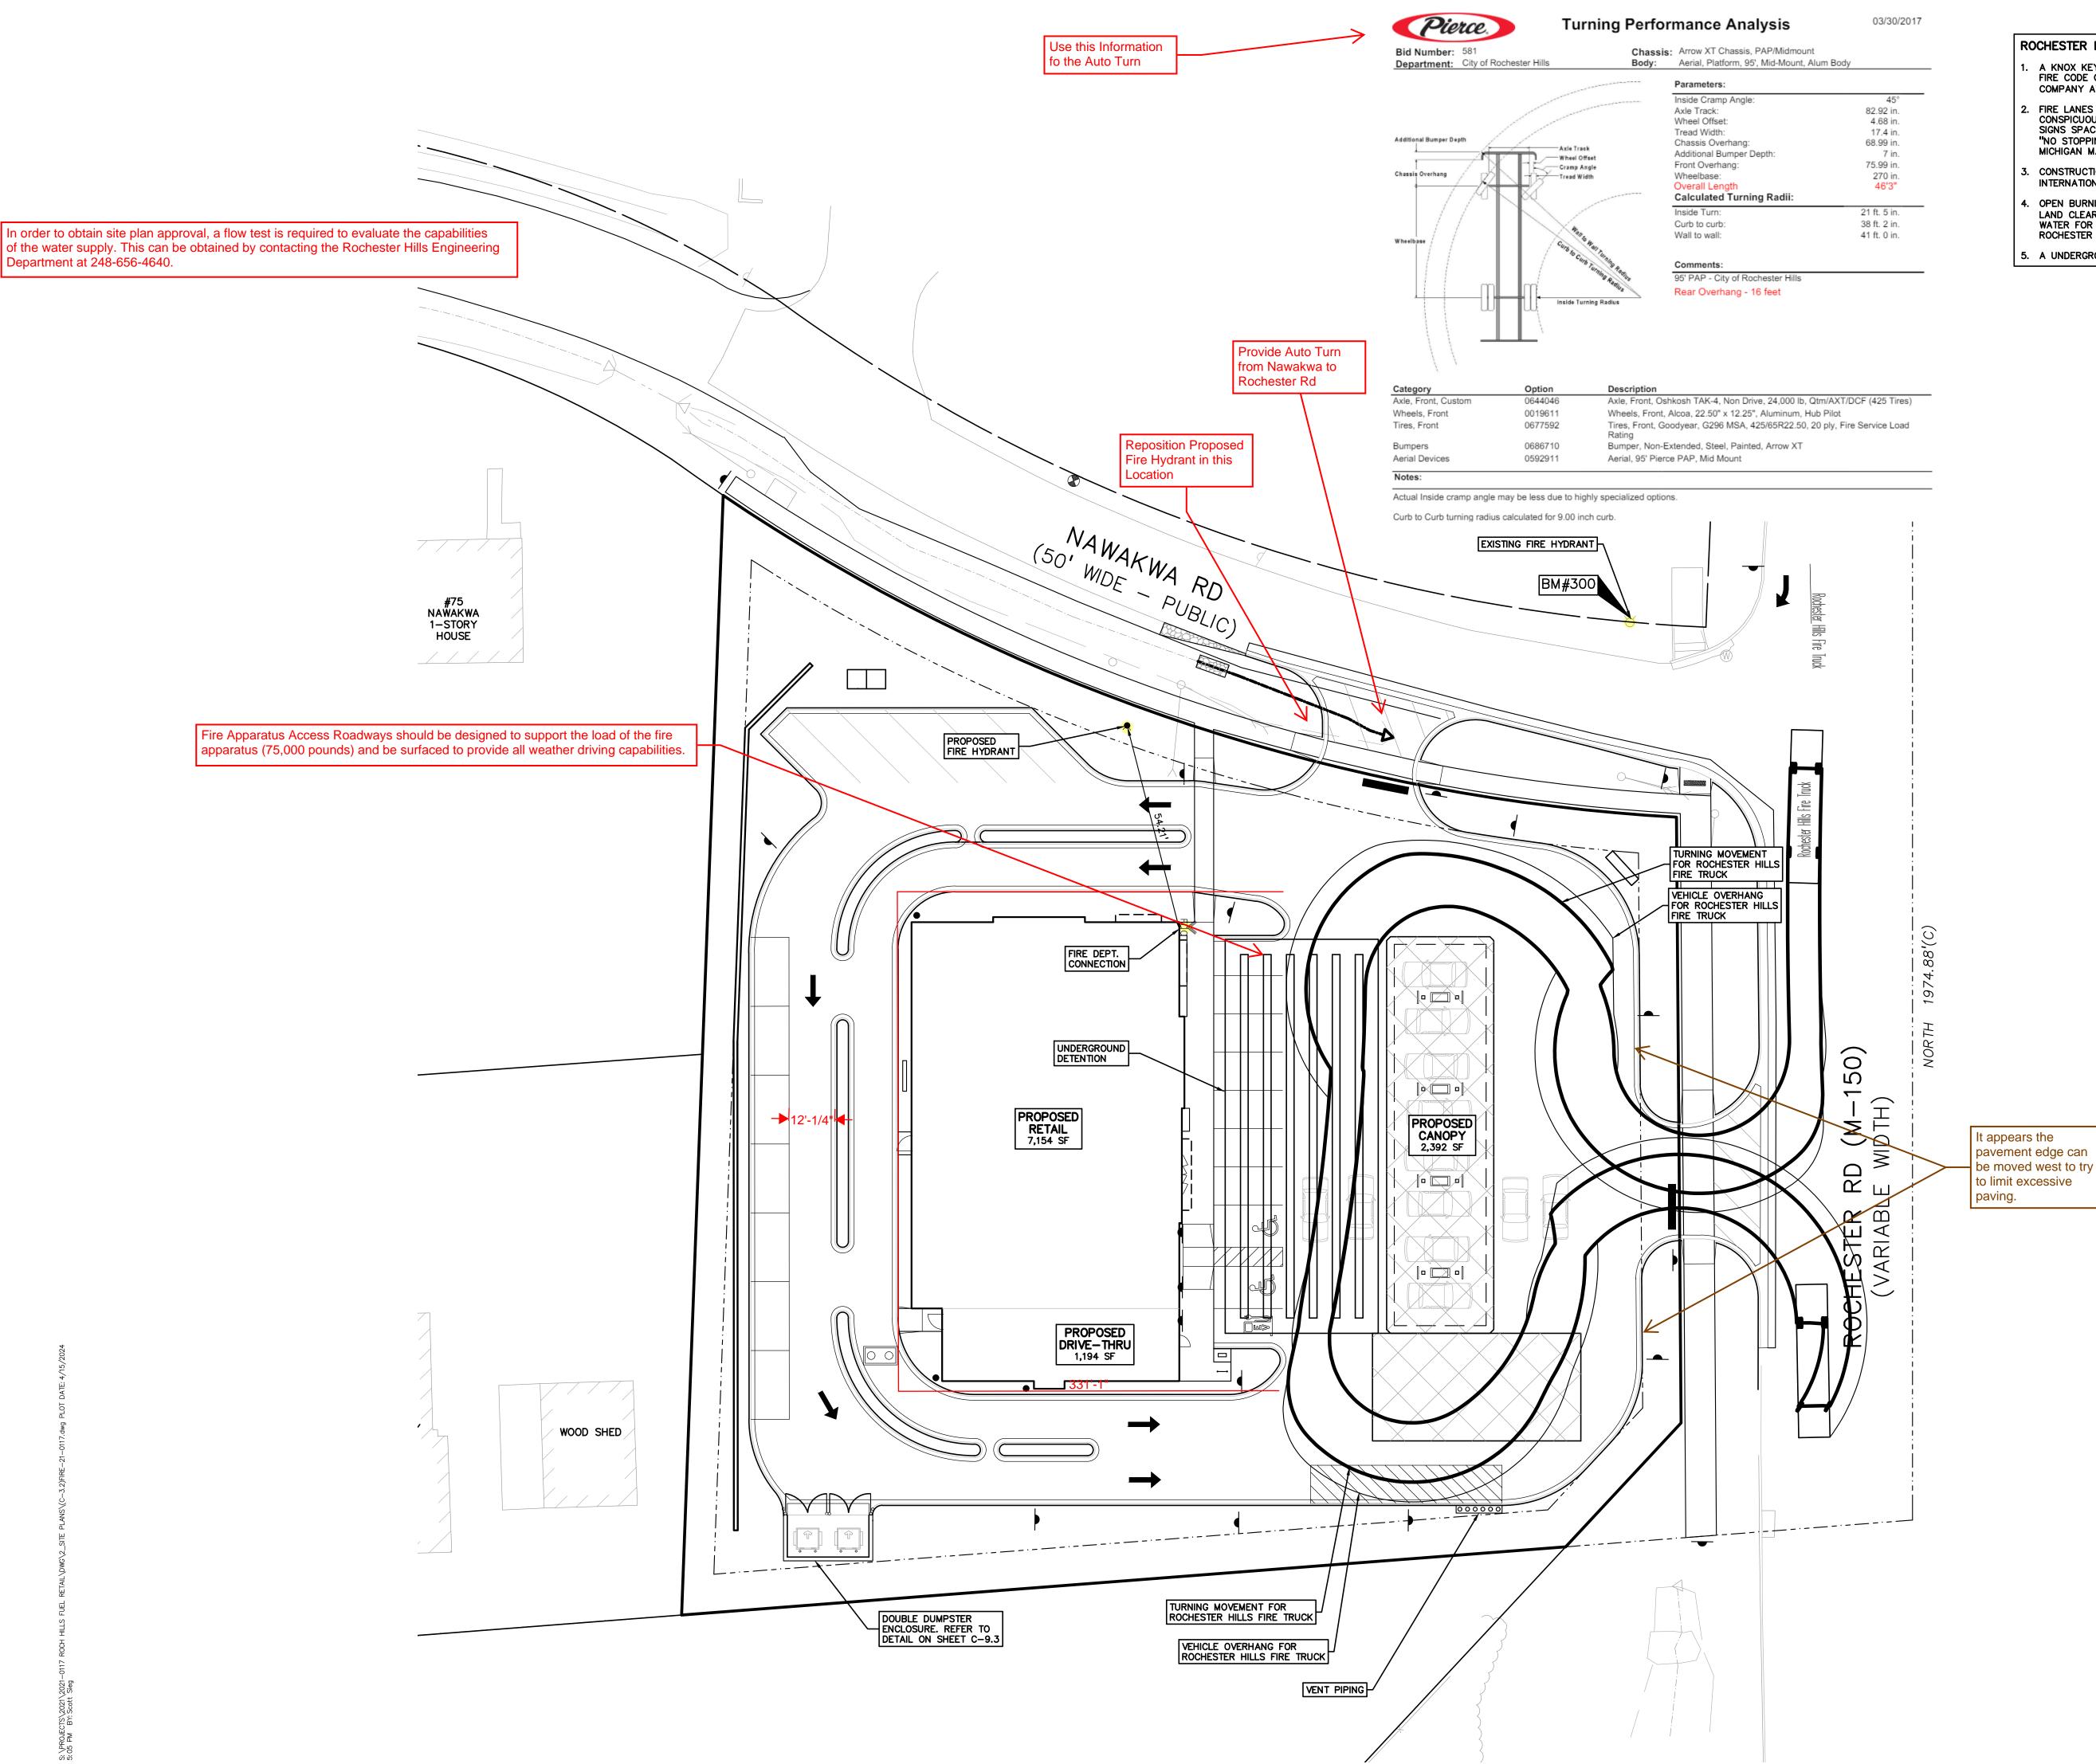

ROCHESTER HILLS FIRE DEPARTMENT NOTES:

- A KNOX KEY SYSTEM SHALL BE INSTALLED, IN A LOCATION APPROVED BY THE FIRE CODE OFFICIAL. ORDERING INFORMATION IS AVAILABLE FROM THE KNOX COMPANY AT www.knoxbox.com (3200 SERIES BOX).
- . FIRE LANES SHALL BE DESIGNATED BY THE FIRE CODE OFFICIAL AND SHALL BE CONSPICUOUSLY POSTED ON BOTH SIDES OF THE FIRE LANE, WITH FIRE LANE SIGNS SPACED NOT MORE THAN 100 FEET APART. FIRE LANE SIGNS SHALL READ "NO STOPPING, STANDING, PARKING, FIRE LANE", AND SHALL CONFORM TO THE MICHIGAN MANUAL OF UNIFORM TRAFFIC CONTROL DEVICES.
- CONSTRUCTION SITES SHALL BE SAFEGUARDED IN ACCORDANCE WITH THE INTERNATIONAL FIRE CODE (IFC) 2006 CHAPTER 14.
- OPEN BURNING IS NOT PERMITTED, INCLUDING THE BURNING OF TRASH, DEBRIS OR LAND CLEARING MATERIALS. OPEN BURNING FOR WARMING OF SAND AND/OR WATER FOR THE PREPARATION OF MORTAR SHALL BE WITHIN THE CITY OF ROCHESTER HILLS BURN PERMIT GUIDELINES.
- 5. A UNDERGROUND DETENTION SYSTEM IS SHOWN ON-SITE.

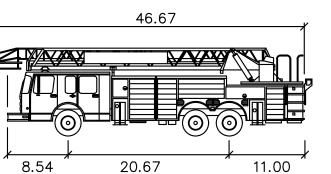


ROCHESTER HILLS LADDER TRUCK

Width	: 8.50
Track	: 8.00
Lock to Lock Time	: 5.0
Steering Angle	: 30.0







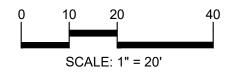



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CLIENT

3420 ROCHESTER ROAD, LLC 29200 NORTHWESTERN HIGHWAY, SUITE 450 FARMINGTON HILLS, MICHIGAN 48334

PROJECT TITLE

3420 ROCHESTER ROAD 3420 ROCHESTER ROAD ROCHESTER HILLS, OAKLAND COUNTY, MICHIGAN

12/20/23
04/17/24

ORIGINAL ISSUE DATE: AUGUST 15, 2022 DRAWING TITLE

FIRE TRUCK

TURNING PLAN


PEA JOB NO.





NOT FOR CONSTRUCTION CITY FILE #22-029 SECTION #34

2021-0117

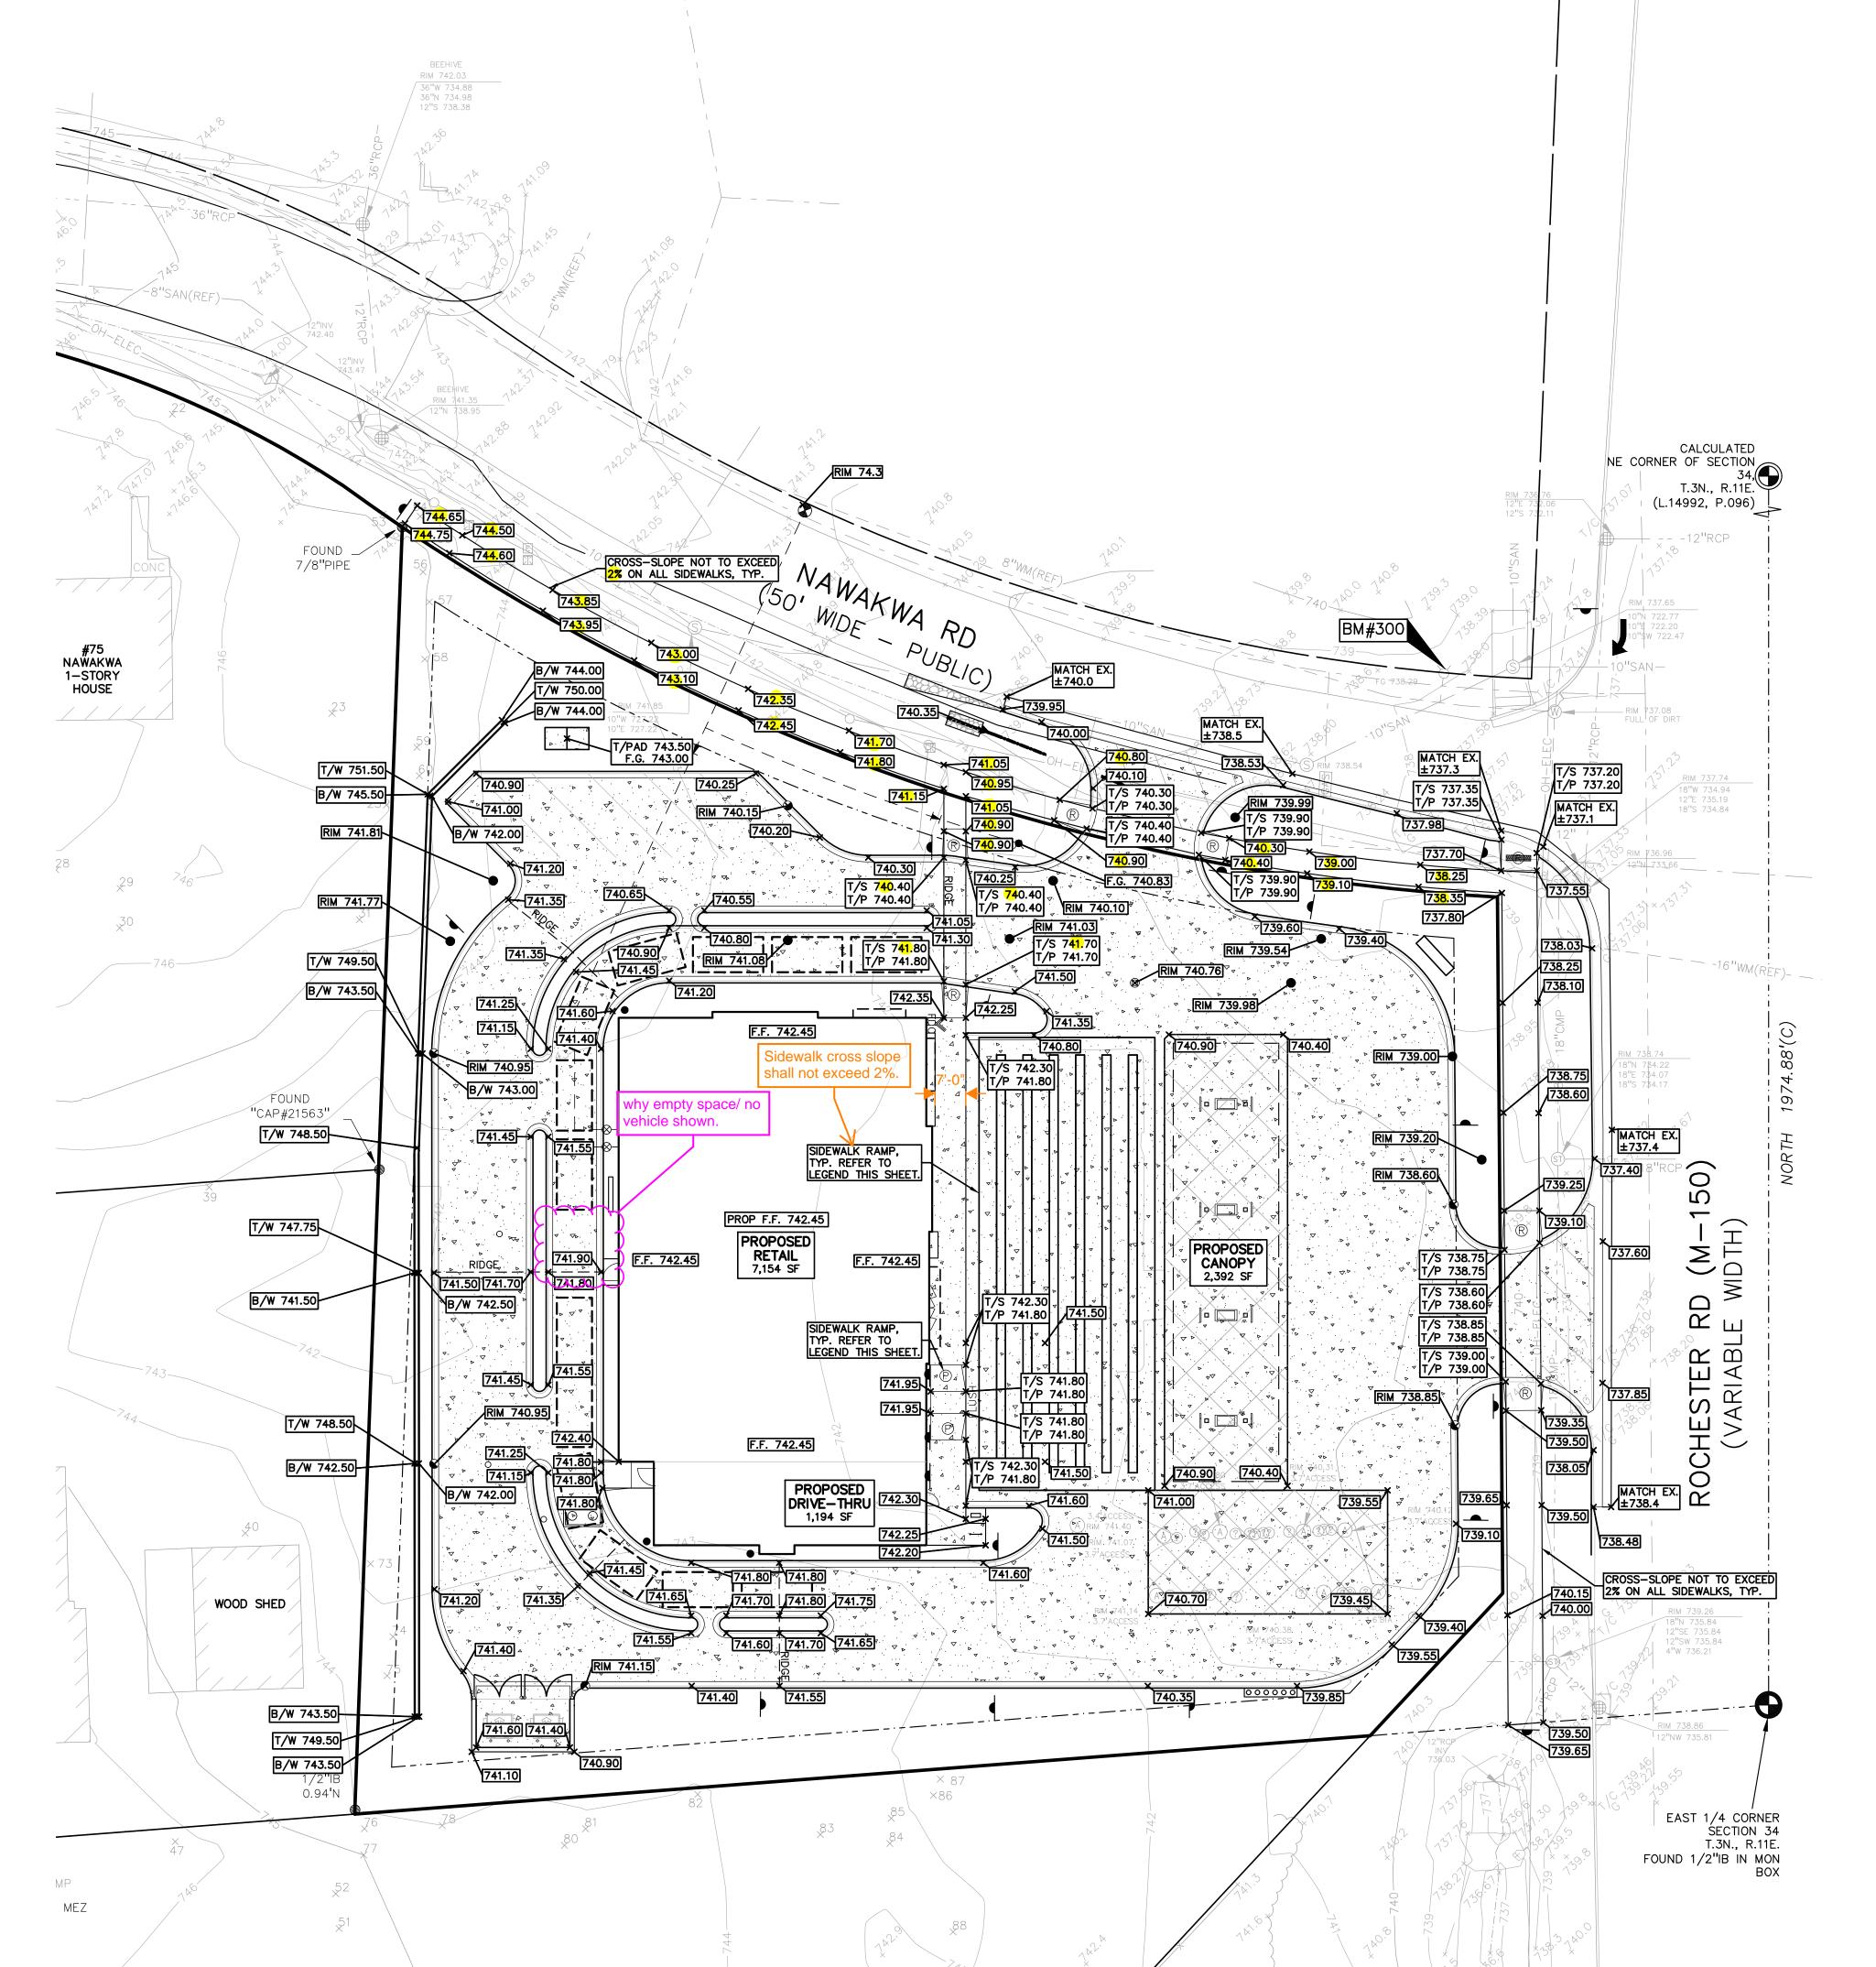



EXISTING SPOT ELEVATION PROPOSED SPOT ELEVATION: TYPICALLY TOP OF PAVEMENT IN PAVED AREAS, GUTTER GRADE

IN CURB LINES. EXISTING CONTOUR

——922—— PROPOSED CONTOUR PROPOSED REVERSE GUTTER PAI

- - - PROPOSED RIDGE LINE ----- PROPOSED SWALE/DITCH

ABBREVIATIONS

T/C = TOP OF CURB G = GUTTER GRADE T/P = TOP OF PAVEMENT F.G. = FINISH GRADE T/S = TOP OF SIDEWALK F.F. = FINISHED FLOOR T/W = TOP OF WALL B/W = BOTTOM OF WALL

RETAINING WALL NOTE:

TOP OF WALL (T/W) AND BOTTOM OF WALL (B/W) GRADES ARE THE FINISH GRADE AT THE TOP AND BOTTOM OF THE RETAINING WALL, NOT ACTUAL TOP AND BOTTOM OF THE WALL STRUCTURE

EARTHWORK BALANCING NOTE:

THE CONTRACTOR SHALL BE RESPONSIBLE FOR IMPORTING OR EXPORTING ALL MATERIALS AS REQUIRED TO PROPERLY GRADE THIS PROJECT TO THE FINISHED ELEVATIONS SHOWN ON THE APPROVED PLANS. THE CONTRACTOR SHALL MAKE THEIR OWN DETERMINATION OF CUT AND FILL QUANTITIES AND ALLOW FOR REMOVAL OF EXCESS OR IMPORTATION OF ADDITIONAL MATERIAL AT NO ADDITIONAL COST TO THE OWNER.

> **BENCHMARKS** (GPS DERIVED - NAVD88 DATUM)

BM #300 ARROW ON HYDRANT AT THE NORTHWEST CORNER OF ROCHESTER ROAD AND NAWAKWA ELEV. - 740.28

BM #301 SET BENCHTIE IN SOUTH FACE OF UTILITY POLE AT THE NORTHWEST CORNER OF NAWAKWA ROAD AND CHERRY ROAD. ELEV. - 749.41

BM #302 ARROW ON HYDRANT EAST OF HOUSE #3466 CHERRY ROAD. ELEV. - 748.12

BM #303 DIMPLE ON NORTHWEST BOLT OF STRAIN POLE JUST NORTH OF THE M-59 WEST RAMP. ELEV. - 738.60

SIDEWALK RAMP LEGEND:

SIDEWALK RAMP 'TYPE P' REFER TO LATEST MDOT R-28

WARNING DETAILS

STANDARD RAMP AND DETECTABLE (

GROUP t: 844.813.2949

www.peagroup.com









SCALE: 1" = 20'



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CLIENT

3420 ROCHESTER ROAD, LLC 29200 NORTHWESTERN HIGHWAY,

SUITE 450 FARMINGTON HILLS, MICHIGAN 48334

PROJECT TITLE

3420 ROCHESTER

ROAD
3420 ROCHESTER ROAD
ROCHESTER HILLS, OAKLAND COUNTY, MICHIGAN

REVISIONS	
SITE/UTILITY LAYOUT	12/20/23
SITE/UTILITY LAYOUT	04/17/24


ORIGINAL ISSUE DATE: AUGUST 15, 2022

DRAWING TITLE


PRELIMINARY GRADING PLAN





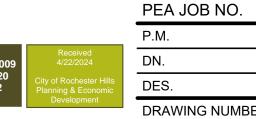

2021-0117

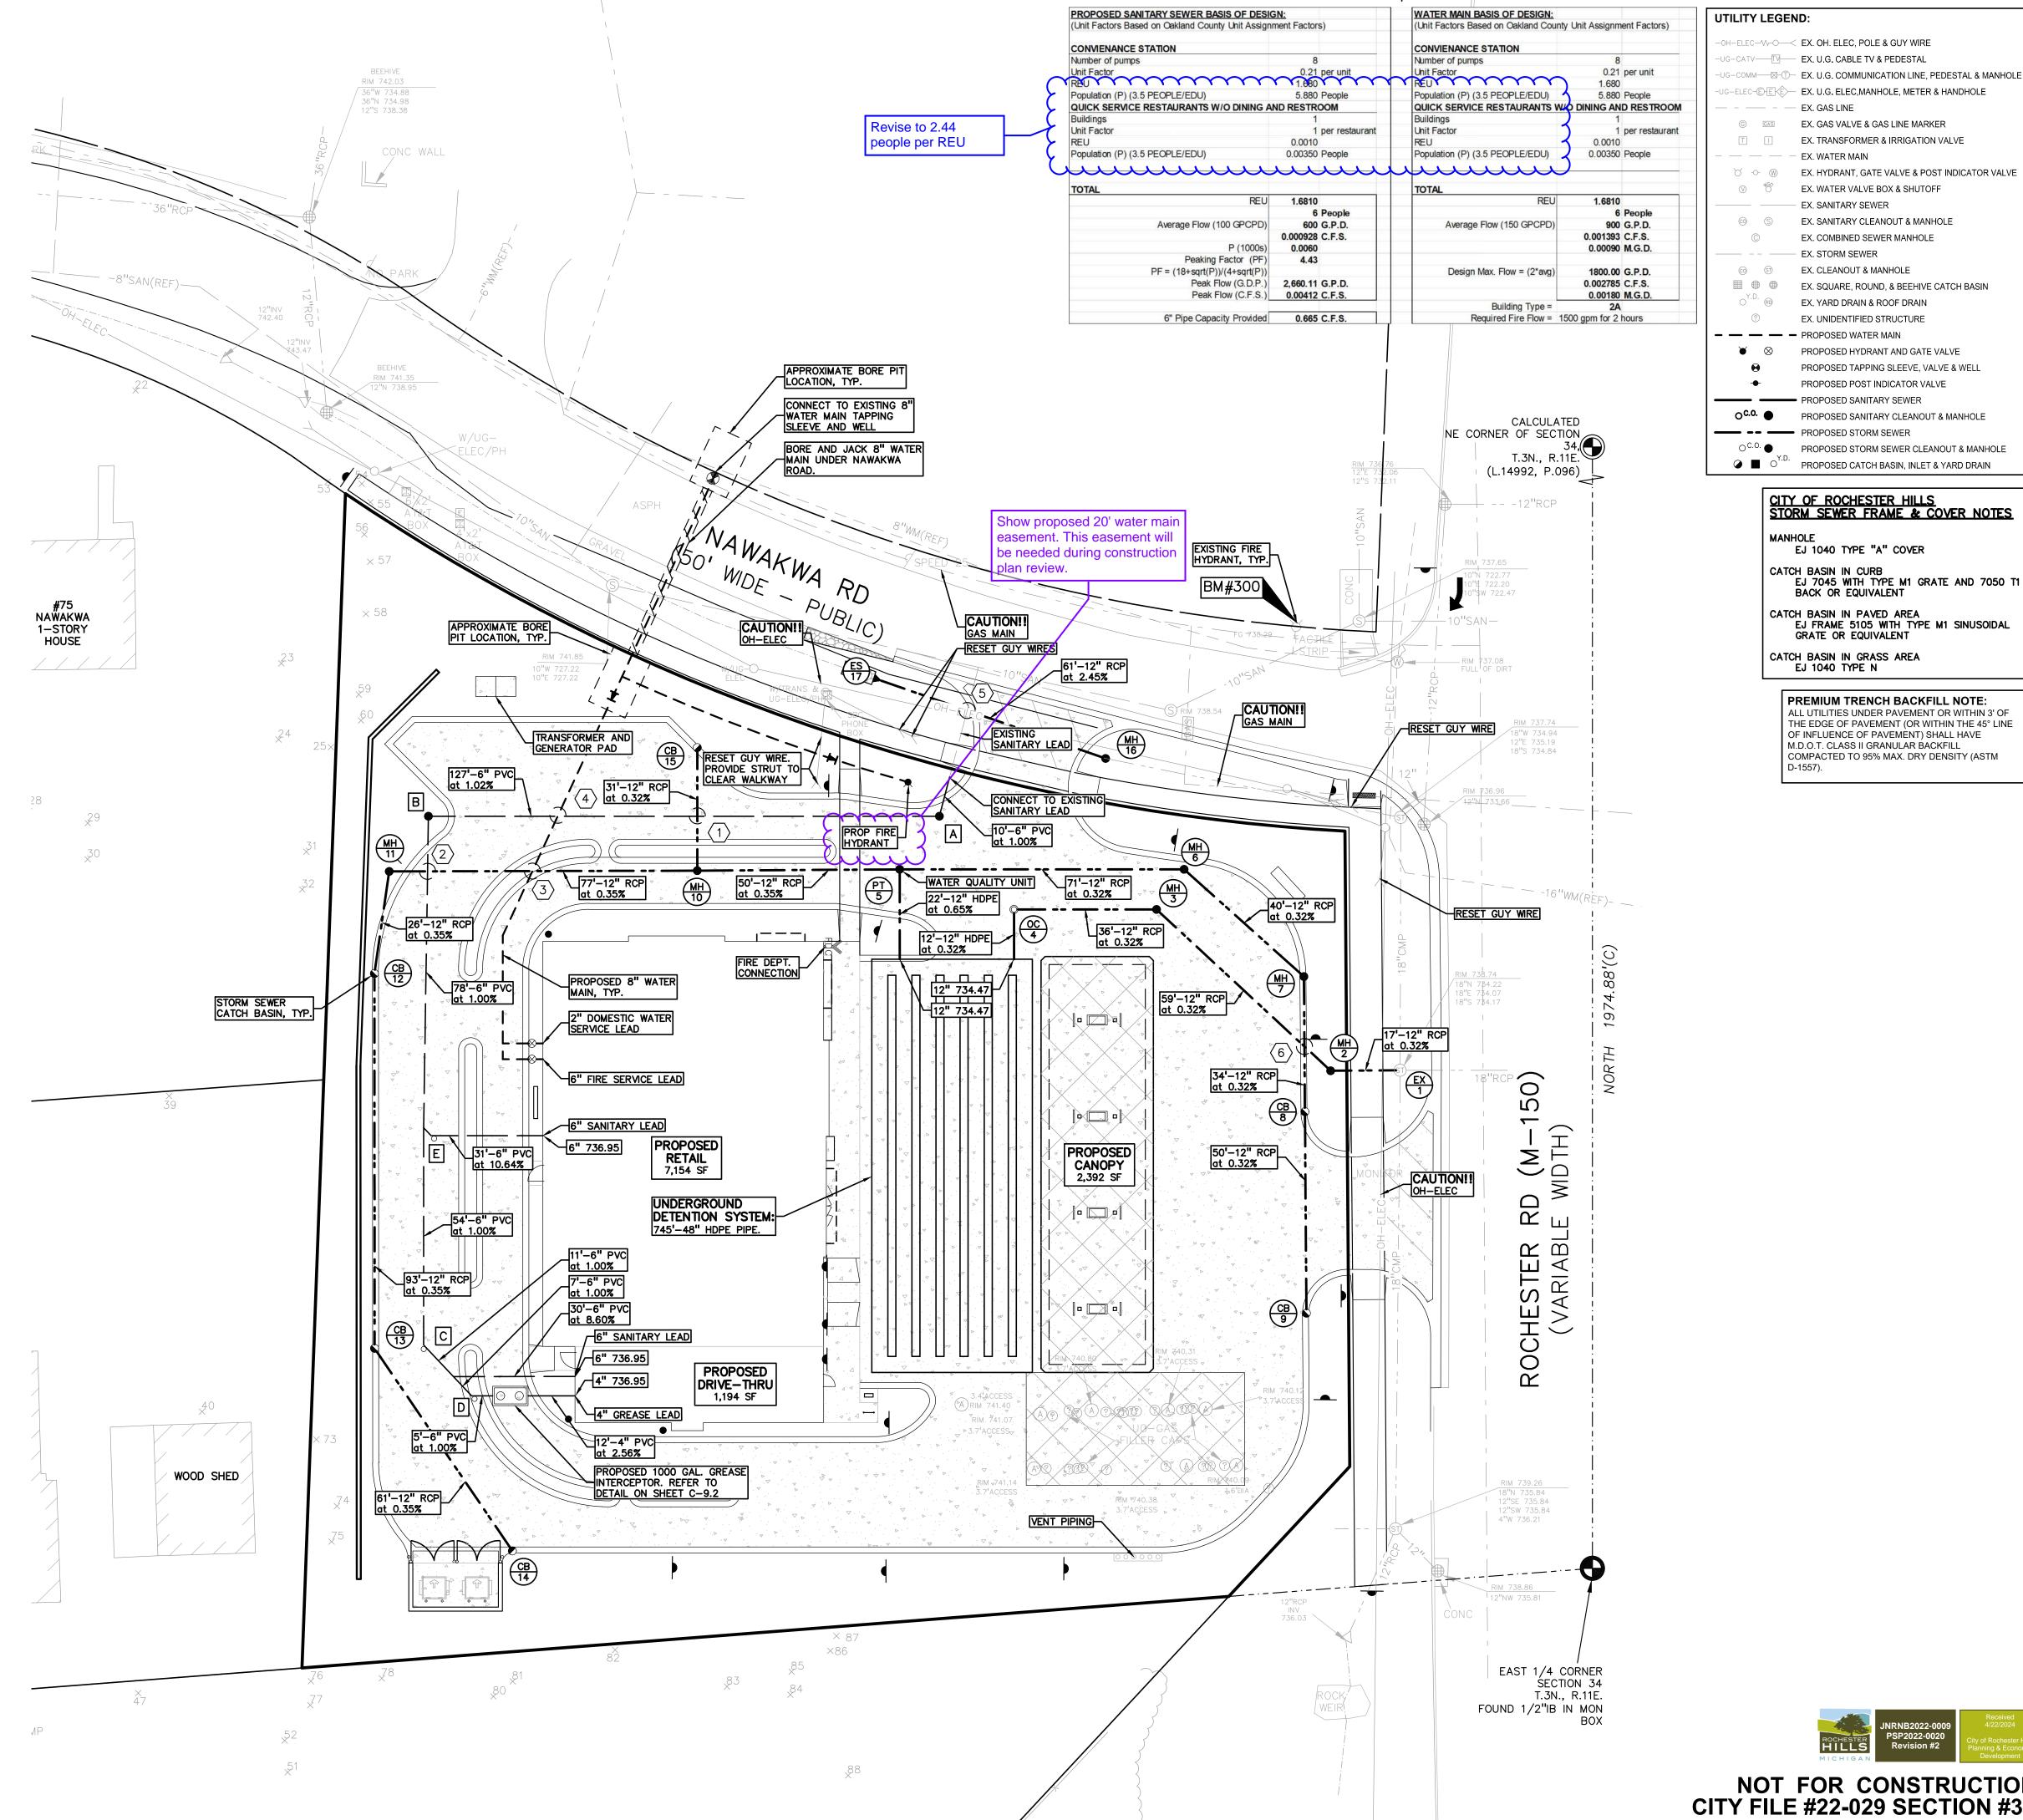

GROUP t: 844.813.2949 www.peagroup.com

EX. GAS LINE

— — — EX. WATER MAIN

© GAS EX. GAS VALVE & GAS LINE MARKER

EX. STORM SEWER

EX. CLEANOUT & MANHOLE

EX. SQUARE, ROUND, & BEEHIVE CATCH BASIN

EX. YARD DRAIN & ROOF DRAIN

EX. UNIDENTIFIED STRUCTURE

PROPOSED HYDRANT AND GATE VALVE PROPOSED TAPPING SLEEVE, VALVE & WELL

PROPOSED POST INDICATOR VALVE

○ C.O. ■ PROPOSED STORM SEWER CLEANOUT & MANHOLE

CITY OF ROCHESTER HILLS
STORM SEWER FRAME & COVER NOTES

EJ 7045 WITH TYPE M1 GRATE AND 7050 1

CATCH BASIN IN PAVED AREA EJ FRAME 5105 WITH TYPE M1 SINUSOIDAL

PREMIUM TRENCH BACKFILL NOTE:

OF INFLUENCE OF PAVEMENT) SHALL HAVE M.D.O.T. CLASS II GRANULAR BACKFILL

COMPACTED TO 95% MAX. DRY DENSITY (ASTM

ALL UTILITIES UNDER PAVEMENT OR WITHIN 3' OF THE EDGE OF PAVEMENT (OR WITHIN THE 45° LINE

OC.O. ● PROPOSED SANITARY CLEANOUT & MANHOLE

EJ 1040 TYPE "A" COVER

BACK OR EQUIVALENT

GRATE OR EQUIVALENT

CATCH BASIN IN GRASS AREA EJ 1040 TYPE N

CATCH BASIN IN CURB

EX. TRANSFORMER & IRRIGATION VALVE


EX. WATER VALVE BOX & SHUTOFF

EX. SANITARY CLEANOUT & MANHOLE

EX. COMBINED SEWER MANHOLE





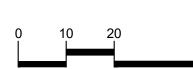





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CLIENT

3420 ROCHESTER ROAD, LLC 29200 NORTHWESTERN HIGHWAY, SUITE 450

FARMINGTON HILLS, MICHIGAN 48334

PROJECT TITLE

3420 ROCHESTER ROAD

3420 ROCHESTER ROAD ROCHESTER HILLS, OAKLAND COUNTY, MICHIGAN

REVISIONS	
SITE/UTILITY LAYOUT	12/20/23
SITE/UTILITY LAYOUT	04/17/24
-	


ORIGINAL ISSUE DATE: AUGUST 15, 2022

DRAWING TITLE

PEA JOB NO.

PRELIMINARY UTILITY PLAN


2021-0117

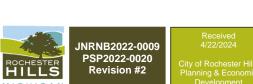

NOT FOR CONSTRUCTION CITY FILE #22-029 SECTION #34

SWS DES. DRAWING NUMBER:

C-6.0

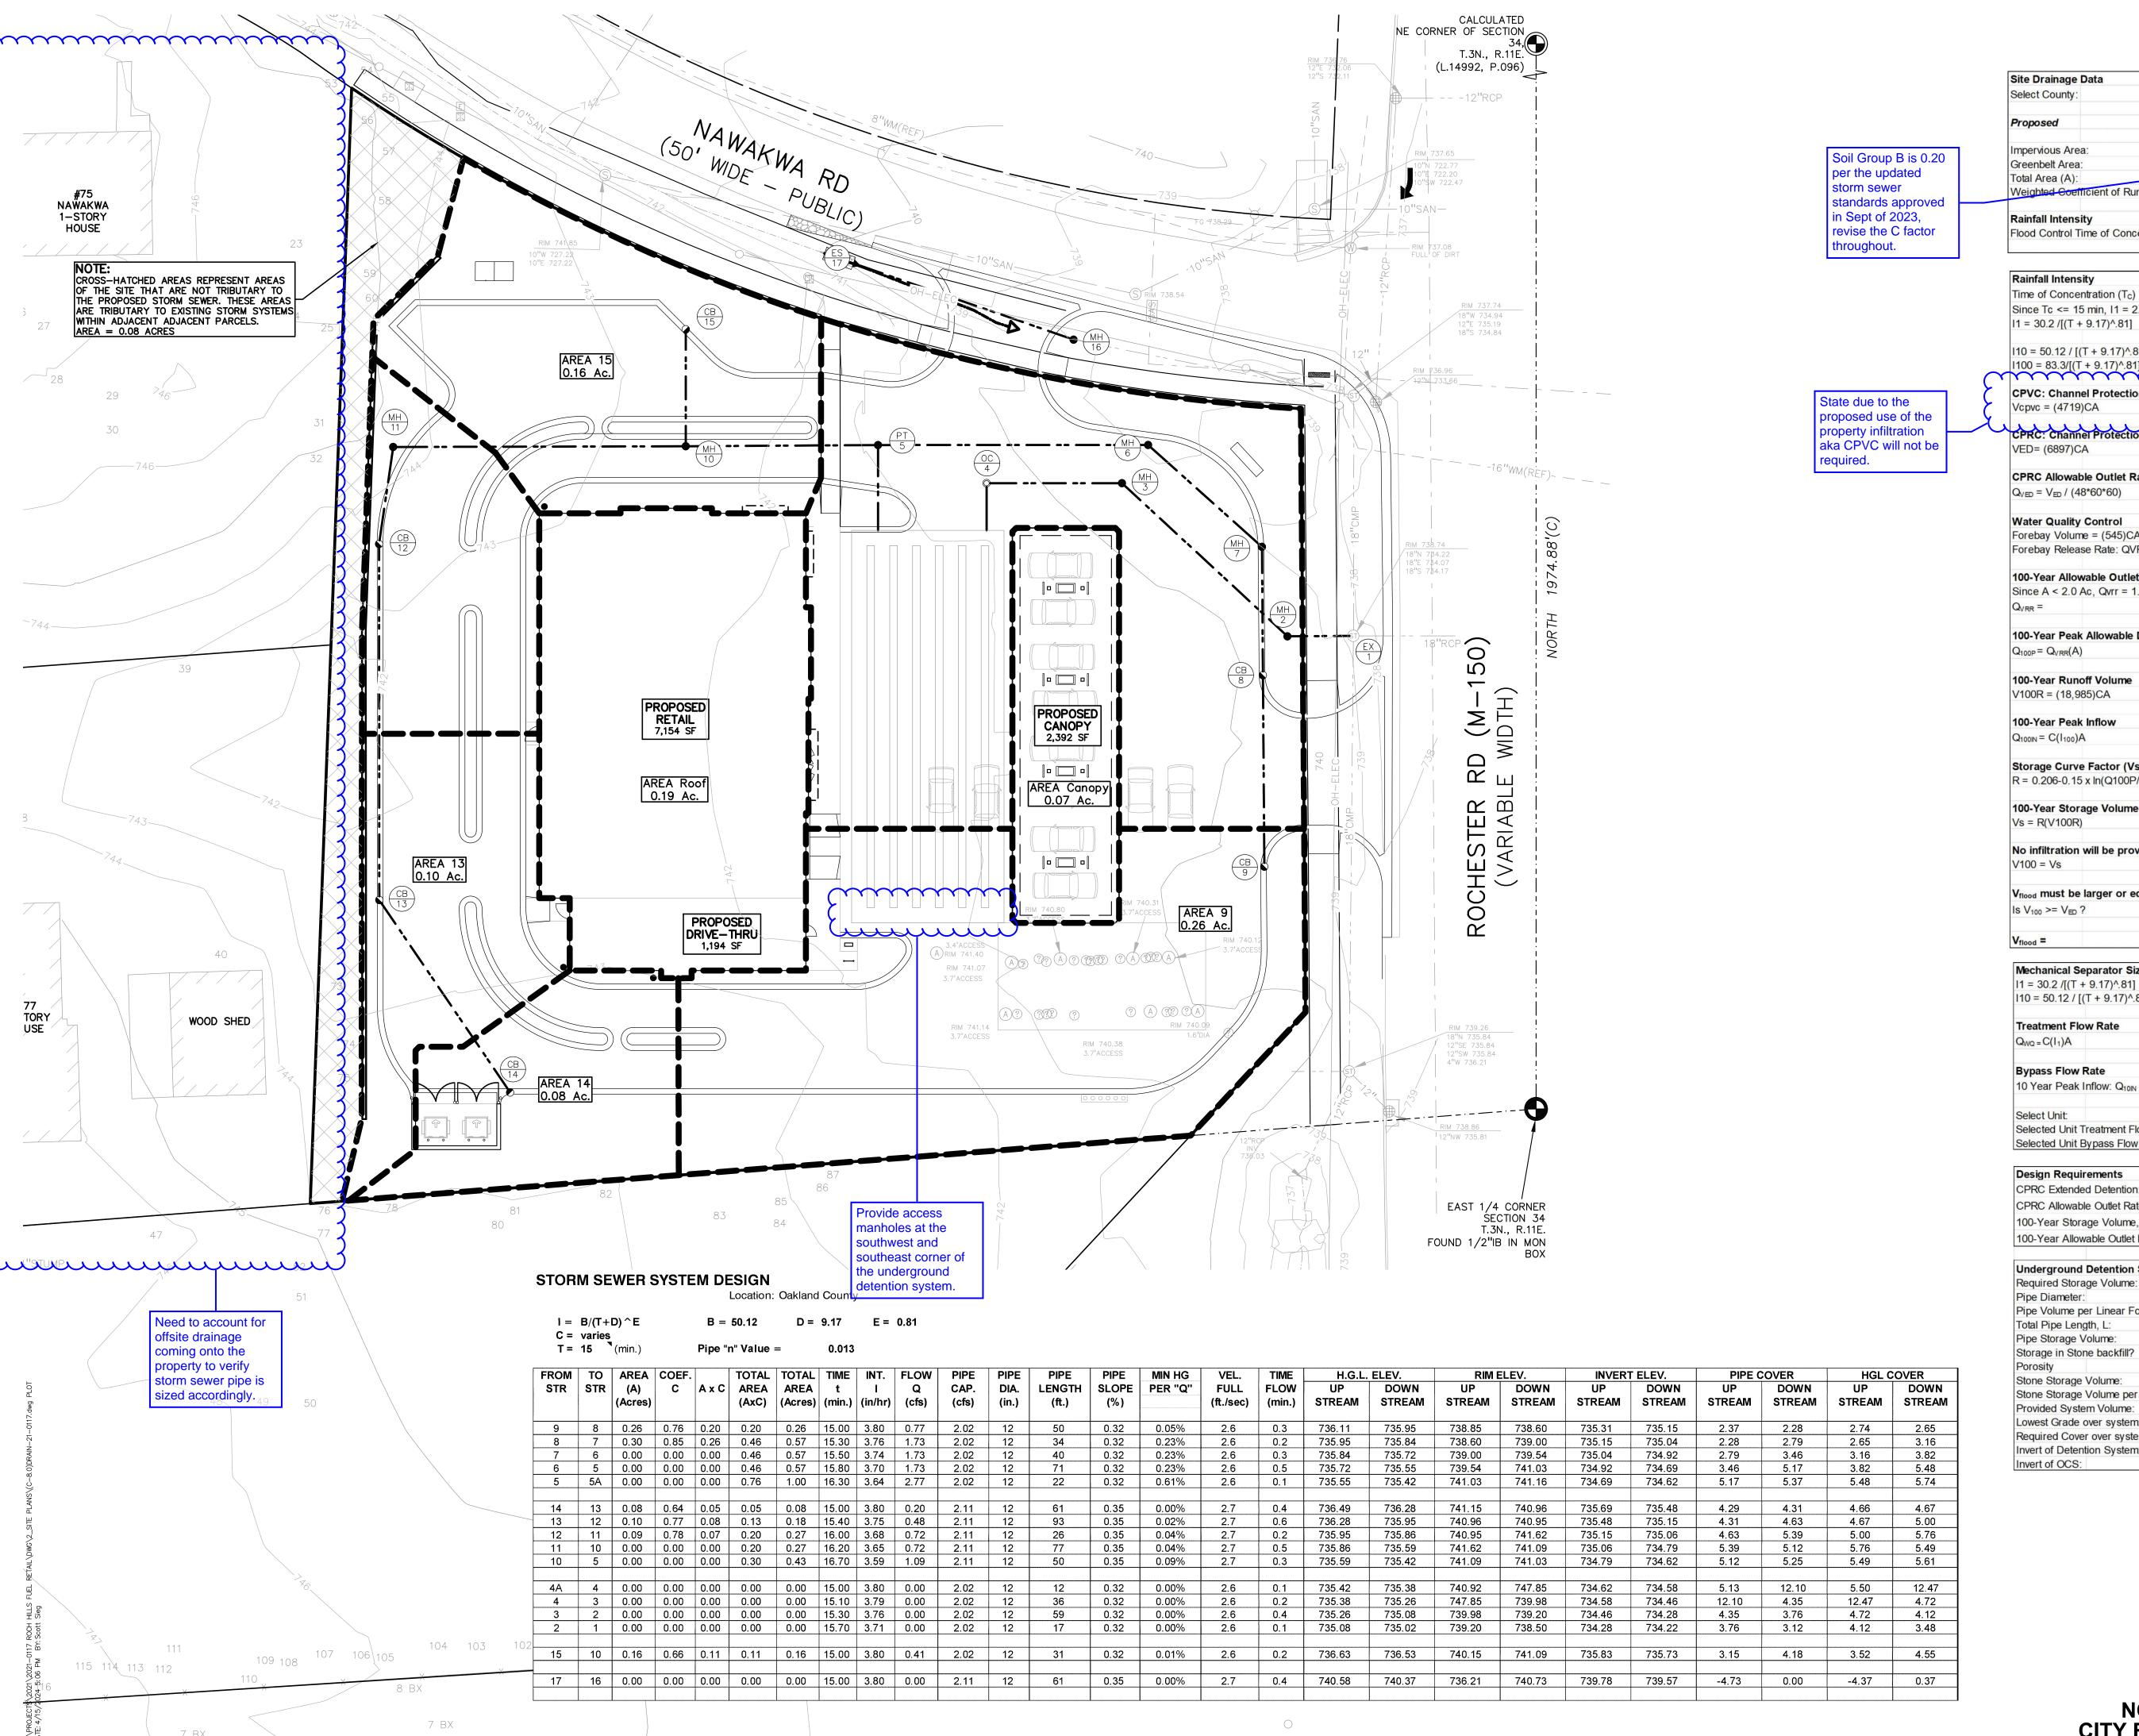

Site Drainage Data				
Select County:	Oakland			
Proposed				
Impervious Area:	0.97	acre	P	\ 0.
Greenbelt Area:	0.36	acre	C =	0.
Total Area (A):	1.33	acre	Ly x	۸ ۸
Weighted Coefficient of Ru	unoff (C):	0.76		
Rainfall Intensity				
Flood Control Time of Cond	centration, Tc =	10.00	min	

10.00 min

Time of confecting about (16)	10.00	11111
Since Tc <= 15 min, I1 = 2.0 in/hr		
I1 = 30.2 /[(T + 9.17)^.81]	2.00	in/hr
I10 = 50.12 / [(T + 9.17)^.81]	4.58	in/hr
I100 = 83.3/[(T + 9.17)^.81]	7.62	in/hr
m	\sim	\sim
CPVC: Channel Protection Volume Control Vol	ume	
Vcpvc = (4719)CA	4,770	cf
		 7
CPRC: Channel Protection Rate Control Volum		
VED= (6897)CA	6,971	cf
CPRC Allowable Outlet Rate		
$Q_{VED} = V_{ED} / (48*60*60)$	0.04	cts
Water Quality Central		
Water Quality Control Forebay Volume = (545)CA	551	cf
Forebay Release Rate: QVF = VF/(48*60*60)	0.003	
Totebay Nelease Nate. QVI = VI7(40 00 00)	0.003	013
100-Year Allowable Outlet Rate		
Since A < 2.0 Ac, Qvrr = 1.0		
Q _{VRR} =	1.00	cfs/ac
100-Year Peak Allowable Discharge		
$Q_{100P} = Q_{VRR}(A)$	1.33	cfs
100-Year Runoff Volume		
V100R = (18,985)CA	19,190	cf
100-Year Peak Inflow		
$Q_{100IN} = C(I_{100})A$	7.70	cfs
Storage Curve Factor (Vs/Vr)		
R = 0.206-0.15 x ln(Q100P/Q100IN)	0.469	
400 Voor Storogo Volumes		
100-Year Storage Volume	0.000	of
Vs = R(V100R)	9,000	CT
No infiltration will be provided, so no CPVC dec	duction is taker	1
V100 = Vs	9,000	
V100 V3	3,000	01
V _{flood} must be larger or equal to V _{ED} :		
le V ₁₀₀ >= V ₂₀ ?	Ves	
13 V 100 <= VED (TAC	


71100d =	9,000 0
Mechanical Separator Sizing	
-	0.70 :- //-
I1 = 30.2 /[(T + 9.17)^.81]	2.76 in/hr
110 = 50.12 / [(T + 9.17)^.81]	4.58 in/hr
Treatment Flow Rate	
$Q_{WQ} = C(I_1)A$	2.79 cfs
Bypass Flow Rate	
10 Year Peak Inflow: Q _{10IN} =	4.63 cfs
Select Unit:	CS-5
Selected Unit Treatment Flow Rate	2.81 cfs
Selected Unit Bypass Flow Rate:	call Contech cfs

Design Requirements		
CPRC Extended Detention: V _{ED} =	6,971	cf
CPRC Allowable Outlet Rate: Q _{VED} =	0.04	cfs
100-Year Storage Volume, V _{100D} =	9,000	cf
100-Year Allowable Outlet Rate: Q _{VRR} =	1.33	cfs
Underground Detention Storage		
Required Storage Volume:	9,000	cf
Pipe Diameter:	48	in
Pipe Volume per Linear Foot:	12.57	cf/lf
Total Pipe Length, L:	745	ft
Pipe Storage Volume:	9,362	cf
Storage in Stone backfill?	N	
Porosity	0	%
Stone Storage Volume:	0	cf
Stone Storage Volume per Linear Foot:	0.00	cf/lf
Provided System Volume:	9,362	cft
Lowest Grade over system:	640.90	
Required Cover over system:	1.50	ft
Invert of Detention System:	734.62	
Invert of OCS:	734.58	

	$P \equiv V$
	GROUP
	t: 844.813.2949
}	www.peagroup.com





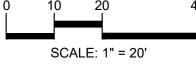



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CLIENT

3420 ROCHESTER ROAD, LLC 29200 NORTHWESTERN HIGHWAY SUITE 450 FARMINGTON HILLS, MICHIGAN 48334

PROJECT TITLE

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3420 ROCHESTER ROAD ROCHESTER HILLS, OAKLAND COUNTY, MICHIGAN

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DRAWING TITLE	

DRAINAGE AREA MAP

2021-0117

SWS

ROCHESTER HILLS MICHIGAN	JNRNB2022-0009 PSP2022-0020 Revision #2	Received 4/22/2024 City of Rochester Hills Planning & Economic Development

NOT FOR CONSTRUCTION CITY FILE #22-029 SECTION #34

DRAWING NUMBER:

PEA JOB NO.

GENERAL NOTES:

THESE NOTES APPLY TO ALL CONSTRUCTION ACTIVITIES ON THIS PROJECT.

- ALL CONSTRUCTION, WORKMANSHIP AND MATERIALS SHALL BE IN ACCORDANCE WITH CURRENT OSHA, MDOT AND MUNICIPALITY STANDARDS AND REGULATIONS.
- THE CONTRACTOR SHALL NOTIFY THE CITY ENGINEER AND/OR THE AUTHORITY HAVING JURISDICTION 3 BUSINESS DAYS PRIOR TO THE BEGINNING OF CONSTRUCTION.
- THE CONTRACTOR MUST CONTACT THE ENGINEER SHOULD THEY ENCOUNTER ANY DESIGN ISSUES DURING CONSTRUCTION. IF THE CONTRACTOR MAKES DESIGN MODIFICATIONS WITHOUT THE WRITTEN DIRECTION OF THE DESIGN ENGINEER. THE CONTRACTOR DOES SO AT HIS OWN RISK.
- ALL NECESSARY PERMITS, TESTING, BONDS AND INSURANCES ETC., SHALL BE PAID FOR BY THE CONTRACTOR. THE OWNER SHALL PAY FOR ALL CITY INSPECTION FEES.
- THE CONTRACTOR SHALL NOTIFY THE APPROPRIATE 811/ONE CALL UTILITY LOCATING CENTER, THE CITY ENGINEER AND/OR THE AUTHORITY HAVING JURISDICTION 3 BUSINESS DAYS PRIOR TO THE BEGINNING OF CONSTRUCTION. IF NO NOTIFICATION IS GIVEN AND DAMAGE RESULTS, SAID DAMAGE WILL BE REPAIRED AT SOLE EXPENSE OF THE CONTRACTOR. IF EXISTING UTILITY LINES ARE ENCOUNTERED THAT CONFLICT IN LOCATION WITH NEW CONSTRUCTION, THE CONTRACTOR SHALL NOTIFY THE DESIGN ENGINEER SO THAT THE CONFLICT MAY BE RESOLVED.
- CONTRACTOR TO VERIFY THAT THE PLANS AND SPECIFICATIONS ARE THE VERY LATEST PLANS AND SPECIFICATIONS AND FURTHERMORE, VERIFY THAT THESE PLANS AND SPECIFICATIONS HAVE BEEN APPROVED. ALL ITEMS CONSTRUCTED BY THE CONTRACTOR PRIOR TO RECEIVING FINAL APPROVAL, HAVING TO BE ADJUSTED OR RE-DONE, SHALL BE AT THE CONTRACTORS EXPENSE. SHOULD THE CONTRACTOR ENCOUNTER A CONFLICT BETWEEN THESE PLANS AND/OR SPECIFICATIONS, THEY SHALL SEEK CLARIFICATION IN WRITING FROM THE ENGINEER BEFORE COMMENCEMENT OF CONSTRUCTION. FAILURE TO DO SO SHALL BE AT SOLE EXPENSE TO THE CONTRACTOR.
- ANY WORK WITHIN THE STREET OR HIGHWAY RIGHTS-OF-WAY SHALL BE PERFORMED IN ACCORDANCE WITH THE REQUIREMENTS OF THE AGENCIES HAVING JURISDICTION AND SHALL NOT BEGIN UNTIL ALL NECESSARY PERMITS HAVE BEEN ISSUED FOR THE WORK.
- ALL PROPERTIES OR FACILITIES IN THE SURROUNDING AREAS, PUBLIC OR PRIVATE, DESTROYED OR OTHERWISE DISTURBED DUE TO CONSTRUCTION, SHALL BE REPLACED AND/OR RESTORED TO THE ORIGINAL CONDITION BY THE
- THE CONTRACTOR SHALL PROVIDE ALL NECESSARY BARRICADING, SIGNAGE, LIGHTS AND TRAFFIC CONTROL DEVICES TO PROTECT THE WORK AND SAFELY MAINTAIN TRAFFIC IN ACCORDANCE WITH LOCAL REQUIREMENTS AND THE MANUAL OF UNIFORM TRAFFIC CONTROL DEVICES (LATEST EDITION). THE DESIGN ENGINEER, OWNER, CITY AND STATE SHALL NOT BE HELD LIABLE FOR ANY CLAIMS RESULTING FROM ACCIDENTS OR DAMAGES CAUSED BY THE CONTRACTOR'S FAILURE TO COMPLY WITH TRAFFIC AND PUBLIC SAFETY REGULATIONS DURING THE CONSTRUCTION PERIOD.
- 10. IT SHALL BE THE RESPONSIBILITY OF THE CONTRACTOR TO ADJUST THE TOP OF ALL EXISTING AND PROPOSED STRUCTURES (MANHOLES, CATCH BASINS, INLETS, GATE WELLS ETC.) WITHIN GRADED AND /OR PAVED AREAS TO FINAL GRADE SHOWN ON THE PLANS. ALL SUCH ADJUSTMENTS SHALL BE INCIDENTAL TO THE JOB AND WILL NOT BE PAID FOR SEPARATELY.

PAVING NOTES:

- IN AREAS WHERE NEW PAVEMENTS ARE BEING CONSTRUCTED, THE TOPSOIL AND SOIL CONTAINING ORGANIC MATTER SHALL BE REMOVED PRIOR TO PAVEMENT CONSTRUCTION.
- 2. PROVIDE EXPANSION JOINTS AND JOINT SEALANT AT TWO "END-OF-RADIUS" LOCATIONS (OPPOSITE SIDES AT EACH LONG END) OF CONCRETE CURB ISLANDS.
- 5. REFER TO ARCHITECTURAL PLANS FOR DETAILS OF FROST SLAB AT EXTERIOR BUILDING DOORS.
- . CONSTRUCTION TRAFFIC SHOULD BE MINIMIZED ON THE NEW PAVEMENT. IF CONSTRUCTION TRAFFIC IS ANTICIPATED ON THE PAVEMENT STRUCTURE, THE INITIAL LIFT THICKNESS COULD BE INCREASED AND PLACEMENT OF THE FINAL LIFT COULD BE DELAYED UNTIL THE MAJORITY OF THE CONSTRUCTION ACTIVITIES HAVE BEEN COMPLETED. THIS ACTION WILL ALLOW REPAIR OF LOCALIZED FAILURE, IF ANY DOES OCCUR, AS WELL AS REDUCE LOAD DAMAGE ON THE
- . CONCRETE PAVEMENT JOINTING UNLESS SHOWN OTHERWISE IN THE PLANS OR REQUIRED BY THE AUTHORITY HAVING
- 5.1. WHERE PROPOSED CONCRETE ABUTS A STRUCTURE PROVIDE A MINIMUM 1/2" EXPANSION JOINT WITH SEALANT, THE JOINT FILLER BOARD MUST BE AT LEAST THE FULL DEPTH OF THE CONCRETE AND HELD DOWN A 1/2 INCH TO ALLOW FOR SEALING
- 5.2. WHERE PROPOSED CONCRETE ABUTS EXISTING CONCRETE OR IN BETWEEN POURS OF PROPOSED CONCRETE (CONSTRUCTION JOINT) PROVIDE 5/8" DOWELS EVERY 30" CENTER TO CENTER HALF WAY ALONG THE THICKNESS OF THE PROPOSED PAVEMENT. ALTERNATE DOWELS SIZES AND SPACING MUST BE APPROVED THE ENGINEER PRIOR TO COMMENCING WORK AND VIA THE SUBMITTAL PROCESS.
- 5.3. WHERE PROPOSED CONCRETE ABUTS EXISTING OR PROPOSED SIDEWALK PROVIDE A MINIMUM 1/2" EXPANSION JOINT WITH SEALANT 5.4. WHERE PROPOSED CONCRETE ABUTS EXISTING OR PROPOSED CURBING PROVIDE A MINIMUM 1/2" EXPANSION JOINT
- WITH SEALANT
- 5.5. CONTROL, LONGITUDINAL AND/OR TRANSVERSE JOINTS SHALL BE PLACED TO PROVIDE PANELS WITHIN THE PAVEMENT AS SQUARE AS POSSIBLE WITH THE FOLLOWING MAXIMUM SPACING PARAMETERS; 5.5.1. 6-INCH THICK CONCRETE PAVEMENT: 12' X 12'
- 8-INCH THICK CONCRETE PAVEMENT: 15' X 15' 5.5.2. 5.6. IRREGULAR-SHAPED PANELS MAY REQUIRE THE USE OF REINFORCING MESH OR FIBER MESH AS DETERMINED BY THE ENGINEER. THE USE OF MESH MUST BE APPROVED THE ENGINEER PRIOR TO COMMENCING WORK AND VIA THE
- SUBMITTAL PROCESS. 5.7. IF A JOINT PLAN IS NOT PROVIDED IN THE PLANS, THE CONTRACTOR SHALL SUBMIT ONE TO THE ENGINEER FOR REVIEW PRIOR TO COMMENCING WORK AND VIA THE SUBMITTAL PROCESS.
- . CONCRETE CURBING JOINTING UNLESS SHOWN OTHERWISE IN THE PLANS OR REQUIRED BY THE AUTHORITY HAVING
- 6.1. WHERE PROPOSED CONCRETE CURBING ABUTS A STRUCTURE PROVIDE A MINIMUM 1/2" EXPANSION JOINT WITH SEALANT 6.2. WHERE PROPOSED CONCRETE ABUTS EXISTING OR PROPOSED SIDEWALK PROVIDE A MINIMUM 1/2" EXPANSION JOINT
- WITH SEALANT 6.3. WHERE PROPOSED CONCRETE ABUTS EXISTING CURBING PROVIDE A MINIMUM 1/2" EXPANSION JOINT WITH SEALANT
- 6.4. IN BETWEEN POURS OF PROPOSED CONCRETE CURBING (CONSTRUCTION JOINT) 6.4.1. CARRY THE REBAR CONTINUOUSLY BETWEEN POURS
- IF THE REBAR IS NOT LONG ENOUGH TO CARRY CONTINUOUSLY THEN TIE TWO PIECES OF REBAR PER THE LATEST MDOT SPECIFICATIONS 6.5. CONTROL JOINTS SHALL BE PLACED A MAXIMUM 10' CENTER TO CENTER AND AT ALL RADIUS RETURNS

GENERAL GRADING AND EARTHWORK NOTES:

THESE NOTES APPLY TO ALL CONSTRUCTION ACTIVITIES ON THIS PROJECT

- CONTRACTOR TO FIELD VERIFY ALL EXISTING TREES AND BRUSH AND REMOVE ALL THAT ARE NECESSARY TO GRADE
- . ALL GRADES ARE TO TOP OF PAVEMENT UNLESS OTHERWISE NOTED.
- THE STAGING OF CONSTRUCTION ACTIVITIES SHALL OCCUR ONLY WITHIN THE SITE BOUNDARIES. ANY CONSTRUCTION ACTIVITIES OUTSIDE OF THE SITE BOUNDARIES SHALL BE AT THE SOLE RESPONSIBILITY AND RISK OF THE
- ALL SOIL EROSION AND SEDIMENTATION CONTROL MEASURES SHALL MEET THE REQUIREMENTS OF THE AUTHORIZED PUBLIC AGENCY OF JURISDICTION. AN EROSION CONTROL PERMIT MUST BE SECURED FROM OAKLAND COUNTY PRIOR
- . ALL EARTHWORK AND GRADING OPERATIONS SHALL BE PERFORMED IN ACCORDANCE WITH THE SOILS INVESTIGATION
- REFER TO SOIL EROSION CONTROL PLAN FOR ADDITIONAL SOIL EROSION AND SEDIMENTATION CONTROL MEASURES AND NOTES (WILL BE PART OF FINAL SITE PLAN/ENGINEERING PLANS).
- ALL SLOPES EXCEEDING 1:6 MUST BE STABILIZED BY SODDING OR BY PLACING A MULCH BLANKET PEGGED IN PLACE
- ALL DISTURBED AREAS SHALL BE SEEDED AND MULCHED OR SODDED IN ACCORDANCE WITH THE LANDSCAPE PLANS.
- PROVIDE A MINIMUM OF 4" OF TOPSOIL IN THESE AREAS UNLESS OTHERWISE NOTED. THE CONTRACTOR SHALL NOTE EXISTING UNDERGROUND UTILITIES WITHIN AND ADJACENT TO THE SITE. BACKFILL FOR \$hould match city EXISTING UTILITY TRENCHES SHALL BE EXAMINED CRITICALLY. ANY TRENCHES FOUND TO HAVE SOFT, UNSTABLE OR UNSUITABLE BACKFILL MATERIAL, IN THE OPINION OF THE THIRD PARTY TESTING COMPANY, THAT ARE TO BE WITHIN


THE ZONE OF INFLUENCE OF PROPOSED BUILDINGS OR PAVEMENT SHALL BE COMPLETELY EXCAVATED AND

- BACKFILLED WITH SUITABLE MATERIAL. 10. ON-SITE FILL CAN BE USED IF THE SPECIFIED COMPACTION RI
- USED, IT SHOULD BE CLEAN AND FREE OF FROZEN SOIL, ORG 1. THE FINAL SUBGRADE/EXISTING AGGREGATE BASE SHOULD BE TANDEM AXLE TRUCK OR FRONT END LOADER UNDER THE OBS LOOSE OR YIELDING AREAS THAT CANNOT BE MECHANICALLY

REMOVED AND REPLACED WITH ENGINEERED FILL OR AS DICTA

- 12. SUBGRADE UNDERCUTTING, INCLUDING BACKFILLING SHALL BE FROST HEAVING AND UNSTABLE SOIL CONDITIONS. ANY EXCAV FILL AREAS OR BELOW SUBGRADE IN CUT AREAS WILL BE CLA
- 13. SUBGRADE UNDERCUTTING SHALL BE PERFORMED WHERE NECE THE PROPERTY OF THE CONTRACTOR. ANY SUBGRADE UNDERC
- THE GEOTECHNICAL ENGINEERING REPORT FOR THE PROJECT. 14. ANY SUB-GRADE WATERING REQUIRED TO ACHIEVE REQUIRED



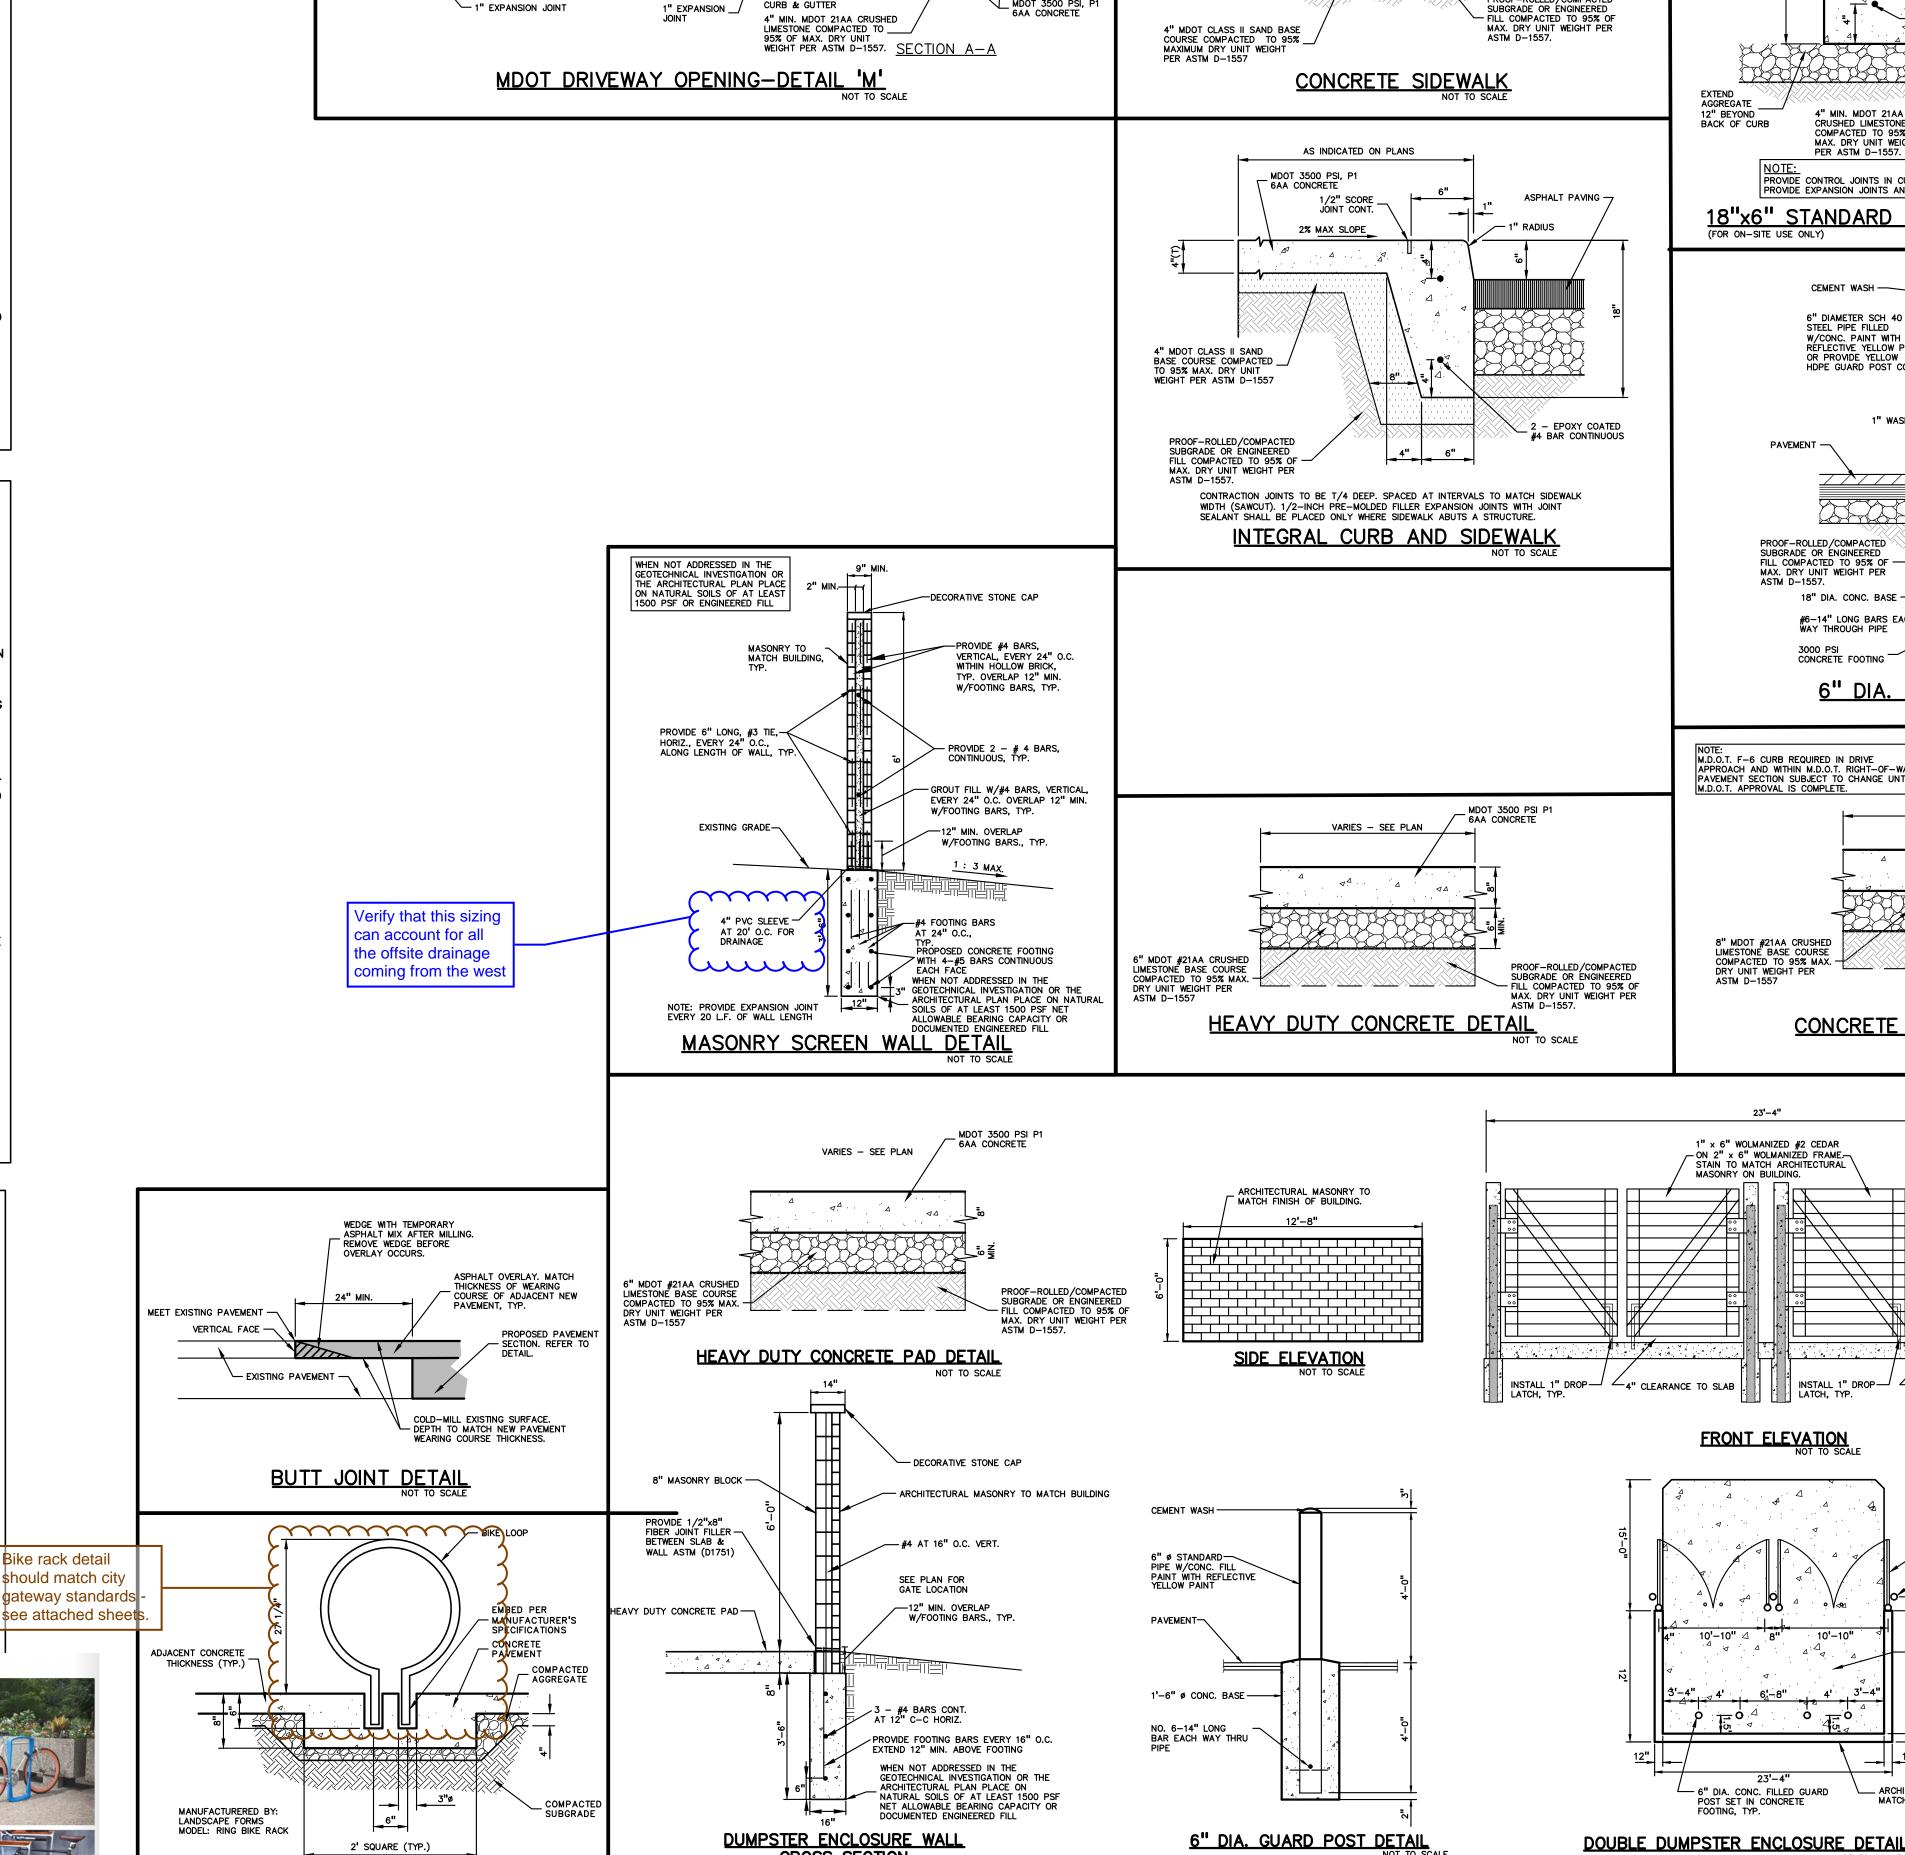

CROSS SECTION

GUTTER

THICKNESS.

AS IN ADJACENT -

NOTE: CROSS-SLOPE OF SIDEWALK MUST NOT

EXCEED 2.0%, EXCEPT IN TRANSITION AREA MATCHING INTO EXISTING SIDEWALK

DOUBLE TRASH ENCLOSURE DETAIL

WIDTH VARIES - SEE PLAN

PROVIDE 1" DEPTH SAWCUT CONTROL JOINTS AT INTERVALS EQUAL TO THE WIDTH OF THE

SIDEWALK (NOT TO EXCEED 8' INTERVAL).

PROOF-ROLLED / COMPACTED


EPOXY COATED #5


BIKE RACK DETAIL NOT TO SCALE

ALIGN DRIVEWAY RETURN TO FIT OPENING
IN CURB AND GUTTER

PLANE OF WEAKNESS JOINTS

— 1" EXPANSION JOINT

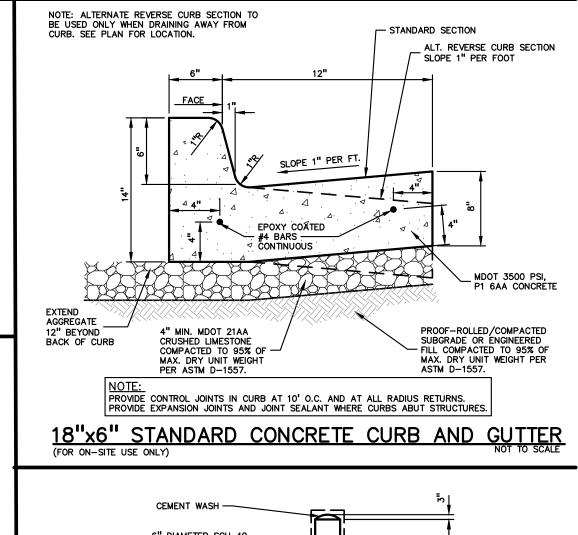


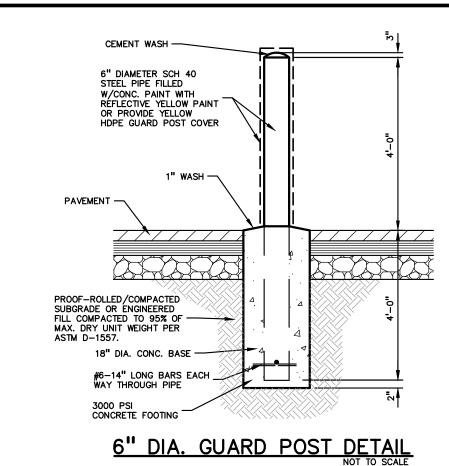




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CLIENT **3420 ROCHESTER** ROAD, LLC 29200 NORTHWESTERN HIGHWA SUITE 450 FARMINGTON HILLS, MICHIGAN 48334

CONCRETE APPROACH DETAIL

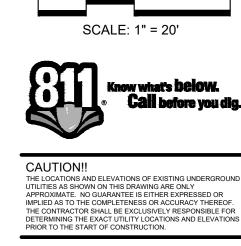4" CLEARANCE TO SLAB

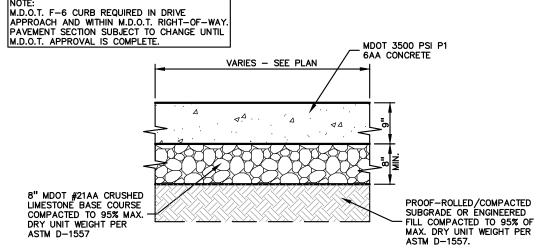SEE HEAVY-DUTY CONCRETE PAD

NOT FOR CONSTRUCTION

CITY FILE #22-029 SECTION #34

DETAIL, THIS SHEET

MATCH FINISH OF BUILDING.

23'-4"

1" x 6" WOLMANIZED #2 CEDAR

ON 2" x 6" WOLMANIZED FRAME.
STAIN TO MATCH ARCHITECTURAL

FRONT ELEVATION

- 6" DIA. CONC. FILLED GUARD POST SET IN CONCRETE

10'-10"

MASONRY ON BUILDING.

PROJECT TITLE **3420 ROCHESTER** ROAD 3420 ROCHESTER ROAD

ROCHESTER HILLS, OAKLAND COUNTY, MICHIGAN

REVISIONS

SITE/UTILITY LAYOUT

- 6" DIA. CONC. FILLED STEEL GUARD POST. W/CONC. FOOTING. HEIGHT TO BE 6" ABOVE TOP HINGE, TYP.

GUARD POSTS BY HEAVY DUTY HINGES, TYP.

SITE/UTILITY LAYOUT	04/17/24
-	
-	

ORIGINAL ISSUE DATE: AUGUST 15, 2022

DRAWING TITLE

NOTES AND DETAILS


PEA JOB NO. 2021-0117 SWS DRAWING NUMBER:

GENERAL BARRIER FREE NOTES:

PAVEMENT, GUTTERS ETC.

THE FOLLOWING NOTES PROVIDE AN OUTLINE OF SOME OF THE REQUIREMENTS CONTAINED WITHIN THE "STANDARDS FOR ACCESSIBLE DESIGN - AMERICANS WITH DISABILITIES ACT 2010", AND "ACCESSIBLE AND USEABLE BUILDINGS AND FACILITIES", ICC/ANSI A117.1-2009. THE CONTRACTOR IS RESPONSIBLE FOR ALL OF THE REQUIREMENTS PRESENTED WITHIN THESE DOCUMENTS, WHICH

- ARE AVAILABLE IN FULL UPON REQUEST. 1. AN ACCESSIBLE ROUTE CONSISTS OF WALK SURFACES, CURB RAMPS AND RAMPS. AT LEAST ONE ACCESSIBLE ROUTE SHALL BE PROVIDED WITHIN THE SITE FROM ACCESSIBLE PARKING SPACES, ACCESSIBLE PASSENGER LOADING ZONES, PUBLIC STREETS AND SIDEWALKS, AND
- PUBLIC TRANSPORTATION STOPS TO THE BUILDING OR FACILITY ENTRANCE THEY SERVE. 2. THE RUNNING SLOPE OF ALL WALKING SURFACES SHALL NOT EXCEED 5% (1:20) AND THE CROSS-SLOPE SHALL NOT EXCEED 2% (1:48). 3. WALKING SURFACES MUST BE LEVEL WITH PERMITTED VERTICAL CHANGES IN LEVEL NOT TO
- EXCEED 1/4", OR BEVELED CHANGES IN LEVEL NOT TO EXCEED 1/2". REFER TO DETAIL ON THIS SHEET. ANY CHANGE IN LEVEL GREATER THAN 1/2" MUST BE RAMPED. 4. TURNING SPACES ALONG ACCESSIBLE ROUTES MUST BE AT LEAST 5 FEET WIDE IN ALL
- DIRECTIONS AND NOT EXCEED 2% SLOPE (1:48) IN ANY DIRECTION. 5. ACCESSIBLE ROUTES WILL BE DESIGNED TO BE A MINIMUM OF 5 FEET WIDE. THE MINIMUM
- CLEAR WIDTH IS 3 FEET. 6. RAMPS ALONG ACCESSIBLE ROUTES WILL HAVE A RUNNING SLOPE GREATER THAN 5% (1:20) AND LESS THAN 8.3% (1:12).
- 7. THE CROSS-SLOPE OF RAMP RUNS SHALL NOT EXCEED 2% (1:48)
- 8. THE MINIMUM CLEAR WIDTH OF ANY RAMP IS 36 INCHES. 9. THE MAXIMUM RISE FOR ANY RAMP (NOT INCLUDING CURB RAMPS) SHALL NOT EXCEED 30 INCHES. LANDINGS ARE REQUIRED AT THE TOP AND BOTTOM OF EACH RAMP. LANDINGS SHALL HAVE A CROSS-SLOPE NOT EXCEEDING 2% (1:48), SHALL BE 5 FEET LONG AND AT LEAST AS WIDE AS THE RAMP CLEAR WIDTH. IF THERE IS A CHANGE OF DIRECTION AT A LANDING, THEN THE LANDING MUST BE AT LEAST 5 FEET WIDE AND 5 FEET LONG.
- 10. HANDRAILS ARE REQUIRED FOR ANY RAMP (NOT INCLUDING CURB RAMPS) WITH A RISE GREATER THAN 6 INCHES. ALL HANDRAILS ARE REQUIRED TO HAVE EDGE PROTECTION UNLESS ADJOINING ANOTHER ACCESS POINT OR IF THE VERTICAL DROP-OFF AT THE EDGE OF THE RAMP DOES NOT EXCEED 1/2" IN 10 FEET. EDGE PROTECTION CAN BE PROVIDED BY MEANS OF A 4" MIN. CURB OR BARRIER.
- 11. CURB RAMPS ALONG ACCESSIBLE ROUTES SHALL NOT BE STEEPER THAN 8.3% (1:12). APPROACHING SLOPES TO THE RAMP CANNOT EXCEED 5%, WHICH INCLUDES SIDÈWALKS,
- 12. IF CURB RAMP SIDES ARE FLARED, THE FLARES SHALL NOT BE STEEPER THAN 10% (1:10)... 13. CURB RAMPS SHALL BE LOCATED OR PROTECTED TO PREVENT THEIR OBSTRUCTION BY PARKED
- 14. HANDRAILS ARE NOT REQUIRED ON CURB RAMPS. 15. WHERE DETECTABLE WARNING IS REQUIRED AT CURB RAMPS, THE DETECTABLE WARNING SHALL BE 24" MINIMUM IN DEPTH AND SHALL EXTEND THE FULL WIDTH OF THE RAMP. THE DETECTABLE WARNING SHALL BE LOCATED SO THE EDGE NEAREST THE CURB IS 6 INCHES MINIMUM AND 8 INCHES MAXIMUM FROM THE CURB LINE.
- 16. FOR EVERY SIX OR FRACTION OF SIX ACCESSIBLE PARKING SPACES, ONE VAN ACCESSIBLE
- SPACE SHALL BE PROVIDED. 17. ACCESSIBLE PARKING SPACES SHALL BE LOCATED ON THE SHORTEST ACCESSIBLE ROUTE FROM PARKING TO A BUILDING ENTRANCE. 18. BARRIER FREE CAR PARKING SPACES SHALL BE A MINIMUM OF 11 FEET WIDE WITH AN ACCESS
- AISLE 5 FEET WIDE MINIMUM. 19. SURFACE SLOPES WITHIN THE PARKING SPACES AND AISLES SHALL NOT EXCEED 2% (1:48)
- 20. ACCESSIBLE AREAS INCLUDING PARKING SPACES, AISLES AND PATHWAYS, REQUIRE A MINIMUM VERTICAL CLEARANCE OF 98 INCHES.
- 21. ACCESSIBLE PARKING SPACES ARE REQUIRED TO BE IDENTIFIED BY SIGNS. THE SIGNS SHALL INCLUDE THE INTERNATIONAL SYMBOL OF ACCESSIBILITY. VAN PARKING SPACES ARE REQUIRED TO BE DESIGNATED AS "VAN ACCESSIBLE". REFER TO DETAILS ON THIS SHEET.

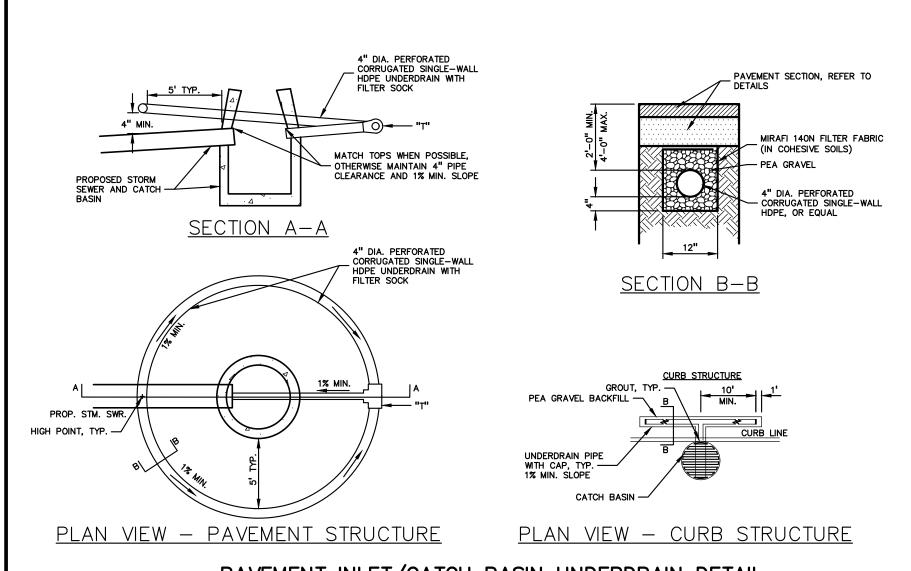

PAVEMENT INLET/CATCH BASIN UNDERDRAIN DETAIL

4"-45° BEND -

WYE FITTING OF SAME MATERIAL AS —

ADJACENT SEWER

HEAVY DUTY CAST

IRON HOUSING W/ SECURED COVER —

E.J.I.W. #1565 OR APPROVED EQUAL

2'-7" RAD.

TURN

TRAFFIC MARKINGS SHOULD BE STRIPE USING WHITE TRAFFIC PAINT UNLESS OTHERWISE NOTED ON THE PLANS.

PAINTED DIRECTIONAL ARROWS

NOT TO SCALE

STRAIGHT


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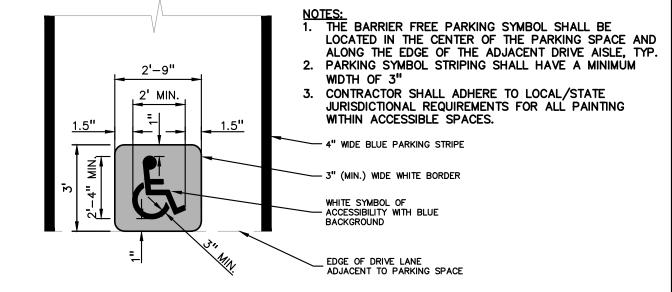
CLEANOUT

(IN ASPHALT PAVEMENT)

ENCASEMENT



UNIVERSAL BARRIER FREE PARKING STALL DETAIL

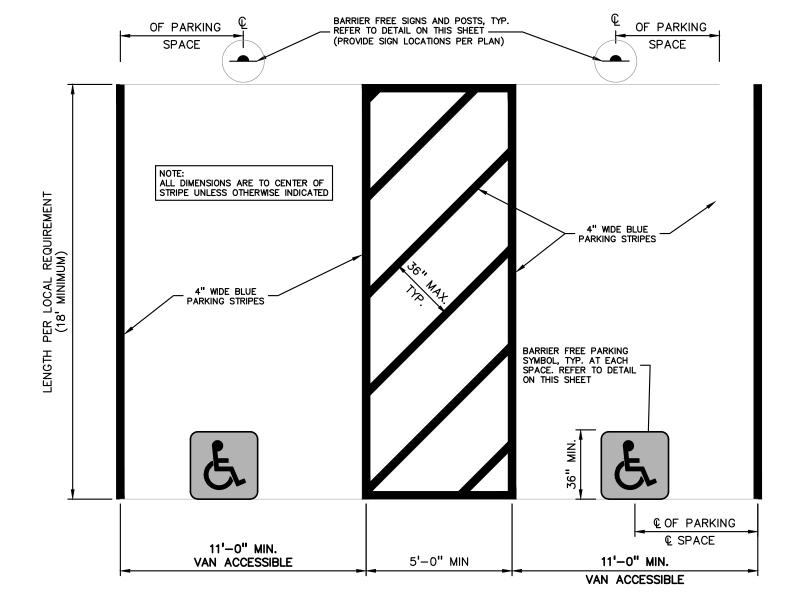

BARRIER FREE PARKING SYMBOL DETAIL (INTERNATIONAL SYMBOL OF ACCESSIBILITY)




- FIRE LANE SIGNS: APPROVED "NO PARKING FIRE LANE" SIGN MUST BE INSTALLED AND MAINTAINED IN COMPLIANCE WITH THE CRITERIA SET FORTH IN THE MICHIGAN MANUAL OF UNIFORM TRAFFIC CONTROL DEVICES. SOME OF THE CRITERIA IS AS FOLLOWS:
- SIGN SHALL BE RED LETTERING ON WHITE BACKGROUND AND SHALL READ, "FIRE LANE. NO PARKING. NO STOPPING. NO SIGNS SHALL BE SPACED NO FURTHER THAN 100 FEET APART SIGNS SHALL BE INSTALLED AT A RIGHT ANGLE 90° TO CURB SIGN SHALL BE SEVEN (7) FEET FROM THE BOTTOM OF SIGN TO GRADE SIGNS SHALL BE DOUBLE FACED WHERE SHOWN ON PLANS.
 SIGNS SHALL BE 12 INCHES IN WIDTH AND 18 INCHES IN


FIRE LANE SIGN DETAIL
NOT TO SCALE



RIGHT LANE MUST TURN RIGHT SIGN DETAIL

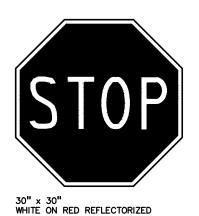

DO NOT ENTER SIGN DETAIL

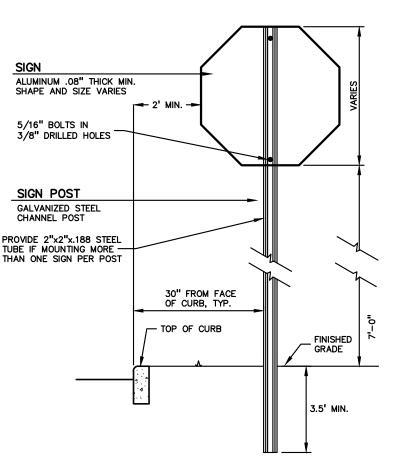

BARRIER FREE SIGN NOTES:

A MINIMUM OF 3 FEET LONG.

AND LOCAL REQUIREMENTS.

1. ONE SIGN IS REQUIRED AT EACH BARRIER FREE PARKING SPACE.

3. WHEN TWO BARRIER FREE PARKING SPACES ARE ADJACENT AND FACING EACH

OTHER, TWO SIGNS ARE REQUIRED, BUT CAN BE MOUNTED ON THE SAME POST.

5. ANCHOR POSTS SHALL BE 2.25" NOM. SQUARE 12-GAUGE GALVANIZED STEEL POST,

6. IF THESE NOTES AND DETAILS CONFLICT WITH LOCAL CODES AND ORDINANCES, THE

12"x18" x 0.080" ALUMINUM BARRIER

TO STEEL TUBE WITH 38" CADMIUM PLATED BOLTS, NUTS, AND WASHERS.

6"x12" x 0.080" ALUMINUM VAN

SECONDARY/PENALTY SIGNAGE PER JURISDICTIONAL
REQUIREMENTS WHERE APPLICABLE

BOLLARD A MINIMUM OF 2'-0".

APPLICABLE.

- ACCESSIBLE SIGN (R7-8P) WHERE

2"x2"x.188" GALVANIZED STEEL TUBE. EXTEND INTO CONCRETE FILLED PIPE

6" DIA, SCHEDULE 40 GALVANIZED STEEL PIPE FILLED WITH CONCRETE (WHEN SIGN IS LOCATED

WITH 1% FINISHED SLOPE. PAINT BOLLARD WITH 2 COATS OF SAFETY YELLOW PAINT, OR PROVIDE YELLOW BOLLARD SLEEVE...

IN PAVED AREA OR SIDEWALK). PROVIDE

ROUNDED WASH AT TOP OF CONCRETE FILL

18" DIA. CONCRETE FOOTING USING

- M.D.O.T. 'P1' CONCRETE, 3500 PSI, 6AA OR APPROVED EQUAL

INSTALL BREAKAWAY TUBE POST

IN SIGN LOCATIONS WHERE PIPE BOLLARD IS NOT REQUIRED.

- PAVEMENT SURFACE

FREE PARKING SIGN (R7-8). BOLT SIGN

7. ALTERNATE MATERIALS MAY BE USED IF IN COMPLIANCE WITH A.D.A. GUIDELINES

BARRIER FREE SIGN AND POST DETAIL

NOTE: ALTERNATE REVERSE CURB SECTION TO BE USED ONLY WHEN DRAINING AWAY FROM CURB. SEE PLANS FOR LOCATION.

EXTEND AGGREGATE

FACE

SIDEWALK RAMP AT LEAST 5%-7% SLOPE -

(MAX. SLOPE 8.3%)

STANDARD 6" HIGH CONCRETE CURB AND —/ GUTTER SECTION

TRANSITION FROM STANDARD CURB SECTION TO MODIFIED CURB SECTION — REQUIRED AT BARRIER FREE AREAS

DETECTABLE WARNING (AS REQUIRED). REFER TO PLANS FOR — DETECTABLE WARNING LOCATIONS

SLOPE AT 1.0%

OR 1/8" PER FT.

TYPICAL SIDEWALK RAMP PLAN VIEW

TYPICAL BARRIER FREE PARKING SPACES


MODIFIED 18"x6" CONCRETE CURB AND GUTTER

7/16" HOLES AT 1" CENTERS. POSTS SHALL TELESCOPE INSIDE ANCHOR POSTS A


OF UNIFORM TRAFFIC CONTROL DEVICES (MMUTCD).

STRICTER REQUIREMENT SHOULD BE USED.


NOT FOR CONSTRUCTION **CITY FILE #22-029 SECTION #34**

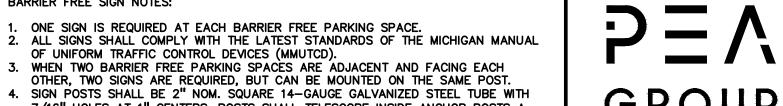

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CAUTION!! HE LOCATIONS AND ELEVATIONS OF EXISTING UNDERGROUN ILITIES AS SHOWN ON THIS DRAWING ARE ONLY APPROXIMATE. NO GUARANTEE IS EITHER EXPRESSED OR
MPLIED AS TO THE COMPLETENESS OR ACCURACY THEREOF CONTRACTOR SHALL BE EXCLUSIVELY RESPONSIBLE FOR ETERMINING THE EXACT UTILITY LOCATIONS AND ELEVATIONS RIOR TO THE START OF CONSTRUCTION.

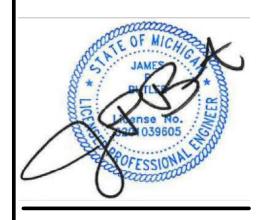RESERVED **PARKING** GREEN BORDER AN LEGEND WHITE SYMBOL, BLUE BACKGROUND. REFLECTORIZED MAY ONLY BE USED AT 11' WIDE SPACES LOCATED
ON THE LEFT SIDE OF A
5' WIDE AISLE, OR 8' WIDE
SPACES LOCATED TO THE ONLY LEFT OF 8' WIDE AISLES GREEN BORDER AND ACCESSIBLE REFLECTORIZE

REDUCE GUTTER PAN SLOPE TO 1.0%

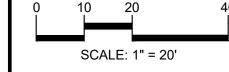TARGET SLOPE (2.0% MAX) AT BARRIER FREE PARKING SPACE LOCATIONS

PROOF-ROLLED/COMPACTED
SUBGRADE OR ENGINEERED FILL
COMPACTED TO 95% OF MAX. DR
UNIT WEIGHT PER ASTM D-1557.

STANDARD 6" HIGH — CONCRETE CURB AND GUTTER SECTION

TRANSITION FROM STANDARD CURB - SECTION TO MODIFIED CURB SECTION REQUIRED AT BARRIER FREE AREAS

MODIFIED CONCRETE CURB AND GUTTER - SECTION WITH REDUCED GUTTER SLOPE TO MEET A.D.A. REQUIREMENTS

WIDTH OF 11.0' SHALL BE MEASURED FROM CENTER OF STRIPING AND/OR TO THE CURB

CURB AND GUTTER SECTION ABOVE

(B) THE ACCESSIBLE. PARKING SPACE LENGTH SHALL BE MEASURED

FROM CENTER OF STRIPING AND/OR
TO THE CURB FACE. TO ENSURE
THE PARKING SPACE IS A.D.A.
COMPLIANT. REFER TO MODIFIED
CURB AND GUTTER DETAIL ABOVE

(A) THE STANDARD ACCESSIBLE PARKING SPACE

FACE (WHERE SPACES ARE DIMENSIONED TO THE CURB FACE). ENSURE THE PARKING SURFACE IS A.D.A. COMPLIANT BY PROVIDING THE MODIFIED

ROLLED CURB, TAPER FROM — ZERO TO 6" CURB HEIGHT ALONG RAMP LENGTH

- STANDARD SECTION

- ALT. REVERSE CURB SECTION

3420 ROCHESTER PARKING SIGN DETAIL

ROAD, LLC 29200 NORTHWESTERN HIGHWAY SUITE 450 FARMINGTON HILLS, MICHIGAN 48334

PROJECT TITLE

3420 ROCHESTER **ROAD** 3420 ROCHESTER ROAD

ROCHESTER HILLS, OAKLAND COUNTY, MICHIGAN


MODIFIED CURB AND GUTTER SECTION FOR BARRIER FREE PARKING AREAS REVISIONS SITE/UTILITY LAYOUT 12/20/23 SITE/UTILITY LAYOUT 04/17/24

ORIGINAL ISSUE DATE AUGUST 15, 2022

DRAWING TITLE **NOTES AND DETAILS**

PEA JOB NO. 2021-0117 SWS DRAWING NUMBER:


C-9.2

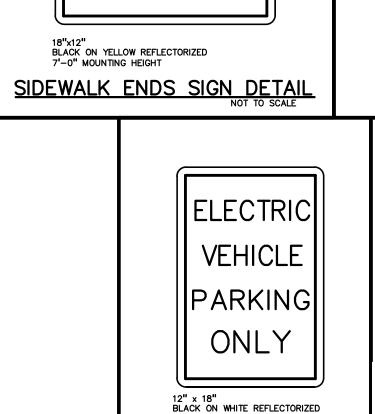


7'-0" MOUNTING HEIGHT


ELECTRIC VEHICLE


ENDS

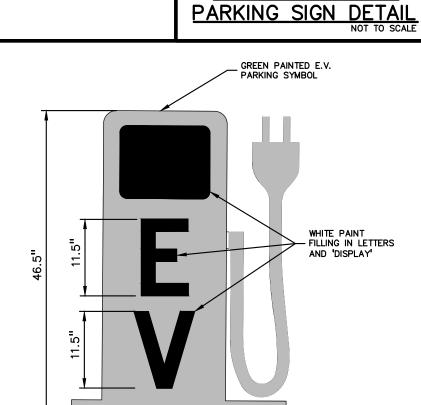


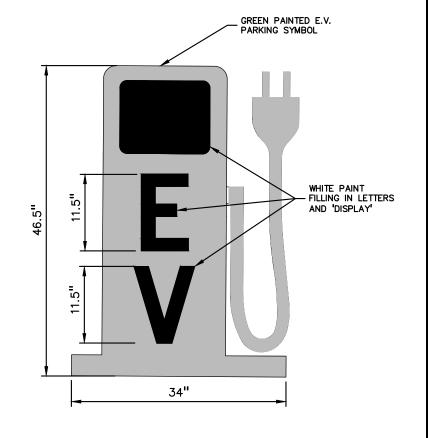


EV PARKING SYMBOL

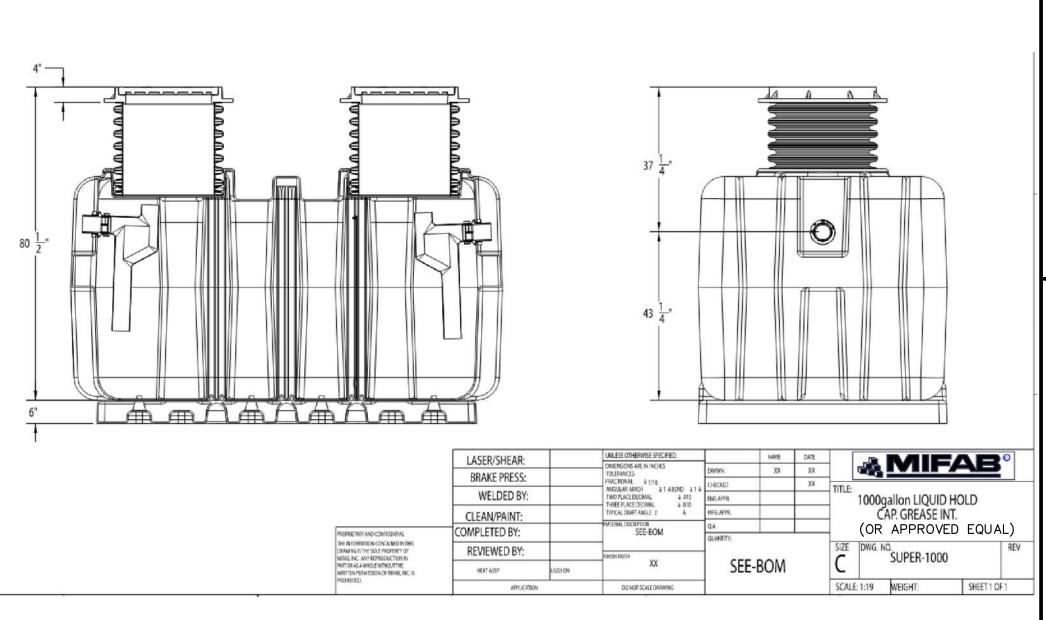

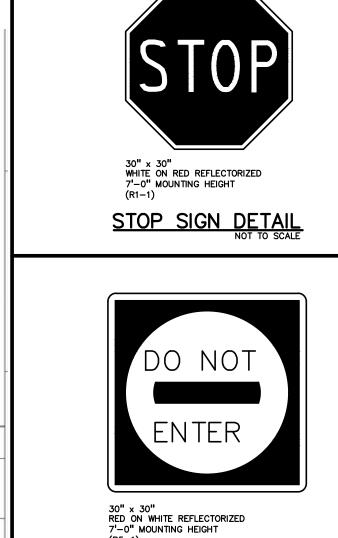

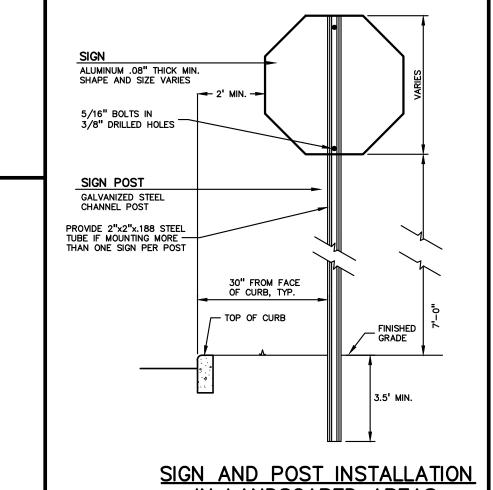



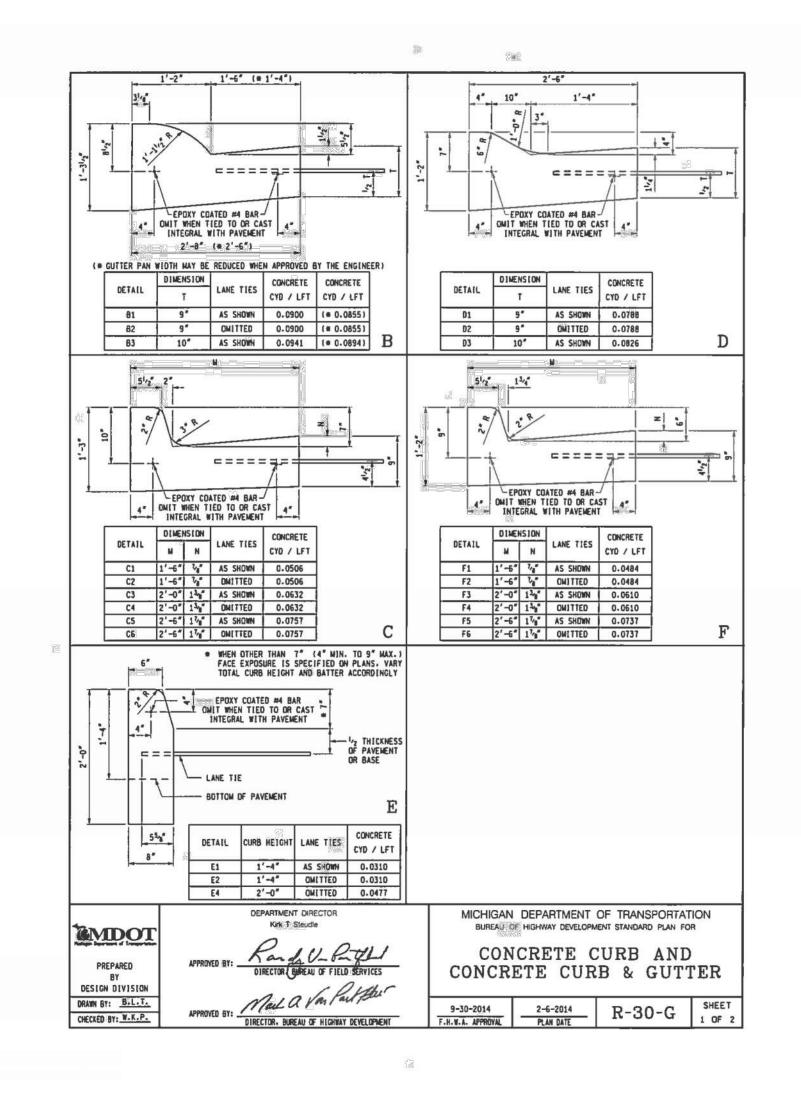

Different sight distances are required for yield or signal

controlled intersections. Contact road agency's (City,

R.C.O.C., or M.D.O.T.) design division for determining corner sight distance at yield or signalized approaches.

GHT DISTANCE

OBSERVATION POINT (DRIVER'S EYE)

FOR OFFSET

SEE NOTE

VEHICLE "P"

Any deviation from given data requires an engineering

study approved by the road agency (Clty, R.C.O.C., or

Guide for the Development of Bicycle Facilities.

M.D.O.T.) In accordance with the latest edition AASHTO

2. This design guide also applies to new Permit and Plat

The blcycle design speed used in the chart is 18 MPH.

4. Approach pathway slope greater than 8% is not

5. Existing site conditions may require an engineering

Sidewalk/Pathway _____

(DRIVER'S EYE) DESIGN

OBSERVATION POINT___

construction projects.

allowed due to ADA compliance.

study to determine sight distance.

CITY OF ROCHESTER HILLS STANDARD DETAIL FOR:

> Sight Distance Pathways

DRAWN BY: FILE NAME: PLAN DATE: REV. REV. B. SMITH CIRC DRV 8/28/1996 4/12/2012 3/15/2014

The point of vision shall be from the height of eye, 3.5 feet above the proposed intersecting elevation to a height of

object 3.5 feet above the existing or proposed road centerline and shall be continuously visible within the specified

Point of Observation:

PATHWAY GRADE

APPROACHING

INTERSECTION

limits.

(A) Eighteen (18) feet from edge of

MINIMUM CORNER SIGHT DISTANCE

FOR STREETS AT INTERSECTIONS


; \ENG\DWG\DETAILS\ROADS\SIGHT DISTANCE-Rds & Foths.DWG


SIGHT DISTANCE


IN FEET.

BOTH DIRECTIONS

pavement of sidewalk/pathway.

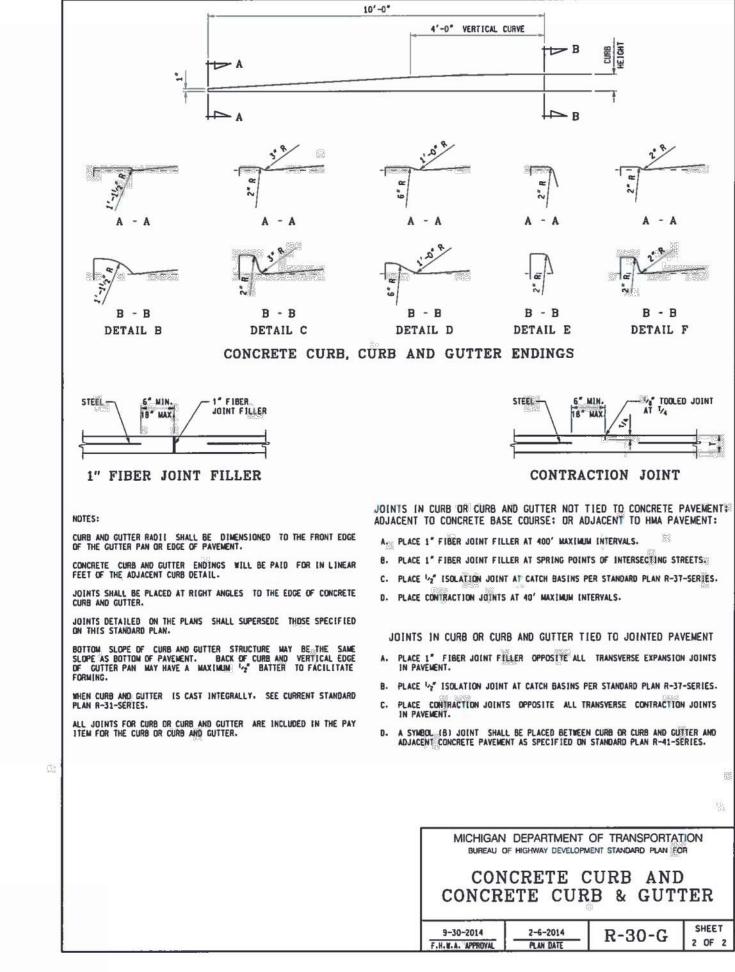

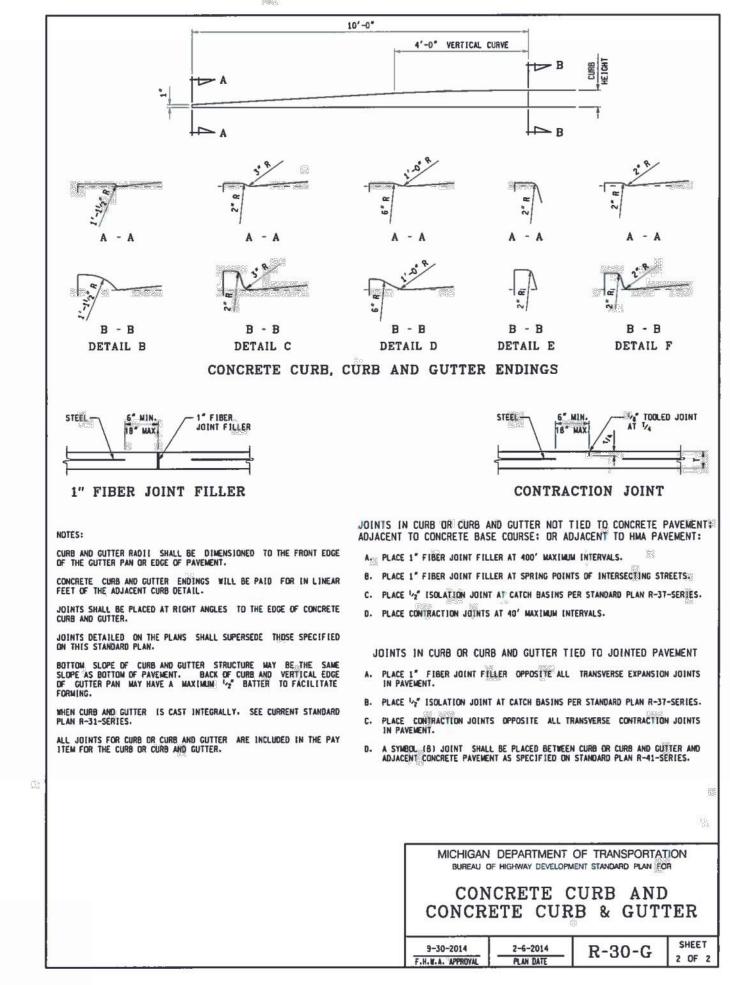

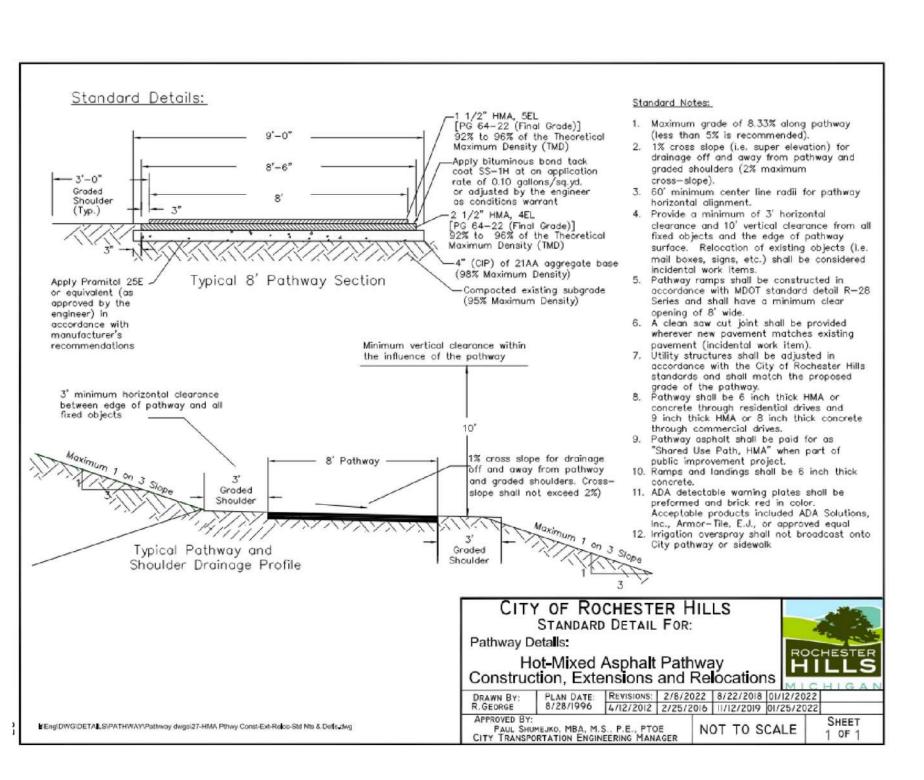











CAUTION!! THE LOCATIONS AND ELEVATIONS OF EXISTING UNDERGROUND UTILITIES AS SHOWN ON THIS DRAWING ARE ONLY UTILITIES AS SHOWN ON THIS DRAWING ARE ONLY
APPROXIMATE. NO GUARANTEE IS EITHER EXPRESSED OR
IMPLIED AS TO THE COMPLETENESS OR ACCURACY THEREOF.
THE CONTRACTOR SHALL BE EXCLUSIVELY RESPONSIBLE FOR
DETERMINING THE EXACT UTILITY LOCATIONS AND ELEVATIONS
PRIOR TO THE START OF CONSTRUCTION.

CLIENT

3420 ROCHESTER ROAD, LLC 29200 NORTHWESTERN HIGHWAY SUITE 450 FARMINGTON HILLS, MICHIGAN 48334

PROJECT TITLE

3420 ROCHESTER ROAD 3420 ROCHESTER ROAD

ROCHESTER HILLS, OAKLAND COUNTY, MICHIGAN

REVISIONS	
SITE/UTILITY LAYOUT	12/20/23
SITE/UTILITY LAYOUT	04/17/24
ORIGINAL ISSUE DATE	:


DRAWING TITLE

AUGUST 15, 2022

DETAILS


	PEA JOB NO.	2021-0117
	P.M.	LAA
ived 2024	DN.	MT
nester Hills Economic	DES.	SWS
oment	DRAWING NUMBER:	



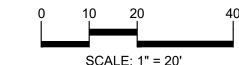




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PRIOR TO THE START OF CONSTRUCTION.

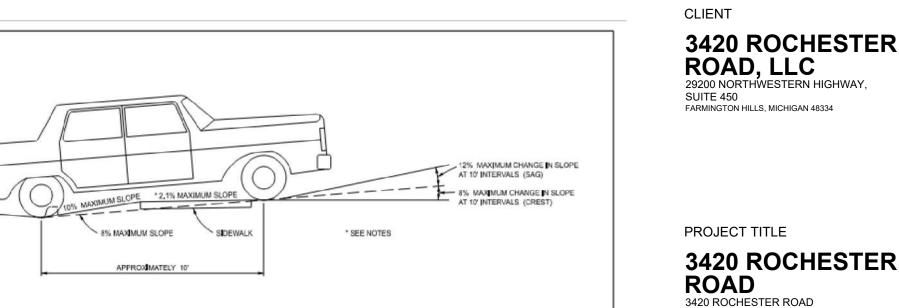

NOTES: FOR CURB AND GUTTER DETAILS, SEE STANDARD PLAN R-30-SERIES. TRANSVERSE SIDEWALK SLOPES ARE 2.1% MAXIMUM. IN ORDER TO MEET SITE CONDITIONS, IF THE TRANSVERSE SLOPE IS REQUIRED TO BE LESS THAN 1.5%, LONGITUDINAL DRAINAGE MUST BE PROVIDED. WHEN SETTING GRADES FOR COMMERCIAL DRIVES. THE TYPES OF VEHICLES USING THE DRIVE SHOULD BE CONSIDERED.

EMDOT DRIVEWAY OPENINGS & APPROACHES, AND CONCRETE SIDEWALK R-29-J

LOW VOLUME COMMERCIAL OR RESIDENTIAL DRIVEWAY SLOPES MAXIMUM GRADE 8% ~ MAXIMUM GRADE 1.5% MAXIMUM GRADE 4% -COMMERCIAL DRIVEWAY PROFILE FOR MAJOR TRAFFIC GENERATORS FOR DRIVEWAY DESIGN REFER ALSO TO "ADMINISTRATIVE RULES REGULATING DRIVEWAYS, BANNERS, AND PARADES ON OR OVER HIGHWAYS" AND GEOMETRIC DESIGN G-880-SERIES, COMMERCIAL DRIVEWAYS.

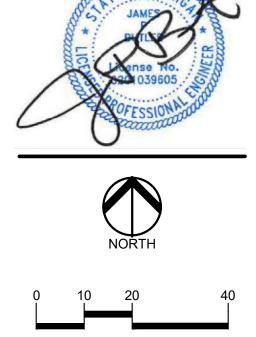

3420 ROCHESTER ROAD, LLC

29200 NORTHWESTERN HIGHWAY, FARMINGTON HILLS, MICHIGAN 48334

PROJECT TITLE


3420 ROCHESTER ROAD ROCHESTER HILLS, OAKLAND COUNTY, MICHIGAN


REVISIONS SITE/UTILITY LAYOUT 12/20/23 SITE/UTILITY LAYOUT 04/17/24 ORIGINAL ISSUE DATE:

DRAWING TITLE M.D.O.T. **DETAILS**

AUGUST 15, 2022

PEA JOB NO.	2021-0117
P.M.	LAA
DN.	MT
DES.	SWS
DRAWING NUMBER	<u> </u>

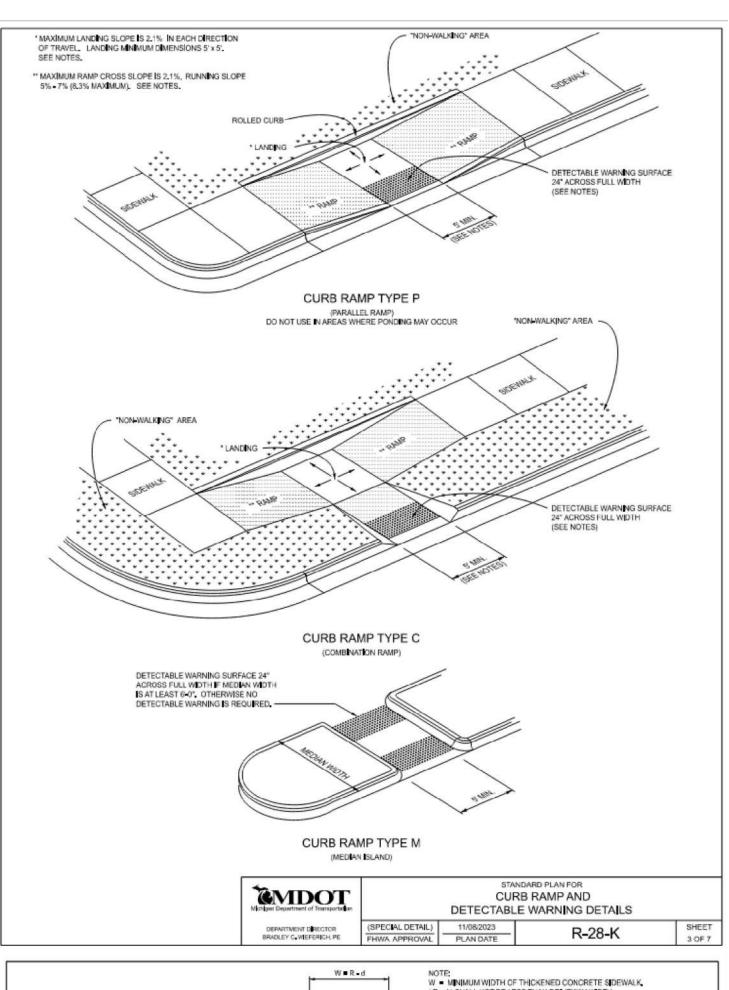

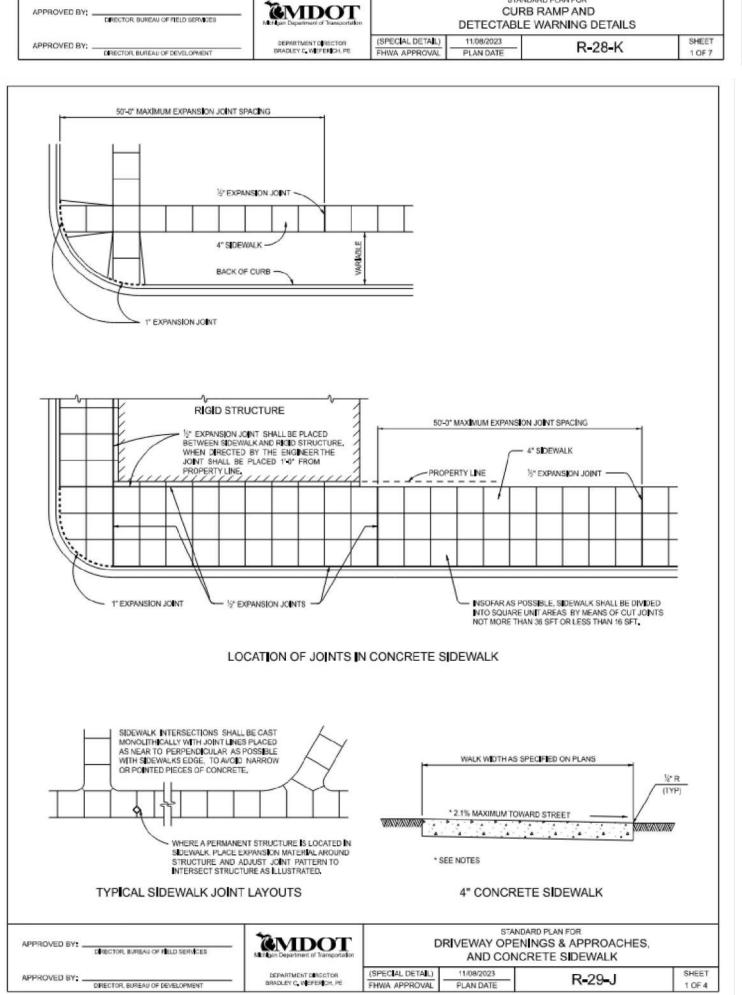

MAXIMUM LANDING SLOPE IS 2.1% IN EACH DIRECTION OF TRAVEL. LANDING MINIMUM DIMENSIONS 5' x 5'. SEE NOTES.

** MAXIMUM RAMP CROSS SLOPE IS 2.1%, RUNNING SLOPE

"NON-WALKING" AREA

CURB RAMP TYPE R (ROLLED SIDES)

FULL CURB HEIGHT MAY BE REDUCED TO ACCOMMODATE MAXIMUM SIDE FLARE SLOPE

CURB RAMP TYPE F

(FLARED SIDES, TWO RAMPS SHOWN)

MINDOT

DETECTABLE WARNING SURFACE 24" ACROSS FULL WIDTH (SEE NOTES)


CURB RAMP AND


DETECTABLE WARNING SURFACE 24" ACROSS FULL WIDTH (SEE NOTES)

5% - 7% (8,3% MAXIMUM). SEE NOTES.

DETECTABLE WARNING SURFACE 24° ACROSS FULL WIDTH

(SEE NOTES) -

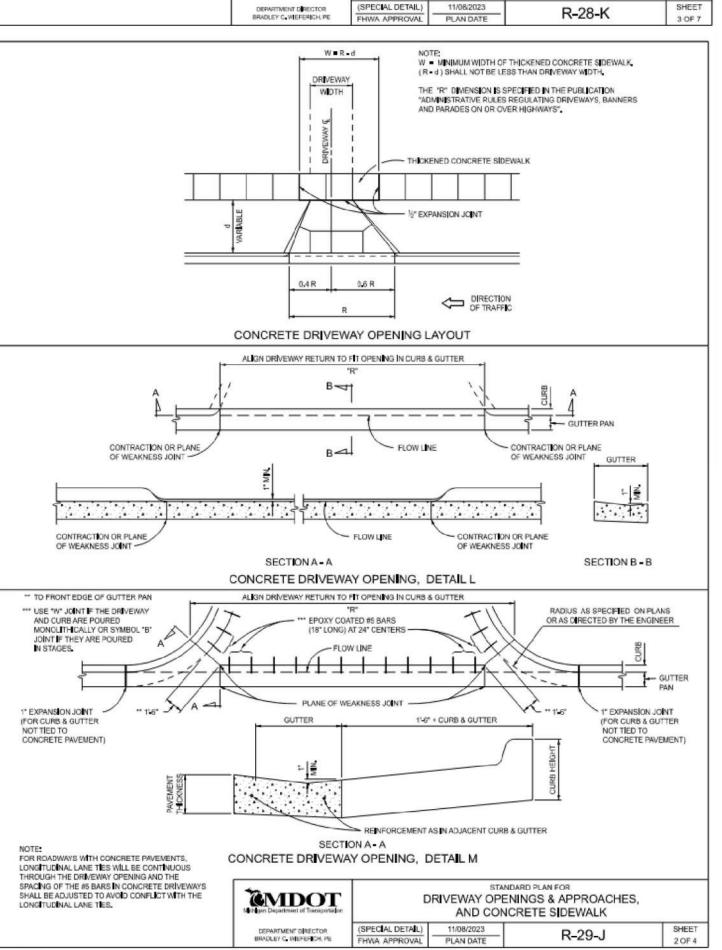

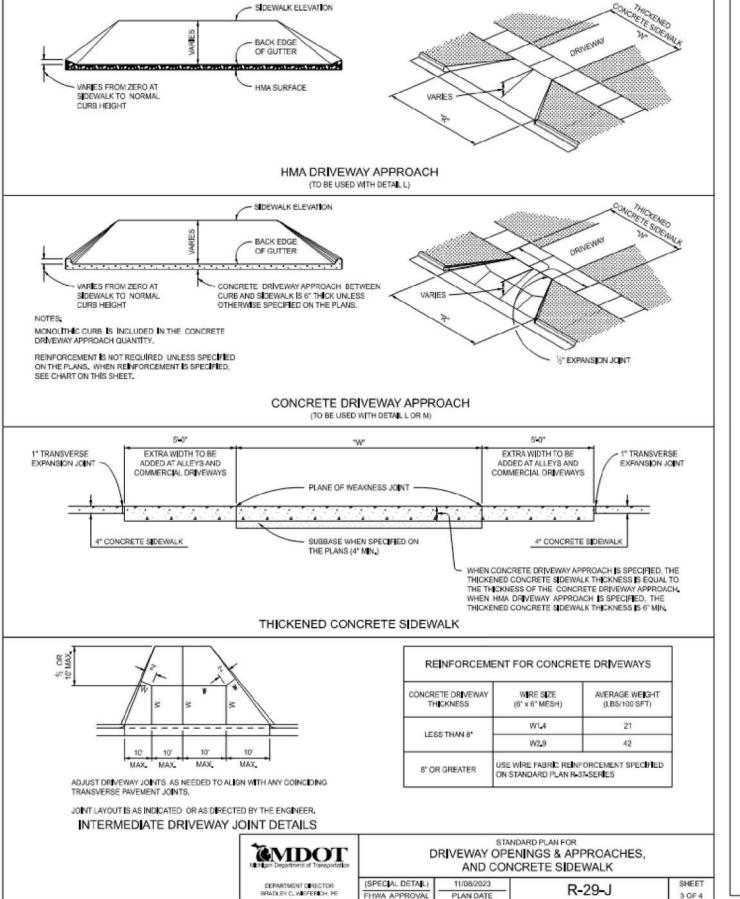

TREE PLANTING RESTRICTIONS:

PRIOR APPROVAL IS REQUIRED TO PLANT ANY TREE OR SHRUB ON THE PUBLIC RIGHT-OF-WAY. ALL TREES AND SHRUBS MUST BE PLANTED AT LEAST 10' FROM THE EDGE OF THE PUBLIC ROAD. SHADE TREES AND SHRUBS MUST BE PLANTED AT LEAST 5' FROM THE EDGE OF THE PUBLIC WALKWAY. EVERGREEN AND ORNAMENTAL TREES MUST BE PLANTED AT LEAST 10' FROM THE EDGE OF THE PUBLIC WALKWAY

NO TREES OR SHRUBS MAY BE PLANTED WITHIN THE TRIANGULAR AREA FORMED AT THE INTERSECTION OF ANY STREET RIGHT-OF-WAY LINES AT A DISTANCE ALONG EACH LINE OF 25' FROM THEIR POINT OF INTERSECTION. NO TREES OR SHRUBS MAY BE PLANTED IN THE TRIANGULAR AREA FORMED AT THE INTERSECTION OF ANY DRIVEWAY WITH A PUBLIC WALKWAY AT A DISTANCE ALONG EACH LINE OF 15' FROM THEIR POINT OF INTERSECTION.

TREES MUST BE 3' OFF ANY SIGHT LINE. ALL TREES AND SHRUBS MUST BE PLANTED AT LEAST 10' FROM ANY FIRE HYDRANT. SHADE AND EVERGREEN TREES MUST BE AT LEAST 15' AWAY FROM THE NEAREST OVERHEAD WIRE. TREES MUST BE PLANTED A MINIMUM OF 5' FROM AN UNDERGROUND UTILITY.

PLANTINGS TO BE MIN. 4' OFF FENCE LINE AND/OR PROPERTY LINE; UNLESS THE CITY'S LANDSCAPE ARCHITECT REQUIRES A GREATER DISTANCE. THESE REQUIREMENTS ARE INCORPORATED INTO THE PLAN.

CLOSING COMMENT:
PRIOR TO THE RELEASE OF THE PERFORMANCE BOND. THE
CITY OF ROCHESTER HILLS FORESTRY DIVISION NEEDS TO
INSPECT ALL TREES. EXISTING OR PLANTED. TO IDENTIFY ANY
THAT POSE A HAZARD TO THE SAFE USE OF THE PUBLIC
RIGHT-OF-WAY. FORESTRY MAY REQUIRE THE DEVELOPER TO
REMOVE. AND POSSIBLY REPLACE. ANY SUCH TREES,

ALL GROUND MOUNTED UTILITIES SHALL BE FULLY SCREENED

ALL LANDSCAPE AREAS MUST BE IRRIGATED. WATERING WILL ONLY OCCUR BETWEEN THE HOURS OF 12AM-5AM.

IRRIGATION OVERSPRAY SHALL NOT BROADCAST ONTO CITY PATHWAYS, TYP. IRRIGATION PLAN TO BE PROVIDED BY OTHERS.

TREE NOTE PER CITY OF ROCHESTER HILLS: ANY PLANT MATERIAL THAT IS DESIGNATED TO BE PRESERVED THAT DIES OR IS DAMAGED DURING OR AS A RESULT OF

REQUIREMENT

NO MORE THAN 20% OF A SINGLE PLANT SPECIES ON SITE. ALL DEC TREES SHOULD BE A MIN OF 3" CAL, ORN TREES SHOULD BE A MIN OF 2" CAL. EVG TREES A MIN OF 10' HT. OR 5' SPREAD. ALL SHRUBS SHOULD BE 30" MIN HEIGHT OR 24" IN SPREAD. NO PLANTINGS TO BE CLOSER THAN 4' FROM FENCE AND PROPERTY LINE.

CONSTRUCTION SHALL BE REPLACED PURSUANT TO ORDINANCE

LANDSCAPE CALCULATIONS: AUTOMOTIVE
NB-NEIGHBORHOOD BUSINESS/FB FLEX BUSINESS OVERLAY PER CITY OF ROCHESTER HILL'S ZONING ORDINANCE

PARKING LOT INTERIOR TREE = P 5% OF PARKING LOT TO BE LANDSCAPED AREA, FOR PARKING OF 20 OR MORE CARS, 1 DECIDUOUS TREE PER 150 SF LANDSCAPED AREA REQUIRED: 29,985 SF * 0.05 = 1,499 SF REQUIRED LANDSCAPE AREA 1,499 SF / 150 = 10 TREES

PROVIDED: 10 TREES AND 4.350 SF OF LANDSCAPED AREA EXCEEDED

RIGHT OF WAY LANDSCAPE / TREE = R 1 DEC TREE PER 35 LF OR ROW 1 ORN. TREE PER 35 LF OF ROW

REQUIRED: NAWAKWA RD: 262 LF / 35 = 7.5 DEC AND 7.5 ORN. REQUIRED: ROCHESTER RD: 158 LF / 35 = 4.5 DEC AND 4.5 ORN. REQUIRED: M-59(NE SIDE): 44 LF $\frac{1}{2}$ 5 AND $\frac{1}{3}$ 5 = 1.7 DEC AND 1.2 ORN.

PROVIDED: NAWAKWA RD: 3 EXISTING TREES, 5 DEC AND 8 ORN. PROVIDED: ROCHESTER RD: 5 DEC, AND 5 ORN. PROVIDED: M-59(NE SIDE): 2 DEC AND 2 ORN.

PERIMETER PARKING LANDSCAPE = PP REQUIRED: 1 DEC TREE/ 25LF AND 1 ORN TREE/ 35LF, ALONG EDGE OF PARKING LOT FACING AND WITHIN 100' OF PUBLIC ROW.

ANY PARKING WITHIN 30' OF PUBLIC STREET OR R.O.W REQUIRES A DEC. OR EVG. HEDGE FOR SCREENING. REQUIRED: NAWAKWA RD: 200 LF /25 AND /35 = 8 DEC AND 6 ORN. REQUIRED: ROCHESTER RD: 135 LF /25 AND /35 = 6 DEC AND 4 ORN.

PROVIDED: NAWAKWA RD: 8 DEC AND 6 ORN. AND SHRUB HEDGE PROVIDED: ROCHESTER RD: 6 DEC, AND 4 ORN. LOCATED ON THE SOUTH SIDE OF SITE AND SHRUB HEDGE

WEST BUFFER TYPE D
WHEN ZONE NB IS ADJACENT TO ZONE R, BUFFER TYPE D REQUIRED 25' MINIMUM YARD WIDTH, 2.5 DEC TREES PER 100 LF, 1.5 ORN. TREES PER 100 LF, 5 EVG PER 100 LF, 8 SHRUBS PER 100 LF

PROVIDED: MASONRY SCREEN WALL WEST SIDE OF SITE; SHRUBS ON EAST SIDE OF WALL, REPLACEMENT TREES ON WEST SIDE OF WALL AND 5 EXISTING TREES TO REMAIN ON WEST SIDE OF WALL.

TREE REPLACEMENT = RE REGULATED TREES TO BE REPLACED 1:1 RATIO REQUIRED TO LEAVE 40% OF REGULATED TREES OUTSIDE THE BLDG ENVELOPE.

SPECIMEN TREES TO BE REPLACED AT 50% DBH PROVIDED: 12, 2" DEC. OR 8' EVG. TREES AT WEST SIDE OF SITE/WALL AND 40% TREES PRESERVED.

SEE SHEET T-1.0 FOR TREE PRESERVATION PLAN

REGULATED ON SITE TREE REGULATED TREES REMOVED:

SPECIMEN TREES REMOVED: DBH OF SPECIMEN TREES REMOVED: 0 INCHES = 0 REPLACEMENT INCHES SPECIMEN REPLACMENT TREES: TREES SPECIMEN TREES TO REMAIN ON-SITE: 0 TREES REPLACEMENT REQUIRED: 12+0-0= 12 TREES (MIN, 2" DECIDUOUS OR 8' EVERGREEN)

TOTAL TREES ON SITE: EXEMPT TREES IN BUILDING: TREES TO REMAIN ON SITE: % TREES TO REMAIN: (8)/(20-0)40.0%

CITY OF ROCHESTER HILLS MAINTENANCE AGREEMENTS

PER SECTION 138-12.109 MAINTENANCE SCHEDULE: THE OWNER OF THE PROPERTY SHALL BE RESPONSIBLE FOR THE ONGOING MAINTENANCE OF THE SITE LANDSCAPE AS FOLLOWS:

A. LANDSCAPING SHALL BE KEPT IN A NEAT, ORDERLY AND HEALTHY GROWING CONDITION FREE FORM DEBRIS AND REFUSE.

B. PRUNING SHALL BE MINIMAL AT THE TIME OF INSTALLATION, ONLY TO REMOVE DEAD OR DISEASED BRANCHES. SUBSEQUENT PRUNING SHALL ASSURE C. ALL DEAD, DAMAGED OR DISEASED PLANT MATERIAL SHALL BE REMOVED IMMEDIATELY AND REPLACED WITHIN 6 MONTHS AFTER IT DIES OR IN THE NEXT PLANTING SEASON, WHICHEVER OCCURS FIRST. FOR PURPOSES OF THIS SECTION, THE PLANTING SEASON FOR DECIDUOUS PLANTS SHALL BE BETWEEN MARCH 1 AND JUNE 1 AND FROM OCTOBER 1 UNTIL THE PREPARED SOIL BECOMES FROZEN. THE PLANTING SEASON FOR EVERGREENS SHALL BE BETWEEN


MATCH 1 AND JUNE 1. PLANT MATERIAL INSTALLED TO REPLACE DEAD OR DISEASED MATERIAL SHALL BE AS CLOSE AS PRACTICAL TO THE SIZE OF THE MATERIAL IT IS INTENDED TO REPLACE. THE CITY MAY NOTIFY PROPERTY OWNERS OF THE NEED TO REPLACE DEAD, DAMAGED, OR DISEASED MATERIAL.). THE APPROVED LANDSCAPE PLAN SHALL BE CONSIDERED A PERMANENT RECORD AND INTEGRAL PART OF THE SITE PLAN APPROVAL. UNLESS OTHERWISE APPROVED IN CONCORDANCE WITH THE AFOREMENTIONED PROCEDURES, ANY REVISIONS TO OR REMOVAL OF PLANT MATERIALS, OR NON-COMPLIANCE WITH THE MAINTENANCE REQUIREMENTS OF THIS SECTION 138-12.109 WILL PLACE THE PARCEL IN NON-CONFORMITY WITH THE APPROVED LANDSCAPE PLAN AND BE A VIOLATION OF THIS ORDINANCE.

E. IF PROTECTED TREES ARE DAMAGED, A FINE SHALL BE ISSUED ON AN INCH-BY-INCH BASIS AT A MONETARY RATE AS DEFINED BY THE FORESTRY DEPARTMENT.

PLANT SCHEDULE L-1.0

SUBTOTAL

CODE	<u>QTY</u>	BOTANICAL / COMMON NAME	SIZE	CONTAINER	SPACING	REMARKS
DECIDU	JOUS T	REFS				
ARB3	4	ACER RUBRUM 'BOWHALL' / BOWHALL RED MAPLE	3" CAL.	B&B	PER PLAN	
CBF3	1	CARPINUS BETULUS 'FASTIGIATA' / PYRAMIDAL EUROPEAN HORNBEAN	3" CAL.	B&B	PER PLAN	
CA3	2	CARPINUS CAROLINIANA / AMERICAN HORNBEAM	3" CAL.	B&B	PER PLAN	
GBP3	3	GINKGO BILOBA 'PRINCETON SENTRY' / PRINCETON SENTRY GINKGO	3" CAL.	B&B	PER PLAN	
LSS3	4	LIQUIDAMBAR STYRACIFLUA 'SLENDER SILHOUETTE' / SLENDER SILHOUETTE SWEET GUM	3" CAL.	B&B	PER PLAN	
LT3	3	LIRIODENDRON TULIPIFERA / TULIP POPLAR	3" CAL.	B&B	PER PLAN	REPLACEMENT TREE
QK3	10	QUERCUS ROBUR X BICOLOR 'NADLER' / KINDRED SPIRIT® OAK	3" CAL.	B&B	PER PLAN	
SR3	5	SYRINGA RETICULATA 'IVORY SILK' / IVORY SILK JAPANESE TREE LILAC	3" CAL.	B&B	PER PLAN	
TB3	1	TILIA AMERICANA 'BOULEVARD' / BOULEVARD AMERICAN LINDEN	3" CAL.	B&B	PER PLAN	
UF3	6	ULMUS X 'FRONTIER' / FRONTIER ELM	3" CAL.	B&B	PER PLAN	
	39	SUBTOTAL:				
EVERG	REEN T	REES				
PG10	5	PICEA GLAUCA / WHITE SPRUCE	10` HT.	B&B	PER PLAN	REPLACEMENT TREE
	5	SUBTOTAL:				
ORNAM	1ENTAL	TREES				
AG3	4	AMELANCHIER X GRANDIFLORA 'AUTUMN BRILLIANCE' / AUTUMN BRILLIANCE APPLE SERVICEBERRY	3" CAL.	B&B	PER PLAN	REPLACEMENT TREE
CCF2	4	CERCIS CANADENSIS 'FOREST PANSY' / FOREST PANSY EASTERN REDBUD	2" CAL.	B&B	PER PLAN	
HL8	5	HYDRANGEA PANICULATA 'LIMELIGHT' / LIMELIGHT PANICLE HYDRANGEA	8` HT.	B&B	PER PLAN	
MJ2	3	MAGNOLIA X 'JANE' / JANE MAGNOLIA	2" CAL.	B&B	PER PLAN	
MM2	9	MALUS X 'JARMIN' / MARILEE® CRABAPPLE	2" CAL.	B&B	PER PLAN	
SM6	4	SYRINGA MEYERI 'PALIBIN' / DWARF KOREAN LILAC	6` HT.	B&B	PER PLAN	
	29	SUBTOTAL:				
SHRUB	S					
DG30		DEUTZIA GRACILIS 'NIKKO' / NIKKO DEUTZIA	30" HT.	CONT.	30" O.C.	
IG30	26	ILEX GLABRA 'SHAMROCK' / SHAMROCK INKBERRY HOLLY	30" HT.	CONT.	30" O.C.	
JH6	19	JUNIPERUS CHINENSIS 'HETZII COLUMNARIS' / HETZI COLUMN JUNIPER	6` HT.	CONT.	36"O.C.	
SNF30	29	SPIRAEA JAPONICA 'NEON FLASH' / NEON FLASH JAPANESE SPIREA	30" HT.	CONT.	36"O.C.	
TM30	22	TAXUS X MEDIA 'DENSIFORMIS' / DENSE ANGLO-JAPANESE YEW	30" HT.	CONT.	30" O.C.	
VB30	10	VIBURNUM DENTATUM 'CHRISTOM' / BLUE MUFFIN VIBURNUM	30" HT.	CONT.	36"O.C.	
	130	SUBTOTAL:				
PEREN	NIALS					
CK2	20	CALAMAGROSTIS X ACUTIFLORA 'KARL FOERSTER' / KARL FOERSTER FEATHER REED GRASS	1 GAL.	POT	30" O.C.	
	20	CURTOTAL				

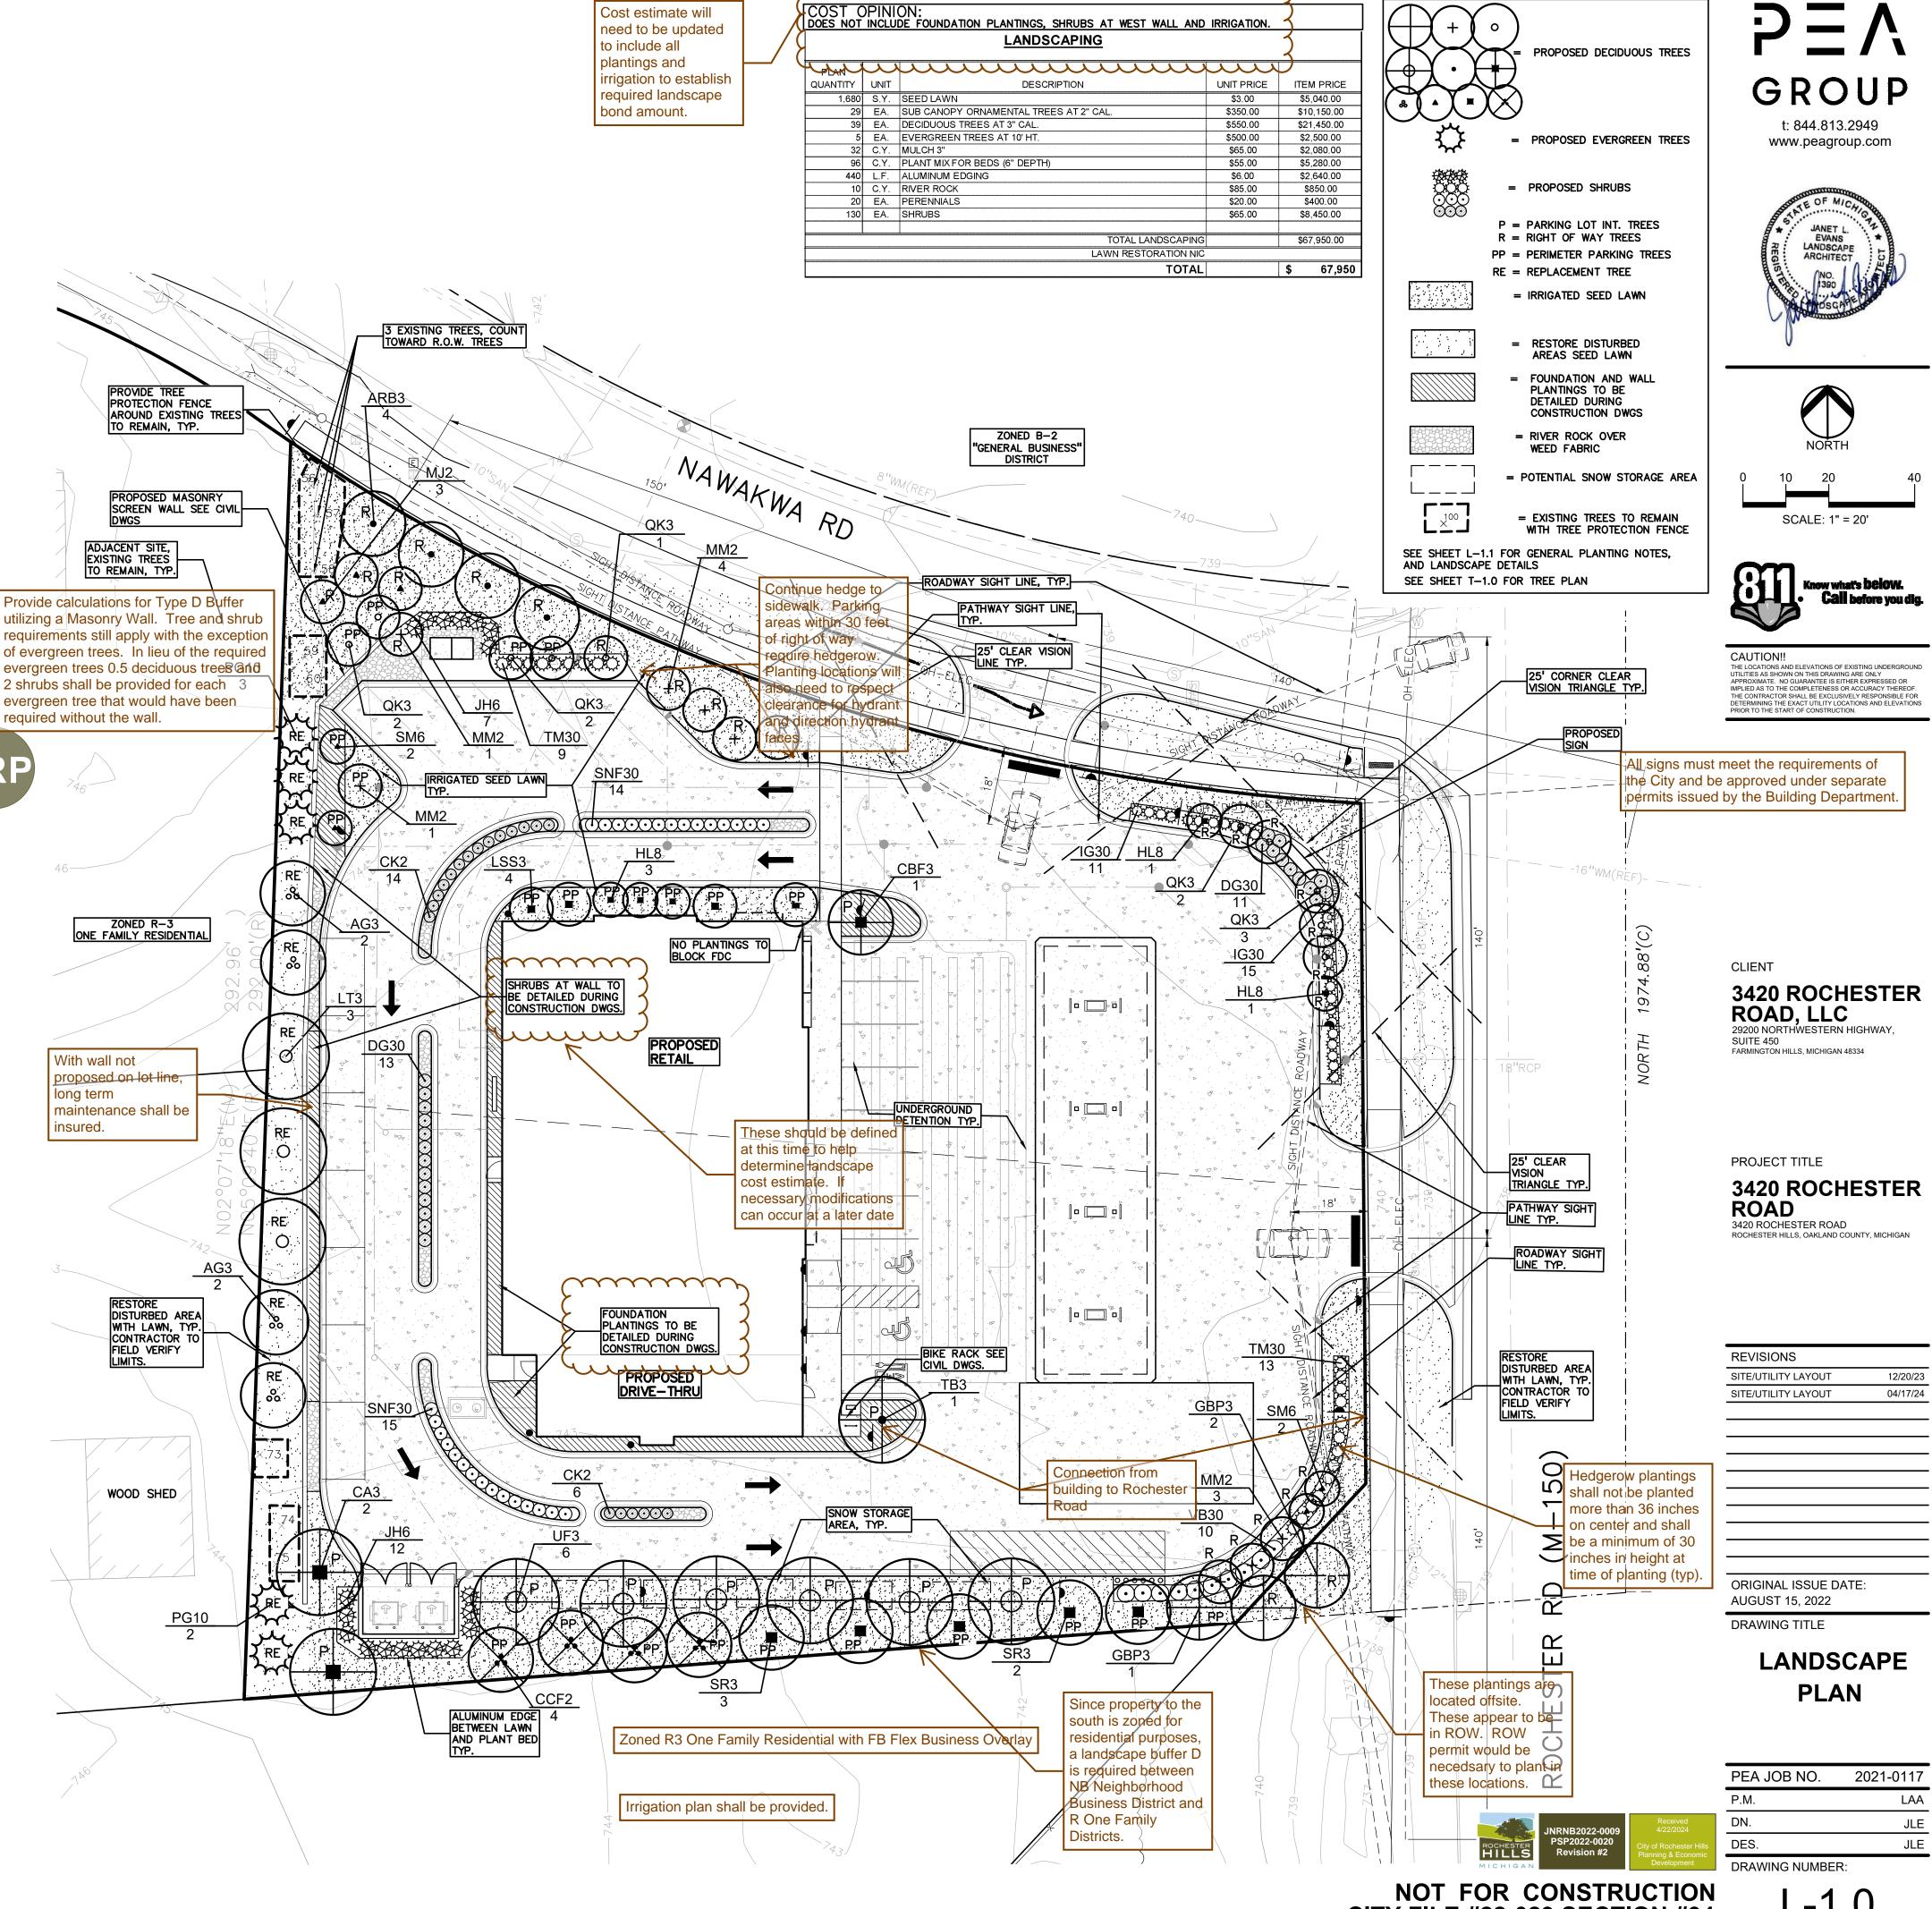


CITY FILE #22-029 SECTION #34

L-1.0

GENERAL PLANTING NOTES:

- 1. LANDSCAPE CONTRACTOR SHALL VISIT SITE, INSPECT EXISTING SITE CONDITIONS AND REVIEW PROPOSED PLANTING AND RELATED WORK. IN CASE OF DISCREPANCY BETWEEN PLAN AND PLANT LIST, PLAN SHALL GOVERN QUANTITIES. CONTACT LANDSCAPE ARCHITECT WITH ANY CONCERNS.
- 2. CONTRACTOR SHALL VERIFY LOCATIONS OF ALL ON SITE UTILITIES PRIOR TO BEGINNING CONSTRUCTION ON HIS/HER PHASE OF WORK. ELECTRIC, GAS, TELEPHONE, CABLE TELEVISION MAY BE LOCATED BY CALLING MISS DIG 1-800-482-7171. ANY DAMAGE OR INTERRUPTION OF SERVICES SHALL BE THE RESPONSIBILITY OF CONTRACTOR. CONTRACTOR SHALL COORDINATE ALL RELATED ACTIVITIES WITH OTHER TRADES ON THE JOB AND SHALL REPORT ANY UNACCEPTABLE JOB CONDITIONS TO OWNER'S REPRESENTATIVE PRIOR TO
- 3. ALL PLANT MATERIAL TO BE PREMIUM GRADE NURSERY STOCK AND SHALL SATISFY AMERICAN ASSOCIATION OF NURSERYMEN STANDARD FOR NURSERY STOCK. ALL LANDSCAPE MATERIAL SHALL BE NORTHERN GROWN, NO. 1. GRADE.
- 4. CONTRACTOR IS RESPONSIBLE FOR VERIFYING ALL QUANTITIES SHOWN ON LANDSCAPE PLAN PRIOR TO PRICING THE WORK.
- 5. THE OWNER'S REPRESENTATIVE RESERVES THE RIGHT TO REJECT ANY PLANT MATERIAL NOT MEETING SPECIFICATIONS.
- 6. ALL SINGLE STEM SHADE TREES TO HAVE STRAIGHT TRUNKS AND SYMMETRICAL
- 7. ALL SINGLE TRUNK SHADE TREES TO HAVE A CENTRAL LEADER; TREES WITH FORKED OR IRREGULAR TRUNKS WILL NOT BE ACCEPTED.
- 8. ALL MULTI STEM TREES SHALL BE HEAVILY BRANCHED AND HAVE SYMMETRICAL CROWNS. ONE SIDED TREES OR THOSE WITH THIN OR OPEN CROWNS SHALL NOT
- 9. ALL EVERGREEN TREES SHALL BE HEAVILY BRANCHED AND FULL TO THE GROUND, SYMMETRICAL IN SHAPE AND NOT SHEARED FOR THE LAST FIVE GROWING
- 10. ALL TREES TO HAVE CLAY OR CLAY LOAM BALLS, TREES WITH SAND BALLS WILL
- 11. NO MACHINERY IS TO BE USED WITHIN THE DRIP LINE OF EXISTING TREES; HAND GRADE ALL LAWN AREAS WITHIN THE DRIP LINE OF EXISTING TREES.
- 12. ALL TREE LOCATIONS SHALL BE STAKED BY LANDSCAPE CONTRACTOR AND ARE SUBJECT TO THE APPROVAL OF THE LANDSCAPE ARCHITECT PRIOR TO INSTALLATION OF THE PLANT MATERIAL.
- 13. IT IS MANDATORY THAT POSITIVE DRAINAGE IS PROVIDED AWAY FROM ALL
- 14. ALL PLANTING BEDS SHALL RECEIVE 4" SHREDDED HARDWOOD BARK MULCH WITH PRE EMERGENT, SEE SPECIFICATIONS. SHREDDED PALETTE AND DYED MULCH WILL
- 15. ALL LANDSCAPED AREAS SHALL RECEIVE 4" COMPACTED TOPSOIL.
- 16. SEE SPECIFICATIONS FOR ADDITIONAL COMMENTS, REQUIREMENTS, PLANTING PROCEDURES AND WARRANTY STANDARDS.
- 17. FOR NON-LAWN SEED MIX AREAS, AS NOTED ON PLAN, BRUSH MOW ONCE SEASONALLY FOR INVASIVE SPECIES CONTROL.
- 18. CONTRACTOR SHALL NOT INSTALL PLANTS UNDER BUILDING OVERHANG AND SHALL NOTIFY LANDSCAPE ARCHITECT IF DRAWINGS CONFLICT WITH BUILDING
- 19. TREES SHALL NOT CONFLICT/ BLOCK PROPOSED REGULATORY/ DIRECTION SIGNAGE, MONUMENT SIGNS, ADDRESS OR LIGHT POLES. SHIFT TREES AS

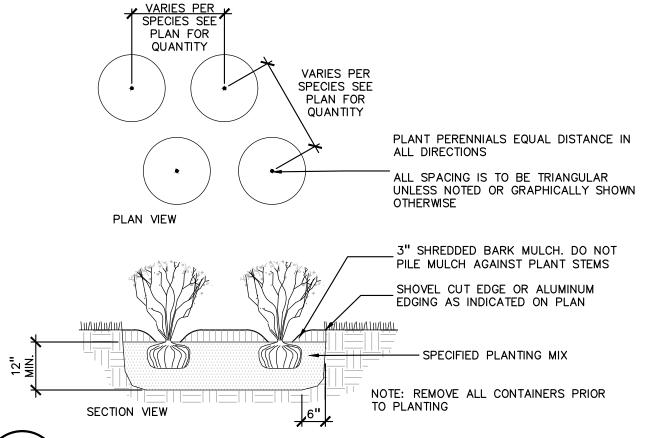

PERMALOC ALUMINUM EDGING OR APPROVED

EQUAL WITH BLACK FINISH

- COMPACTED SUBGRADE

LANDSCAPE BED EDGING SHALL BE ALUMINUM AS MANUFACTURED BY

8' OR 16' SECTIONS SHALL BE USED WITH ONE STAKE PER 38" OF

EDGING SHALL BE 3" THICK X 4" DEPTH WHEN ADJ. TO MULCH AND

STAKE SHALL SECURELY ENGAGE EDGING AND SHALL BE ENTIRELY

EDGING SHALL HAVE A MINIMUM OF 2" OF INTERLOCKING OVERLAP

INSTALL AS PER MANUFACTURER'S SPECIFICATIONS WITH TOP OF

EDGING $\frac{1}{4}$ " ABOVE COMPACTED FINISH GRADE. FINISH GRADE TO BE COMPACTED ON BOTH SIDES OF EDGING TO MAINTAIN STABILITY

PLANT SO THAT TOP OF ROOT BALL IS

PLACE ROOTBALL ON UNEXCAVATED OR

TAMPED SOIL

FLUSH TO GRADE OR 1-2" HIGHER IF

IN POORLY DRAINED SOILS

THICK X 5 1" DEPTH WHEN ADJ. TO ROCK, FINISH: BLACK

- BED MEDIA

SPECIFICATIONS FOR LANDSCAPE BED EDGING:

PERMALOC 1.800.356.9660

DURAFLEX MEETING AAMA 2603

BELOW TOP SURFACE OF EDGING


BETWEEN SECTIONS

LUMINUM EDGE DETAIL

SCALE: 1/2'' = 1'-0''

PERENNIAL PLANTING DETAIL

SCALE: 1'' = 2'-0''

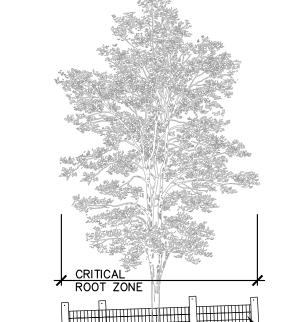

START OF CONSTRUCTION ACTIVITIES AND SHALL REMAIN IN PLACE UNTIL CONSTRUCTION IS COMPLETE NO PERSON MAY CONDUCT ANY ACTIVITY WITHIN THE DRIP LINE OF ANY TREE DESIGNATED TO REMAIN; INCLUDING, BUT NOT LIMITED TO PLACING SOLVENTS, BUILDING MATERIAL, CONSTRUCTION EQUIPMENT OR SOIL DEPOSITS WITHIN DRIP LINES

TREE PROTECTION WILL BE ERECTED PRIOR TO

GRADE CHANGES MAY NOT OCCUR WITHIN THE DRIP

LINE OF PROTECTED TREES DURING CONSTRUCTION, NO PERSON SHALL ATTACH

ANY DEVICE OR WIRE TO ANY REMAINING TREE

ALL UTILITY SERVICE REQUESTS MUST INCLUDE NOTIFICATION TO THE INSTALLER THAT PROTECTED TREES MUST BE AVOIDED. ALL TRENCHING SHALL OCCUR OUTSIDE OF THE PROTECTIVE FENCING

TREES LOCATED ON ADJACENT PROPERTY THAT MAY BE AFFECTED BY CONSTRUCTION ACTIVITIES MUST BE

TREES TO BE PRESERVED SHALL BE IDENTIFIED WITH FLAGGING PRIOR TO THE TREE CLEARING OPERATIONS PROVIDE FENCE AROUND CRITICAL ROOT ZONE OF

FENCE SHALL BE PLACED IN A CIRCLE WITH A MINIMUM RADIUS OF 1' PER 1" DIAMETER OF THE

TREE MEASURED AT 4.5' ABOVE GROUND 4'HIGH PROTECTIVE FENCING WITH STEEL POSTS - 10' O.C. - EXISTING SOIL

TREE PROTECTION DETAIL

SCALE: 1'' = 3'-0''

CAUTION!! THE LOCATIONS AND ELEVATIONS OF EXISTING UNDERGROUND UTILITIES AS SHOWN ON THIS DRAWING ARE ONLY APPROXIMATE. NO GUARANTEE IS EITHER EXPRESSED OR IMPLIED AS TO THE COMPLETENESS OR ACCURACY THEREOF. THE CONTRACTOR SHALL BE EXCLUSIVELY RESPONSIBLE FOR DETERMINING THE EXACT LITH BY LOCATIONS AND ELEVATIONS.

DETERMINING THE EXACT UTILITY LOCATIONS AND ELEVATIONS PRIOR TO THE START OF CONSTRUCTION.

3420 ROCHESTER

29200 NORTHWESTERN HIGHWAY,

ROAD, LLC

FARMINGTON HILLS, MICHIGAN 48334

PROJECT TITLE

REVISIONS

SITE/UTILITY LAYOUT

SITE/UTILITY LAYOUT

ORIGINAL ISSUE DATE:

LANDSCAPE

DETAILS

2021-0117

LAA

JLE

JLE

AUGUST 15, 2022

DRAWING TITLE

PEA JOB NO.

P.M.

DN.

DES.

SUITF 450

GROUP

t: 844.813.2949

www.peagroup.com

LANDSCAPE

ARCHITEC'

PLANT SO THAT TOP OF ROOT BALL IS FLUSH TO GRADE OR 1-2" HIGHER IF IN POORLY DRAINED SOILS STAKING/GUYING **LOCATION** CONTINUOUS RIM MIN. TYP.

STAKE JUST BELOW BRANCHES WITH 2"-3" WIDE NYLON OR PLASTIC STRAPS. CONNECT FROM TREE TO STAKE AND ALLOW FOR FLEXIBILITY. REMOVE AFTER (1) ONE YEAR. (DO NOT USE WIRE & HOSE)

THREE 2"X2" HARDWOOD STAKES OR STEEL T-POSTS DRIVEN A MIN. OF 18" DEEP FIRMLY INTO SUBGRADE PRIOR TO BACKFILLING

SHREDDED HARDWOOD BARK MULCH TO DRIPLINE. 3" DEEP AND LEAVE 3" CIRCLE OF CLIENT BARE SOIL AROUND TREE TRUNK. DO NOT PLACE MULCH IN CONTACT WITH TREE TRUNK. FORM SAUCER WITH 4" HIGH

-FINISH GRADE SPECIFIED PLANTING MIX, WATER & TAMP TO - REMOVE AIR POCKETS, ÁMEND SOIL PER SITE CONDITIONS & TREE REQUIREMENTS EXPOSE ROOT FLARE OF TREE. CONTRACTOR MAY HAVE TO REMOVE EXCESS SOIL FROM TOP OF ROOTBALL. REMOVE ALL BURLAP FROM TOP 3 OF ROOTBALL. DISCARD ALL NON-BIODEGRADABLE MATERIAL OFF SITE

PLACE ROOTBALL ON UNEXCAVATED OR TAMPED SOIL

3420 ROCHESTER

ROAD 3420 ROCHESTER ROAD

12/20/23

04/17/24

EVERGREEN TREE PLANTING DETAIL SCALE: 1'' = 3'-0''

120° STAKING/GUYING <u>LOCATION</u>

PLANT SO THAT TOP OF ROOT BALL IS FLUSH TO GRADE OR 1-2" HIGHER IF IN POORLY DRAINED SOILS

MATERIAL AT TOP & BOTTOM, REMOVE AFTER FIRST WINTER DO NOT PRUNE TERMINAL LEADER PRUNE

SECURE TREE WRAP WITH BIODEGRADABLE

ONLY DEAD, BROKEN BRANCHES AS DIRECTED BY LANDSCAPE ARCHITECT

STAKE JUST BELOW BRANCHES WITH 2"-3" WIDE NYLON OR PLASTIC STRAPS. CONNECT - FROM TREE TO STAKE AND ALLOW FOR FLEXIBILITY. REMOVE AFTER (1) ONE YEAR. (DO NOT USE WIRE & HOSE)

(3) THREE 2"X2" HARDWOOD STAKES DRIVEN A MIN. OF 18" DEEP FIRMLY INTO SUBGRADE PRIOR TO BACKFILLING


SHREDDED HARDWOOD BARK MULCH TO DRIPLINE. 3" DEEP AND LEAVE 3" CIRCLE OF BARE SOIL AROUND TREE TRUNK. DO NOT PLACE MULCH IN CONTACT WITH TREE TRUNK. FORM SAUCER WITH 4" HIGH

CONTINUOUS RIM SPECIFIED PLANTING MIX, WATER & TAMP TO - REMOVE AIR POCKETS, AMEND SOIL PER SITE CONDITIONS & TREE REQUIREMENTS


-FINISH GRADE

EXPOSE ROOT FLARE OF TREE. CONTRACTOR MAY HAVE TO REMOVE EXCESS SOIL FROM - TOP OF ROOTBALL. REMOVE ALL BURLAP FROM TOP 1 OF ROOTBALL. DISCARD ALL NON-BIODEGRADABLE MATERIAL OFF SITE PLACE ROOTBALL ON UNEXCAVATED OR

DRAWING NUMBER:

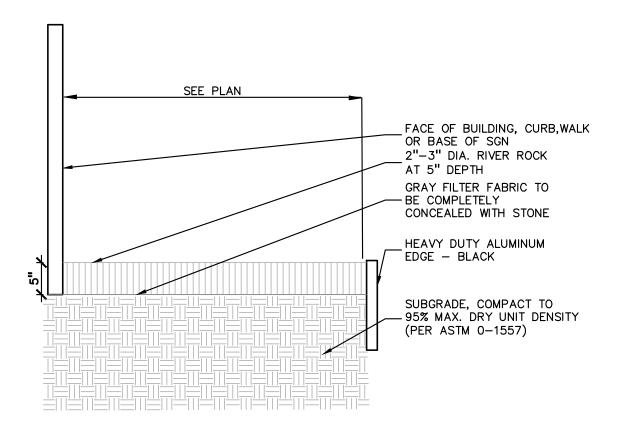

RIVER ROCK EDGE DETAIL SCALE: $1 \frac{1}{2}$ " = 1'-0"

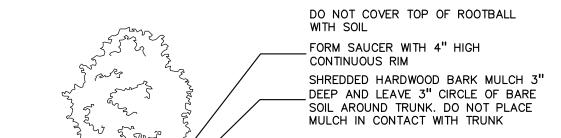

- FINISH GRADE TAMP TO REMOVE AIR POCKETS -ROOTBALL. DISCARD ALL NON-BIODEGRADABLE MATERIAL OFF SITE VARIES ON CONTAINER

SHRUB PLANTING DETAIL

OR BALL SIZE

SPECIFIED PLANTING MIX. WATER AND REMOVE ALL BURLAP FROM TOP 1 OF


SCALE: 1'' = 2'-0''


SCALE: 1'' = 3'-0''

MIN. TYP.

DECIDUOUS TREE PLANTING DETAIL

NOT FOR CONSTRUCTION **CITY FILE #22-029 SECTION #34**

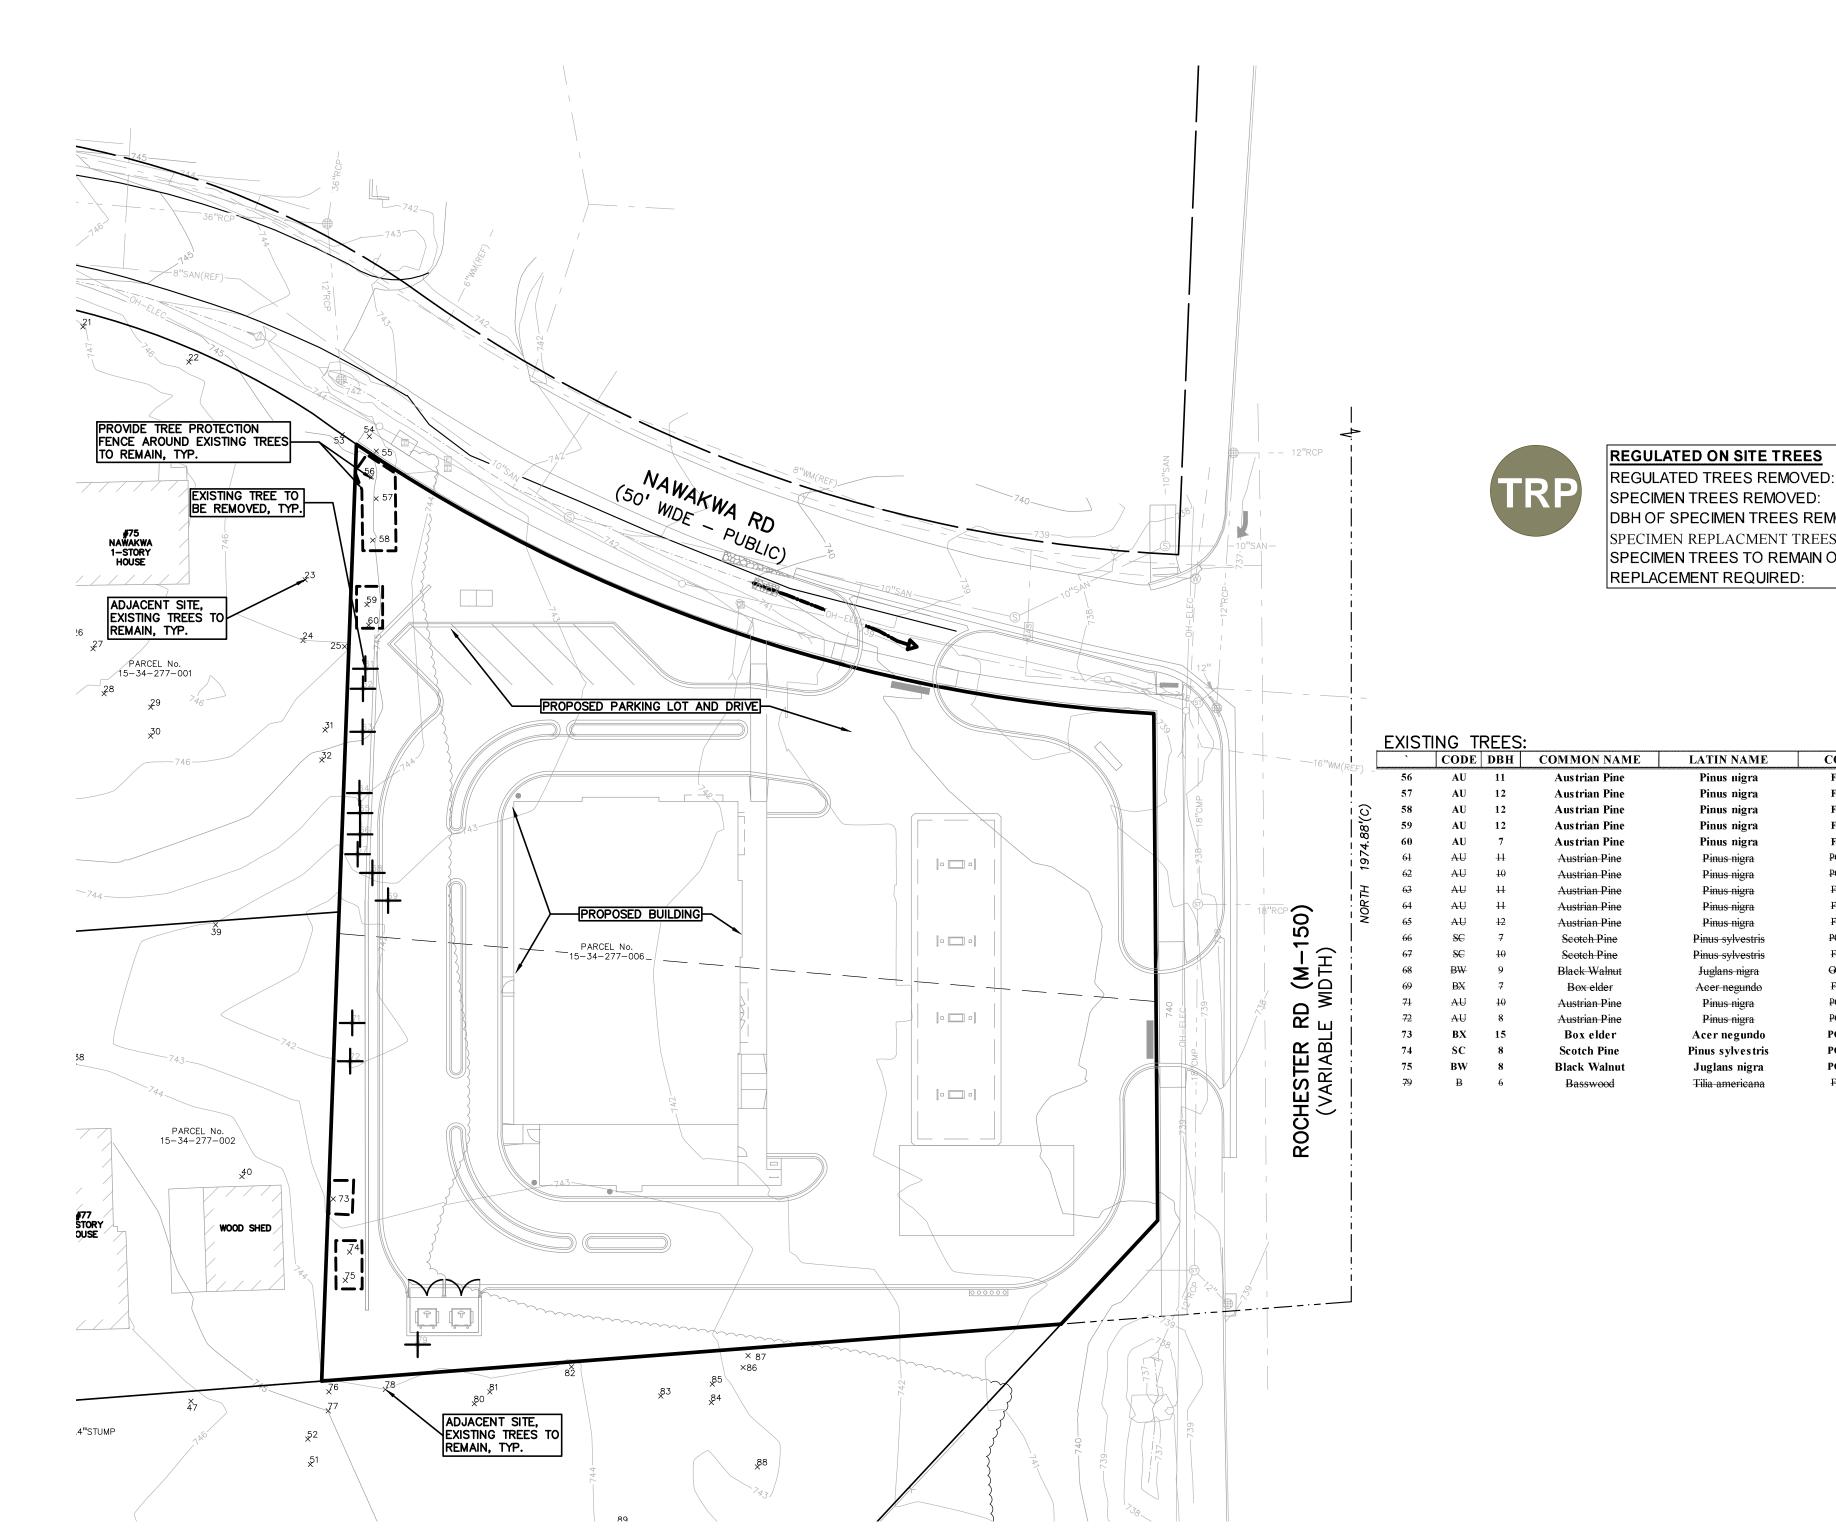

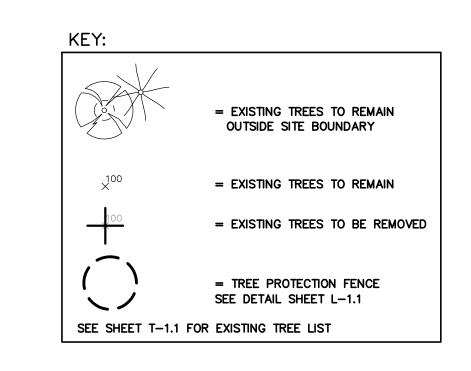



Austrian Pine

Austrian Pine

Austrian Pine

Austrian Pine

Scotch Pine

Scotch Pine

Black Walnut

Box elder

Scotch Pine

Black Walnut

Pinus nigra

Pinus nigra

Pinus nigra

Pinus nigra Pinus nigra

Pinus nigra Pinus nigra Pinus nigra

Pinus nigra

Pinus sylvestris

Pinus sylvestris

Juglans nigra

Acer negundo

Pinus nigra

Pinus nigra

Acer negundo

Pinus sylvestris

Juglans nigra

Tilia americana

FAIR

POOR

POOR

POOR

POOR

POOR

FAIR

REGULATED ON SITE TREES					
REGULATED TREES REMOVED:	12				
SPECIMEN TREES REMOVED:	0				
DBH OF SPECIMEN TREES REMOVED:	0	INCHES =	- 0	REPLACEMENT IN	ICHES
SPECIMEN REPLACMENT TREES:	0	TREES			
SPECIMEN TREES TO REMAIN ON-SITE:	: 0	TREES			
REPLACEMENT REQUIRED:	12+0-0=	12	TREES	(MIN, 2" DECIDUOUS	OR 8' EVERGREEN)

TOTAL TREES ON SITE: 20 EXEMPT TREES IN BUILDING: TREES TO REMAIN ON SITE: % TREES TO REMAN: (8)/(20-0)

40.0%


	<u>-</u>					<u>-</u>
OND	COMMENT	EXEMPT?	SPECIMEN	SAVE / REMOVE	OFFSITE/ NIC	IN BULDING
FAIR			N	S	N	N
FAIR			N	S	N	N
FAIR			N	S	N	N
FAIR			N	S	N	N
FAIR			N	S	N	N
POOR			И	R	И	N
POOR			Ŋ	R	N	N
FAIR			И	R	N	N
FAIR			И	R	А	N
FAIR			И	R	А	N
POOR			N	R	N	H
FAIR			А	R	Н	N
						T



www.peagroup.com





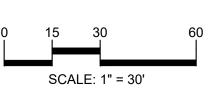



CAUTION!!
THE LOCATIONS AND ELEVATIONS OF EXISTING UNDERGROUND
UTILITIES AS SHOWN ON THIS DRAWING ARE ONLY
APPROXIMATE. NO GUARANTEE IS EITHER EXPRESSED OR
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THE CONTRACTOR SHALL BE EXCLUSIVELY RESPONSIBLE FOR
DETERMINING THE EXACT UTILITY LOCATIONS AND ELEVATIONS
PRIOR TO THE START OF CONSTRUCTION.

3420 ROCHESTER ROAD, LLC 29200 NORTHWESTERN HIGHWAY, SUITE 450 FARMINGTON HILLS, MICHIGAN 48334

PROJECT TITLE

3420 ROCHESTER ROAD
3420 ROCHESTER ROAD
ROCHESTER HILLS, OAKLAND COUNTY, MICHIGAN


REVISIONS	
SITE/UTILITY LAYOUT	12/20/23
SITE/UTILITY LAYOUT	04/17/24
ORIGINAL ISSUE DATE	:
ALIOUET 45, 0000	

AUGUST 15, 2022 DRAWING TITLE

TREE PLAN



JLE

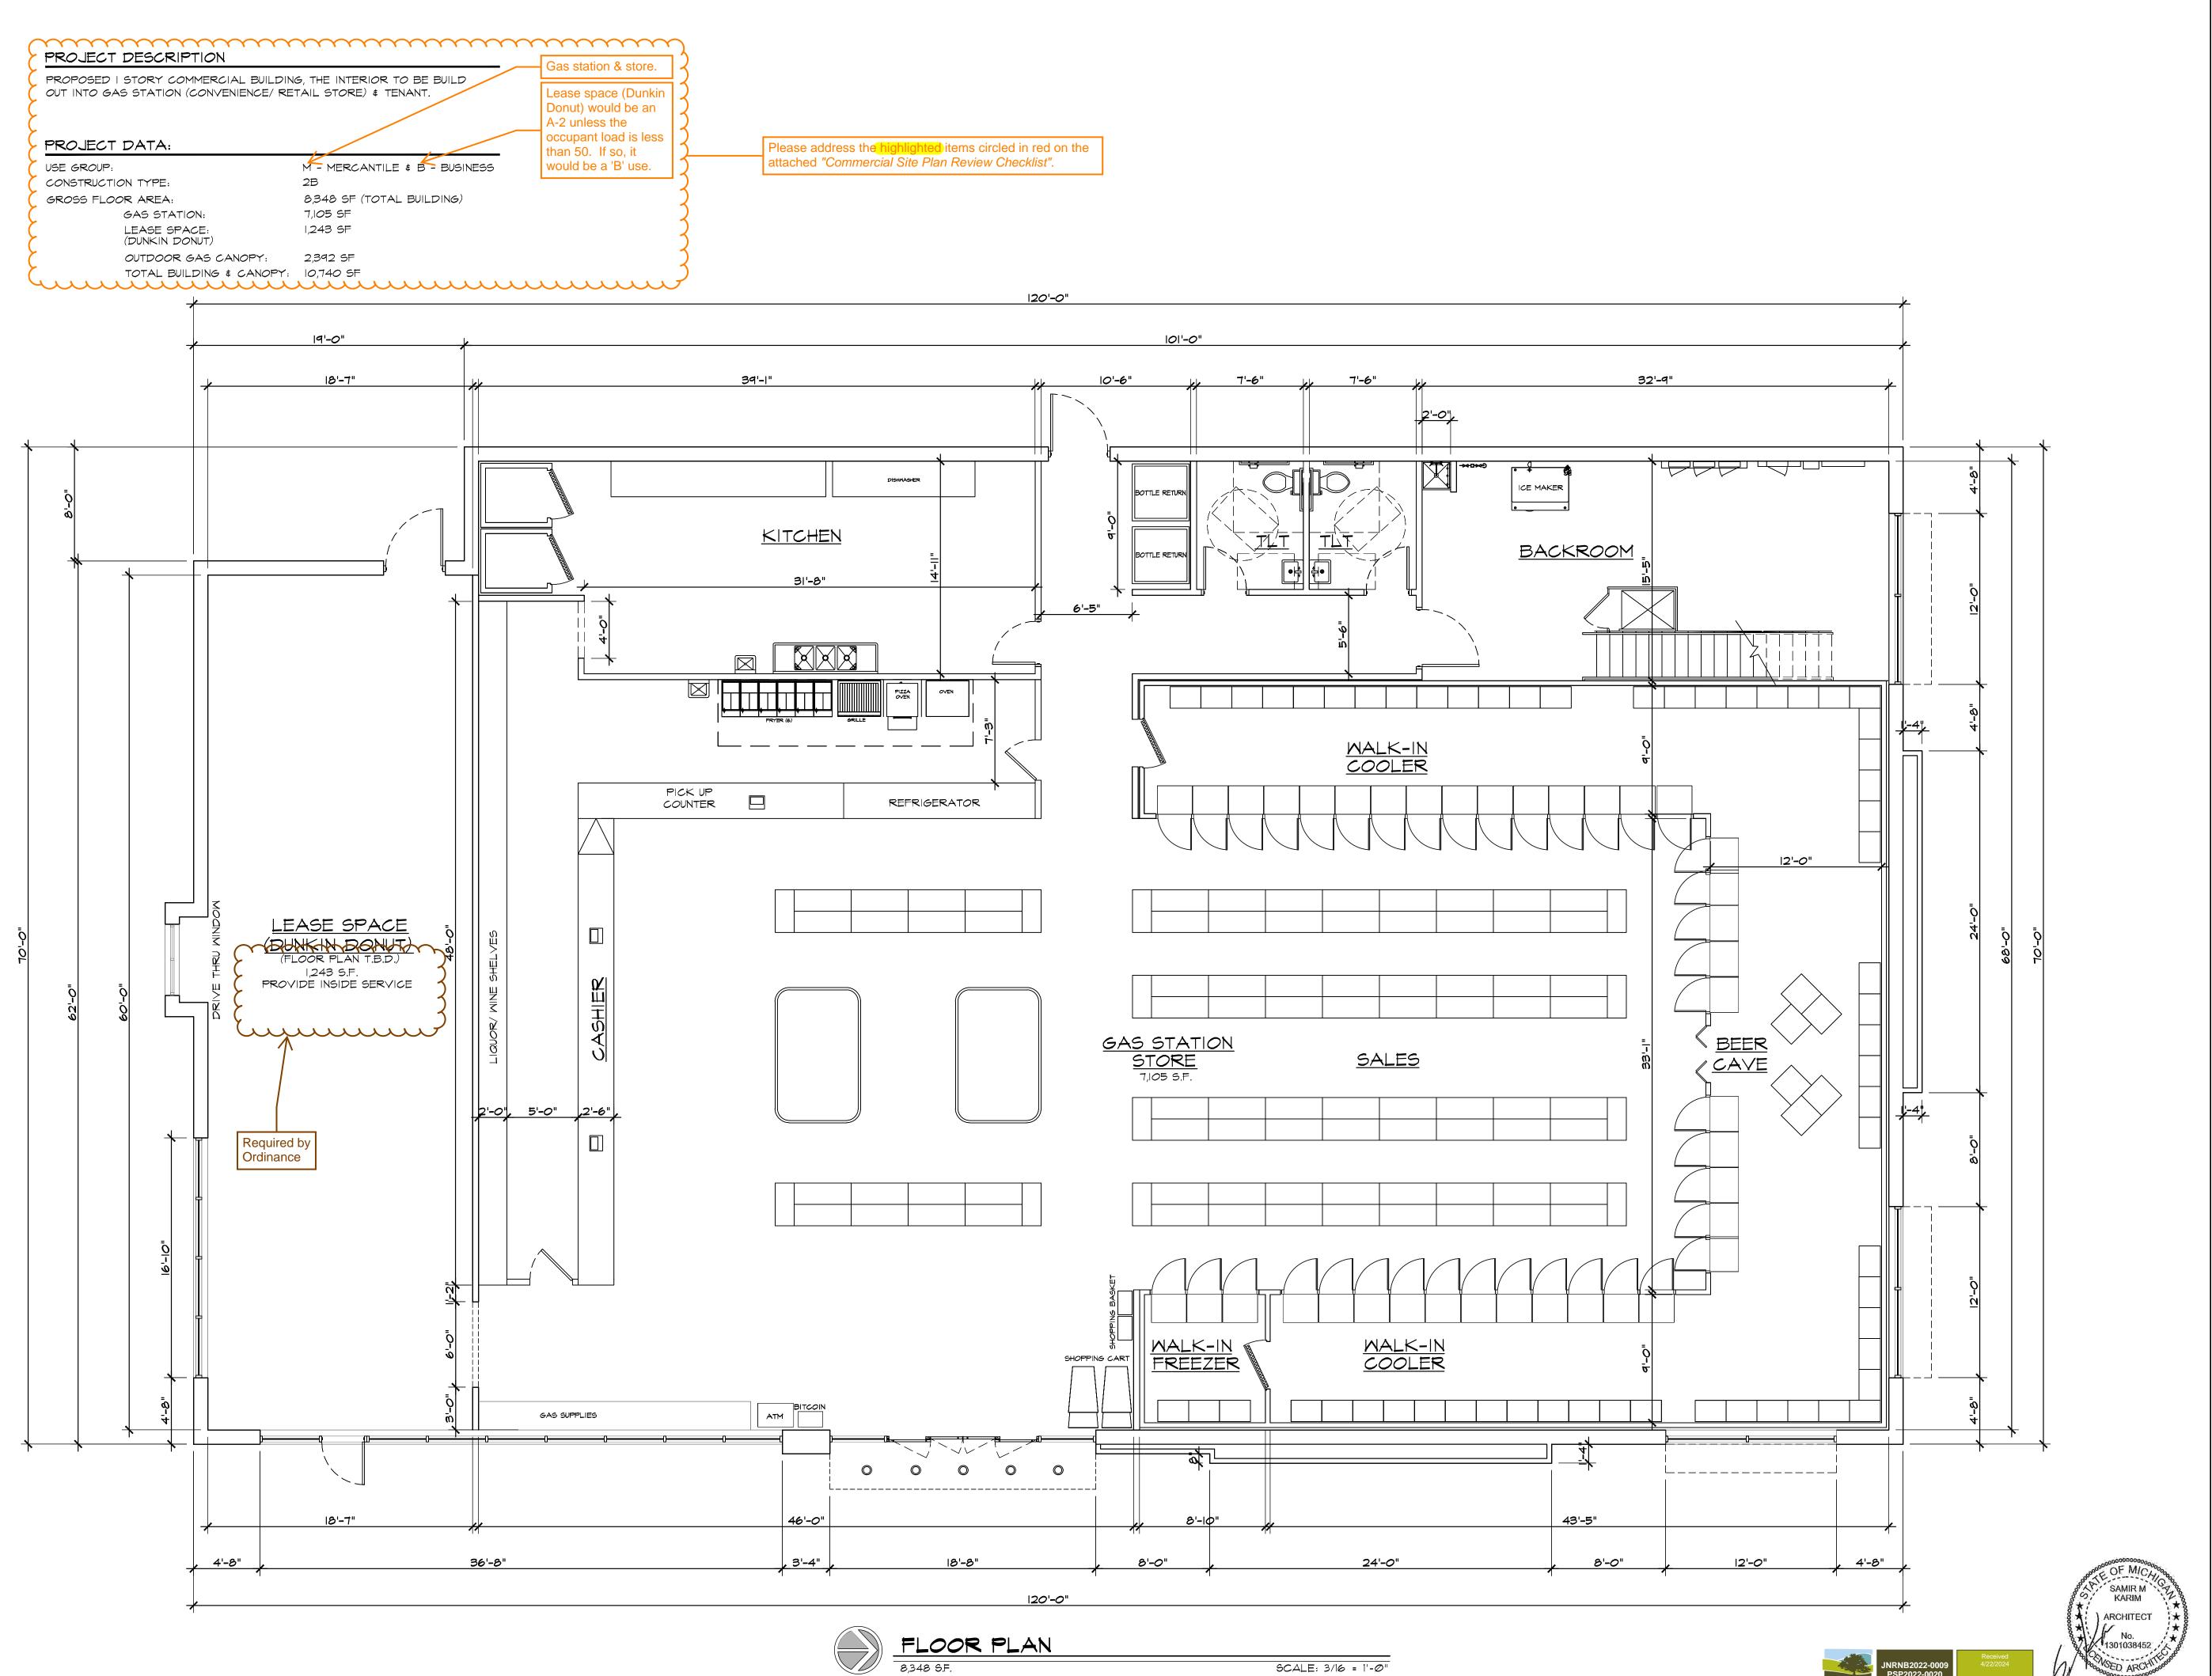

ARCHITECTURAL DESIGN

RESIDENTIAL COMMERCIAL INDUSTRIAL

G.A.V. ASSOCIATES, INC 24001 ORCHARD LAKE RD., STE. 180A FARMINGTON, MICHIGAN 48336 PH: (248) 985-9101 WEB: WWW.GAVASSOCIATES.COM



SED DRAMINGS FOR:
ATION
ROCHESTER ROAD
CTED HILLS MICHIAN

DRAWN: DESIGNED: CHECKED:
M.B. G.A. G.A.


SCALE : AS SHOWN

SCALE : AS SHOWN
FILE NAME :

JOB #: 21091

SHEET TITLE FLOOR PLAN

SHEET #

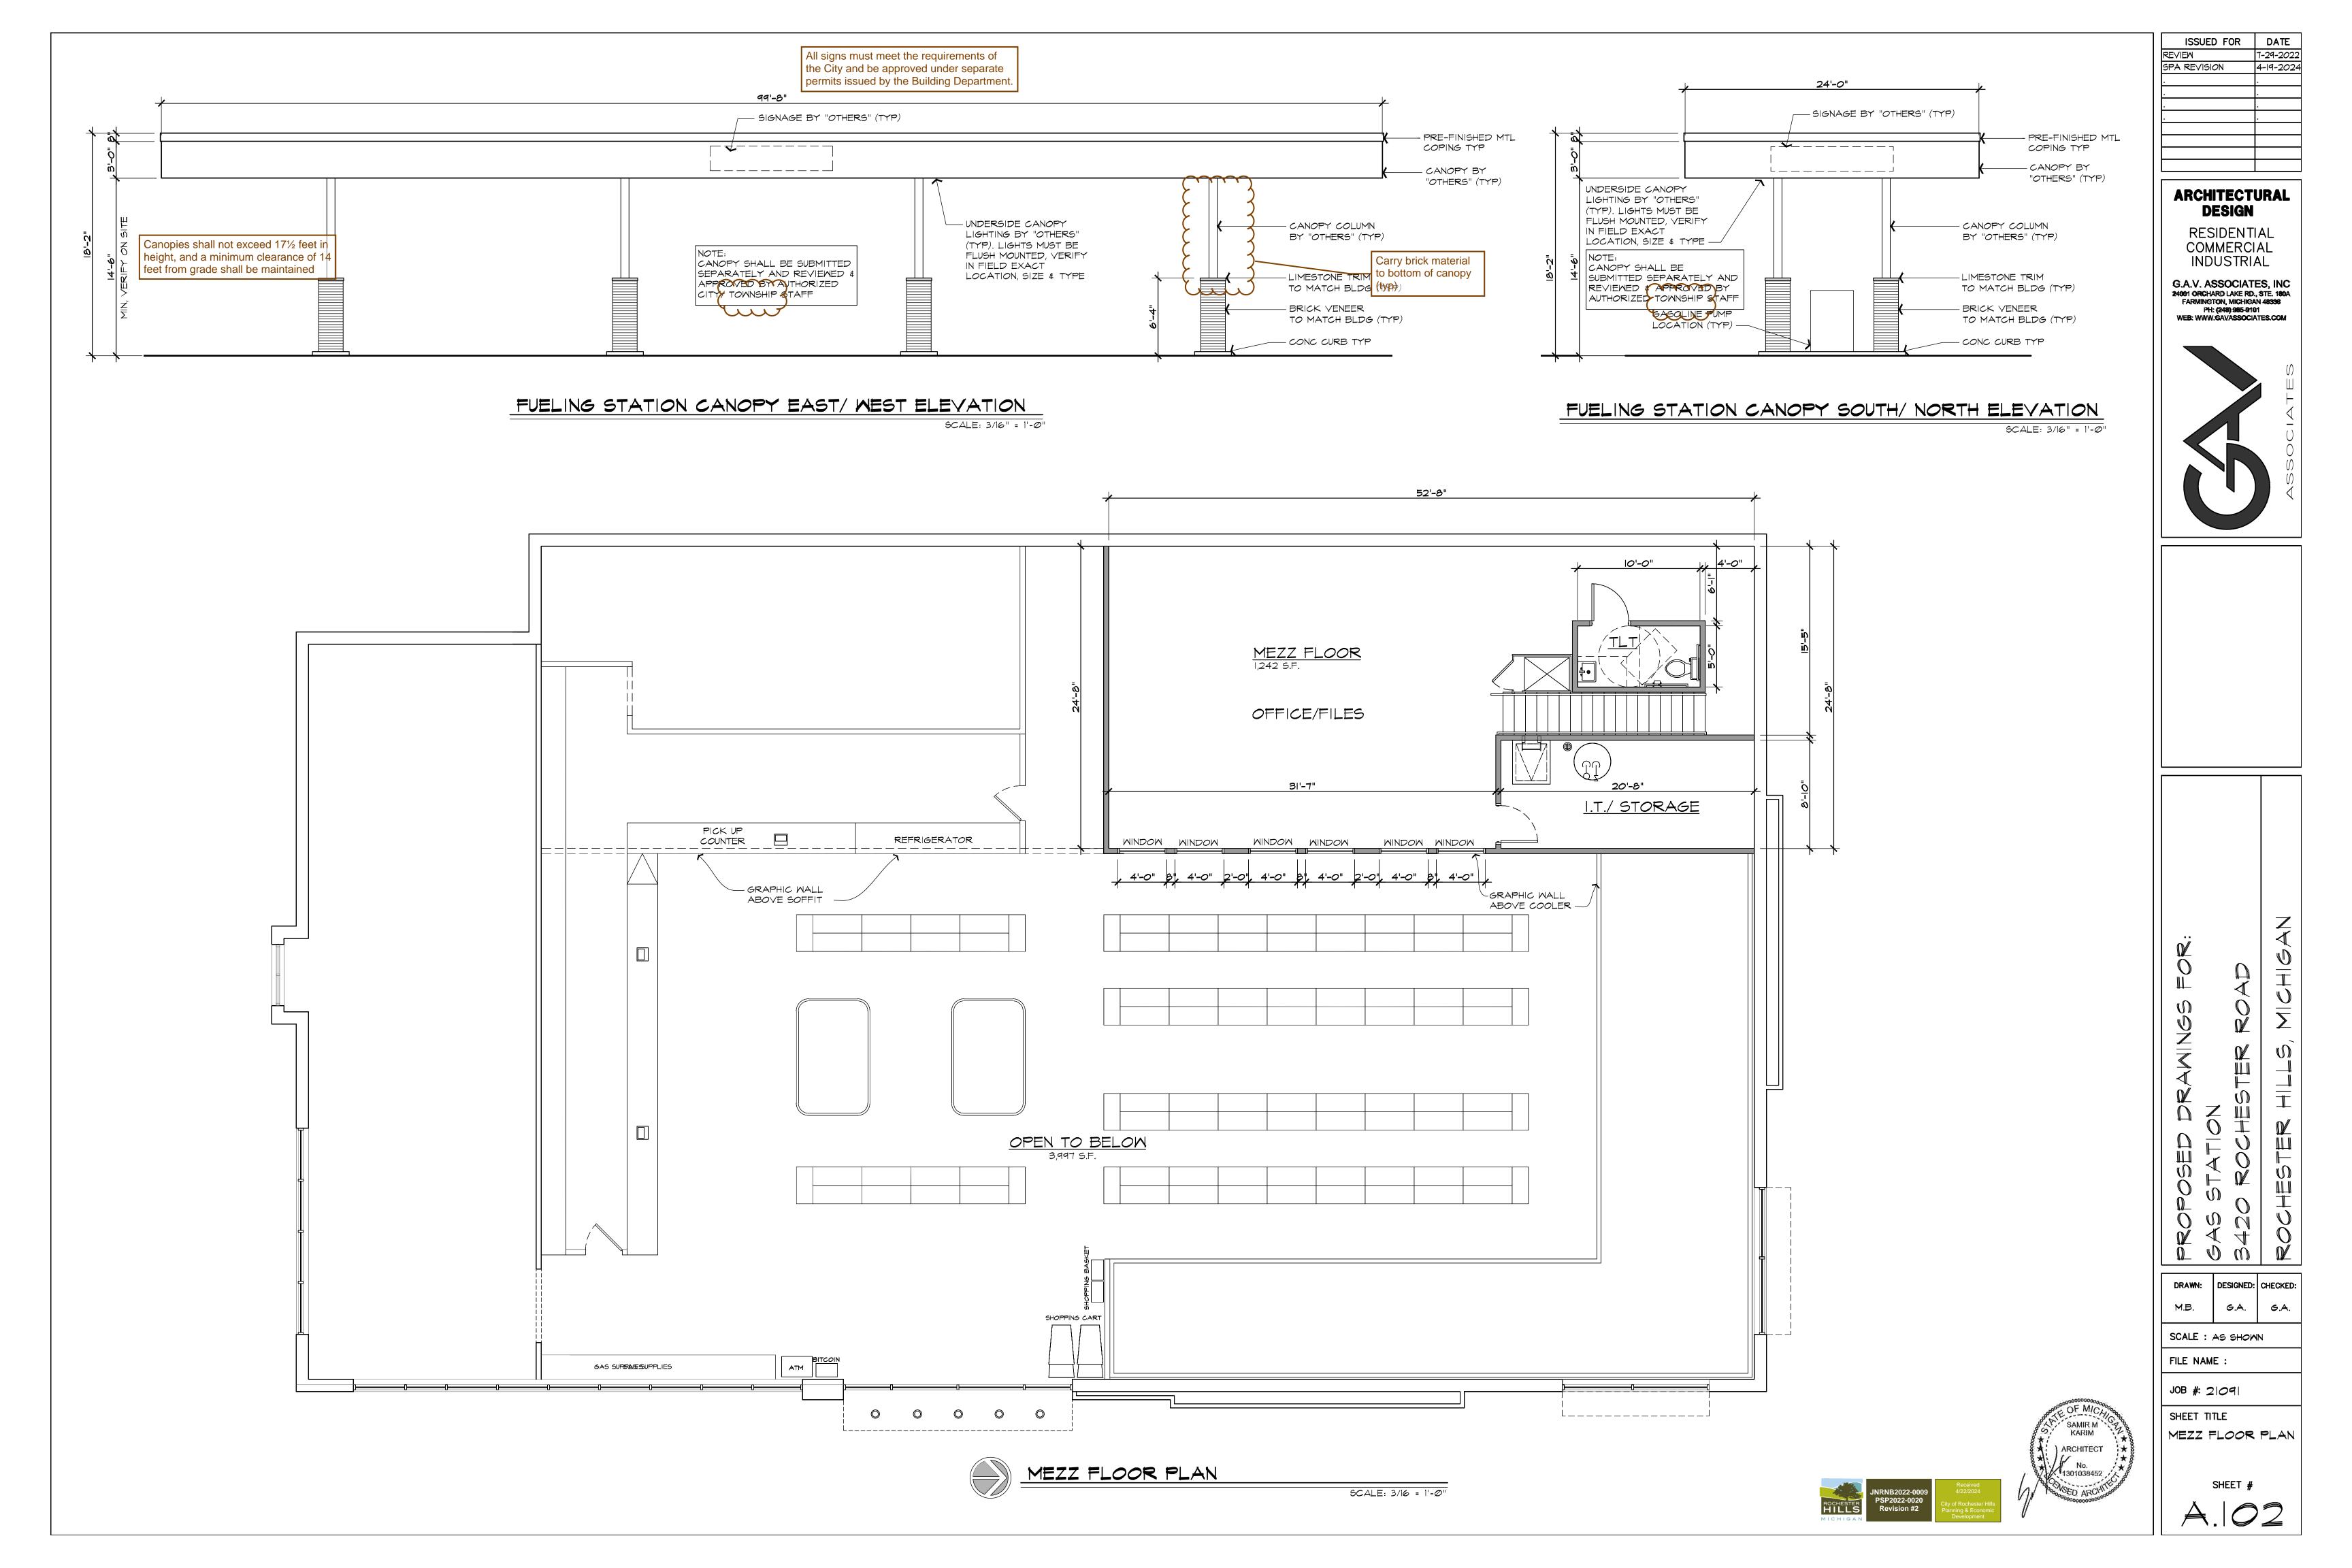





ISSUED FOR 8-24-2022 SPA REVISION 4-19-2024

> **ARCHITECTURAL DESIGN**

> > RESIDENTIAL COMMERCIAL INDUSTRIAL

G.A.V. ASSOCIATES, INC 24901 ORCHARD LAKE RD., STE. 180A FARMINGTON, MICHIGAN 48336 PH: (248) 985-9101 WEB: WWW.GAVASSOCIATES.COM

DESIGNED: CHECKED: DRAWN:

G.A. G.A.

SCALE : AS SHOWN

FILE NAME:

JOB #: 21091

SHEET TITLE EXTERIOR RENDERINGS


SHEET #







SCALE: 3/16" = 1'-0"

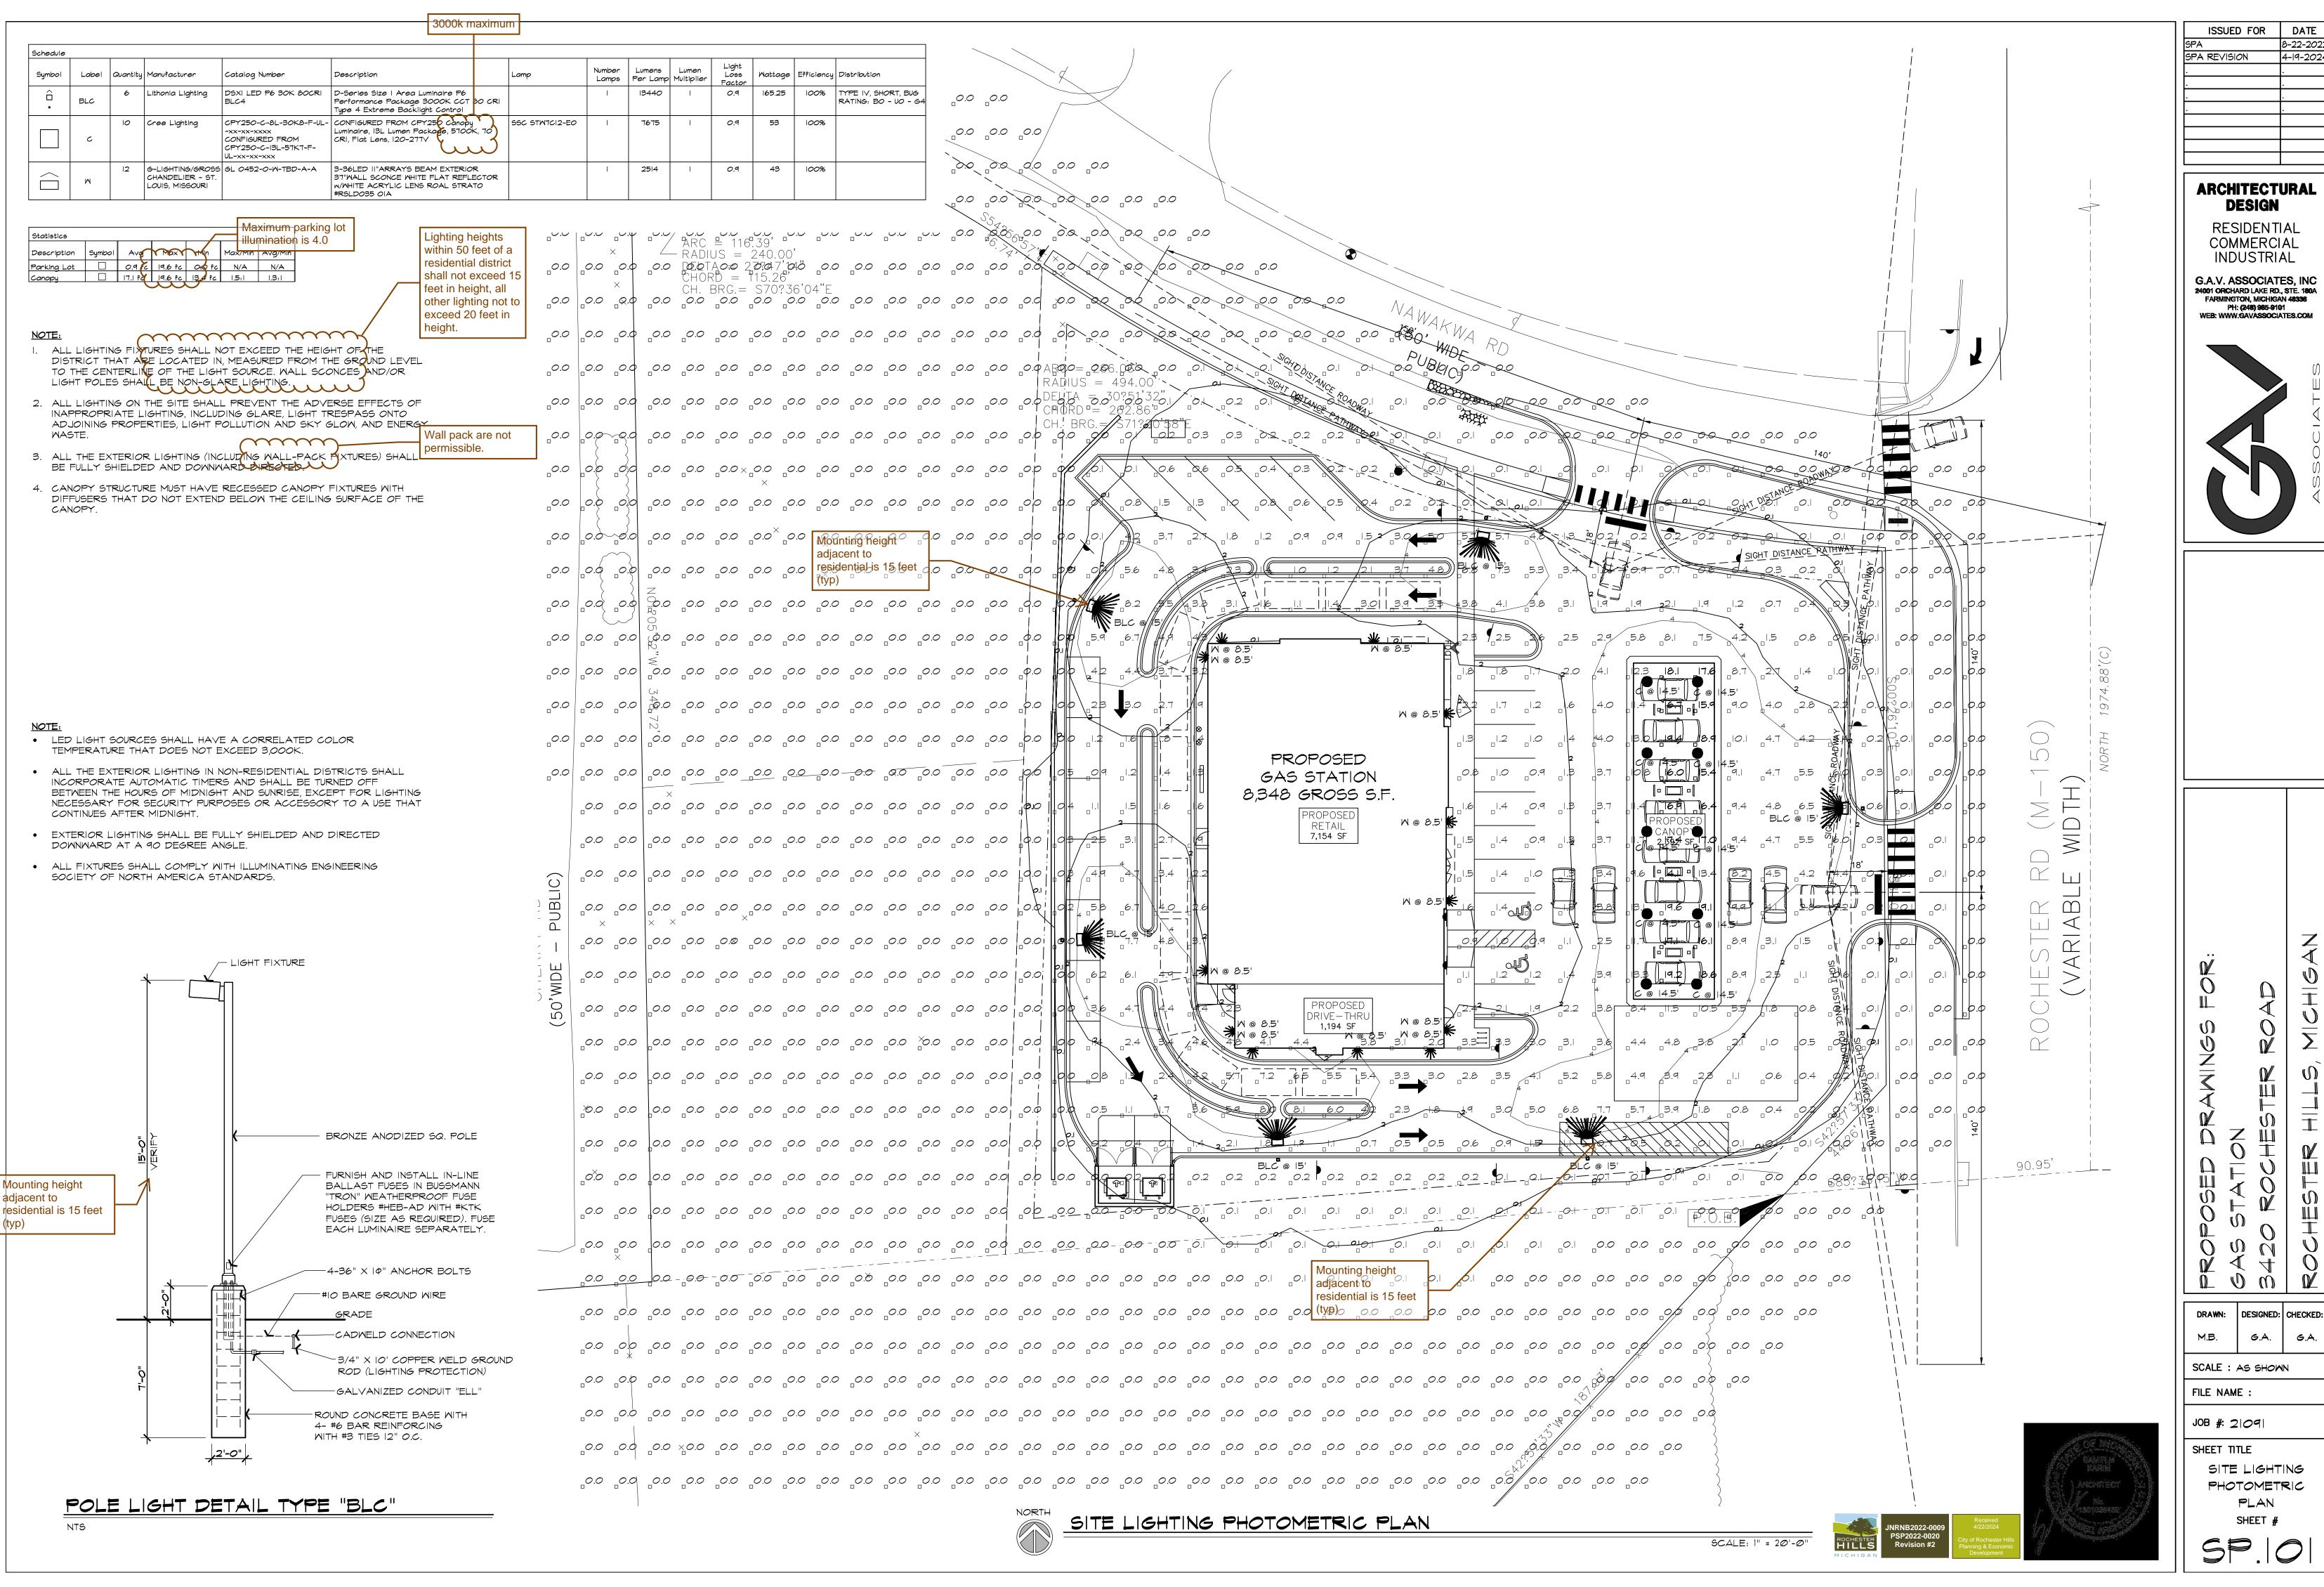


SPA REVISION 4-19-202

> **ARCHITECTURAL** DESIGN

> > RESIDENTIAL COMMERCIAL INDUSTRIAL

G.A.V. ASSOCIATES, INC 24001 ORCHARD LAKE RD., STE. 180A FARMINGTON, MICHIGAN 48336

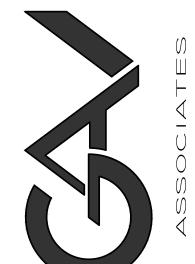


G.A. G.A. SCALE : AS SHOWN

JOB #: 21091

SITE LIGHTING PHOTOMETRIC PLAN

SHEET #

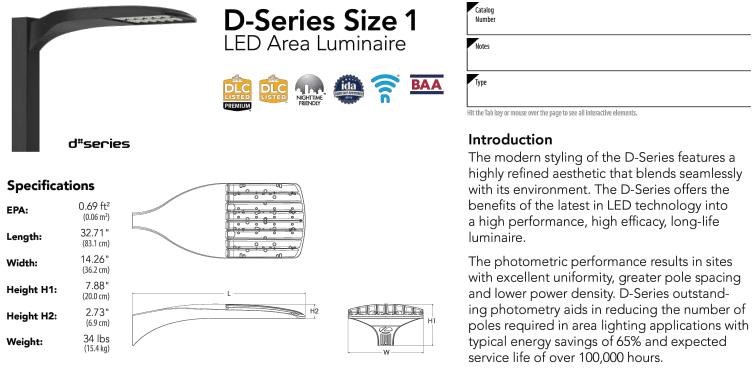

that does not exceed 3 000K	Distribution AFR Automotive front row T1S Type I short T2M Type II medium T3M Type III medium	T5M Type V medium T5LG Type V low glare T5W Type V wide	Voltage MVOLT (120V-277V) ⁴ HVOLT (347V-480V) ^{5,6} XVOLT (277V - 480V) ^{7,8}	Mounting Shipped included SPA Square pole mountin (#8 drilling)
P4 P9 (this section 80CRI only, P5 extended lead times apply) Rotated optics 27K 2700K 80CRI	13M IVDE III MEGIUM	PLCS T HILL LELL	420 16 76	RPA Round pole mounting
P111 P131 30K 3000K 80CRI 35K 3500K 80CRI 40K 4000K 80CRI 50K 5000K 80CRI	T3LG Type III low glare ³ T4M Type IV medium T4LG Type IV low glare ³ TFTM Forward throw medium	BLC3 Type III backlight control ³ BLC4 Type IV backlight control ³ LCC0 Left corner cutoff ³ RCC0 Right corner cutoff ³	120 ^{16, 26} 208 ^{16, 26} 240 ^{16, 26} 277 ^{16, 26} 347 ^{16, 26} 480 ^{16, 26}	(#8 drilling) SPAS Square pole mounting #5 drilling RPAS Round pole mounting #5 drilling SPA8N Square narrow pole mounting #8 drilling WBA Wall bracket 10 MA Mast arm adapter (mounts on 2 3/8" 01

Control options			Other optio	ons	Finish (required)		
Shipped install NLTAIR2 PIRHN PIR PER PER5	nLight AIR gen 2 enabled with bi-level motion / ambient sensor, 8-40' mounting height, ambient sensor enabled at 2fc. ^{11, 12, 20, 21} High/low, motion/ambient sensor, 8-40' mounting height, ambient sensor enabled at 2fc. ^{13, 20, 21} NEMA twist-lock receptacle only (controls ordered separate) ¹⁴ Five-pin receptacle only (controls ordered separate) ^{14, 21}	PER7 FA0 BL30 BL50 DMG DS	Seven-pin receptacle only (controls ordered separate) ^{14,21} Field adjustable output ^{15,21} Bi-level switched dimming, 30% ^{16,21} Bi-level switched dimming, 50% ^{16,21} O-10v dimming wires pulled outside fixture (for use with an external control, ordered separately) ¹⁷ Dual switching ^{18, 19,21}	Shipped in SPD20KV HS L90 R90 CCE HA BAA SF DF Shipped s EGSR	20KV surge protection Houseside shield (black finish standard) ²² Left rotated optics ¹ Right rotated optics ¹ Coastal Construction ²³ 50°C ambient operation ²⁴ Buy America(n) Act Compliant Single fuse (120, 277, 347V) ²⁶ Double fuse (208, 240, 480V) ²⁶	DDBXD DBLXD DNAXD DWHXD DDBTXD DBLBXD DNATXD DWHGXD	Dark Bronze Black Natural Aluminum White Textured dark bronze Textured black Textured natural aluminum Textured white

LITHONIA LIGHTING. COMMERCIAL OUTDOOR

One Lithonia Way • Conyers, Georgia 30012 • Phone: 1-800-705-SERV (7378) • www.lithonia.com © 2011-2023 Acuity Brands Lighting, Inc. All rights reserved.

FIXTURE TYPE "BLC"

LIGHT POLE +/- 15' AFF (VIF)

CPY Series - Version C

CPY250® LED Canopy/Soffit Luminaire

Product Description The CPY250® LED Canopy/Soffit Luminaire has an extremely thin profile constructed of rugged cast aluminum. It can be surface mounted easily from below the canopy deck and can be pendant mounted. Direct imaging of the LEDs is eliminated with a highly efficient patterned flat or 0.91" (23mm) drop glass lens. Applications: Petroleum canopies, CNG fueling stations, soffits Performance Summary Assembled in the USA by Cree Lighting from US and imported parts

Initial Delivered Lumens: Up to 21,000 Efficacy: Up to 165 LPW

CRI: Minimum 70 CRI (40K, 50K, 57K); 80 CRI (30K); 90 CRI (40K, 50K) CCT: 3000K, 4000K, 5000K, 5700K

Limited Warranty[†]: 10 years for luminaire/10 years for Colorfast DeltaGuard® finish/5 years for BML sensor/up to 5 years for Synapse® accessories/1 year for field-installed accessories IP66 Rated (select models only)

Class I, Division 2 Hazardous Location for select models †See http://creelighting.com/warranty for warranty terms. For Synapse accessories, consult Synapse spec sheets for details on warranty terms. Accessories

Direct Mount Luminaires Canopy Upgrade Kits (18 ga. steel, except where noted) Pendant Mount Luminaires Pendant Mount Kits XA-PS12KIT* – 5" (127mm) pendant XA-PS18KIT* – 11" (279mm) pendant XA-PS22KIT* – 15" (381mm) pendant XA-BXCCM+ – for use with Jet-Philips, 21.60" (549mm) square a correlated color temperature

XA-BXCCN+ - for use with Elsco Franciscan, 22.06" (560mm) square

XA-BXCCP+ - for use with LSI Dakota or Masters, 22.50" (572mm) square

XA-BXCCQ+ - for use with Whiteway Riviera or Rig-A-Lite, 20.60" (523mm) Includes two conduit fittings and 3/4-14 NPT pipe threaded on two square
XA-BXCCR+ – for use with Elsco Merrit, 18.06" [459mm] square
XA-BXCCS+ – for use with LSI Richmond or Whiteway Civic, 23.00" [584mm] L
x 13.00" [330mm] W
Direct Mount Junction Box/Stem Kit
XA-BXCCJBOX – 6.0" [152mm] H x 3/4" [19mm] NPT Stem Synapse® SimplySnap 10V Interface - Requires other Synapse components to

XA-BXCCJB0X - 6.0" (152mm) H x 3/4" [19mm] NPT Stem

- Watertight

- Rated for feed through 8 [4 in, 4 out) #12 AWC conductors

Direct Mount Beauty Plates

XA-BXCCBP+ - 26.17" (665mm) Beauty Plate Only [18 ga. steel]

XA-BXCCBP812+ - 26.17" (665mm) Beauty Plate [18 ga. steel] w/12" (305mm)

Backer Plate [16 ga. steel]

- For use in canopies where deck opening is larger than what is required for mounting the CPY250 luminaire. Maximum deck opening 10.75" x 15" (183mm x 375mm)

XA-BXCCBP814+ 26.17" (665mm) Beauty Plate [18 ga. steel] w/16" (406mm) (183mm x 375mm)

XA-BXCGBPB16+ - 26.17" (665mm) Beauty Plate [18 ga. steel) w/16" (406mm)

Backer Plate [16 ga. steel)

- For use in canopies where deck opening is larger than what is required for mounting the CPY250 luminaire. Maximum deck opening 12" x 15"

(305mm x 375mm)

* Must specify color: BK (Black), BZ (Bronze), SV (Silver) or WH (White)
+ Must specify color: T (Black), Z (Bronze), S (Silver) or W (White)

Ordering Information Example: CPY250-C-13L-57K7-D-UL-DM-SV

LED light sources shall have

that does not exceed 3,000K.

CPY250	С								
Product	Version	Lumen Package*	CCT/CRI	Optic	Voltage	Mounting	Color Options	Controls	Options
PY250	С	2L 2,000 Lumens 4L 4,000 Lumens 8L 8,000 Lumens 13L 13,000 Lumens 21L 21,000 Lumens	30K8 3000K, 80 CRI 40K7 4000K, 70 CRI 4000K, 90 CRI 50K7 5000K, 70 CRI 50K9 5000K, 90 CRI 57K7 5700K, 70 CRI	D 0.91" (23mm) Drop Lens F Flat Lens	UL Universal 120- 277V UH Universal 347- 480V - Available only in 4L-21L lumen packages	DM Direct FM Flush Mount H6 Car Wash HC Hook & Cord PD Pendant	BK Black BZ Bronze SV Silver WH White	BLANK Non-Dimming 10V 0-10V Dimming - Control by others - Refer to Dimming spec sheet for details BML Bluetooth® Technology Enabled Multi-Level Sensor - Utilizes a multifunction sensor - Available only with UL voltage - Refer to BML spec sheet for details - 8-20' sensor lens installed on luminaire; 20-40' sensor lens and aisle shroud included - Not available with other controls	10KV 10kV/5kA Surge Suppression Replaces standard 6kV/3kA surge suppression Rot for use with BML as BML option includes10kV/5kA surge as standard HZ Class I, Div. 2 Hazardous Location Certification Available with DM and PD mounts only Not available with BML control or K option K NSF 2 Certification Luminaires include NSF certification mark Suitable for DM mount only Not available with BML control or HZ option

complete system

- Refer to DIM10-220F spec sheet for

CREE \$\Dightarrow\$ LIGHTING

Rev. Date: V705/18/2023

DM Mount / DM Mount with HZ Option

Gasket to Seal up to 4.25" (108mm) Canopy Cutout

Mounts with (4)
Supplied Self-Sealing
Sheet Metal Screws

Weight

12.5 lbs. (5.7kg)

Refer to Page 4 for additional mounts.

← 11.0"→

FIXTURE TYPE "C"

CANOPY +/- 14.5' AFF (VIF), SEE ELEVATIONS

BEAM

Exterior Sconce

Lighting 9777 Reavis Park Drive St. Louis, MO 63123 800.331.2425 or 314.631.6000 sales@glighting.com www.glighting.com

GENERAL SPECIFICATION LED: High efficiency mid-power LEDs are field serviceable.

LED Dimming: 0-10V dimming standard. Body: Extruded aluminum wall plate and rails. Body hinges for easy serviceability. **Diffuser:** Extruded polycarbonate lens is UL-94 HB Flame Class rated. **Standard Finishes:** Highly durable oven cured no VOC premium powder coat.

Design: Aluminum die cast end caps and decorative bars. **Modified:** Contact factory for modified lengths, lamping and decorative fronts. Exterior Mounting: Gasketed between wall and wall plate.

GL-	5451-		H-	S-	PA-	A-	A
MC	DEL NO.		LAMPING	DIFFUSER	FINISH	DESIGN	OPTION(S)
GL-5449 4lbs 1.8kg	W in 7 1/4" H in 12" D in 3 7/8"	mm 185 mm 305 mm 125	AL. 10LED35	O tarradia.	Standard: Powder Coat BLK-Black BL-Blue GR-Gray	Standard: A. Optional: B.	A. No Options EL. Emergency LED Remote mount up to 10' from lamping in controlled environment with an area temperature range of
GL-5450 5lbs 2.3kg	W in 7 1/4" H in 17" D in 3 7/8"	mm 185 mm 430 mm 125	A. 14LED30 B. 14LED35 C. 14LED40		LG-Light Gray BE-Beige PAB-Antique Brass PA-Painted Aluminum PTC-Painted Copper WH-White DBZ-Dark Bronze	C. D.* E.*	32°-131°F. LED only. Specify 120 or 277 voltage.
	W in 7 1/4" H in 25" D in 3 7/8"	mm 185 mm 635 mm 125	D. 14LED30 E. 14LED35 F. 14LED40 G. 28LED30 H. 28LED35 I. 28LED40		NSN-New Satin Nickel BRN-Brown RD-Red CH-Champagne RG-Reed Green SG-Sungold GM-Gun Metal POR-Oil Rubbed Bronze Textured Powder TLV-Light Verdigris	*D&E not available with GL-5449. *E not available with GL-5450.	
GL-5452 10lbs 4.5kg	W in 7 1/4" H in 37" D in 3 7/8"	mm 185 mm 940 mm 125	K. 21LED30L. 21LED35M. 21LED40N. 42LED30O. 42LED35P. 42LED40		TWH-Textured White TBL-Textured Black TS-Textured Silver TBN-Terra Brown TBZ-Textured Bronze Premium: SA-Satin Aluminum		
GL-5453 14lbs 6.3kg	W in 7 1/4" H in 49" D in 3 7/8"	mm 185 mm 1245 mm 125	S. 28LED35				

,	All dimensions are n	ominal.					Light Source Definition						
	<u>Lamp</u> 10LED30 10LED35 10LED40	<u>LED</u> 10W 10W 10W	<u>CRI</u> 92 92 92	Rated <u>Life Hrs</u> 50000 50000 50000	Delivered Lumens 478 478 478	Kelvin 3000 3500 4000	<u>Lamp</u> 28LED30 28LED35 28LED40	<u>LED</u> 28W 28W 28W	<u>CRI</u> 80 80 80	Rated <u>Life Hrs</u> 50000 50000 50000	Delivered <u>Lumens</u> 1562 1562 1562	<u>Kelvin</u> 3000 3500 4000	
	14LED30 14LED35 14LED40 21LED30	14W 14W 14W 21W	80 80 80 80	50000 50000 50000 50000	781 781 781 781 1171	3000 3500 4000 3000	42LED30 42LED35 42LED40 56LED30	42W 42W 42W 56W	80 80 80	50000 50000 50000 50000	2527 2527 2527 2527 3124	3000 3500 4000 3000	
	21LED35 21LED40	21W 21W	80 80	50000 50000	1171 1171	3500 4000	56LED35 56LED40	56W 56W	80 80	50000 50000	3124 3124	3500 4000	

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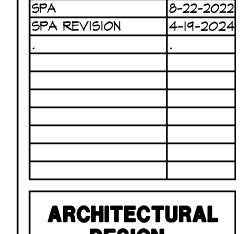
All dimensions are nominal.

G Lighting reserves the right to modify existing designs to improve appearance or function

FIXTURE TYPE "M"

+/- 8.5' AFF, SEE ELEVATIONS






ISSUED FOR

DESIGN

RESIDENTIAL COMMERCIAL INDUSTRIAL

G.A.V. ASSOCIATES, INC 24901 ORCHARD LAKE RD., STE. 180A FARMINGTON, MICHIGAN 48336 PH: (248) 965-9101 WEB: WWW.GAVASSOCIATES.COM

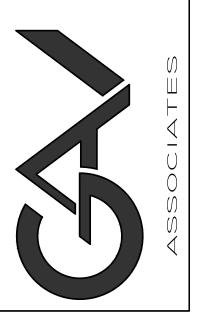

DESIGNED: CHECKED: DRAWN:

G.A. G.A.

SCALE : AS SHOWN

FILE NAME:

JOB #: 21091

SHEET TITLE SITE LIGHTING

SHEET #

CUT SHEET

3420 S. ROCHESTER RD. NEW FUEL CENTER & DRIVE THRU PGP 2022 - 0020



CITY OF ROCHESTER HILLS





Commercial Site Plan Review Checklist

Document 4,4,1250

Revised 4/19/21

Created 04/03/17

The following information is required on plans submitted for Site Plan Review.

- Section references and those in parentheses () relate to the Michigan Building Code 2015 unless otherwise noted.
- Section references to accessibility items relate to the ICC A117.1-2009, unless otherwise noted.

BUILDING CODE REQUIREMENTS

REFER TO CATTACHED L COPES CURRENTLY IN EFFECT" Provide a list of all construction codes that will be applicable to the project at the time of application for building permit.

Classify the building with respect to occupancy in one or more of the groups listed in Section 302.

- a. Where a building contains more than one occupancy group, identify the type of mixed uses and the corresponding occupancy groups including:
 - i. Accessory occupancies (508.2),
 - ii. Non-separated occupancies (508.3),
 - iii. Šeparated occupancies (508.4), and/or
 - iv. Combinations of the above
- 3. Indicate proposed structures Construction Classification Type per the requirements of Section
 - 4.) Provide a building height and number of stories analysis based on Section 504 and Tables 504.3 and 504.4.

IF REQUIRED

- Include any Increases allowed per applicable provisions of Sections 504 for automatic sprinkler system.
- 5.) Provide a building area analysis based on Section 506 and Table 506.2.
 - Include any increases allowed per applicable provisions of Sections 506 for frontage and/or automatic sprinkler system.
- 6. Indicate if a full or limited area automatic sprinkler and/or fire alarm system will be installed per Chapter 9.
 - If an automatic sprinkler system exists and/or is proposed, show the location of the Fire Department Connection (FDC).
 - Indicate setbacks from property lines and/or fire separation distances from adjacent buildings on the same site (107.2.5 and 705.3).

IF A CANOPY OVER GAS PUMPS IS PROPOSED. If two or more buildings are on the same lot, indicate whether they shall be regulated as separate buildings or shall be considered as portions of one building (503.1.2).

If treated as separate buildings indicate fire-resistant rating requirements for exterior walls based on Table 602 and allowable wall openings per Table 705.8.

On the site plan and the floor plans identify all entrances per applicable provisions of Section 1105.

Identify all public entrances including all accessible public entrances (1105.1), all restricted entrances (1105.1.3), and all service entrances (1105.1.5).

Indicate any of the following applicable proposed accessible route/routes to the accessible entrances.

Accessible routes within the site shall be provided from public transportation stops; accessible parking; accessible passenger loading zones; and public streets or sidewalks to the accessible building entrance served (1104.1).

- Other than in buildings or facilities containing or serving Type B units, an accessible route shall not be required between site arrival points and the building or facility entrance if the only means of access between them is a vehicular way not providing for pedestrian access.
- が、At least one accessible route shall connect accessible buildings, accessible facilities, accessible elements and accessible spaces that are on the same site (1104.2).
 - An accessible route is not required between accessible buildings, accessible facilities, accessible elements and accessible spaces that have, as the only means of access between them, a vehicular way not providing for pedestrian access.
- Provide sufficient grade information on the plans along the proposed accessible route/routes to verify compliance with the requirements of A117.1 Section 402.
 - Provide details (as applicable) of the following components along the proposed accessible route/routes to verify compliance with A117.1:
 - Section 404 for door maneuvering clearance and ground surface slope.
 - K Section 405 for ramps.
- Section for curb ramps. (RAMP'TYPE P') ✓ 10. Indicate the number of accessible parking spaces provided including van accessible spaces as required by Section 1106.
 - All accessible parking spaces shall be a Universal Barrier Free Design to allow van access in any accessible parking space per the City Ordinance Section 138-11.300. Universal barrier free spaces shall be 11 feet in width with a 5 foot access aisle.
 - ✓ b. Indicate the proposed surfaces slopes of accessible parking spaces and their access aisles. Provide sufficient point elevations on the plan at the perimeter of such spaces to clearly verify the provisions of A117.1 Section 502.5 have been satisfied (1:48 max slope).
 - ✓ c. Provide details of required accessible parking signage per the requirements of A117.1 Section 502.7.
 - Confirm that the accessible parking spaces are located on the shortest accessible route of travel from the parking to the accessible building entrance per A117.7 Section 1106.6.
 - $oldsymbol{arphi}$ e. Verify that accessible parking spaces are logically distributed throughout the site when multiple accessible building entrances are provided.
 - 14. Indicate location of passenger loading zones that are required by Section 1106.7 or are being proposed.
 - Provide details/dimensions of proposed passenger loading zones and their accessible access aisles per Section 1106.7 and A117.7 Section 503.
 - Indicate the proposed surface slopes of accessible passenger loading zone access aisles. Provide sufficient point elevations on the plan at the perimeter of access aisles to clearly verify the provisions of A117.1 Section 503.4 have been satisfied (1:48 max. slope).
 - Provide vertical clearance complying with A117.7 Section 503.5.
 - 12. Detectible warnings are required at sidewalk ramps located in the road right-of-ways.
 - Please refer to ADA (Americans Disability Act) requirements for details of detectible warnings at sidewalk ramps. Provide a detail on the plans complying with these requirements. Although not enforced by the City of Rochester Hills, the ADA (Americans Disability Act) requires detectible warnings to be provided at all sidewalk ramps (including

those on site). Conformance to these requirements is the responsibility of the project's designer and owner.

13. Provide sufficient grade information to verify compliance with Section 1804.3 for minimal drainage away from the building (2% minimum).

√ 14. Confirm there is proper clearance between grade and exterior materials.

a. Various material have clearance requirements based on code and/or manufacture's requirements, i.e., wood siding requires 6 inches clearance between siding and earth and 2 inches between siding and concrete surfaces per Section 2304.12.1.5.



BUILDING DEPARTMENT CITY OF ROCHESTER HILLS



Codes Currently in Effect

The codes noted below are adopted by the City of Rochester Hills Codified Ordinance Sections 18-41 and 18-136.

Commercial:

Building: 2015 Michigan Building Code - Effective April 20, 2017

Rehab: 2015 Michigan Rehabilitation Code for Existing Buildings 2015 - Effective

December 13, 2016

Accessibility: ICC ANSI A117.1 – 2009

Mechanical: 2021 Michigan Mechanical Code - 2021 IMC with Part 9A amendments and

additions - Effective March 12, 2024

Electrical: 2023 Michigan Electrical Code - NFPA 70: 2023 National Electrical Code with

Part 8 amendments and additions - Effective March 12, 2024

Plumbing: 2021 Michigan Plumbing Code - 2021 IPC with Part 7 amendments and

additions - Effective March 12, 2024

Energy: 2015 Michigan Building Code - 2015 IECC with Part 10a amendments and

additions and ASHREA 90.1.3 - 2013 - Effective September 20, 2017

Fuel gas: International Fuel Gas Code - 2021, as referenced in the 2021 Michigan

Mechanical Code

Fire: International Fire Code - 2021, as referenced in the 2021 Michigan Mechanical

Code

Fire Suppression: NFPA 13, 13R - 2019 per 2021 Part 9A Michigan Mechanical Code Rules.

Fire Alarm: NFPA 72 - 2019 as referenced in the 2021 Michigan Mechanical Code.

Residential:

All Trades: 2015 Michigan Residential Code with Administrative Rules Part 5 – Amendments

- Effective February 8, 2022

Energy Code: 2015 Michigan Residential Code - Chapter 11 with Administrative Rules Part 5

- Amendments - Effective February 8, 2022

Fire Suppression: NFPA 13D - 2019 per 2021 Part 9A Michigan Mechanical Code Rules

Fire Alarm: NFPA 72 -2013

SITE PLAN - COMPLETE PACKAGE 2024_01_08 ..pdf Markup Summary

Building Department (8)



Subject: Building Department Author: Mark Artinian Date: 5/8/2024 1:14:28 PM

Status:

A building permit is required for the demolition of all the existing building and canopy.



Subject: Building Department Author: Mark Artinian Date: 5/8/2024 1:35:11 PM

Status:

7'-0"

.....

.....



Subject: Building Department

Author: Mark Artinian **Date:** 5/8/2024 1:36:15 PM

Status:

Sidewalk cross slope shall not exceed 2%.



Subject: Building Department

Author: Mark Artinian

Date: 5/8/2024 2:11:18 PM

Status:

Gas station & store.



Subject: Building Department

Author: Mark Artinian Date: 5/8/2024 2:11:21 PM

Status:

Lease space (Dunkin Donut) would be an A-2 unless the occupant load is less than 50. If so, it

would be a 'B' use.



Subject: Building Department **Author:** Mark Artinian

Date: 5/8/2024 2:31:21 PM

Status:

Please address the highlighted items circled in red on the attached "Commercial Site Plan Review Checklist".

Mark Artinian 248-841-2446

Subject: Building Department

Author: Mark Artinian Date: 5/8/2024 3:36:31 PM

Status:

Mark Artinian 248-841-2446 ArtinianM@RochesterHills.org

No

Subject: Building Department **Author:** Mark Artinian

Date: 5/8/2024 3:36:52 PM

Status:

No

Engineering Department (3)

Subject: Engineering Department

Author: Jason Boughton Date: 4/23/2024 11:40:26 AM

Status:

The applicant needs to submit a Land Improvement Permit (LIP) application with engineer's estimate, fee and construction plans to proceed with the construction plan review process.



Subject: Engineering Department

Author: Jason Boughton Date: 4/23/2024 11:45:28 AM

Status:

City File #22-029 Section #34 in the lower right

hand corner of each sheet

Jason Boughton 248-841-2490

Subject: Engineering Department

Author: Jason Boughton Date: 4/23/2024 11:45:55 AM

Status:

Engineering Legal Review (8)

NY, POLICY No. OP 405833,

Oakland, Slate of Michigan,
Liber

conded by Uber 19 of Plats, Page
described as Bulgions: Beginning
s Subdivision, said line being also

Noth, Range 11 East, Avon
1888 '4139' W as measured
mit Feast 14 coner of said

Subject: Engineering Legal Review

Author: Jenny McGuckin Date: 5/2/2024 9:40:22 AM

Status:

Liber



Subject: Engineering Legal Review

Author: Jenny McGuckin

Date: 5/2/2024 9:55:10 AM

Status:

Measured metes and bounds does not close by 1

foot.



Subject: Engineering Legal Review

Author: Jenny McGuckin Date: 5/2/2024 10:46:49 AM

Status:

Show existing water main easement (L.15988

P.103)



Subject: Engineering Legal Review

Author: Jenny McGuckin Date: 5/2/2024 11:03:22 AM

Status:

Show existing DTE easement (40379 P.734)



Subject: Engineering Legal Review

Author: Jenny McGuckin Date: 5/2/2024 11:15:04 AM

Status:

15.00 ft

.....

.....



Subject: Engineering Legal Review

Author: Jenny McGuckin Date: 5/2/2024 11:15:06 AM

Status:

15.00 ft



Subject: Engineering Legal Review

Author: Jenny McGuckin

Date: 5/2/2024 11:14:34 AM

Status:

Verify sign does not fall within existing water main easement



Subject: Engineering Legal Review

Author: Jenny McGuckin Date: 5/2/2024 11:16:46 AM

Status:

Show proposed 20' water main easement. This easement will be needed during construction plan review.

Fire Department (8) Subject: Fire Department Use this Information fo the Auto Turn Author: Jon Mills Date: 4/24/2024 2:56:56 PM Status: **Subject:** Fire Department Reposition Proposed Fire Hydrant in this Location Author: Jon Mills Date: 4/25/2024 3:19:48 PM Status: **Subject:** Fire Department 12'-1/4" Author: Jon Mills Date: 4/24/2024 3:03:52 PM Status: Subject: Fire Department Fire Apparatus Access Roadways should be Author: Jon Mills designed to support the load of the fire Date: 4/25/2024 3:12:49 PM apparatus (75,000 pounds) and be surfaced to Status: provide all weather driving capabilities. Subject: Fire Department 331'-1" Author: Jon Mills Date: 4/24/2024 3:07:58 PM Status: Subject: Fire Department Provide Auto Turn from Nawakwa to Rochester Rd Author: Jon Mills Date: 4/25/2024 3:19:52 PM Status: **Subject:** Fire Department In order to obtain site plan approval, a flow test is Author: Jon Mills required to evaluate the capabilities Date: 4/25/2024 3:19:39 PM of the water supply. This can be obtained by Status: contacting the Rochester Hills Engineering Department at 248-656-4640. Subject: Fire Department Author: Jon Mills Date: 4/25/2024 3:32:05 PM Status:

Group (28)



Subject: Group Author: macdonaldj Date: 4/22/2024 1:47:24 PM

/22/2024 1:47:24 PM Develop

Status:



Subject: Group Author: C.McLeod Date: 5/2/2024 9:35:46 AM

Status:

City of Rochester Hills Planning & Economic Development

SP

Subject: Group Author: C.McLeod Date: 5/2/2024 9:35:39 AM Status: Subject: Group LIP Author: C.McLeod Date: 5/2/2024 9:35:36 AM Status: Subject: Group BP Author: C.McLeod Date: 5/2/2024 9:35:31 AM Status: Subject: Group Author: C.McLeod Date: 5/2/2024 9:35:50 AM Status: Subject: Group Received Author: C.McLeod 4/22/2024 Date: 5/2/2024 9:36:48 AM Status: City of Rochester Hills Planning & Economic Development Subject: Group Received Author: C.McLeod 4/22/2024 Date: 5/2/2024 9:36:55 AM Status: City of Rochester Hills Planning & Economic Development Subject: Group Received Author: C.McLeod 4/22/2024 Date: 5/2/2024 9:36:59 AM Status: City of Rochester Hills Planning & Economic Development Subject: Group Received Author: C.McLeod 4/22/2024 Date: 5/2/2024 9:37:05 AM Status: T FOR CONSTRUCTION LE #22-029 SECTION #34 City of Rochester Hills Planning & Economic Development Subject: Group Received Author: C.McLeod 4/22/2024 Date: 5/2/2024 9:37:15 AM Status: FOR CONSTRUCTION .E #22-029 SECTION #34 City of Rochester Hills Planning & Economic Development Subject: Group Received Author: C.McLeod 4/22/2024 Date: 5/2/2024 9:37:21 AM Status: FOR CONSTRUCTION LE #22-029 SECTION #34 City of Rochester Hills Planning & Economic

Development

DOUBLE DIAMPSTER ENGLOSISE	Subject: Group Author: C.McLeod Date: 5/2/2024 9:37:25 AM Status:	Received 4/22/2024 City of Rochester Hills Planning & Economic Development
NSTALLATION D. AREAS ID. AREAS	Subject: Group Author: C.McLeod Date: 5/2/2024 9:37:29 AM Status:	Received 4/22/2024 City of Rochester Hills Planning & Economic Development
FOR CONSTRUCTION E #22-029 SECTION #34	Subject: Group Author: C.McLeod Date: 5/2/2024 9:37:34 AM Status:	Received 4/22/2024 City of Rochester Hills Planning & Economic Development
PRINCE PROPERTY OF C	Subject: Group Author: C.McLeod Date: 5/2/2024 9:37:39 AM Status:	Received 4/22/2024 City of Rochester Hills Planning & Economic Development
FOR CONSTRUCTION .E #22-029 SECTION #34	Subject: Group Author: C.McLeod Date: 5/2/2024 9:37:43 AM Status:	Received 4/22/2024 City of Rochester Hills Planning & Economic Development
1 DECOMOUS TREE PLANTA SELECTIVE OF THE PLANT	Subject: Group Author: C.McLeod Date: 5/2/2024 9:37:51 AM Status:	Received 4/22/2024 City of Rochester Hills Planning & Economic Development
PE PA PA PA PA PA PA PA	Subject: Group Author: C.McLeod Date: 5/2/2024 9:37:55 AM Status:	Received 4/22/2024 City of Rochester Hills Planning & Economic Development
THE PROPERTY OF	Subject: Group Author: C.McLeod Date: 5/2/2024 9:38:00 AM Status:	Received 4/22/2024 City of Rochester Hills Planning & Economic Development
Principal Princi	Subject: Group Author: C.McLeod Date: 5/2/2024 9:38:04 AM Status:	Received 4/22/2024 City of Rochester Hills Planning & Economic Development
AMERICAN AND AND AND AND AND AND AND AND AND A	Subject: Group Author: C.McLeod Date: 5/2/2024 9:38:09 AM Status:	Received 4/22/2024 City of Rochester Hills Planning & Economic Development



Subject: Group Author: C.McLeod

Date: 5/2/2024 9:38:13 AM

Status:

Received 4/22/2024

City of Rochester Hills Planning & Economic

Development



Subject: Group Author: C.McLeod Date: 5/2/2024 9:38:25 AM

Status:

Received 4/22/2024

City of Rochester Hills Planning & Economic

Development



Subject: Group Author: C.McLeod Date: 5/2/2024 9:38:32 AM

Status:

Received 4/22/2024

City of Rochester Hills Planning & Economic

Development



Subject: Group Author: C.McLeod

Date: 5/2/2024 10:39:42 AM

Status:



Subject: Group Author: C.McLeod

Date: 5/2/2024 11:46:15 AM

Status:



Subject: Group Author: C.McLeod

Date: 5/6/2024 12:56:23 PM

Status:



Highlight (34)



Subject: Highlight Author: Jon Mills

Date: 4/24/2024 2:57:06 PM

Status:



Subject: Highlight Author: Jon Mills

Date: 4/24/2024 2:57:33 PM


Status:



Subject: Highlight Author: Jon Mills

Date: 4/24/2024 2:57:42 PM

Status:

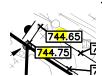

Subject: Highlight Author: Mark Artinian Date: 5/8/2024 1:21:00 PM



Subject: Highlight Author: Mark Artinian Date: 5/8/2024 1:21:01 PM

Status:



Subject: Highlight Author: Mark Artinian Date: 5/8/2024 1:21:02 PM

Status:



Subject: Highlight Author: Mark Artinian Date: 5/8/2024 1:21:06 PM

Status:



Subject: Highlight Author: Mark Artinian Date: 5/8/2024 1:21:07 PM

Status:



Subject: Highlight Author: Mark Artinian Date: 5/8/2024 1:21:08 PM

Status:



Subject: Highlight Author: Mark Artinian Date: 5/8/2024 1:21:10 PM

Status:



Subject: Highlight Author: Mark Artinian Date: 5/8/2024 1:21:11 PM

Status:



Subject: Highlight Author: Mark Artinian Date: 5/8/2024 1:21:12 PM

Status:



Subject: Highlight Author: Mark Artinian Date: 5/8/2024 1:21:13 PM

Status:



Subject: Highlight Author: Mark Artinian Date: 5/8/2024 1:21:14 PM



Subject: Highlight Author: Mark Artinian Date: 5/8/2024 1:21:16 PM

Status:



Subject: Highlight Author: Mark Artinian Date: 5/8/2024 1:21:17 PM

Status:



Subject: Highlight Author: Mark Artinian Date: 5/8/2024 1:21:20 PM

Status:



Subject: Highlight Author: Mark Artinian Date: 5/8/2024 1:21:20 PM

Status:



Subject: Highlight
Author: Mark Artinian
Date: 5/8/2024 1:21:23 PM

Status:



Subject: Highlight Author: Mark Artinian Date: 5/8/2024 1:21:24 PM

Status:



Subject: Highlight Author: Mark Artinian Date: 5/8/2024 1:21:43 PM

Status:



Subject: Highlight Author: Mark Artinian Date: 5/8/2024 1:21:44 PM

Status:



Subject: Highlight Author: Mark Artinian Date: 5/8/2024 1:21:45 PM

Status:



Subject: Highlight Author: Mark Artinian Date: 5/8/2024 1:21:46 PM

Subject: Highlight Author: Mark Artinian Date: 5/8/2024 1:21:48 PM Status: Subject: Highlight Author: Mark Artinian Date: 5/8/2024 1:21:49 PM Status: Subject: Highlight CROSS Author: Mark Artinian Date: 5/8/2024 1:21:53 PM Status: Subject: Highlight **741.05**| Author: Mark Artinian Date: 5/8/2024 1:23:12 PM Status: Subject: Highlight Author: Mark Artinian Date: 5/8/2024 1:23:13 PM Status: Subject: Highlight **Author:** Mark Artinian **740.4(Date:** 5/8/2024 1:23:17 PM Status: /P 740.40 Subject: Highlight Author: Mark Artinian Date: 5/8/2024 1:23:19 PM Status: P 740.40 Subject: Highlight Author: Mark Artinian Date: 5/8/2024 1:23:39 PM Status: 741.80N

4 741.03 S 741.70 P 741.70 Subject: Highlight Author: Mark Artinian Date: 5/8/2024 1:23:41 PM

Status:

Subject: Highlight Author: Mark Artinian Date: 5/8/2024 3:35:23 PM

Image (2)



Subject: Image Author: Jon Mills

Date: 4/24/2024 2:56:09 PM

Status:



Subject: Image Author: C.McLeod

Date: 5/8/2024 12:00:42 PM

Status:

Jenny McGuckin - YES (1)

MO MO MAN PROPERTY AND ADDRESS OF THE PERTY ADDRESS OF THE PERTY

Subject: Jenny McGuckin - YES Author: Jenny McGuckin Date: 5/2/2024 11:40:32 AM

Status:

Natural Resouces (1)

Subject: Natural Resouces Author: Matt Einheuser Date: 5/3/2024 11:28:56 AM

Status:

Planning Department (48)




Subject: Planning Department

Author: C.McLeod **Date:** 5/2/2024 9:39:47 AM

Status:

Length/dimension of parallel parking spaces should be provided to show compliance with

ordinance requirements

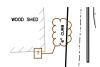

Subject: Planning Department

Author: C.McLeod

Date: 5/2/2024 9:41:12 AM

Status:

?

.....



Subject: Planning Department

Author: C.McLeod

Date: 5/2/2024 9:44:14 AM

Status:

"Do Not Enter" sign?



Subject: Planning Department

Author: C.McLeod **Date:** 5/2/2024 9:45:19 AM

Status:

3000k maximum



Subject: Planning Department

Author: C.McLeod

Date: 5/2/2024 10:05:06 AM

Status:

Show as to be removed






Author: C.McLeod

Date: 5/2/2024 10:08:37 AM

Status:

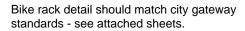



Subject: Planning Department

Author: C.McLeod

Date: 5/6/2024 12:43:19 PM

Status:



Subject: Planning Department

Author: C.McLeod

Date: 5/2/2024 10:35:31 AM

Status:



Subject: Planning Department

Author: C.McLeod

Date: 5/2/2024 10:36:28 AM

Status:





Subject: Planning Department

Author: C.McLeod

Date: 5/6/2024 2:45:11 PM

Status:

Continue hedge to sidewalk. Parking areas within 30 feet of right of way require hedgerow. Planting locations will also need to respect clearance for

Connection from building to Rochester Road

hydrant and direction hydrant faces.



Subject: Planning Department

Author: C.McLeod

Date: 5/2/2024 10:44:35 AM

Status:

All signs must meet the requirements of the City and be approved under separate permits issued by the Building Department.



Subject: Planning Department

Author: C.McLeod

Date: 5/2/2024 11:33:13 AM

Status:

Zoned R3 One Family Residential with FB Flex **Business Overlay**



Subject: Planning Department

Author: C.McLeod

Date: 5/2/2024 11:34:33 AM

Status:

Within 125% of total parking required.



Subject: Planning Department

Author: C.McLeod

Date: 5/2/2024 11:35:43 AM

Status:

Provide sidewalk for access to parking spaces



Subject: Planning Department

Author: C.McLeod

Date: 5/2/2024 11:45:46 AM

Status:

Carry brick material to bottom of canopy (typ)



Author: C.McLeod

Date: 5/2/2024 11:43:03 AM

Status:

All signs must meet the requirements of the City and be approved under separate permits issued by the Building Department.



Subject: Planning Department

Author: C.McLeod

Date: 5/2/2024 11:43:26 AM

Status:



Subject: Planning Department

Author: C.McLeod

Date: 5/2/2024 11:45:18 AM

Status:

Canopies shall not exceed 171/2 feet in height, and a minimum clearance of 14 feet from grade shall

be maintained



Subject: Planning Department

Author: C.McLeod

Date: 5/2/2024 12:02:43 PM

Status:

With wall not proposed on lot line, long term maintenance shall be insured.



Subject: Planning Department

Author: C.McLeod

Date: 5/2/2024 12:03:21 PM

Status:

Irrigation plan shall be provided.



Subject: Planning Department

Author: C.McLeod

Date: 5/2/2024 12:10:13 PM

Status:

Hedgerow plantings shall not be planted more than 36 inches on center and shall be a minimum of 30

inches in height at time of planting (typ).



Subject: Planning Department

Author: C.McLeod

Date: 5/2/2024 12:11:11 PM

Status:

Cost estimate will need to be updated to include all plantings and irrigation to establish required landscape bond amount.




Subject: Planning Department

Author: C.McLeod

Date: 5/2/2024 12:16:34 PM

Status:

Provide calculations for Type D Buffer utilizing a Masonry Wall. Tree and shrub requirements still apply with the exception of evergreen trees. In lieu of the required evergreen trees 0.5 deciduous trees and 2 shrubs shall be provided for each evergreen tree that would have been required without the wall.

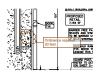

Subject: Planning Department

Author: C.McLeod Date: 5/2/2024 3:46:06 PM

Status:

Ordinance requires 20 feet.



Subject: Planning Department

Author: C.McLeod

Date: 5/2/2024 3:57:12 PM

Status:

It appears the pavement edge can be moved west to try to limit excessive paving.



Author: C.McLeod

Date: 5/2/2024 4:09:38 PM

Status:

Since property to the south is zoned for residential purposes, a landscape buffer D is required between NB Neighborhood Business District and R One Family Districts.



Subject: Planning Department

Author: C.McLeod **Date:** 5/2/2024 4:10:03 PM

Status:



Subject: Planning Department

Author: C.McLeod

Date: 5/6/2024 12:05:58 PM

Status:

Revise based on revised stacking space length required by Ordinance



Subject: Planning Department

Author: C.McLeod

Date: 5/6/2024 12:44:22 PM

Status:

These should be defined at this time to help determine landscape cost estimate. If necessary modifications can occur at a later date



Subject: Planning Department

Author: C.McLeod

Date: 5/6/2024 12:49:03 PM

Status:

Additional brick veneer on east facade may be necessary upon Planning Commission review. Adding brick veneer along base of facade - across all facade materials may be appropriate to increase percentage of masonry and provide additional durability.



Subject: Planning Department

Author: C.McLeod

Date: 5/6/2024 12:50:29 PM

Status:

These architectural features should provide some level of projection from facade and should be carried to grade level.



Subject: Planning Department

Author: C.McLeod

Date: 5/6/2024 12:51:48 PM

Status:

Mounting height adjacent to residential is 15 feet (typ)



Subject: Planning Department

Author: C.McLeod

Date: 5/6/2024 12:51:58 PM

Status:

Mounting height adjacent to residential is 15 feet (typ)



Subject: Planning Department

Author: C.McLeod

Date: 5/6/2024 12:52:33 PM

Status:

Mounting height adjacent to residential is 15 feet (typ)




Subject: Planning Department

Author: C.McLeod

Date: 5/6/2024 12:54:23 PM

Status:

LED light sources shall have a correlated color temperature that does not exceed 3,000K.

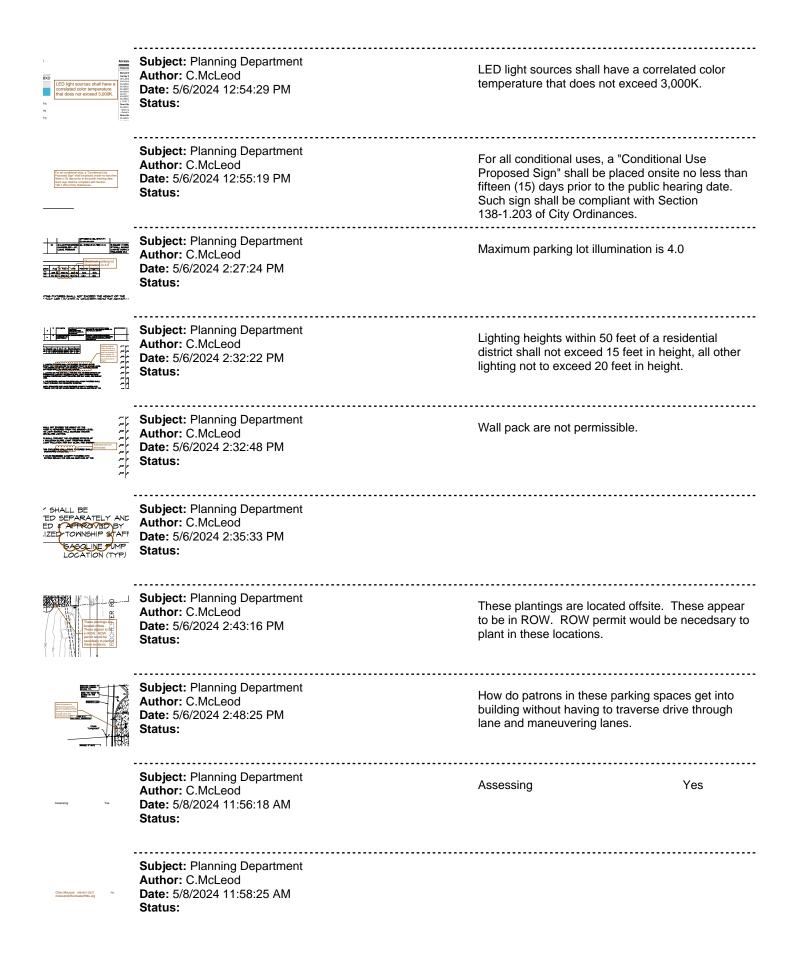



Author: C.McLeod

Date: 5/8/2024 3:52:50 PM

Status:



Subject: Planning Department

Author: C.McLeod

Date: 5/8/2024 3:58:46 PM

Status:

Parallel parking space length of 22'

Required by Ordinance



Subject: Planning Department

Author: C.McLeod

Date: 5/8/2024 3:59:35 PM

Status:

Restaurant use will likely impact parking calculations.

Polygon (1)



Subject: Polygon

Author: Jenny McGuckin Date: 5/2/2024 11:15:00 AM

Status:

Traffic (1)



Subject: Traffic Author: Keith

Date: 5/6/2024 3:18:40 PM

Status:

Traffic, Pathways, Sidewalks (7)




Subject: Traffic, Pathways, Sidewalks

Author: Keith

Date: 5/6/2024 3:17:57 PM

Status:

Rochester Rd is MDOT ROW.

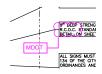

Subject: Traffic, Pathways, Sidewalks

Author: Keith

Date: 5/6/2024 1:46:34 PM

Status:

MDOT



Subject: Traffic, Pathways, Sidewalks

Author: Keith

Date: 5/6/2024 3:12:55 PM

MDOT permit required prior to Site Plan approval. At least we need to see MDOT review comments with next review.

Status:

NOT FOR CO

Subject: Traffic, Pathways, Sidewalks

Author: Keith

Date: 5/6/2024 1:49:45 PM

Status:

City's TIS review will be done concurrently with MDOT's review.



Subject: Traffic, Pathways, Sidewalks

Author: Keith

Date: 5/6/2024 3:15:37 PM

Status:

Install Pathway across property frontage. Coordination with MDOT & City as in 2027 MDOT/City plans to install pathway across the M-59 bridge.



Subject: Traffic, Pathways, Sidewalks

Author: Keith

Date: 5/6/2024 3:16:29 PM

Status:



Subject: Traffic, Pathways, Sidewalks

Author: Keith

Date: 5/6/2024 3:17:49 PM

Status:

Underground Utilities (6)



Subject: Underground Utilities **Author:** Jason Boughton **Date:** 4/23/2024 11:26:08 AM

Status:

Need to account for offsite drainage coming onto the property to verify storm sewer pipe is sized accordingly.

why empty space/ no vehicle shown.



Subject: Underground Utilities Author: Jason Boughton Date: 4/23/2024 11:36:43 AM

Status:

Provide access manholes at the southwest and southeast corner of the underground detention system.



Subject: Underground Utilities **Author:** Jason Boughton **Date:** 4/23/2024 11:37:41 AM

Status:

State due to the proposed use of the property infiltration aka CPVC will not be required.



Subject: Underground Utilities **Author:** Jason Boughton

Date: 4/23/2024 11:39:03 AM

Status:

Soil Group B is 0.20 per the updated storm sewer standards approved in Sept of 2023, revise the C factor throughout.



Subject: Underground Utilities **Author:** Jason Boughton

Date: 4/23/2024 11:41:18 AM

Status:

Revise to 2.44 people per REU



Subject: Underground Utilities **Author:** Jason Boughton

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Date: 4/23/2024 11:43:14 AM

Status:

Verify that this sizing can account for all the offsite drainage coming from the west