SANITARY SEWER QUANTITIES

QTY	UNIT	ITEM
1132	LF	8" PVC TRUSS PIPE
773	LF	8" PVC SDR 26
717	LF	6" PVC SDR 23.5
12	EA	4' MANHOLE
1	EA	8" BULKHEAD

CLEANOUT

EA

10

WATE	R MAIN	I QUANTITIES	Assessing	L. Taylor 248-841-2417 taylorl@rochesterhills.org	Yes
			Building	M. Artinian 248-841-2446	Yes
QTY	UNIT	ITEM	Ŭ	ArtinianM@RochesterHills.org	
1173	LF	8" DI CL 54 WATER MAIN	Engineering -	A Hysinger HysingerA@RochesterHills.org	No
37	LF	6" DI CL 54 WATER MAIN	Utilities	J Boughton BoughtonJ@RochesterHills.org	110
448	LF	4" DI CL 54 PRIVATE FIRE SUPPRESSION	Enginopring	Seth Bucholz	
138	LF	2" TYPE K COPPER WATER SERVICE	Engineering	248-841-2491	YES
910	LF	1" TYPE K COPPER WATER SERVICE	Legal	bucholzs@rochesterhills.org	Date:09/10/202
3	EA	8" GATE VALVE IN WELL	Fire	Captain Josh Boyce 248-841-2713	Yes
1	EA	8" D.I. CAP	1 116	BoyceJ@RochesterHills.org	
7	EA	STANDARD HYDRANT ASSEMBLY	Natural	Matt Einheuser 248-841-2551	Yes
CTOD			Resources	EinheuserM@RochesterHills.org	

Planning

Traffic

STORM SEWER QUANTITIES

QTY	UNIT	ITEM
15	LF	6" SCH 40 PVC
2034	LF	12" CL IV RCP
271	LF	18" CL IV RCP
84	LF	24" CL IV RCP
498	LF	36" CL IV RCP
6	EA	2' INLET
21	EA	4' CATCH BASIN
6	EA	4' MANHOLE
3	EA	5' MANHOLE
1	EA	6' MANHOLE
1	EA	CONTECH CASCADE SEPARATOR CS-10
1	EA	12" FLARED END SECTION
1	EA	36" FLARED END SECTION
1	EA	POND OUTLET STANDPIPE STRUCTURE

DESIGN ENGINEER/SURVEYOR

Site Plan Review

JRMFD2022-0028

PFSC2025-0001

Revision #1

Received 8/20/2025

Reviewed for compliance with City Ordinance, Building and Fire Codes Conditions and mark-ups noted throughout plan set must be addressed prior to final

	Department	Reviewer	Approved
	Assessing	L. Taylor 248-841-2417 taylorl@rochesterhills.org	Yes
	Building	M. Artinian 248-841-2446 ArtinianM@RochesterHills.org	Yes
	Engineering - Utilities	A Hysinger HysingerA@RochesterHills.org J Boughton BoughtonJ@RochesterHills.org	
E E	Engineering Legal	Seth Bucholz 248-841-2491 bucholzs@rochesterhills.org	YES Date:09/10/2025
	Fire	Captain Josh Boyce 248-841-2713 BoyceJ@RochesterHills.org	Yes
	Natural Resources	Matt Einheuser 248-841-2551 EinheuserM@RochesterHills.org	

Chris McLeod 248-841-2572

mcleodc@RochesterHills.org

Keith Depp 248-841-2503

Next Steps: Plans are being forwarded to the October 7, 2025 Planning

Wetland **Parmit**









Land Improvement Permit

GENERAL

SITE SURVEY (BY REICHERT SURVEYING INC)

TOPOGRAPHIC SURVEY - OFFSITE

SOIL BORING LOGS

SOIL BORING LOGS

SOIL BORING LOGS CIVIL DEMOLITION

SHEET CD-1.2 DEMOLITION PLAN - SOUTH

SITE PLAN

DEMOLITION PLAN - NORTH

DEMOLITION PLAN - OFFSITE

SITE PLAN - BUILDING DATA

DIMENSION AND PAVING PLAN - NORTH

SANITARY SEWER PLAN AND PROFILE

STA 0+00 TO 4+00 (ALONG ANGARA DRIVE)

STA 4+00 TO 12+22 (ALONG ANGARA COURT)

STA 12+22 TO 16+49 (OFFSITE TO SOUTH)

STA 0+00 TO 2+94 (ALONG HARVEY STREET)

SITE PLAN - OVERVIEW

SHEET C-1.3 DIMENSION AND PAVING PLAN - SOUTH

CODE ANALYSIS

WETLAND PLAN

SHEET C-4.3 WATER MAIN PROFILES

SHEET C-6.6 STORM SEWER PROFILES

SHEET C-7.2 GRADING PLAN - SOUTH

SHEET C-8.1 SESC PLAN - NORTH

SHEET C-8.3 SESC PLAN - OFFSITE

SHEET C-9.0 DRAINAGE AREA PLAN

SHEET C-9.3 CONTECH CASCADE DETAIL

SHEET C-10.1 MOT TYPICALS AND NOTES

SHEET C-10.4 CONSTRUCTION PLAN

SHEET C-10.5 GRADING AND SESC PLAN

SHEET C-11.1 MDOT R-28 & CITY CURB

SHEET C-10.2 MOT PLAN

SHEET C-11.0 DETAILS

SHEET L-3

SHEET C-11.2 MDOT R-29

SHEET C-12.0 SPECIFICATIONS

SHEET C-12.1 SPECIFICATIONS

ROAD PLANS

SHEET C-10.6 PAVEMENT MARKING AND SIGNAGE PLAN

SPECIFICATIONS

LANDSCAPE PLAN NORTH

LANDSCAPE PLAN SOUTH

SHEET C-10.0 AUBURN ROAD TYPICAL SECTIONS

GRADING

SHEET C-6.1 STORM SEWER PLAN - NORTH

SITUATIONAL PLANS

FIRE PROTECTION PLAN

WETLAND CROSS SECTIONS

WATER MAIN PLAN - NORTH

STORM SEWER PLAN - SOUTH

ANGARA DRIVE / STORM SEWER PROFILES

ANGARA DRIVE / STORM SEWER PROFILES

SOIL EROSION & SEDIMENTATION CONTROL (SESC)

STORM SEWER PLANS

STORM SEWER PROFILES

GRADING PLAN - NORTH

GRADING PLAN - OFFSITE

SHEETS C-7.4-8 GRADING PLAN - DETAILS A THRU E

SESC PLAN - SOUTH

SHEET C-8.4 OAKLAND COUNTY SESC NOTES AND DETAILS

STORM WATER MANAGEMENT

STORM WATER CALCULATIONS

EXISTING CONDITIONS AND REMOVAL PLAN

TREE REMOVAL AND PRESERVATION PLAN NORTH

TREE REMOVAL AND PRESERVATION PLAN SOUTH

ENLARGEMENTS AND LANDSCAPE DETAILS

DETENTION BASIN DETAILS

COVER

SHEET G-1.0

SHEET C-2.2

SHEET C-2.4

SHEET C-6.5

SHEET C-7.1

SHEET C-7.3

SHEET C-8.2

SHEET C-9.2

	TO MDOT	LAN SUBN	SUBMITTAL	SUBMITTAL		SUBMITTAL	PER CITY A
SHEET INDEX	UBMITTAL	Y SITE P	TE PLAN	TE PLAN	TO MDOT	TE PLAN	E PLAN F
	S	AR A	\ <u>\</u>	SIT		SIT	SIT

2 CONCEPT SUBMITTAL TO MDOT	2 PRELIMINARY SITE PLAN SUBM	3 REVISED SITE PLAN SUBMITTAL	3 REVISED SITE PLAN SUBMITTAL	RESUBMIT TO MDOT	REVISED SITE PLAN SUBMITTAL	REVISED SITE PLAN PER CITY A	REVISED SITE PLAN PER MDOT	PRELIMINARY SITE PLAN TO	REVISED SITE PLAN / WETLAN	REVISED SITE PLAN / WETLAN	REV PRELIMINARY SITE PLAN	4 CONSTRUCTION PLAN SUBMITT	CONSTRUCTION PLAN RESUBM	CONSTRUCTION PLAN RESUBM	CONSTRUCTION PLAN RESUBM	WATER AND SANITARY PERMIT
05/23/2055	11/11/2022	04/28/2023	08/23/2023	9/13/2023	1/22/2024	3/14/2024	3/28/2024	5/17/2024	7/24/2024	8/13/2024	9/4/5024	11/20/2024	4/2/2025	2/58/5052	2/1/5025	8/1/2025

INCLUDED SHEETS

 \bullet $| \bullet | \bullet |$

 \bullet

CITY OF ROCHESTER HILLS, OAKLAND COUNTY STANDARD DETAILS

PLAN SUBMITTALS

KEVIN C. MCDEVITT ENGINEER 6201043260

INNOVATIVE GEOSPATIAL

298 VETERANS DRIVE

FOWLERVILLE. MICHIGAN 48836 (OFFICE) 517-223-3512 MONUMENTENGINEERING.CO SERVICE DISABLED VETERAN OWNI SMALL BUSINESS (SDVOSB)

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AUBURN ANGARA

(248) 703-4653

OAKS, LLC 14496 N SHELDON RI SUITE 230 PLYMOUTH, MI 48170 BRUCE MICHAEL

COVER

ORIGINAL ISSUE DATE: 05/19/2022


PROJECT NO: 22-051

SCALE: N/A 1/2" FIELD: REICHERT

DRAWN BY: MN DESIGN BY: KM CHECK BY: AP

G-1.0

ANGARA OAKS

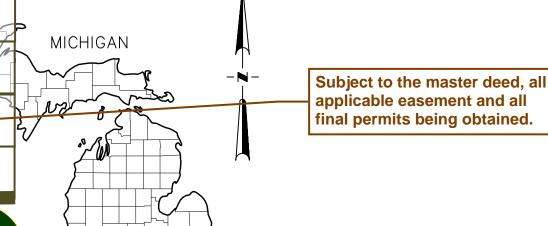



OAKLAND COUNTY **Landscape Bond**

City of Rochester

Hills Planning &

Economic

Development

_andscape Bond = \$171,745 plus inspection fees.

Natural Features

1,137 linear feet of natural features setback disturbance = 20,730 permanent square feet of disturbance and 6,022 square feet



Wetland



39,625 square feet of wetland impact

CLIENT

AUBURN ANGARA OAKS, LLC 14496 NORTH SHELDON ROAD, SUITE 230 PLYMOUTH, MI 48170 CONTACT: BRUCE MICHAEL PHONE: (248) 703-4653

ARCHITECT

J. BRADLEY MOORE & ASSOCIATES, INC. 4844 JACKSON ROAD STE 150 ANN ARBOR, MI 48103 PHONE: (734) 930-1500

LANDSCAPE ARCHITECT

VERT VERDE LANDSCAPE ARCHITECTURE, LLC 44960 ALBERT DRIVE PLYMOUTH, MI 48170 JAMES GRAY, PLA PHONE: (734) 249-3568

SURVEYOR

REICHERT SURVEYING, INC. 140 FLUMERFELT LANE ROCHESTER, MI 48306 BRADLEY G. REICHERT, P.S. PHONE: (248) 651-0592

Resubmit when most of the permits listed in the index have been obtained. Changes usually occur with the outside agencies reviewing/approving it prior to the permit being issued. The final site condo needs to reflect all these changes prior to approval per the City of Rochester Hills Ordinance.

	NUMBER	PERMIT TYPE	GOVERNING AGENCY	APPROVAL DATE
	2024-0463	WETLAND USE PERMIT (CITY)	ROCHESTER HILLS	11/11/2024
		FIRE MARSHALL	ROCHESTER HILLS FD	xx/xx/xxxx
n	2024-0462	PRELIMINARY CONDO APPROVAL	ROCHESTER HILLS	11/11/2024
		FINAL CONDO APPROVAL	ROCHESTER HILLS	xx/xx/xxxx
		CONSTRUCTION DOCUMENTS	ROCHESTER HILLS	XX/XX/XXXX
		ENGINEERING/DRAINAGE REVIEW	ROCHSTER HILLS	xx/xx/xxxx
		SOIL EROSION SEDIMENTATION CONTROL PERMIT	OAKLAND COUNTY WRC	XX/XX/XXXX
	63042-086111-22	MDOT ROW PERMIT APPROVAL	MDOT	04/23/2024
	WRP044129 V.1	PART 303 WETLAND PERMIT	EGLE	XX/XX/XXXX
		ACT 399 PERMIT (WATER)	EGLE	xx/xx/xxxx
		PART 41 PERMIT (SANITARY)	EGLE	xx/xx/xxxx
		NOTICE OF COVERAGE	EGLE	XX/XX/XXXX

SITE PERMIT APPROVAL INDEX

NOTE: BUILDING PERMITS (BUILDING, ELECTRICAL, PLUMBING, MECHANICAL, ETC.) ARE TRACKED SEPARATELY ON THE ARCHITECTURAL PLANS.

				•
INNOVA ⁻	TIVE GEO	SPATIAL (&	
			_	

ENGINEERING SOLUTIONS

MONUMENT ENGINEERING GROUP ASSOCIATES. INC

298 VETERANS DRIVE, FOWLERVILLE, MI 48836 KEVIN C. MCDEVITT, PE

PHONE: 517-223-3512

CITY OF ROCHESTER HILLS,

LOCATION MAP

FILE:P:\Projects\2022\22-051 Auburn Angara Sub\Dwg\Engineering\22-051_G-1.0_Cover.dwg PLOT DATE:8/20/2025 10:07 AM

SITE SURVEY PARCEL "1": LOTS 10 AND 13. SUPERVISOR'S P.OF GRANT M. JOHN'S SUBDIVISION, ACCORDING TO THE PLAT THEREOF AS RECORDED IN L.54A OF PLATS, PAGE(S) 61, O.C.R. PARCEL "2": LOT 11, SUPERVISOR'S PLAT OF GRANT M. JOHN'S SUBDIVISION, ACCORDING TO THE PLAT THEREOF AS RECORDED IN LIBER 54A OF PLATS, PAGE(S) 61, OAKLAND COUNTY RECORDS.

12. TERMS AND CONDITIONS OF PEDESTRIAN BICYCLE PATH EASEMENT AND CONVEYANCE AS RECITED IN INSTRUMENT RECORDED IN L.8692, P.391, O.C.R. TERMS AND CONDITIONS OF PEDESTRIAN BICYCLE PATH EASEMENT AND CONVEYANCE AS RECITED 14. IN INSTRUMENT 13. TERMS AND CONDITIONS OF WATER EASEMENT AND CONVEYANCE AS RECITED IN INSTRUMENT RECORDED IN L.8237. RECORDED IN L.8692, P.391, O.C.R. LOT 12, SUPERVISOR'S P.OF GRANT M. JOHN'S 15. TERMS AND CONDITIONS OF WATER EASEMENT AND CONVEYANCE AS RECITED IN INSTRUMENT RECORDED IN L.8237, SUBDIVISION. ACCORDING TO THE PLAT THEREOF AS 14. TERMS AND CONDITIONS OF ORDER OF NECESSITY AS RECITED IN INSTRUMENT RECORDED IN L.7398, RECORDED IN L.54A OF PLATS, PAGE(S) 61, O.C.R. P.469, O.C.R. 16. TERMS AND CONDITIONS OF ORDER OF NECESSITY AS RECITED IN INSTRUMENT RECORDED IN L.7398, P.469, O.C.R. 17. RIGHTS OR CLAIMS OF PARTIES IN POSSESSION NOT SHOWN OF RECORD. AS TO PARCEL "2" THE SOUTH 28 FEET OF LOT 14. 11. TERMS AND CONDITIONS OF ORDER OF DEFAULT AND RIGHT OF ENTRY AS RECITED 11. IN INSTRUMENT RECORDED IN AS TO PARCEL "4" TOGETHER WITH AN EASEMENT FOR INGRESS AND L.7187, P.685, O.C.R. 11. TERMS AND CONDITIONS OF UTILITY OBLIGATION AGREEMENT AS RECITED IN INSTRUMENT 11. RECORDED IN L.8544, EGRESS IN THE EAST 12 FEET OF LOT 14 P.556, O.C.R. 12. EASEMENTS OVER SUBJECT PROPERTY AS SHOWN ON THE RECORDED PLAT. SUPERVISOR'S P.OF GRANT M. JOHN'S SUBDIVISION, 12.TERMS AND CONDITIONS OF ORDER OF DEFAULT AND RIGHT OF ENTRY AS RECITED IN INSTRUMENT RECORDED IN 13. TERMS AND CONDITIONS OF PEDESTRIAN/BICYCLE PATHWAY EASEMENT AS RECITED IN INSTRUMENT RECORDED IN ACCORDING TO THE PLAT THEREOF AS RECORDED L.7187, P.685, O.C.R. L.11290, P.859, O.C.R. 13.SUBJECT PROPERTY ABUTS A PRIVATE ROAD EASEMENT WHICH IS NOT REQUIRED TO BE MAINTAINED BY THE BOARD OF IN L.54A OF PLATS, PAGE(S) 61, O.C.R. COUNTY ROAD COMMISSIONERS OF THE COUNTY OF OAKLAND. 14.TERMS AND CONDITIONS OF PRIVATE ROAD AS RECITED IN INSTRUMENT RECORDED IN L.47627, P.794, O.C.R. 15.TERMS AND CONDITIONS OF ORDER OF NECESSITY AS RECITED IN INSTRUMENT RECORDED IN L.7398, P.469, O.C.R. 16.TERMS AND CONDITIONS OF PEDESTRIAN/RICYCLE PATHWAY FASEMENT AS RECITED IN INSTRUMENT RECORDED IN 17.TERMS AND CONDITIONS OF TEMPORARY CONSTRUCTION EASEMENT AS RECITED IN INSTRUMENT RECORDED IN L.7160, P.481, O.C.R. N.E. COR. SEC. 32, T.3N., R.11E., L.C.R.C. L.22386, P.341 S02°52'50"E M 827.85'M CL MH DRIAN CO RIM:820.62 (RESIDENTIAL) N90°00'00"E M 124.59'R 125.70'M INVERT 12" PVC INV:811.22 LOT 15 & S. 28' OF LOT 812.37 14 **#15-32-201-006** 3050 HARVEY ST 807.52 S05'05'52"E . **≥** ○696 PARCEL 2 LOT 11 #15-32-201-002 CENTER OF SEC. 32, 920**0**091 T.3N., R.11E., L.C.R.C.-L.51456, P.195 O.C.R. #15-32-201-001 2489 W AUBURN RB. 1136 LOTS 10, 11, 12, 13, 15 & PART OF LOT 14 **○**963 O967 SEWER. **○**968**○**978 INV:836.54 N05'40'44"W R 1105.42'R (RESIDENTIAL) T.3N., R.11E., L.C.R.C. L.22386, P.336 O.C.R. S05'28'22"E M 08 NRUBUA W 7085 110-821-52-81# #2507 S05°40'44"E R 39 33.16'R 33.15'M LEGAL DESCRIPTION OVERALL PARCEL DESCRIPTION: LOTS 10, 11, 12, 13, 15 AND THE SOUTH 28 FEET OF LOT 14, TOGETHER WITH AN EASEMENT DETAIL 1 FOR INGRESS AND EGRESS IN THE EAST 12 FEET OF LOT 14, SUPERVISOR'S PLAT OF GRANT M. ARROW JOHN'S SUBDIVISION, ACCORDING TO THE PLAT THEREOF AS RECORDED IN L.54A OF PLATS, PAGE(S) 61, O.C.R. PART OF THE NORTHEAST 1/4 OF SECTION 32, TOWN 3 NORTH, RANGE 11 EAST, CITY OF ROCHESTER HILLS, OAKLAND COUNTY, MICHIGAN. BEING MORE PARTICULARLY DESCRIBED AS COMMENCING AT THE NORTH 1/4 CORNER OF SAID SECTION 32; THENCE S.05°28'22"E., 33.15 FT. TO THE SOUTH RIGHT OF WAY LINE OF AUBURN ROAD AND POINT OF BEGINNING; THENCE PROCEEDING ALONG SOUTH RIGHT OF WAY LINE N.90°00'00"E., 304.60 FT.; THENCE S.05°05'52"E., 272.13 ALONG THE EAST LINE OF LOT 11; THENCE N.90°00'00"E., 125.70 FT.; THENCE

AS TO PARCEL "3" 1. EASEMENTS OVER SUBJECT PROPERTY AS SHOWN ON 11. THE RECORDED PLAT. 12. EASEMENTS OVER SUBJECT PROPERTY AS SHOWN ON 12. THE RECORDED PLAT. TERMS AND CONDITIONS OF RIGHT OF WAY AS RECITED IN INSTRUMENT RECORDED IN L.1301, P.227, O.C.R. 13. TERMS AND CONDITIONS OF RIGHT OF WAY AS RECITED IN INSTRUMENTS RECORDED IN L.1301, P.227, L.2004, P.484,

LEGEND:

SET IRON RECORD DISTANCE M MEASURED DISTANCE EXISTING GRAVEL

---- EXISTING OVERHEAD WIRES

DE EXISTING UTILITY POLE

EXISTING WATER SHUT OFF EXISTING GATE VALVE

EXISTING STORM STRUCTURE DSI EXISTING DOWN SPOUT

x 655.00 EXISTING GRADE

NO OTHER WETLANDS WERE

THREE **BRADLEY GEORGE** REICHERT LICENSE NO

- 4 W 4 W 8

SCALE: 1"=50' DRAWN: B.G.R

DATE: 9/20/21 | CHECK: G.H.R JOB # 21-068 | SHEET: V-1.0

BENCHMARK:

BM #1 ARROW ATOP FIRE HYDRANT AT THE N.W. CORNER OF LOT 11 ELEVATION 835.42 N.A.V.D.88 DATUM BM #2 ARROW ATOP FIRE HYDRANT N. SIDE OF AUBURN ROAD OPPOSITE N.E. CORNER OF LOT 11 ELEVATION 831.89 N.A.V.D. 88 DATUM

BM #3 ARROW ATOP FIRE HYDRANT ON NORTH SIDE OF AUBURN ROAD APPROXIMATELY 130 FEET WEST OF SITE. ELEVATION 849.53. N.A.V.D. 88 DATUM S.02°52'50"E., 827.85 FT. ALONG THE EAST LINE OF LOTS 14 & 15; THENCE S.89°41'20"W., 390.69 FT. ALONG THE SOUTH LINE OF LOTS 15, 13 AND 10; THENCE N.05°28'22"W., 1105.01 FT. ALONG THE WEST LINE OF LOT 10 THE POINT OF BEGINNING. CONTAINING 9.026 ACRES (NET

RESERVED THEREFROM ALL EASEMENTS AND RIGHT OF WAYS OF RECORD.

O FOUND IRON

EXISTING PAVER STONE EXISTING BUILDING EXISTING CONCRETE

EXISTING ASPHALT EXISTING LANDSCAPED AREA

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5 × .

COMMUNITIES,

OAKS

———— EXISTING STORM SEWER ———— EXISTING SANITARY SEWER —w—— EXISTING WATERMAIN

----×--- EXISTING FENCE

EXISTING HYDRANT

EXISTING WELL

EXISTING GAS SHUT OFF EXISTING SANITARY STRUCTURE

EXISTING UTILITY PEDESTAL

FLAGGING FOR THE NORTH AND EAST LIMITS OF WETLAND A RE-FLAGGED BY ASTI ENVIRONMENTAL ON 8/1/2024 (FLAGS WITH "RH")


FLAGGING FOR WETLANDS A AND NORTH LIMITS OF WETLAND B PERFORMED 7/09/2024 BY BARR ENGINEERING.


INSPECTION OF AND FLAGGING FOR OFFSITE SANITARY SEWER ROUTE, INCLUDING THE SOUTH LIMITS OF WETLAND B, PERFORMED 10/31/23 BY BARR ENGINEERING.

ENCOUNTERED BY BARR ENGINEERING ALONG THE ROUTE OF THE SANITARY

DETAIL 3

SEE LANDSCAPE PLANS FOR TREE SURVEY AND REMOVAL/REPLACEMENT

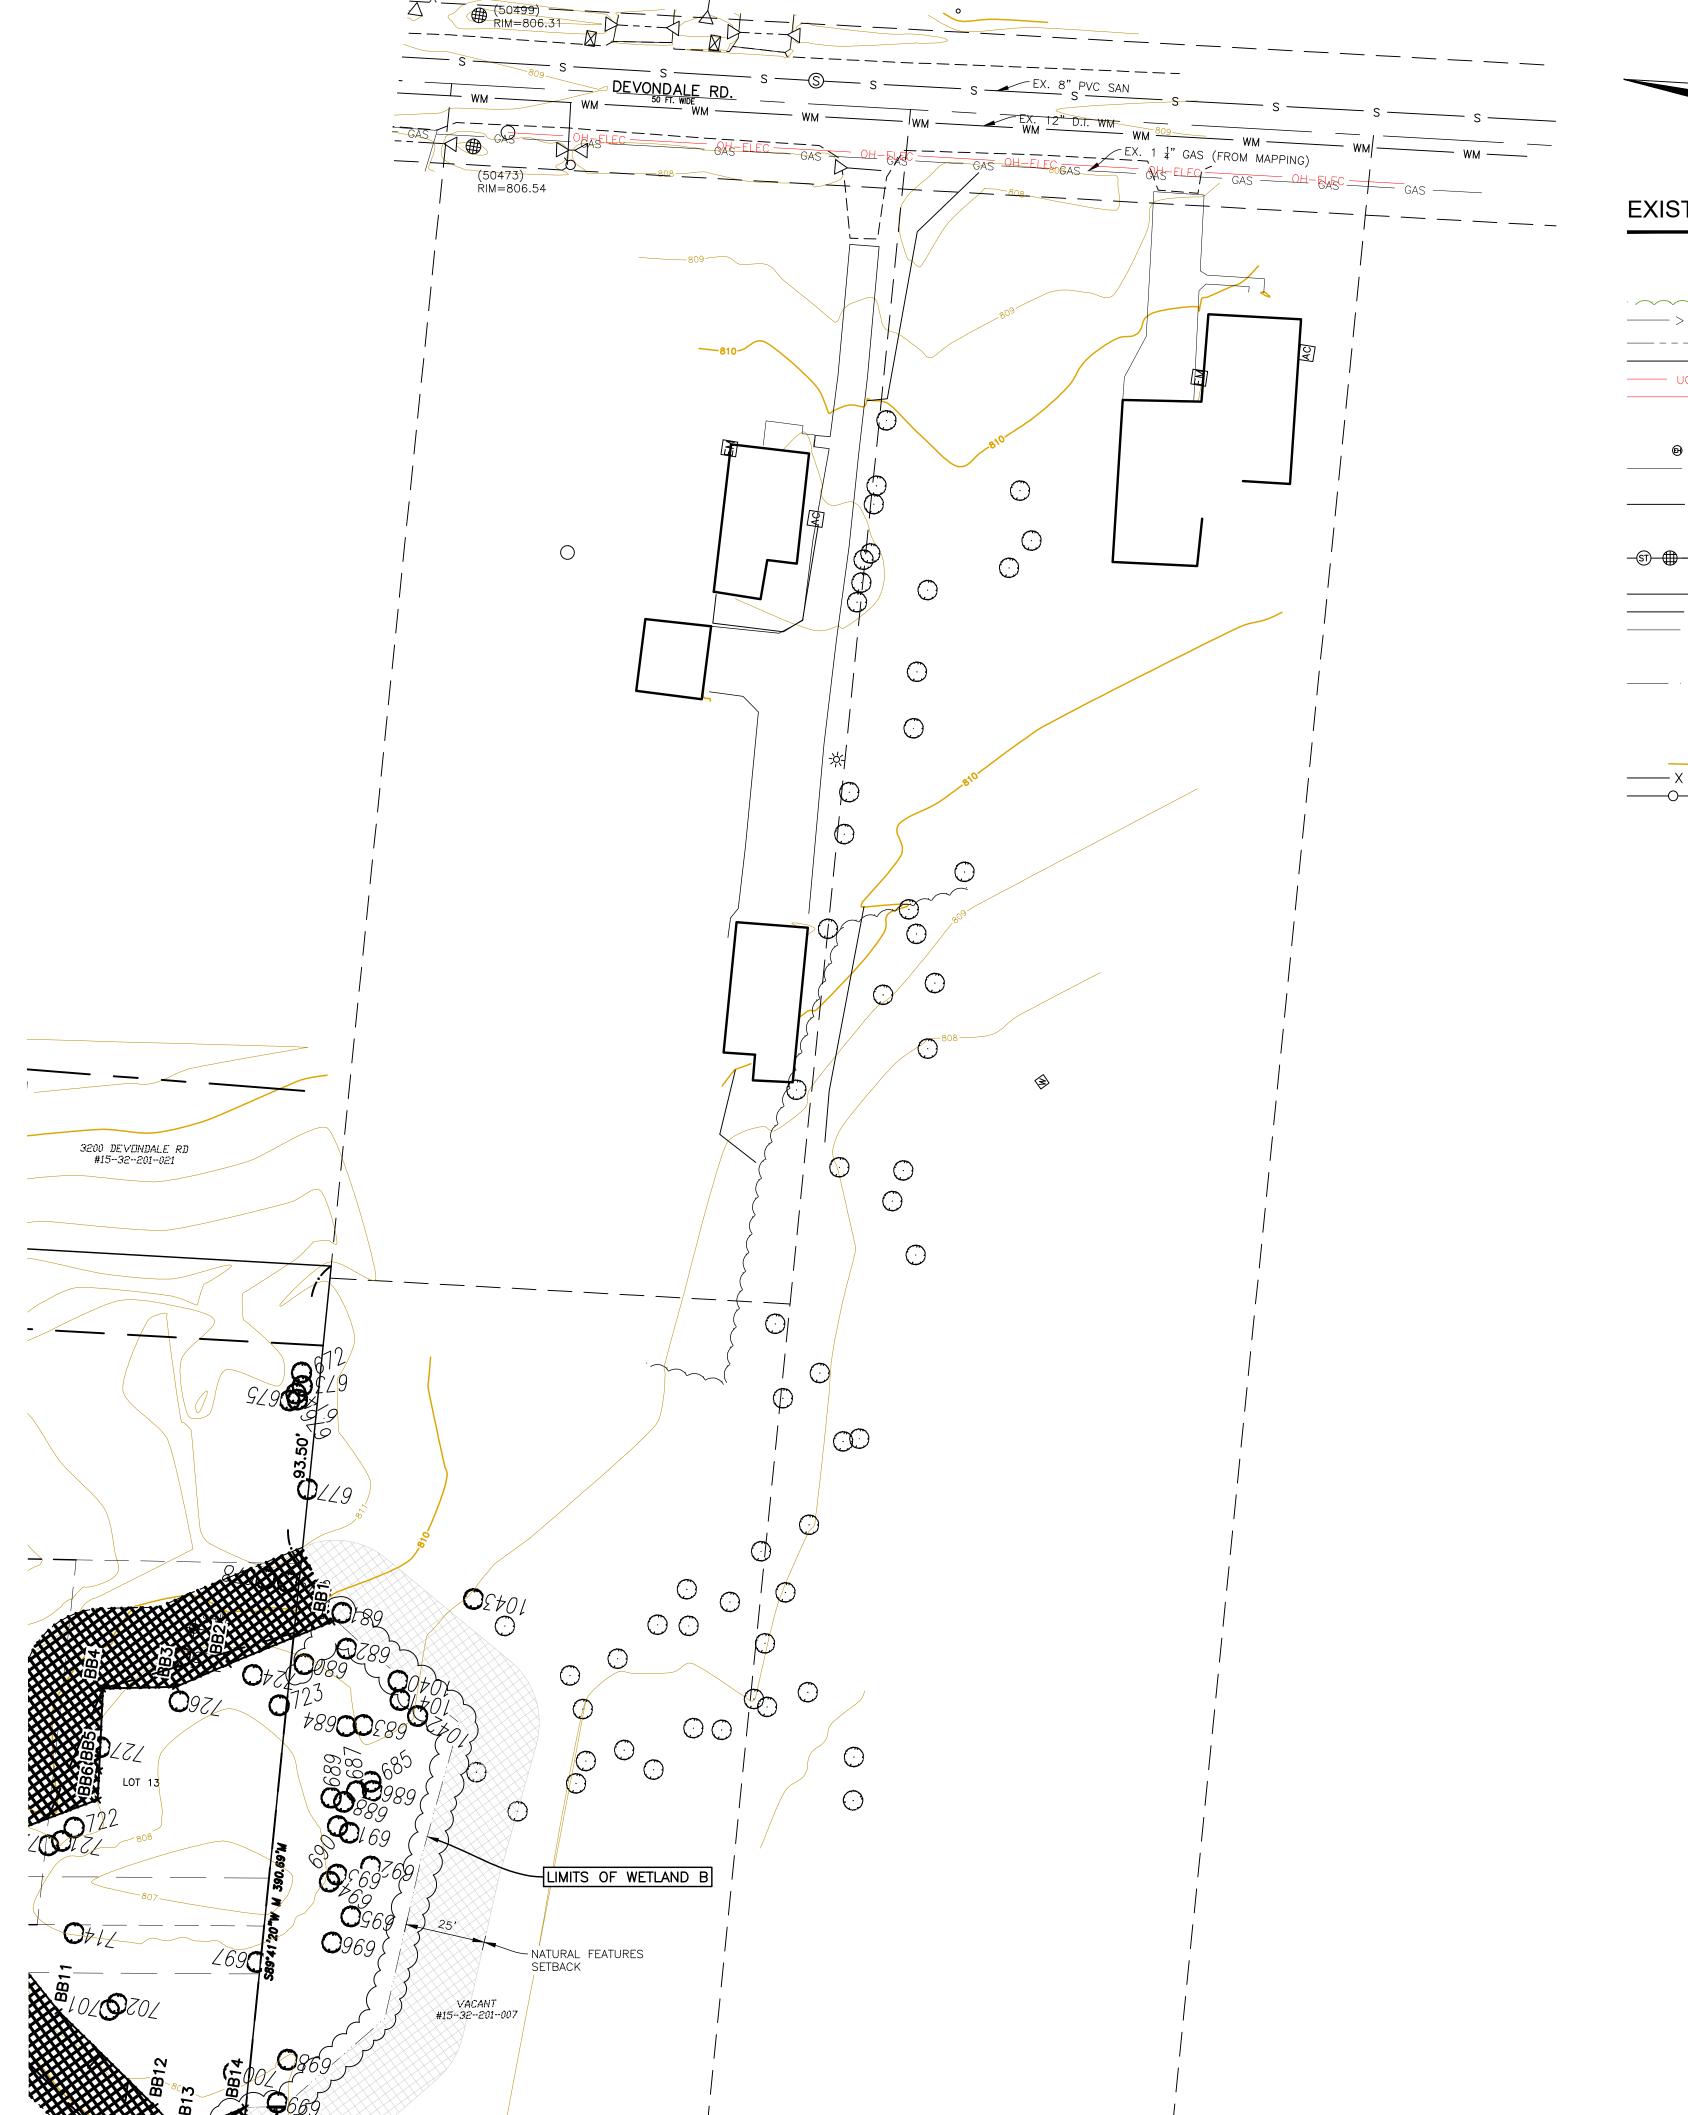

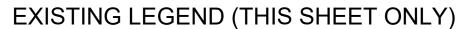

---->---->----->-----UG TELE, MH, TELE PED, CABLE PED UG FIBER, PED, LINE MARKER, VAULT O A OH-ELEC o ø 🛦 CONTOUR ____ X ____ X ____ X ____ FENCE GUARD RAIL RAILROAD SIGNAL, SIGNAL BOX SOIL BORING

DECIDUOUS TREE, CONIFEROUS TREE, SHRUB TREE LINE/ CANOPY DITCH/ DRAINING COURSE UG-ELEC - T-AC-EM-EB UG ELEC, MH, TRANSFORMER, AC UNIT, METER, BOX OH ELEC, UTIL POLE, GUY WIRE GROUND LIGHT, POLE, POLE W/ ARM LT P L 1 H LIGHT MH, LT CTRL BOX, PARK. METER, CAR CHARGER ELEC HAND HOLE, OUTLET, SIGNAL MH, SIGNAL BOX UG GAS, MH, VALVE, LINE MARKER GAS WELL, METER, VENT WATER MAIN, MH, VALVE IN BOX, HYDRANT, FDC WATER WELL, METER, STOP BOX, POST INDICATOR VALVE IRRIGATION CONTROL VALVE, SPRINKLER HEAD STORM SEWER, MH, CB, INLET, YARD DRAIN, DOWN SPOUT CULVERT/ END SECTION SANITARY SEWER, MH, CLEAN OUT COMBINED SEWER, MH STEAM LINE, MH MISC. MANHOLE, HAND HOLE, HAND BOX PARKING BLOCK, SIGN, FLAG POLE, POST, ROCK, MAIL BOX SECTION LINE, SECTION CORNER FOUND IRON ROD (FIR), FD MON, FD PK SET IRON ROD (SIR), SET PK, MAG NAIL FINISH FLOOR ELEVATION, SPOT ELEVATION

298 VETERANS DRIVE FOWLERVILLE,

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arng Group

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THE LOCATIONS AND ELEVATIONS O
EXISTING UNDERGROUND UTILITIES AS SHOW
ON THIS DRAWING ARE ONLY APPROXIMAT
NO GUARANTEE IS EITHER EXPRESSED C
IMPLIED AS TO THE COMPLETENESS C
ACCURACY THEREOF. THE CONTRACTC
SHALL BE EXCLUSIVELY RESPONSIBLE F(
DETERMINING THE EXACT UTILITY LOCATION
AND ELEVATIONS PRIOR TO THE START (
C O N S T R U C T I O N

CLIENT :

AUBURN ANGARA OAKS, LLC

14496 N SHELDON RD SUITE 230 PLYMOUTH, MI 48170 BRUCE MICHAEL (248) 703-4653

ORIGINAL ISSUE DATE:

FLAGGING FOR THE NORTH LIMITS OF WETLAND B PERFORMED 7/09/2024

INSPECTION OF AND FLAGGING FOR

WETLAND B, PERFORMED 10/31/23

NO OTHER WETLANDS WERE ENCOUNTERED BY BARR ENGINEERING ALONG THE ROUTE OF THE SANITARY

SEE LANDSCAPE PLANS FOR TREE SURVEY AND REMOVAL/REPLACEMENT

OFFSITE SANITARY SEWER ROUTE, INCLUDING THE SOUTH LIMITS OF

BY BARR ENGINEERING.

BY BARR ENGINEERING.


SEWER.

05/19/2022 PROJECT NO: 22-051

SCALE: 1" = 30'

FIELD: REICHERT DRAWN BY: MN DESIGN BY: KM CHECK BY: AP



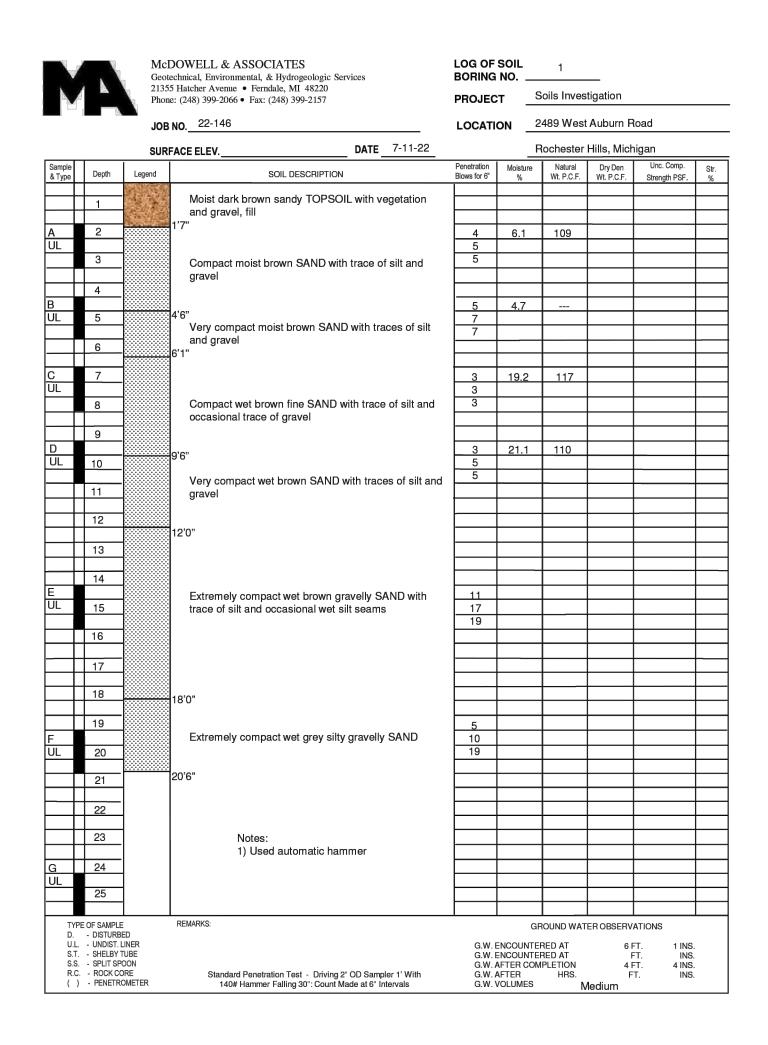

Ž		21355 Phone	5 Hatcher <i>I</i> e: (248) 39	Environmental, & Hydrogeologic Services Avenue • Ferndale, MI 48220 99-2066 • Fax: (248) 399-2157	PROJEC		Soils Inves			
			NO. 22		LOCATI	ON _	2489 West			
Sample	т —	SURF	FACE ELE	EV DATE	Penetration		Rochester Natural	Dry Den	Unc. Comp.	_
k Type	Depth	Legend		SOIL DESCRIPTION	Blows for 6"	Moisture %	Wt. P.C.F.	Wt. P.C.F.	Strength PSF.	Si 9
-+	1		_{0'5"} Moi	ist dark brown sandy TOPSOIL						\vdash
\dashv	+ ' -		_{1'5"} Moi	ist brown fine SAND with trace of silt						\vdash
	2				4	12.0				
IL	3		2'6" ^{Sur}	ff moist brown silty sandy CLAY with pebbles	2					┞
	3						+			⊢
	4		Me of o	dium compact moist brown fine SAND with traces gravel and silt			1			H
			4'6"	gravor and one	2	5.9				
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	6						_			╁
			Cor	mpact moist light brown fine SAND with trace of silt	·					
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L	•		7'0"		2					⊢
	8						+			╁
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)					3	16.5	124			
JL	10		Ext	remely compact moist to wet brown silty SAND	7					⊢
_	11		with	n layers of silt and sand						⊢
	<u> </u>									\vdash
	12									
	10									⊢
-+	13		13'0"				-			\vdash
	14									匚
IL			Ver	ry compact wet brown silty fine SAND	6					₩
, L	15				10					╁
	16		15'6"		"		+			\vdash
]								
	17									\sqsubseteq
+	18	{								⊢
\neg	1.0	1								\vdash
	19]		Notes: 1) Used automatic hammer						
	- 00	. I		, 						\vdash
L	20	- I					1		-	\vdash
	21]								
\Box]								\sqsubseteq
+	22	{					_			\vdash
\dashv	23	1								\vdash
										\Box
ì	24	{								\vdash
JL	25	- I					1			\vdash
		<u> </u>								
D. U.L. S.T.	E OF SAMPLE - DISTURB - UNDIST. I - SHELBY	ED LINER TUBE	REMARKS:			ENCOUNT ENCOUNT		ER OBSERV 9 F 13 F	T. 2 INS.	
S.S. R.C.	- SPLIT SP - ROCK CO - PENETR	OON DRE	5	Standard Penetration Test - Driving 2" OD Sampler 1' With 140# Hammer Falling 30": Count Made at 6" Intervals	G.W.		MPLETION HRS.	13 F		

Sample & Type	Depth	Legend		SOIL DESCRIPTION	Penetration Blows for 6"	Moisture %	Natural Wt. P.C.F.	Dry Den Wt. P.C.F.	Unc. Comp. Strength PSF.	Str.
				Moist dark brown sandy TOPSOIL, fill					outligati of t	7.0
\dashv	1									
	2	***************************************	1'4"	Compact moist brown silty fine SAND with trace of	6	13.7		<u> </u>		
L I				gravel and occasional stones, fill	4	13.7				
	3		2'6"		3					
\perp	4	<i>\\\\\</i>	1	Stiff moist brown silty sandy CLAY with trace of						
	4		4100	pebbles	6	14.8	132			\vdash
L	5		4'6"		9	14.0	102			
	_	<i>\\\\\\</i>	1	Extremely stiff moist variegated silty CLAY with trace of sand & pebbles	15			*	(9000+)	
\dashv	6			or sand & pebbles						\vdash
	7				8	12.9	140			
L			7'0"	Extremely stiff moist blue silty CLAY with trace of	10				(0000)	
	8	<i>/////</i>	7'10"	sand & pebbles	17			, and	(9000+)	
\dashv	9									
					- 8	10.4	137			
L	10			Extremely compact wet grey silty gravelly SAND with	10				_	
	11			moist blue silty clay seams	13					\vdash
\dashv	- ' '	100000000000000000000000000000000000000								
\Box	12									
\dashv	10									
\dashv	13		13'0"							
	14			Extremely compact wet grey SAND & GRAVEL						
L					3					
	15	11111	15'0"	Extremely stiff moist blue silty CLAY with sand &	12 18					_
	16	/////	15'6"	pebbles	"					
]								
\dashv	17									
\dashv	18									
				Netoo						
	19			Notes: 1) Used automatic hammer						
-8	20	-								
	20	1								
$\Box\Box$	21									
\dashv										
	22	1								
\Box	23									
\dashv	0.4									_
	24	-								\vdash
	25	1								
			DEM	DIV.						
D.	OF SAMPLE - DISTURB	ED	REMA	RKS: *Calibrated penetrometer				ER OBSERV		
S.T.	- UNDIST.	TUBE			G.W.	ENCOUNTEI ENCOUNTEI	RED AT		T. INS.	
R.C.	- SPLIT SP	ORE		Standard Penetration Test - Driving 2" OD Sampler 1' With	G.W.	AFTER COM AFTER	PLETION HRS.		T. 5 INS. T. INS.	
()	- PENETR	OMETER		140# Hammer Falling 30": Count Made at 6" Intervals	G.W.	VOLUMES	H	leavy		

McDOWELL & ASSOCIATES

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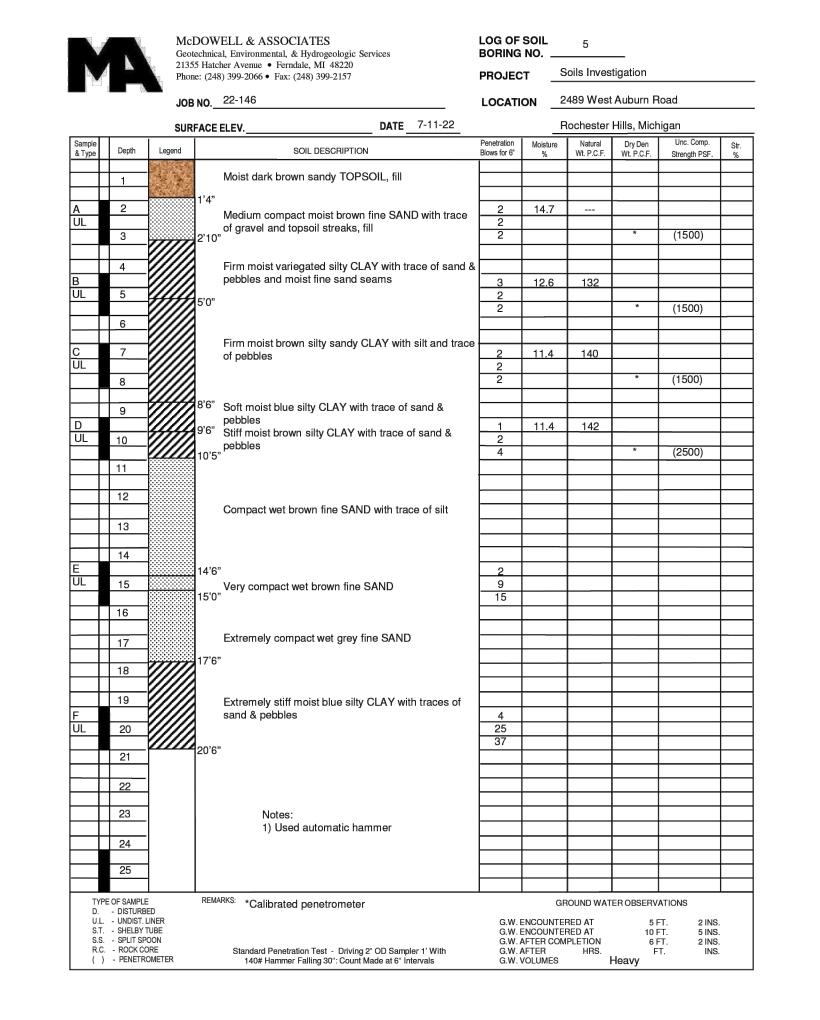
LOG OF SOIL 3


PROJECT Soils Investigation

LOCATION 2489 West Auburn Road

BORING NO. ____

V				her Avenue • Ferndale, MI 48220 3) 399-2066 • Fax: (248) 399-2157	PROJEC	т _	Soils Inves	tigation		
10.00		J	OB NO	22-146	LOCATI	ON _	2489 West	Auburn R	load	
		Phone: (248) 399-2066 JOB NO. 22-146 SURFACE ELEV apth Legend	ELEV DATE7-9-22		_	Rochester	Hills, Mich	nigan		
Sample & Type	Depth	Legend		SOIL DESCRIPTION	Penetration Blows for 6"	Moisture %	Natural Wt. P.C.F.	Dry Den Wt. P.C.F.	Unc. Comp. Strength PSF.	St
		88888888	0'5"	Moist dark brown sandy TOPSOIL						
\dashv	1	-	1′ 4″	Moist brown fine SAND with trace of gravel			+			
Α	2		Ø.,	Stiff moist variegated silty CLAY with sand & pebbles	3	14.0	121			
JL	3	•		and fine sand seams	5		+	*	(7500)	_
	3	////					+		(7300)	\vdash
	4		3'6"	Very stiff moist variegated silty CLAY with sand &						
JL	5	<i>\////</i>		pebbles	7	15.8	131			╙
JL	5		4'10"		20		+	*	(9000+)	⊢
	6			Extremely compact wet brown silty fine SAND					, ,	匚
`	7	<i>{////</i>	6'0"	Extremely stiff moist blue silty CLAY with sand &	<u></u>		1.5-			\vdash
JL	7			pebbles and wet sand lenses	11	12.2	137			\vdash
	8		7'6"		16			*	(9000+)	
			833 833							
D	9	-			4		_			┢
UL	10	-		Extremely compact wet brown silty fine SAND	9					\vdash
			999 999		11					
+	11	-	800 800 800		-		-			┢
\dashv	12	-					1			\vdash
			120							
_	13	-								<u> </u>
+	14		000 000 000				+			\vdash
				Extremely compact wet grey silty fine SAND with wet silt seams	5					
JL	15	-	883 883		10					⊢
_	16				<u> </u>		+			
			000 000							
_	17		17'0"							⊢
-	18									\vdash
\Box			883 883							
	19		333 333	Compact wet grey fine SAND with trace of gravel						<u> </u>
= JL	20	1			7		+			\vdash
			20'6"		9					
\dashv	21	1					+			_
	22						+			\vdash
\dashv										
-+	23	-		Notes: 1) Used automatic hammer			+			\vdash
_	24	1		., cook asioniano namino			\pm			\vdash
]								
	25	1					+			
	OF SAMPL		REMA	RKS: *Calibrated penetrometer	•		GROUND WAT	ER OBSERV	ATIONS	_
	 DISTURE UNDIST. 				GW I	ENCOUNT	ERED AT	4 5	FT. 10 INS	



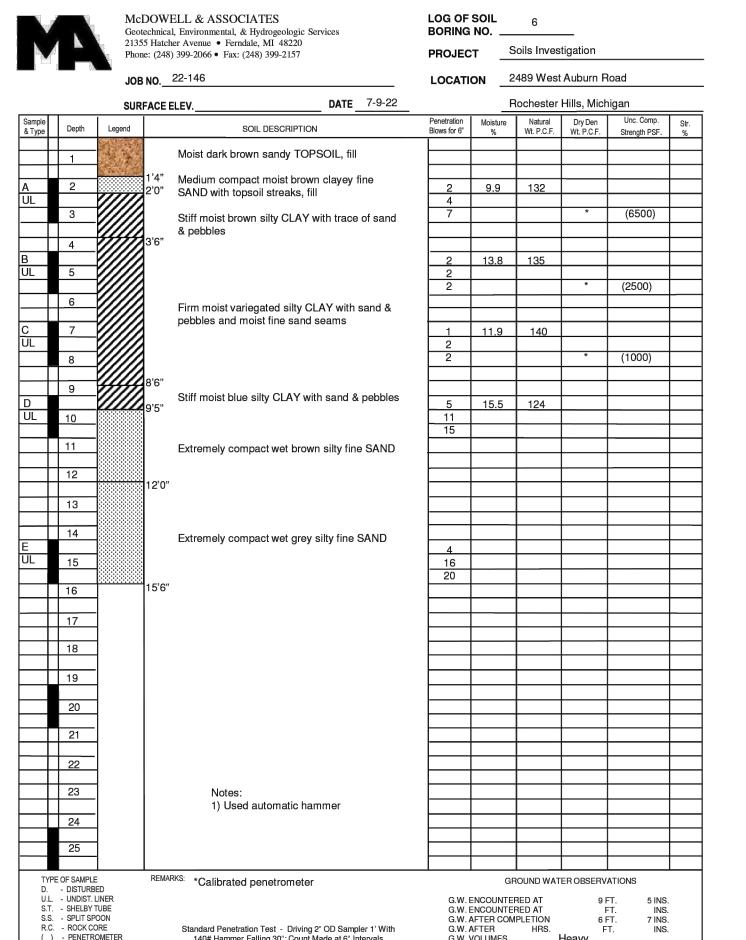

G.W. ENCOUNTERED AT
G.W. AFTER COMPLETION
G.W. AFTER HRS.
G.W. VOLUMES Heavy Standard Penetration Test - Driving 2" OD Sampler 1' With 140# Hammer Falling 30": Count Made at 6" Intervals () - PENETROMETER

DRAWN BY: MN DESIGN BY: KM CHECK BY: AP **V-2.0**

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THE LOCATIONS AND ELEVATIONS C EXISTING UNDERGROUND UTILITIES AS SHOW ON THIS DRAWING ARE ONLY APPROXIMAT NO GUARANTEE IS EITHER EXPRESSED C IMPLIED AS TO THE COMPLETENESS C ACCURACY THEREOF. THE CONTRACTC SHALL BE EXCLUSIVELY RESPONSIBLE FO DETERMINING THE EXACT UTILITY LOCATION AND ELEVATIONS PRIOR TO THE START C C O N S T R U C T I O N

AUBURN ANGARA OAKS, LLC

14496 N SHELDON RD SUITE 230

PLYMOUTH, MI 48170 BRUCE MICHAEL (248) 703-4653

CLIENT :

FOGS

BORING

OAKS

AUBU

ORIGINAL ISSUE DATE: 05/19/2022


SCALE: N/A

FIELD:

PROJECT NO: 22-051

1/2"



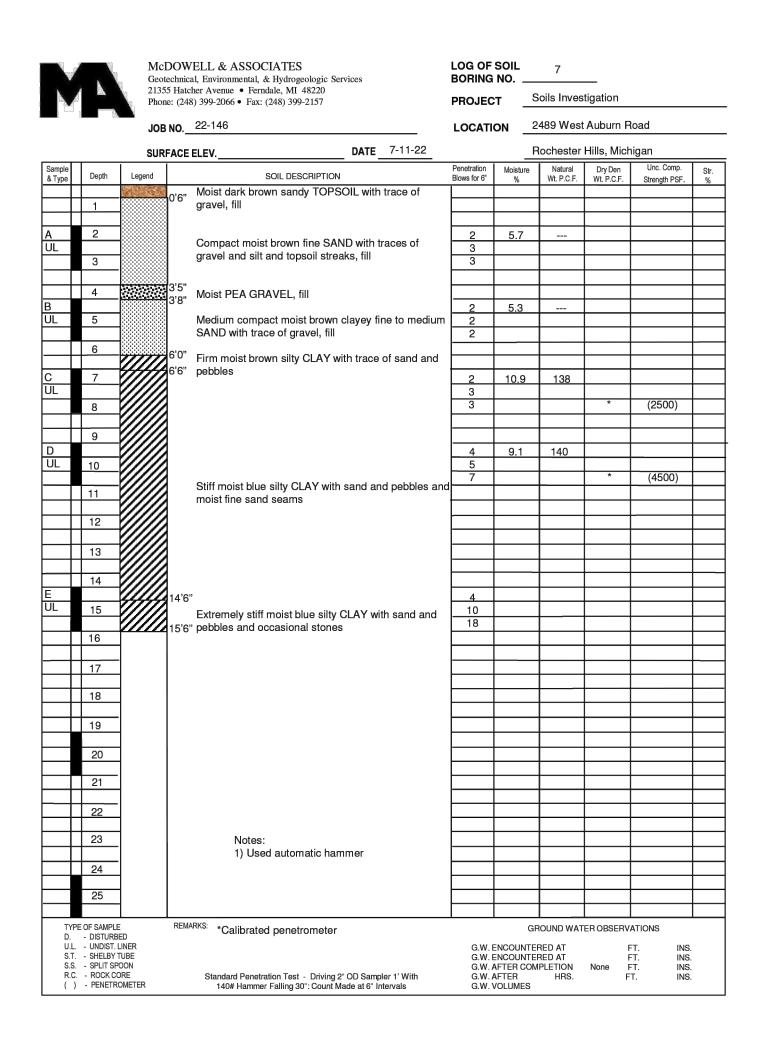

				er Avenue • Ferndale, MI 48220 399-2066 • Fax: (248) 399-2157	PROJEC	т _	Soils Inves	tigation		
	U 500	JOB	NO	22-146	LOCATI	ON _	2489 Wes	t Auburn R	load	
		SUR	FACE E	LEV DATE 7-11-22		=	Rochester		-	
Sample & Type	Depth	Legend		SOIL DESCRIPTION	Penetration Blows for 6"	Moisture %	Natural Wt. P.C.F.	Dry Den Wt. P.C.F.	Unc. Comp. Strength PSF.	Str %
	1									士
	2			Medium compact moist dark brown sandy	<u> </u>		+			\vdash
JL				TOPSOIL, fill	2	13.5	128			\vdash
	3	175	3'0"	AA II	3					
+	4		3'10"	Medium compact moist brown fine SAND with topsoil streaks, fill						\vdash
3	_		3 10		1/6"	19.0				
JL	5			Loose to slightly compact moist to wet brown fine	1/12"					_
	6	-		SAND with trace of gravel and layers of silty clay, possible fill						+
				possible IIII						$oxed{\Box}$
; JL					1	14.7	129			+
	8	5000000000	7'6"		2					+
				Medium compact to compact wet brown SAND & GRAVEL with trace of silt, occasional stones and						
)	9			seams of clay		12.6	134			₩
JL	10	1000			<u>3</u>	12.0	134			\vdash
			10'0"	Extremely stiff moist blue silty CLAY with sand	19					ldash
\dashv	11	<i>\\\\\</i>	11'0"	and pebbles and occasional stones			+			\vdash
	12									
										lacksquare
\dashv	13	<i>\\\\\</i>					+			\vdash
	14			Very stiff moist blue silty CLAY with sand and						
JL	4.5	<i>\\\\\</i>		pebbles	<u>3</u>		-			₩
<i>,</i>	15				7		+			+
	16									二
-	17		16'6"				-			 —
\dashv	17									\vdash
\Box	18									\sqsubseteq
\dashv	19			Extremely stiff moist blue silty CLAY with sand and pebbles and occasional stones			+			╁
	10				7					
	20				18 26					\vdash
	21	<i></i>	20'6"		20					\vdash
_										
\dashv	22	-					+	\vdash		\vdash
	23	1		Notes:						
\perp	0.4			1) Used automatic hammer						\vdash
	24	1								+
	25]								\sqsubseteq
TVO	E OE CALADI		REMAR	ıkş:		<u> </u>			ATION'S	
D.	E OF SAMPLE - DISTURB - UNDIST.	ED	LINA		044		GROUND WAT			
S.T.	- SHELBY	TUBE			G.W.	ENCOUNT ENCOUNT	ERED AT		T. INS) .
R.C.	ROCK CO			Standard Penetration Test - Driving 2" OD Sampler 1' With 140# Hammer Falling 30": Count Made at 6" Intervals	G.W.	AFTER CO AFTER VOLUMES		5 F Cave-In F Heavy		

		10-	NO	22-146	LOCATI	ON 2	489 Wast	Auburn F	Road	
					LOCATI					-
Sample	T	I	FACE		Penetration	 Moisture	Natural	Hills, Mich	Unc. Comp.	Ŧ
& Type	Depth	Legend		SOIL DESCRIPTION	Blows for 6"	%	Wt. P.C.F.	Wt. P.C.F.	Strength PSF.	+
	1	_		Moist brown fine SAND with trace of gravel, fill						‡
Α	2	/////	1'6"	Stiff moist discolored brown silty CLAY with	2	20.9				+
ÜL			2'6"	topsoil streaks, fill	4	20.9				†
	3			Stiff moist dark brown CLAY with topsoil, fill	4					+
	4	<i>\\\\\\\\\\\\\\\\\\\\\\\\\\\\\\\\\\\\\</i>	3'6"							\dagger
B UL	_	\ /////		Firm moist discolored brown silty CLAY, fill	1	19.1	123			Į
OL.	5	-	4'10"	, Medium compact wet grey fine SAND with trace	4			*	(2000)	t
	6		6'0"	of silt and a layer of silty clay						‡
С	7	-			2	11.6				\dagger
ŬL]		Slightly compact wet grey silty fine SAND with	2					1
	8	 		occasional trace of gravel & moist clayey silt	2					\downarrow
	9			seams						\dagger
D UL	40		9'6"		<u>2</u> 4	16.3	122			Ŧ
UL	10	-			4				_	\dagger
	11									Į
\vdash	12	-		Comment wat brown fine CAND with troop of oilt						+
				Compact wet brown fine SAND with trace of silt						1
\vdash	13	-					-			\downarrow
	14	_				_				1
E UL	15	,,,,,,,	14'6"		2		-			+
	15			Firm moist blue silty CLAY with sand & pebbles	4					†
	16	-	15'6"							Ŧ
	17	-								\dagger
]								1
\vdash	18	1								\dagger
	19]								1
	20	-					-			+
		1								1
$\vdash \vdash \vdash$	21	-								+
	22]								†
$\vdash \vdash \vdash$	23	-		Notes:						\downarrow
$\vdash \vdash \vdash$	23	-		Notes: 1) Used track rig						\dagger
	24	1								1
	25	1								+
		1		DVA						1
D.	PE OF SAMPL	BED	REMA	RKS: *Calibrated penetrometer				ER OBSERV		
S.T	UNDIST. SHELBY SPLIT SF	TUBE			G.W.	ENCOUNTE ENCOUNTE AFTER COM	RED AT	F	FT. 10 INS FT. INS	S.
R.0	C - SPEIT SE C - ROCK C) - PENETE	ORE		Standard Penetration Test - Driving 2" OD Sampler 1' With 140# Hammer Falling 30": Count Made at 6" Intervals		AFTER CON AFTER VOLUMES	IPLETION HRS.		FT. 4 INS T. INS	


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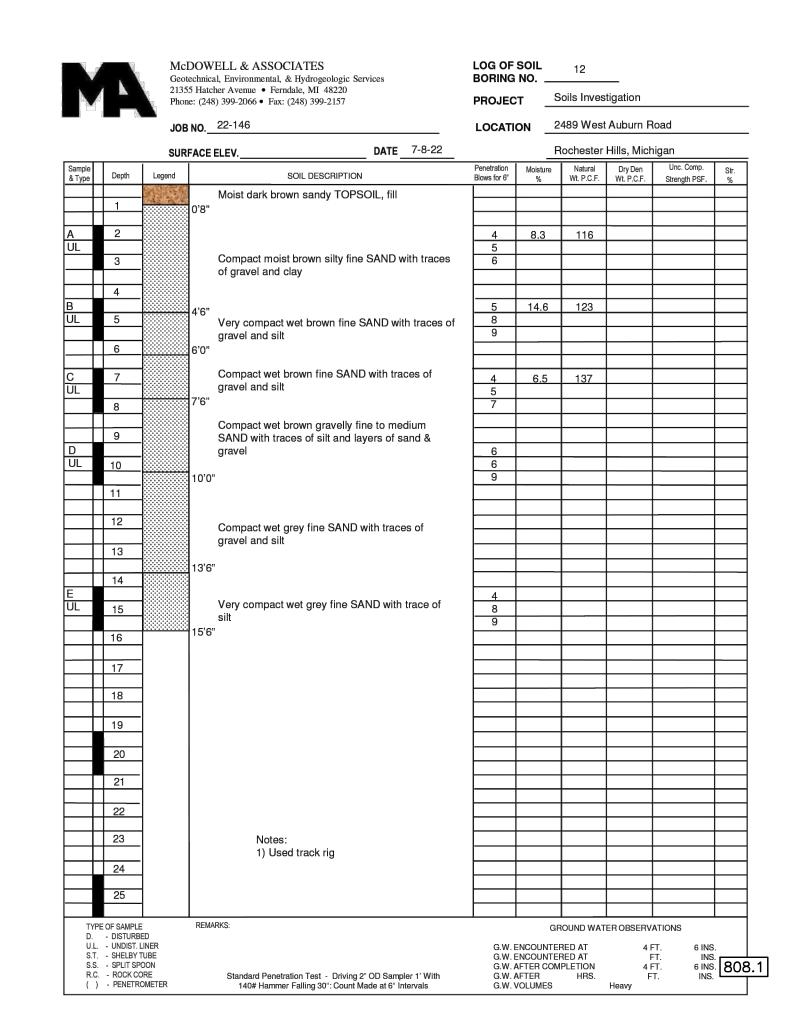
Geotechnical, Environmental, & Hydrogeologic Services

LOG OF SOIL 9

BORING NO. ____

~				her Avenue • Fe: 3) 399-2066 • Fax			PROJEC	т _	Soils Inves	'estigation				
	\$\\\	JOE	NO	22-146			LOCATI	ON _	2489 West Auburn Road					
		SUR	URFACE ELEV. DATE 7-8-22			DATE7-8-22		_	Rochester	r Hills, Michigan				
Sample & Type	Depth	Legend			SOIL DESCRIPTION		Penetration Blows for 6"	Moisture %	Natural Wt. P.C.F.	Dry Den Wt. P.C.F.	Unc. Comp. Strength PSF.	St %		
	1		0'5"		rown sandy TOF	PSOIL, fill ID with trace of silt						\vdash		
		,,,,,,,	1'5"	and gravel, f		ID Will Hadd of diff								
A UL	2						1	15.9				\vdash		
	3				scolored brown ack clayey tops	silty sandy CLAY	2							
	4			With moist bi	ack clayey tops	on seams, iiii						\vdash		
В	4		4'6"				1	19.9				\vdash		
UL	5		ľ	Madium com	naat wat brown	fine to medium	2		1			\vdash		
	6			SAND with tr		line to medium	4		+			\vdash		
0			6'6"									\vdash		
C UL	7					SAND with trace of	7 11		+			\vdash		
	8		7'6"	-	nd occasional st		11							
	9			Very stiff mo pebbles	ist brown silty C	LAY with sand &			+			╁		
D			9'6"	·			8	9.6						
UL	10	,,,,,,	10'6"	Medium com , & occasional	pact wet grey fi stones	ne SAND with gravel	3		+			\vdash		
	11											\vdash		
	10		1											
-+	12								+			╁		
	13		1	Firm moist b	ue silty CLAY w	rith sand & pebbles								
	14								+			\vdash		
E			3				2							
UL	15		1				2		+			\vdash		
	16		15'6"	,			·							
	17											igspace		
	17								+			+		
	18											lacksquare		
	19								+			\vdash		
	20								+			╁		
	21													
	22								+			╁		
	23			Note:	s: ed track rig				-			\vdash		
	24			1, 08	ou truck fly							\perp		
	25											$oxed{\Box}$		
	OF SAMPLE	<u> </u>	REMA	ıRK\$:					ROUND WAT	ER ORSERV	ATIONS			



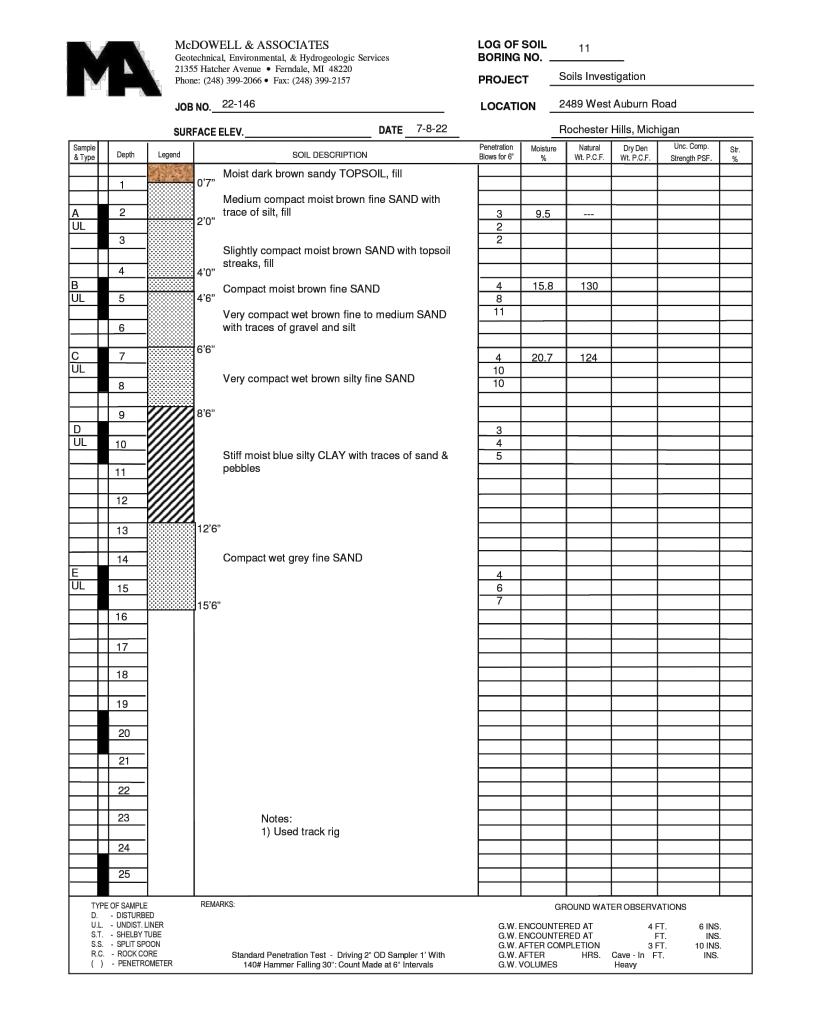



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CLIENT :

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OAKS, LLC

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BRUCE MICHAEL
(248) 703-4653

711E

SOIL BORING LOGS

AUBURN ANGARA OAKS
RT OF SEC. 32, T3N, R11E

19/2024 12/2025 12/2025 17/2025 11/2025 11/2025 11/2025

REVISED PRELIMINARY SITE PLAN TO CITY 09/04/2

CONSTRUCTION PLAN SUBMITTAL 11/20/2

ADDED WETLAND CONS. EASEMENT 12/19/2

CONSTRUCTION PLAN RESUBMITTAL #2 05/29/2

CONSTRUCTION PLAN RESUBMITTAL #3 07/07/2

WATER AND SANTITARY PERMIT PLANS 08/01/2

PROJECT NO: 22-051

SCALE: N/A

0 1/2" 1"

FIELD: REICHERT
DRAWN BY: MN
DESIGN BY: KM
CHECK BY: AP

V-2.1





	McDOWELL & ASSOCIATES Geotechnical, Environmental, & Hydrogeologic Services 21355 Hatcher Avenue • Ferndale, MI 48220 Phone: (248) 399-2066 • Fax: (248) 399-2157 JOB NO. 22-146		8220	LOG OF BORING PROJEC	NO	13 Soils Inves 2489 West		load		
			FACE ELEV.	DATE 7-8-22		_	Rochester	Hills, Mich	nigan	
Sample & Type	Depth	Legend	SOIL DESC	RIPTION	Penetration Blows for 6"	Moisture %	Natural Wt. P.C.F.	Dry Den Wt. P.C.F.	Unc. Comp. Strength PSF.	Str.
			Moist dark brown sandy	TOPSOIL, fill						,,,
\dashv	1		0'9" Compact moist brown fi	ne SAND with trace of silt			+			
A JL	2		2'0"	io of the with trace of oil	3	15.7	119			
JL	3		Compact moist brown si moist clayey sand seam	lty SAND with occasional	5 6					
	4		4'0"							
L	5		Very compact wet brown 5'0"	n silty fine SAND	<u>6</u> 8	17.6	125			
	6		Very compact wet grey of trace of gravel	clayey fine SAND with	9					
	7		6'0"		5	9.7	140			
L					6	5.7	140			
	8		Stiff moist blue silty CLA	Y with sand & pebbles	9					
	9									
) JL	10	/////	9'3"		<u>5</u> 11		-			
	10				13					
+	11		Very compact wet brow	n fine SAND with trace of	-					
	12		silt							
\perp	13						+			
\perp	10		l13'0"							
	14				4					
L	15				8					
	16		Very compact wet grey to silt and wet silt lenses		14					
	10			(Head of wate 15' drive)						
+	17									
	18		18'0"							
_	19						-			
	19				4				<u> </u>	
	20		Very compact wet grey	ine SAND with trace of	9					
	21		silt							
+	22									
\bot	23		22'6"							
	24		Very compact wet grey trace of silt	neaving fine SAND with						
	25		(Spooned out hole for sa	ımple)	<u>6</u> 10					H
			25'6"		13					
D. U.L. S.T. S.S. R.C.	OF SAMPLE - DISTURBE - UNDIST. L - SHELBY T - SPLIT SPC - ROCK CC - PENETRO	ED JINER JUBE DON JRE	REMARKS: 1) Used track rig Standard Penetration Test - 140# Hammer Falling 30"	Driving 2" OD Sampler 1' With Count Made at 6" Intervals	G.W. I G.W. <i>I</i> G.W. <i>I</i>	ENCOUNT ENCOUNT	ERED AT MPLETION HRS.	4 F 9 F 1 F	T. 0 INS	i.

McDowell & Associates			2	
Job Number: 22-146		_	7/9/20	
Project: Infiltration Study - 2489 West Auburn R	toad	Weather: _	Sun	ny
Location: Rochester Hills, Michigan		Ground Elv.: _	N/A	\
Soil Stratigraphy:			Pipe Installation	ı #1
		Soil D	epth:	4'0"
		Inner Pipe	Dia.:	3"
		Casing Le	ngth:	5'
		Embed	ment:	3"
See Boring 2 for soil and groundwater condition	S.	Stic	k-up:	1'3"
			Pipe Installation	ı #2
		Soil D	epth:	N/A
				N/A
				N/A
		Embed	ment:	N/A
		Stic	k-up:	N/A
Soak Period (Pipe #1) Start Date: 7/9/2022 Start Time:	Start Date:	Soak I N/A	Period (Pipe #2) Start Time:	N/A
Notes: Filled water to 1.97' below top of casing (TOC)				
Time: 30 min Water Drop: 0.26 feet				
Notes: Filled water to 2.12' below TOC				
Time: 30 min Water Drop: 0.19 feet	Time:		Water Drop:	inches
Notes: Filled water to 2.04' below TOC	Notes:			
Test Period (Pipe #1)		Test F	Period (Pipe #2)	
Time: 30 min Water Drop: 0.16 feet	Time:		Water Drop:	inches
Notes: Filled water to 2.01' below TOC	Notes:			
Time: 30 min Water Drop: 0.15 feet	Time:		Water Drop:	inches
Notes: Filled water to 2.0' below TOC	Notes:			
Time:30 min Water Drop:0.14feet	Time:		Water Drop:	inches
Notes: Filled water to 2.0' below TOC				
Time: 30 min Water Drop: 0.14 feet			Water Drop:	inches
Notes:				
Time: Feet	Time:		Water Drop:	inches
Notes: Average of last 4 readings = 0.15 ft/30 min	Notes:	N/A		
Average of last 4 readings 0.15 1050 mm				

McDowell & Associates	Infi	Soil Boring #: dtration Test #:	2	
Job Number: 22-146			7/9/202	
Project: Infiltration Study - 2489 West Auburn Ro	oad		Sunn	
Location: Rochester Hills, Michigan		Ground Elv.:	N/A	
Soil Stratigraphy:			Pipe Installation	#1
				.'0"
			-	3"
			ength:	
				3"
See Boring 11 for soil and groundwater condition	is.	Stie	ck-up:1	'3"
			Pipe Installation	#2
Note: Infiltartion test performed in apparent fill s	oils.	Soil I	Depth: N	I/A
		Inner Pipe	Dia.: N	J/A
		Casing L	ength: N	J/A
		Embed	lment:N	J/A
		Stie	ck-up: N	J/A
Groundwater Depth:			tance: N	
Soak Period (Pipe #1)			Period (Pipe #2)	
Start Date: 7/9/2022 Start Time:	_	: <u>N/A</u>		
Notes: Filled water to 2.11' below top of casing (TOC)				
Time: 30 min Water Drop: 0.78 feet		:		inches
Notes: Filled water to 2.00' below TOC		:		
Time: 30 min Water Drop: 0.42 feet		:	Water Drop:	inches
Notes: Filled water to 2.00' below TOC	_ Notes	:		
Test Period (Pipe #1)		Test	Period (Pipe #2)	
Time: 10 min Water Drop: 0.12 feet		:		inches
<u> </u>	Notes			
Notes: Filled water to 1.99' below TOC			Water Drop:	inches
<u> </u>		:		
Notes: Filled water to 1.99' below TOC Time: 10 min Water Drop: 0.12 feet Notes: Filled water to 2.00' below TOC	Time Notes	:		
Notes: Filled water to 1.99' below TOC Time: 10 min Water Drop: 0.12 feet	Time Notes Time	:	Water Drop:	inches
Notes: Filled water to 1.99' below TOC Time: 10 min Water Drop: 0.12 feet Notes: Filled water to 2.00' below TOC Time: 10 min Water Drop: 0.11 feet Notes: Filled water to 2.01' below TOC	Time Notes Time Notes	: : :	Water Drop:	
Notes: Filled water to 1.99' below TOC Time: 10 min Water Drop: 0.12 feet Notes: Filled water to 2.00' below TOC Time: 10 min Water Drop: 0.11 feet	Time Notes Time Notes	:	Water Drop:	
Notes: Filled water to 1.99' below TOC Time: 10 min Water Drop: 0.12 feet Notes: Filled water to 2.00' below TOC Time: 10 min Water Drop: 0.11 feet Notes: Filled water to 2.01' below TOC	Time Notes Time Notes Time Time	: : :	Water Drop:	
Notes: Filled water to 1.99' below TOC Time: 10 min Water Drop: 0.12 feet Notes: Filled water to 2.00' below TOC Time: 10 min Water Drop: 0.11 feet Notes: Filled water to 2.01' below TOC Time: 10 min Water Drop: 0.11 feet	Time Notes Time Notes Time Notes Time Notes	: : :	Water Drop:	inches

McDowell & Associates		Soil Boring #:	
Job Number: 22-146		Date:	7/9/2022
Project: Infiltration Study - 2489 West Auburn R	toad	Weather:	Sunny
Location: Rochester Hills, Michigan		Ground Elv.:	N/A
Soil Stratigraphy:		Pipe	e Installation #1
		Soil Depth:	1'6"
		Inner Pipe Dia.:	3"
		Casing Length:	5'
		Embedment:	3"
See Boring 13 for soil and groundwater condition	ns.	Stick-up:	1'3"
		Pipe	e Installation #2
		Soil Depth:	N/A
		Inner Pipe Dia.:	
		Casing Length:	
			N/A
			N/A
Soak Period (Pipe #1) Start Date: 7/9/2022 Start Time:	Start Date:		tart Time: N/A
Notes: Filled water to 2.02' below top of casing (TOC)	Notes:		
Time: 12 min 42 sec Water Drop: 2.00 feet	Time:	Wa	ater Drop:inche
Notes: Filled water to 2.01' below TOC	Notes:		
Time: 22 min 28 sec Water Drop: 2.00 feet	Time:	Wa	ater Drop:inche
Notes: Filled water to 2.00' below TOC	Notes:		
Test Period (Pipe #1)		Test Period	(Pipe #2)
Time:10 min Water Drop:0.70feet	Time:	Wa	ater Drop:inche
Notes: Filled water to 2.02' below TOC	Notes:		
Time: 10 min Water Drop: 0.67 feet	Time:	Wa	ater Drop:inche
Notes: Filled water to 2.01' below TOC	Notes:		
Time: 10 min Water Drop: 0.66 feet	Time:	Wa	ater Drop:inche
Notes: Filled water to 2.00' below TOC	Notes:		
Time: 10 min Water Drop: 0.66 feet	Time:	Wa	ater Drop:inche
Notes: Filled water to 2.00' below TOC	Notes:		
Time:10 min Water Drop:0.65 feet	Time:	Wa	ater Drop:inche
Notes: Average of last 4 readings = 0.66 ft/10 min	Notes:	N/A	

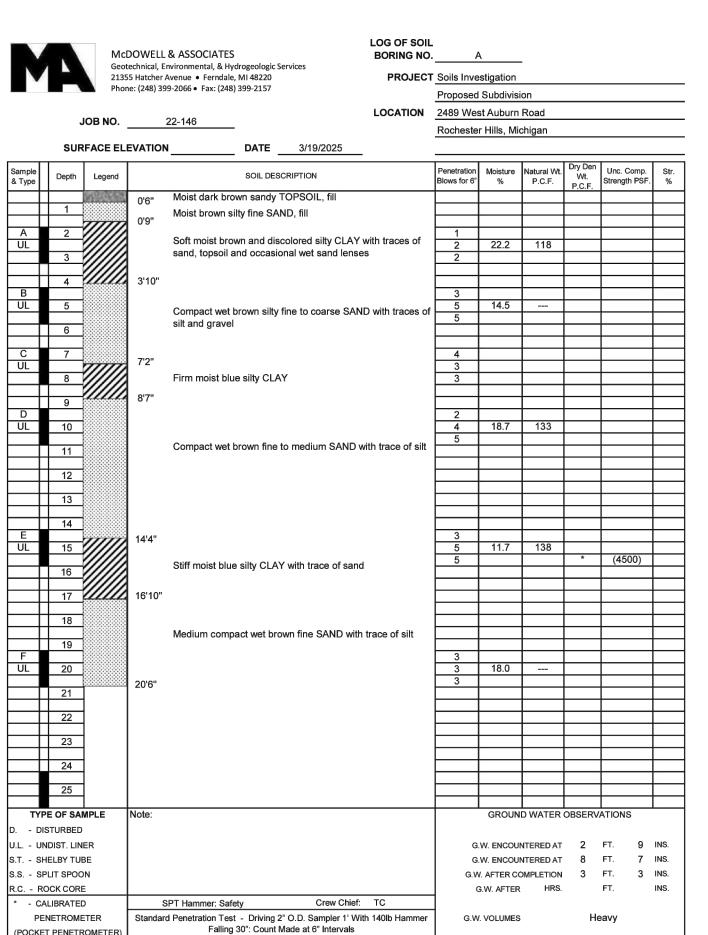


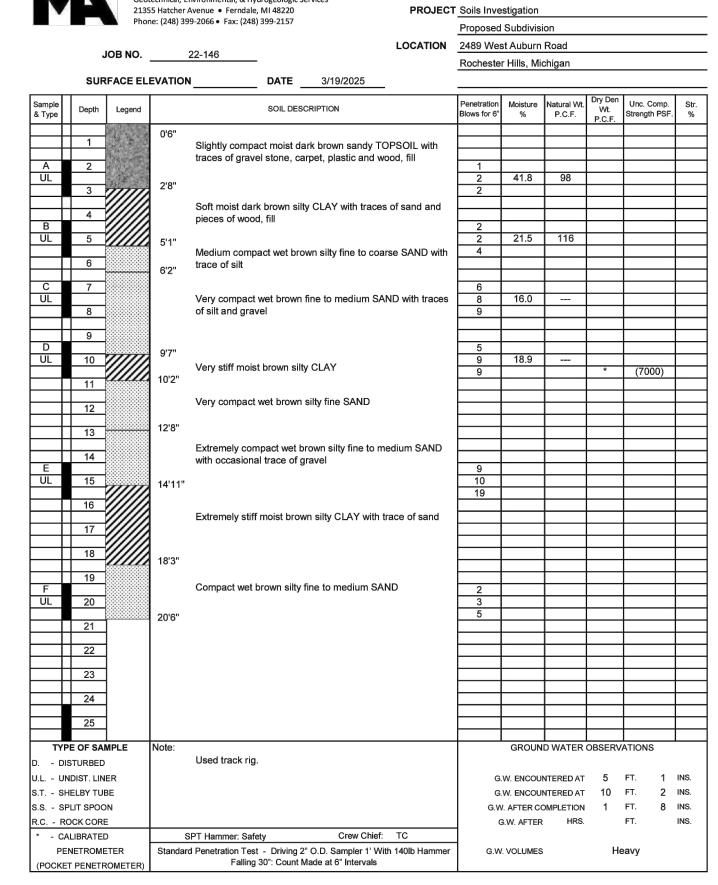


LOG OF SOIL

BORING NO. ____ B

McDOWELL & ASSOCIATES

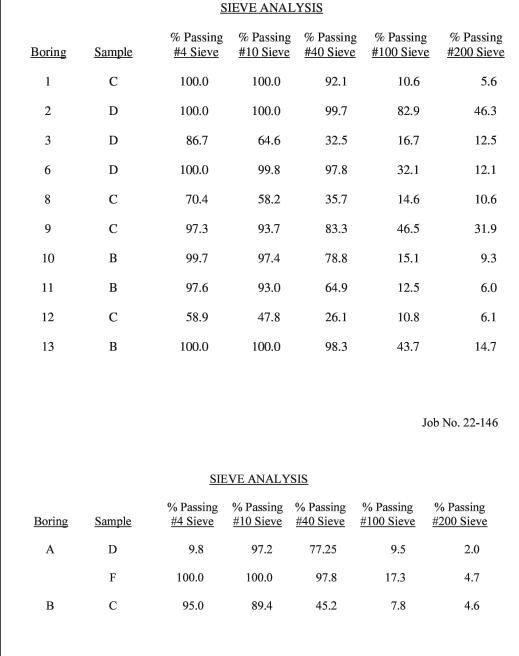

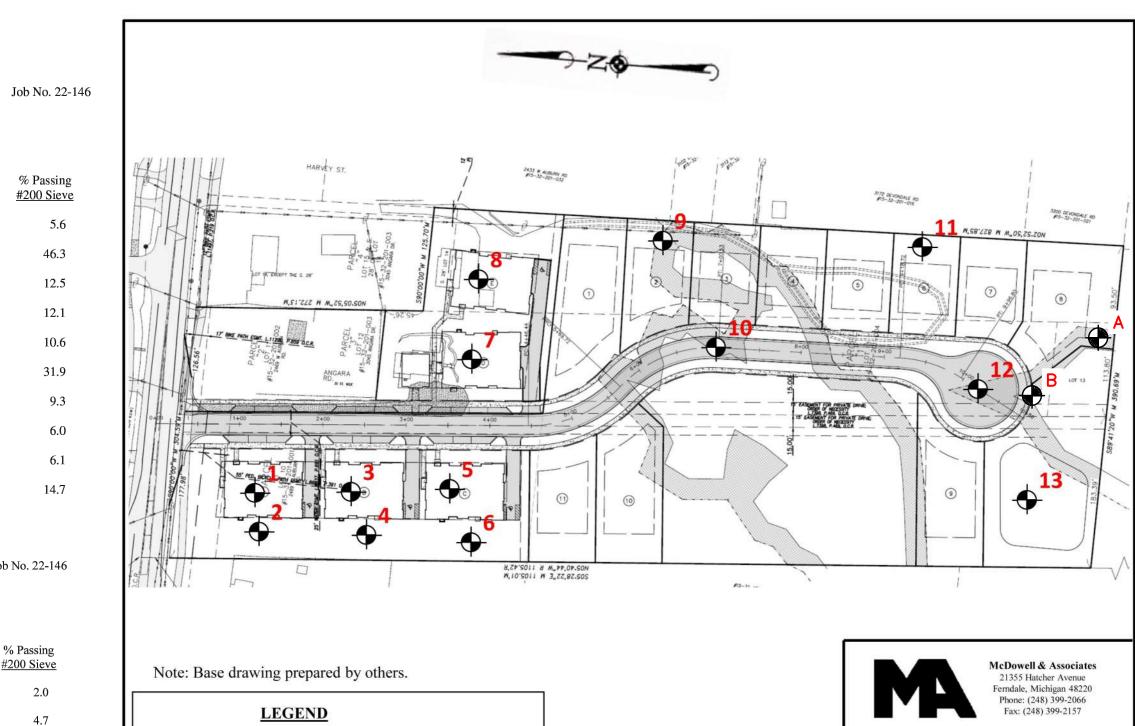

Soil Boring Locations, 1 through 13:

Drilled by McDowell & Associates

EXISTING GROUNDWATER WAS ENCOUNTERED IN BORINGS 12 AND 13 (VICINITY OF STORM WATER POND) AT ROUGHLY THE SAME ELEVATION. BASED ON THE INDICATIONS FROM THESE TWO BORINGS, IT IS ESTIMATED THAT THE STATIC WATER LEVEL DEPTHS ARE 4'-6" (808.1) IN BORING 12 AND 4'-0" (808.3) IN BORING 13.

Soil Boring Location Plan

Job No. 22-146

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AND ELEVATIONS PRIOR TO THE START C
C O N S T R U C T I O N

CLIENT:

AUBURN ANGARA

OAKS, LLC 14496 N SHELDON RD SUITE 230 PLYMOUTH, MI 48170 BRUCE MICHAEL (248) 703-4653

FOGS OAKS


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ORIGINAL ISSUE DATE: 05/19/2022

PROJECT NO: 22-051 SCALE: N/A 1/2"

FIELD: REICHERT DRAWN BY: MN DESIGN BY: KM CHECK BY: AP

(POCKET PENETROMETER)

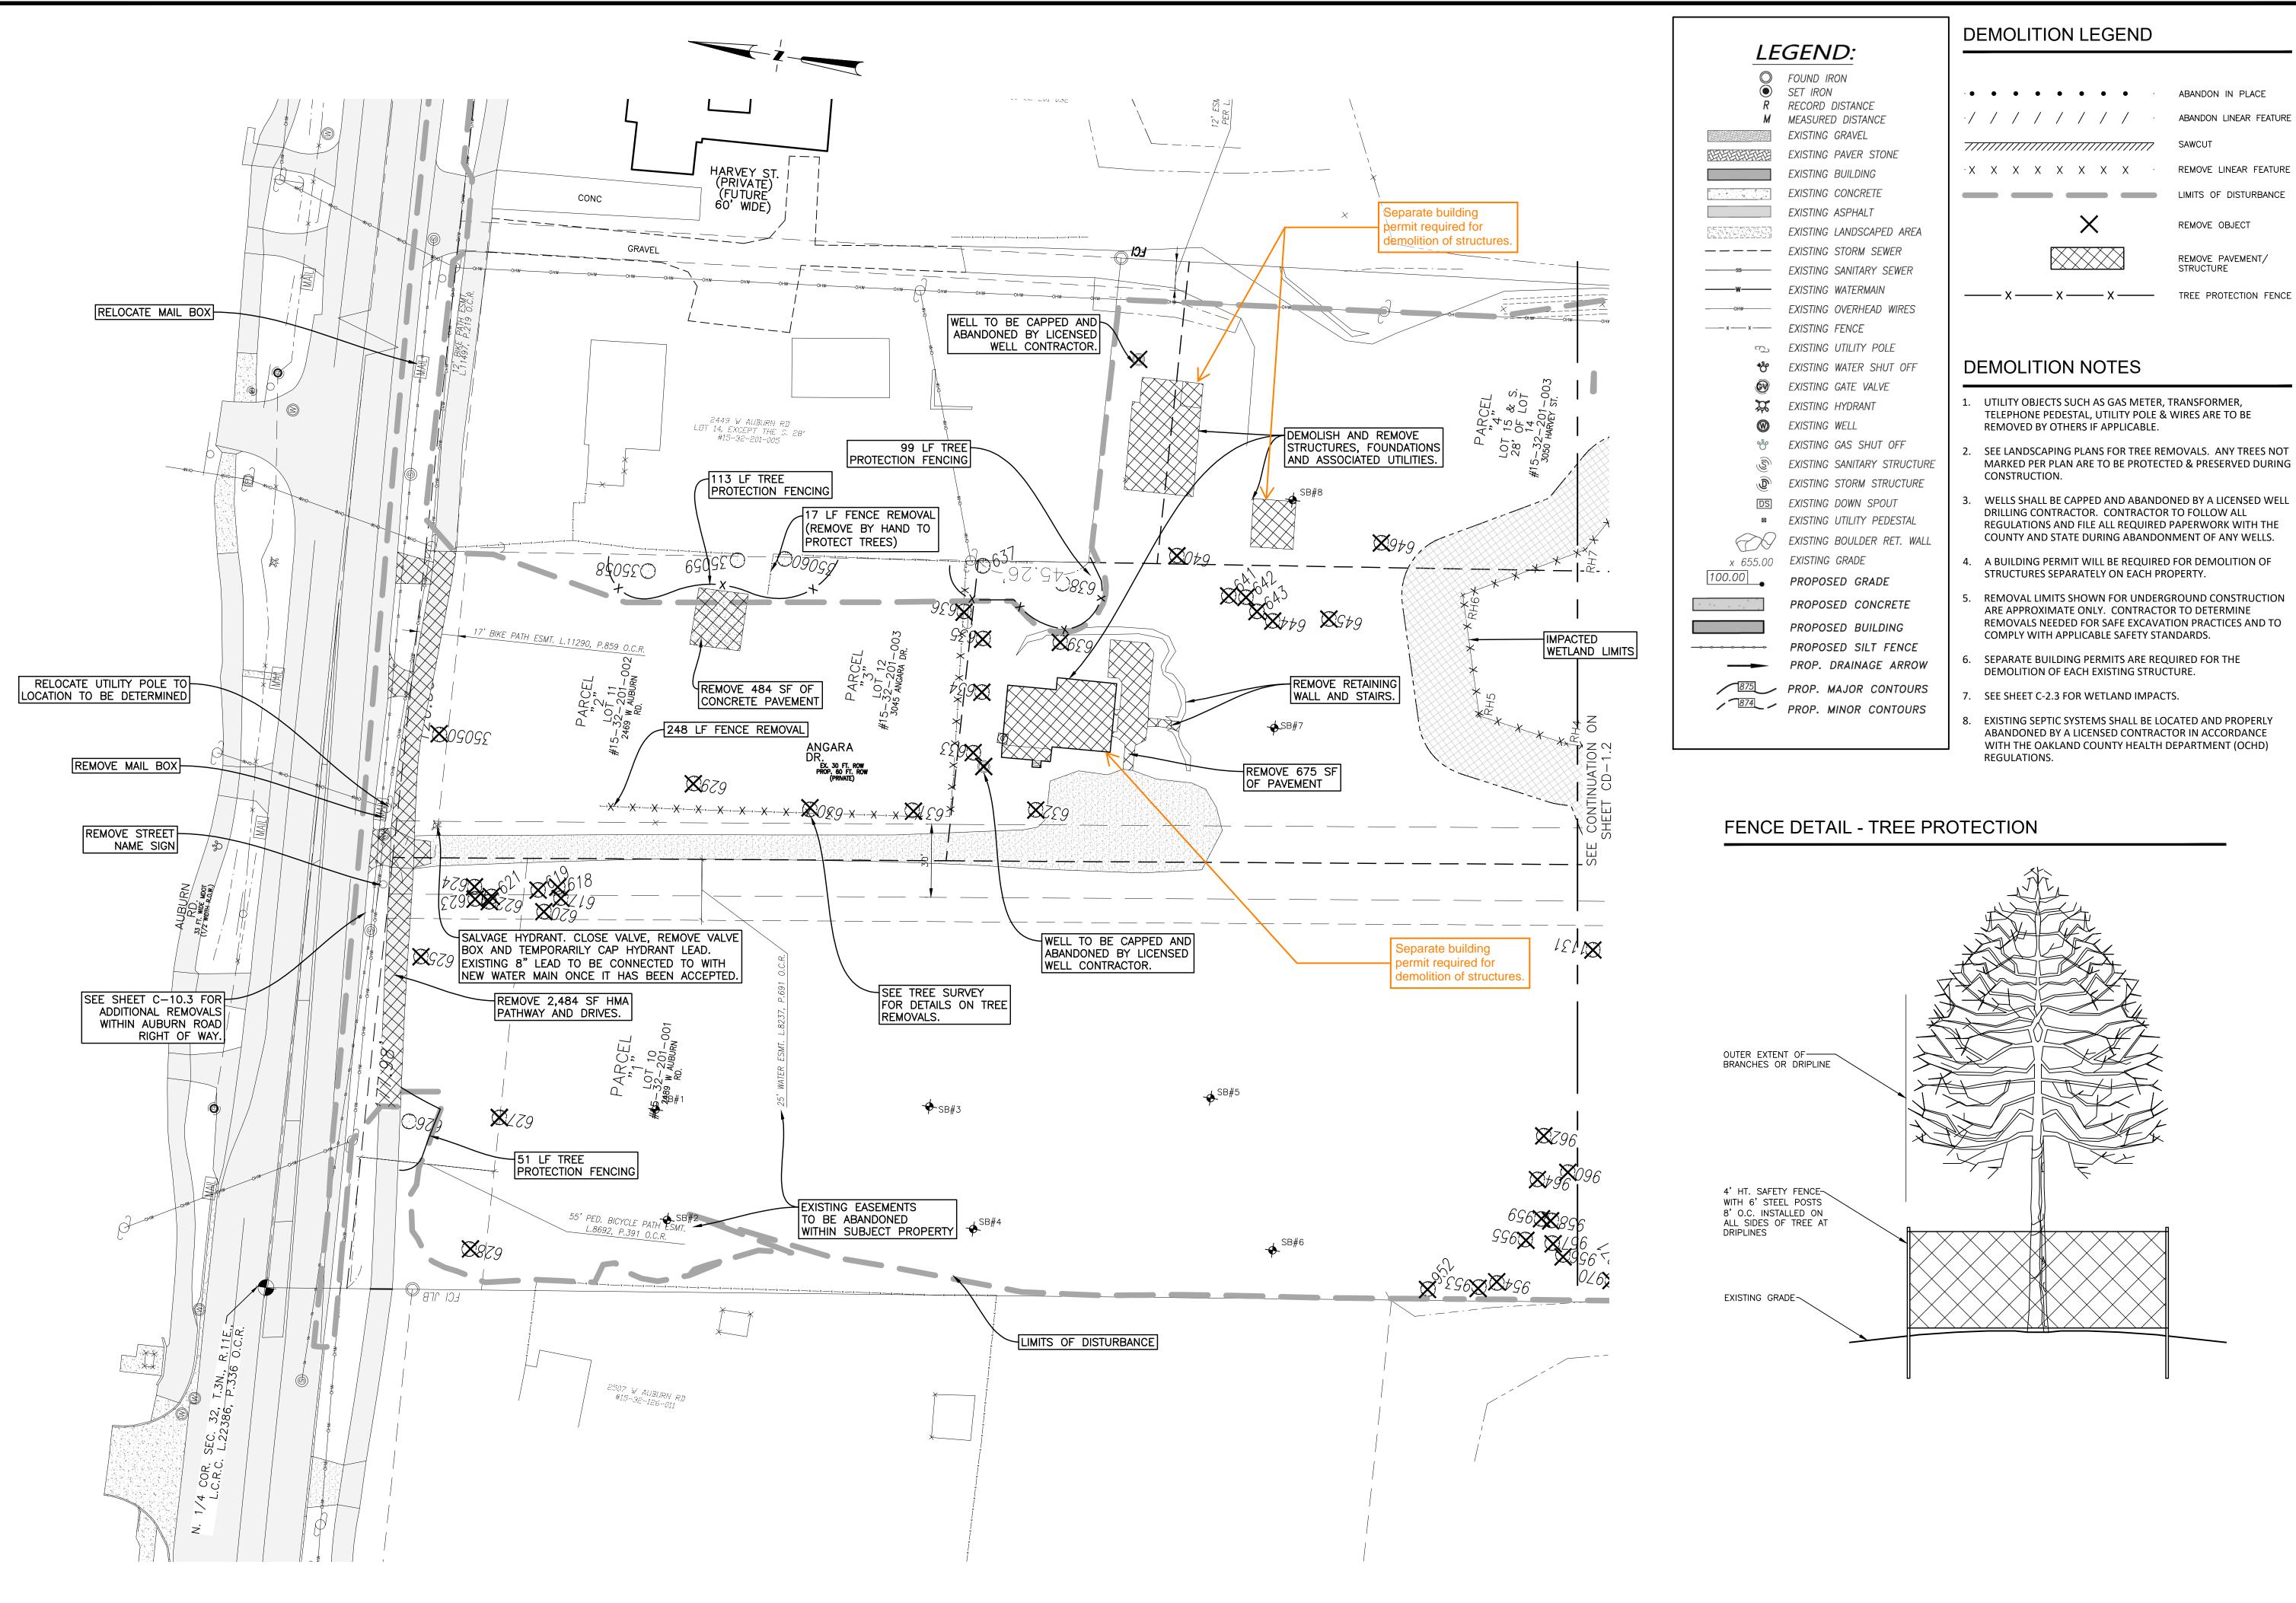

ABANDON IN PLACE ABANDON LINEAR FEATURE

- MARKED PER PLAN ARE TO BE PROTECTED & PRESERVED DURING
- REGULATIONS AND FILE ALL REQUIRED PAPERWORK WITH THE COUNTY AND STATE DURING ABANDONMENT OF ANY WELLS.
- REMOVALS NEEDED FOR SAFE EXCAVATION PRACTICES AND TO
- ABANDONED BY A LICENSED CONTRACTOR IN ACCORDANCE WITH THE OAKLAND COUNTY HEALTH DEPARTMENT (OCHD)

INNOVATIVE GEOSPATIAL & ENGINEERING SOLUTIONS ing Group 298 VETERANS DRIVE FOWLERVILLE, MICHIGAN 48836 (OFFICE) 517-223-3512 MONUMENTENGINEERING.COM ERVICE DISABLED VETERAN OWNE SMALL BUSINESS (SDVOSB)

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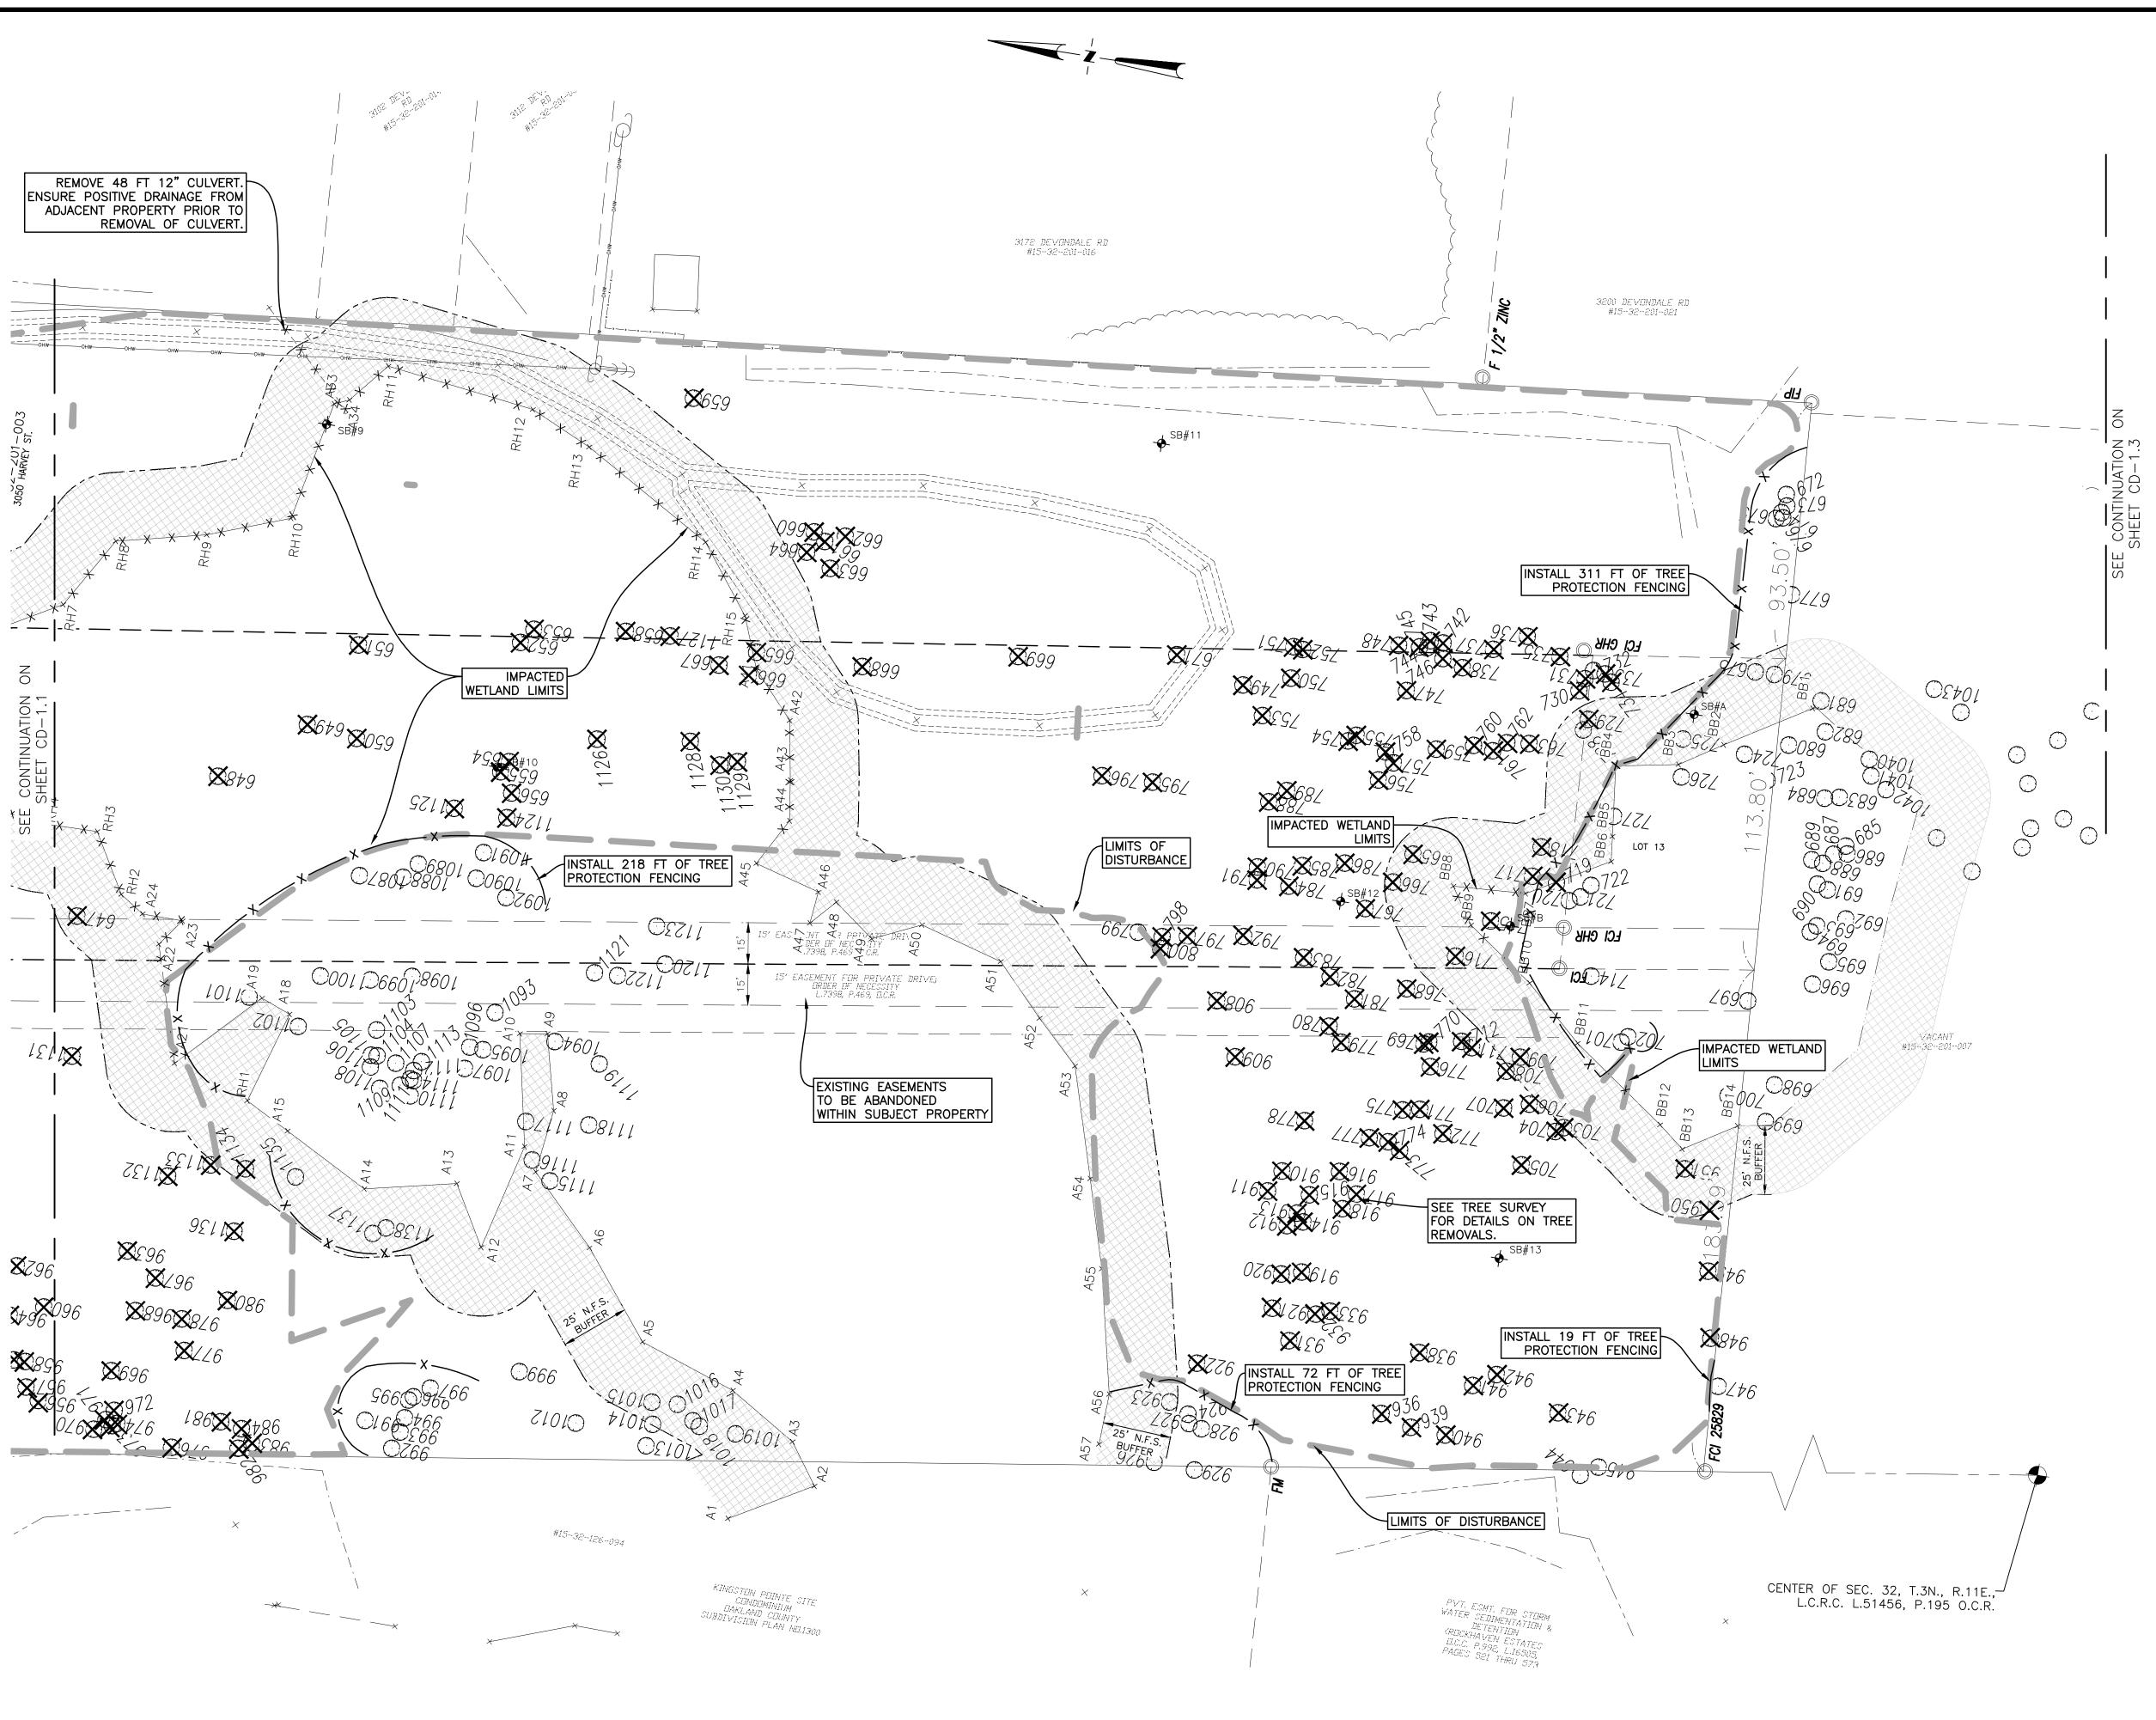
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ORIGINAL ISSUE DATE: 05/19/2022

PROJECT NO: 22-051 SCALE: 1" = 30'

FIELD: REICHERT DRAWN BY: MN DESIGN BY: KM CHECK BY: AP



DEMOLITION LEGEND

. ABANDON IN PLACE ABANDON LINEAR FEATURE REMOVE LINEAR FEATURE \cdot X X X X X X X X LIMITS OF DISTURBANCE REMOVE OBJECT WETLAND IMPACT TREE PROTECTION FENCE

DEMOLITION NOTES

- 1. UTILITY OBJECTS SUCH AS GAS METER, TRANSFORMER, TELEPHONE PEDESTAL, UTILITY POLE & WIRES ARE TO BE REMOVED BY OTHERS IF APPLICABLE.
- SEE SHEET LS-1 FOR TREE REMOVALS. ANY TREES NOT MARKED PER PLAN ARE TO BE PROTECTED & PRESERVED DURING CONSTRUCTION.
- WETLAND AREAS THAT ARE NOT SHOWN TO BE IMPACTED ARE TO BE PROTECTED FROM ANY DAMAGE. INSTALL SILT FENCE PRIOR TO ANY OTHER WORK ADJACENT TO THE WETLAND.
- 4. REMOVAL LIMITS SHOWN FOR UNDERGROUND CONSTRUCTION ARE APPROXIMATE ONLY. CONTRACTOR TO DETERMINE REMOVALS NEEDED FOR SAFE EXCAVATION PRACTICES AND TO COMPLY WITH APPLICABLE SAFETY STANDARDS.
- 5. SEE SHEET C-2.3 FOR WETLAND IMPACTS.

LEGEND:

EXISTING PAVER STONE

EXISTING SANITARY STRUCTURE

PROPOSED GRADE

PROPOSED CONCRETE

PROPOSED BUILDING PROPOSED SILT FENCE

EXISTING BUILDING

O FOUND IRON SET IRON R RECORD DISTANCE **M** MEASURED DISTANCE EXISTING GRAVEL EXISTING CONCRETE EXISTING LANDSCAPED AREA ———— EXISTING STORM SEWER EXISTING SANITARY SEWER ——w—— EXISTING WATERMAIN -----OHW EXISTING OVERHEAD WIRES ----×--- EXISTING FENCE D EXISTING UTILITY POLE * EXISTING WATER SHUT OFF EXISTING GATE VALVE EXISTING HYDRANT EXISTING WELL EXISTING GAS SHUT OFF EXISTING STORM STRUCTURE DS EXISTING DOWN SPOUT EXISTING UTILITY PEDESTAL EXISTING BOULDER RET. WALL x 655.00 EXISTING GRADE

> PROP. DRAINAGE ARROW PROP. MAJOR CONTOURS PROP. MINOR CONTOURS

ORIGINAL ISSUE DATE: 05/19/2022

PROJECT NO: 22-051

SCALE: 1" = 30'

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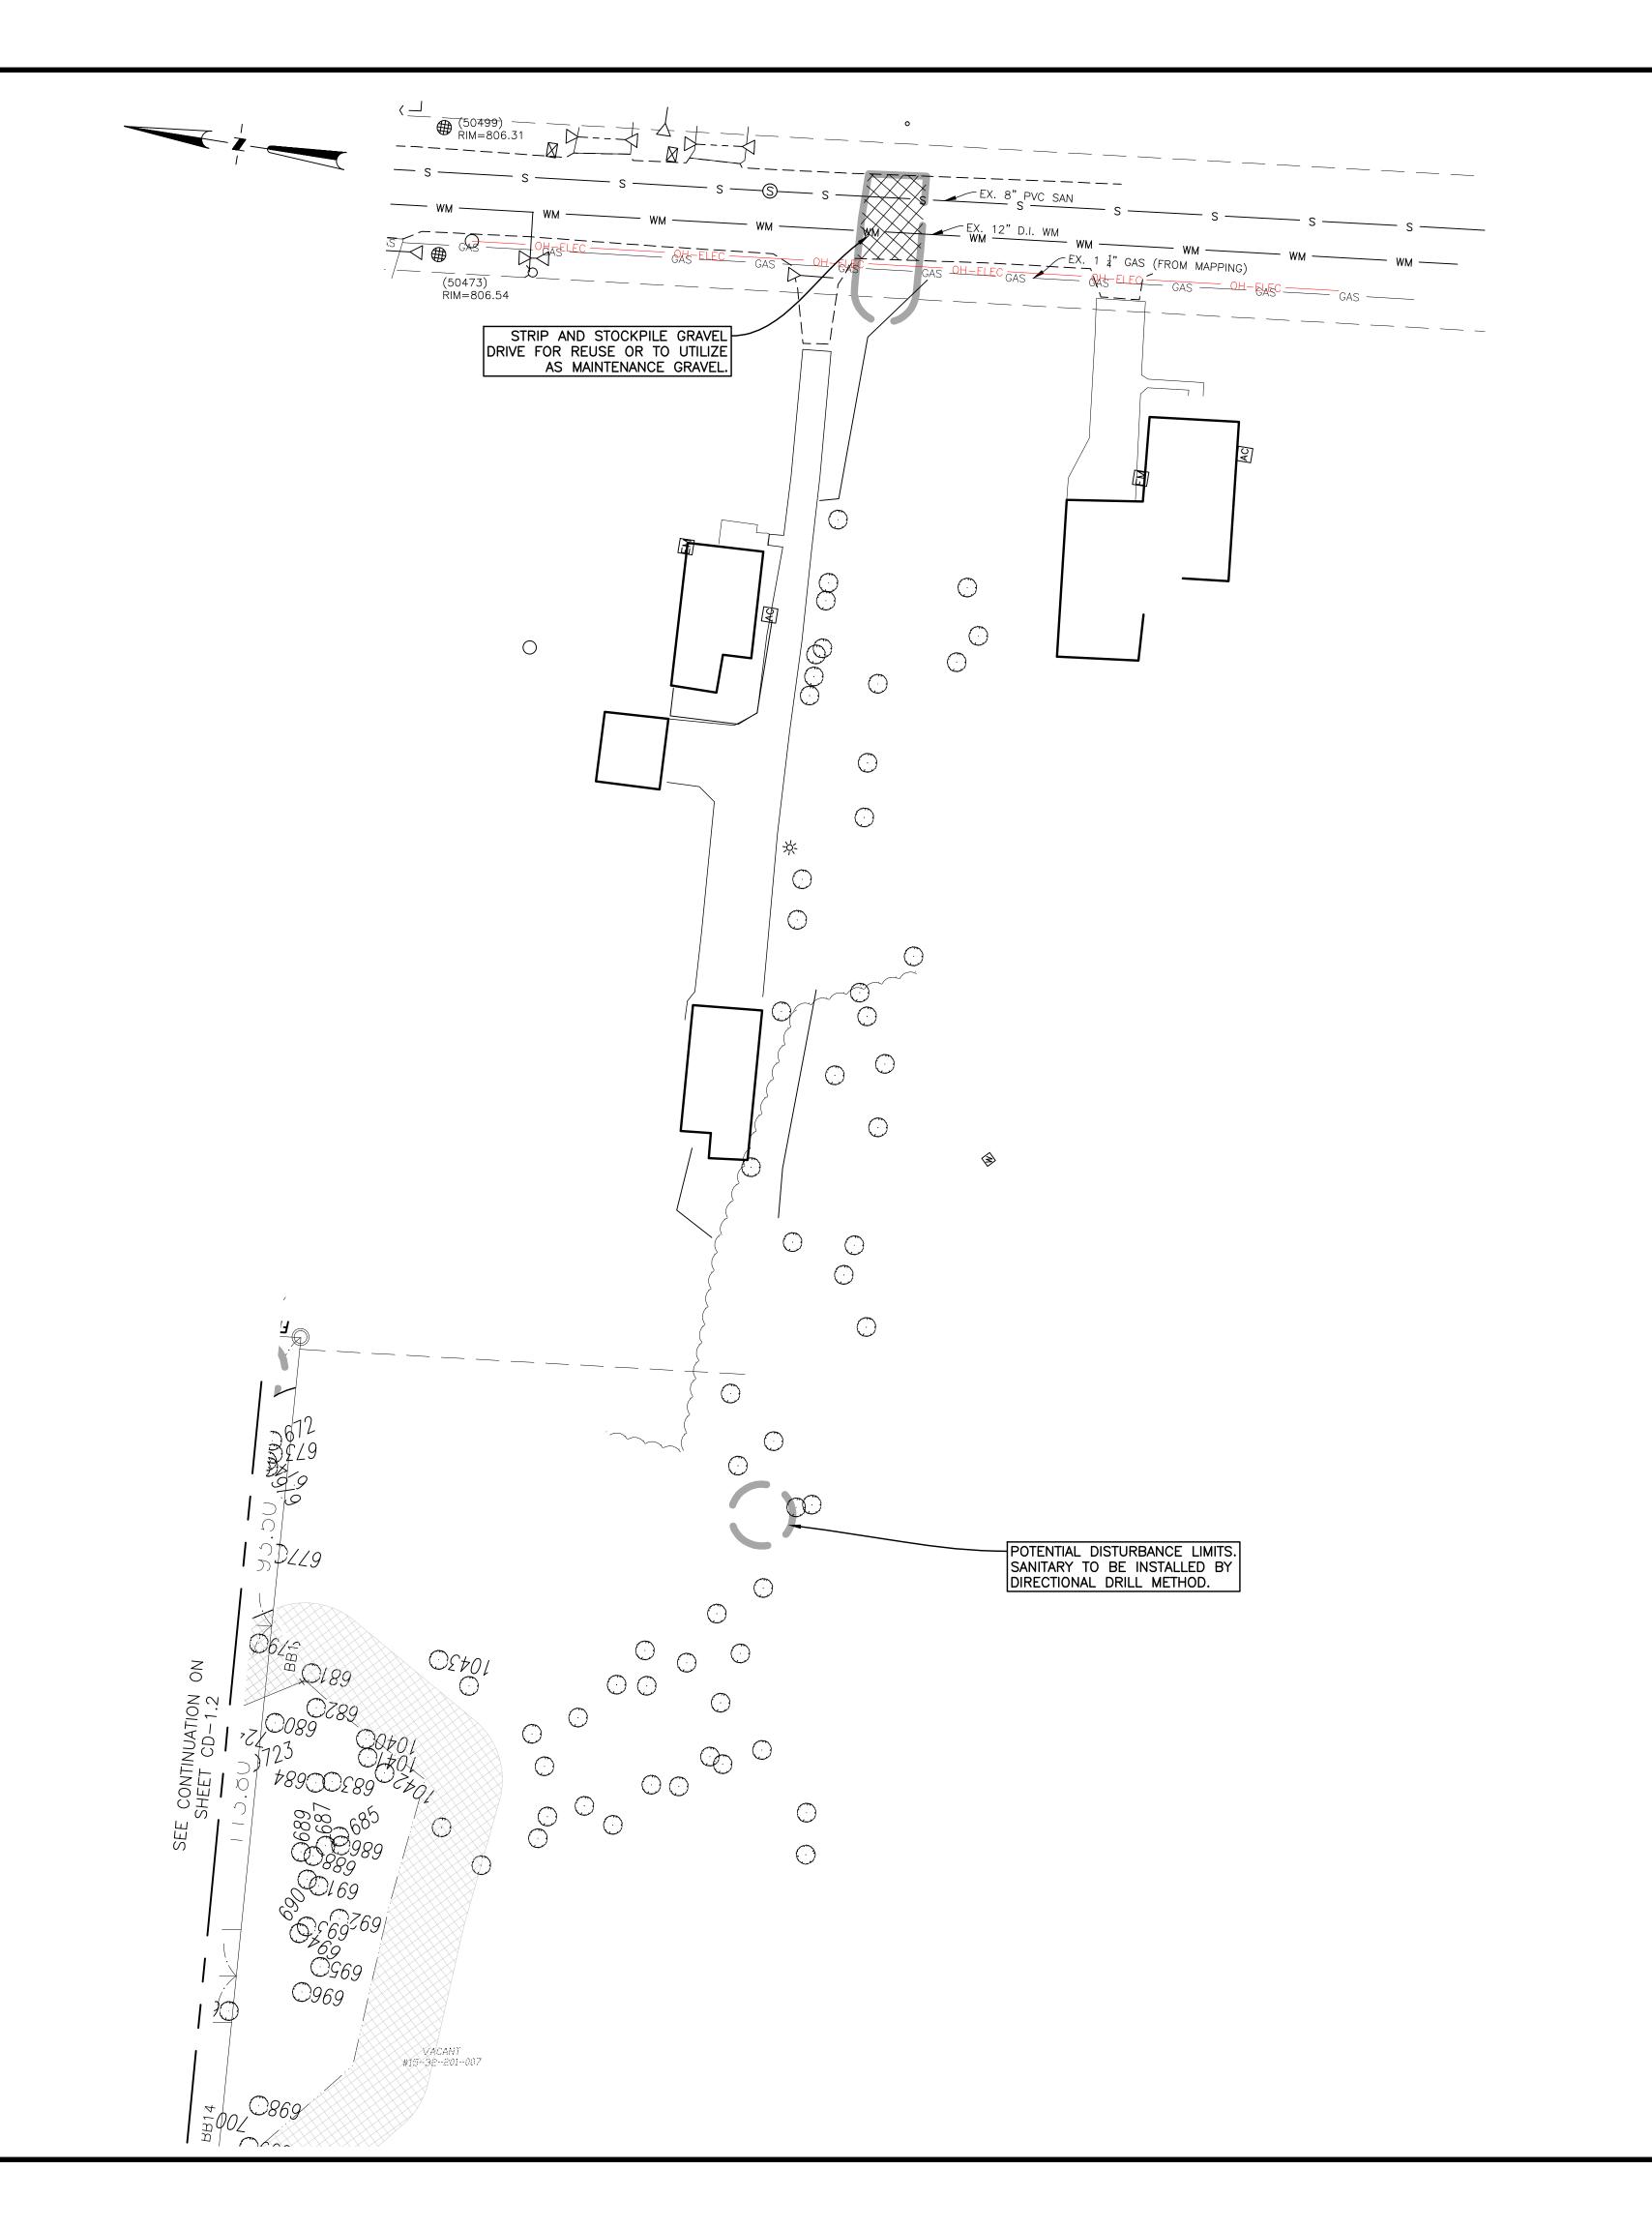
AUBURN

FIELD: REICHERT DRAWN BY: MN DESIGN BY: KM CHECK BY: AP

NOTE: WETLAND A DRAINS TO WETLAND B, WHICH IS HYDRAULICALLY CONNECTED TO A LARGER WETLAND COMPLEX THAT EXTENDS OFF SITE TO THE SOUTH.

> SEE SHEET C-2.2 (WETLAND PLAN) FOR DETAILS OF DISTURBANCE TO WETLANDS AND NATURAL FEATURE SETBACKS.

FILE:P:\Projects\2022\22-051 Auburn Angara Sub\Dwg\Engineering\22-051_CD-1.0_Demo.dwg PLOT DATE:8/20/2025 10:08 AM



DEMOLITION LEGEND

. ABANDON IN PLACE ABANDON LINEAR FEATURE REMOVE LINEAR FEATURE \cdot X X X X X X X \cdot LIMITS OF DISTURBANCE REMOVE OBJECT REMOVE PAVEMENT

TREE PROTECTION FENCE

DEMOLITION NOTES

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LEGEND:

igotimes FOUND IRON

EXISTING GRAVEL

EXISTING LANDSCAPED AREA

ന്ച EXISTING UTILITY POLE

EXISTING GATE VALVE

EXISTING HYDRANT

W EXISTING WELL

x 655.00 EXISTING GRADE 100.00 PROPOSED GRADE

* EXISTING WATER SHUT OFF

* EXISTING GAS SHUT OFF

DS EXISTING DOWN SPOUT EXISTING UTILITY PEDESTAL

EXISTING BOULDER RET. WALL

EXISTING SANITARY STRUCTURE

PROPOSED CONCRETE

PROPOSED BUILDING

PROP. DRAINAGE ARROW

PROP. MAJOR CONTOURS

PROP. MINOR CONTOURS

PROPOSED SILT FENCE

© EXISTING STORM STRUCTURE

———— EXISTING STORM SEWER EXISTING SANITARY SEWER

----×--- EXISTING FENCE

R RECORD DISTANCE **M** MEASURED DISTANCE

EXISTING PAVER STONE

EXISTING BUILDING EXISTING CONCRETE EXISTING ASPHALT

SET IRON

ing Group

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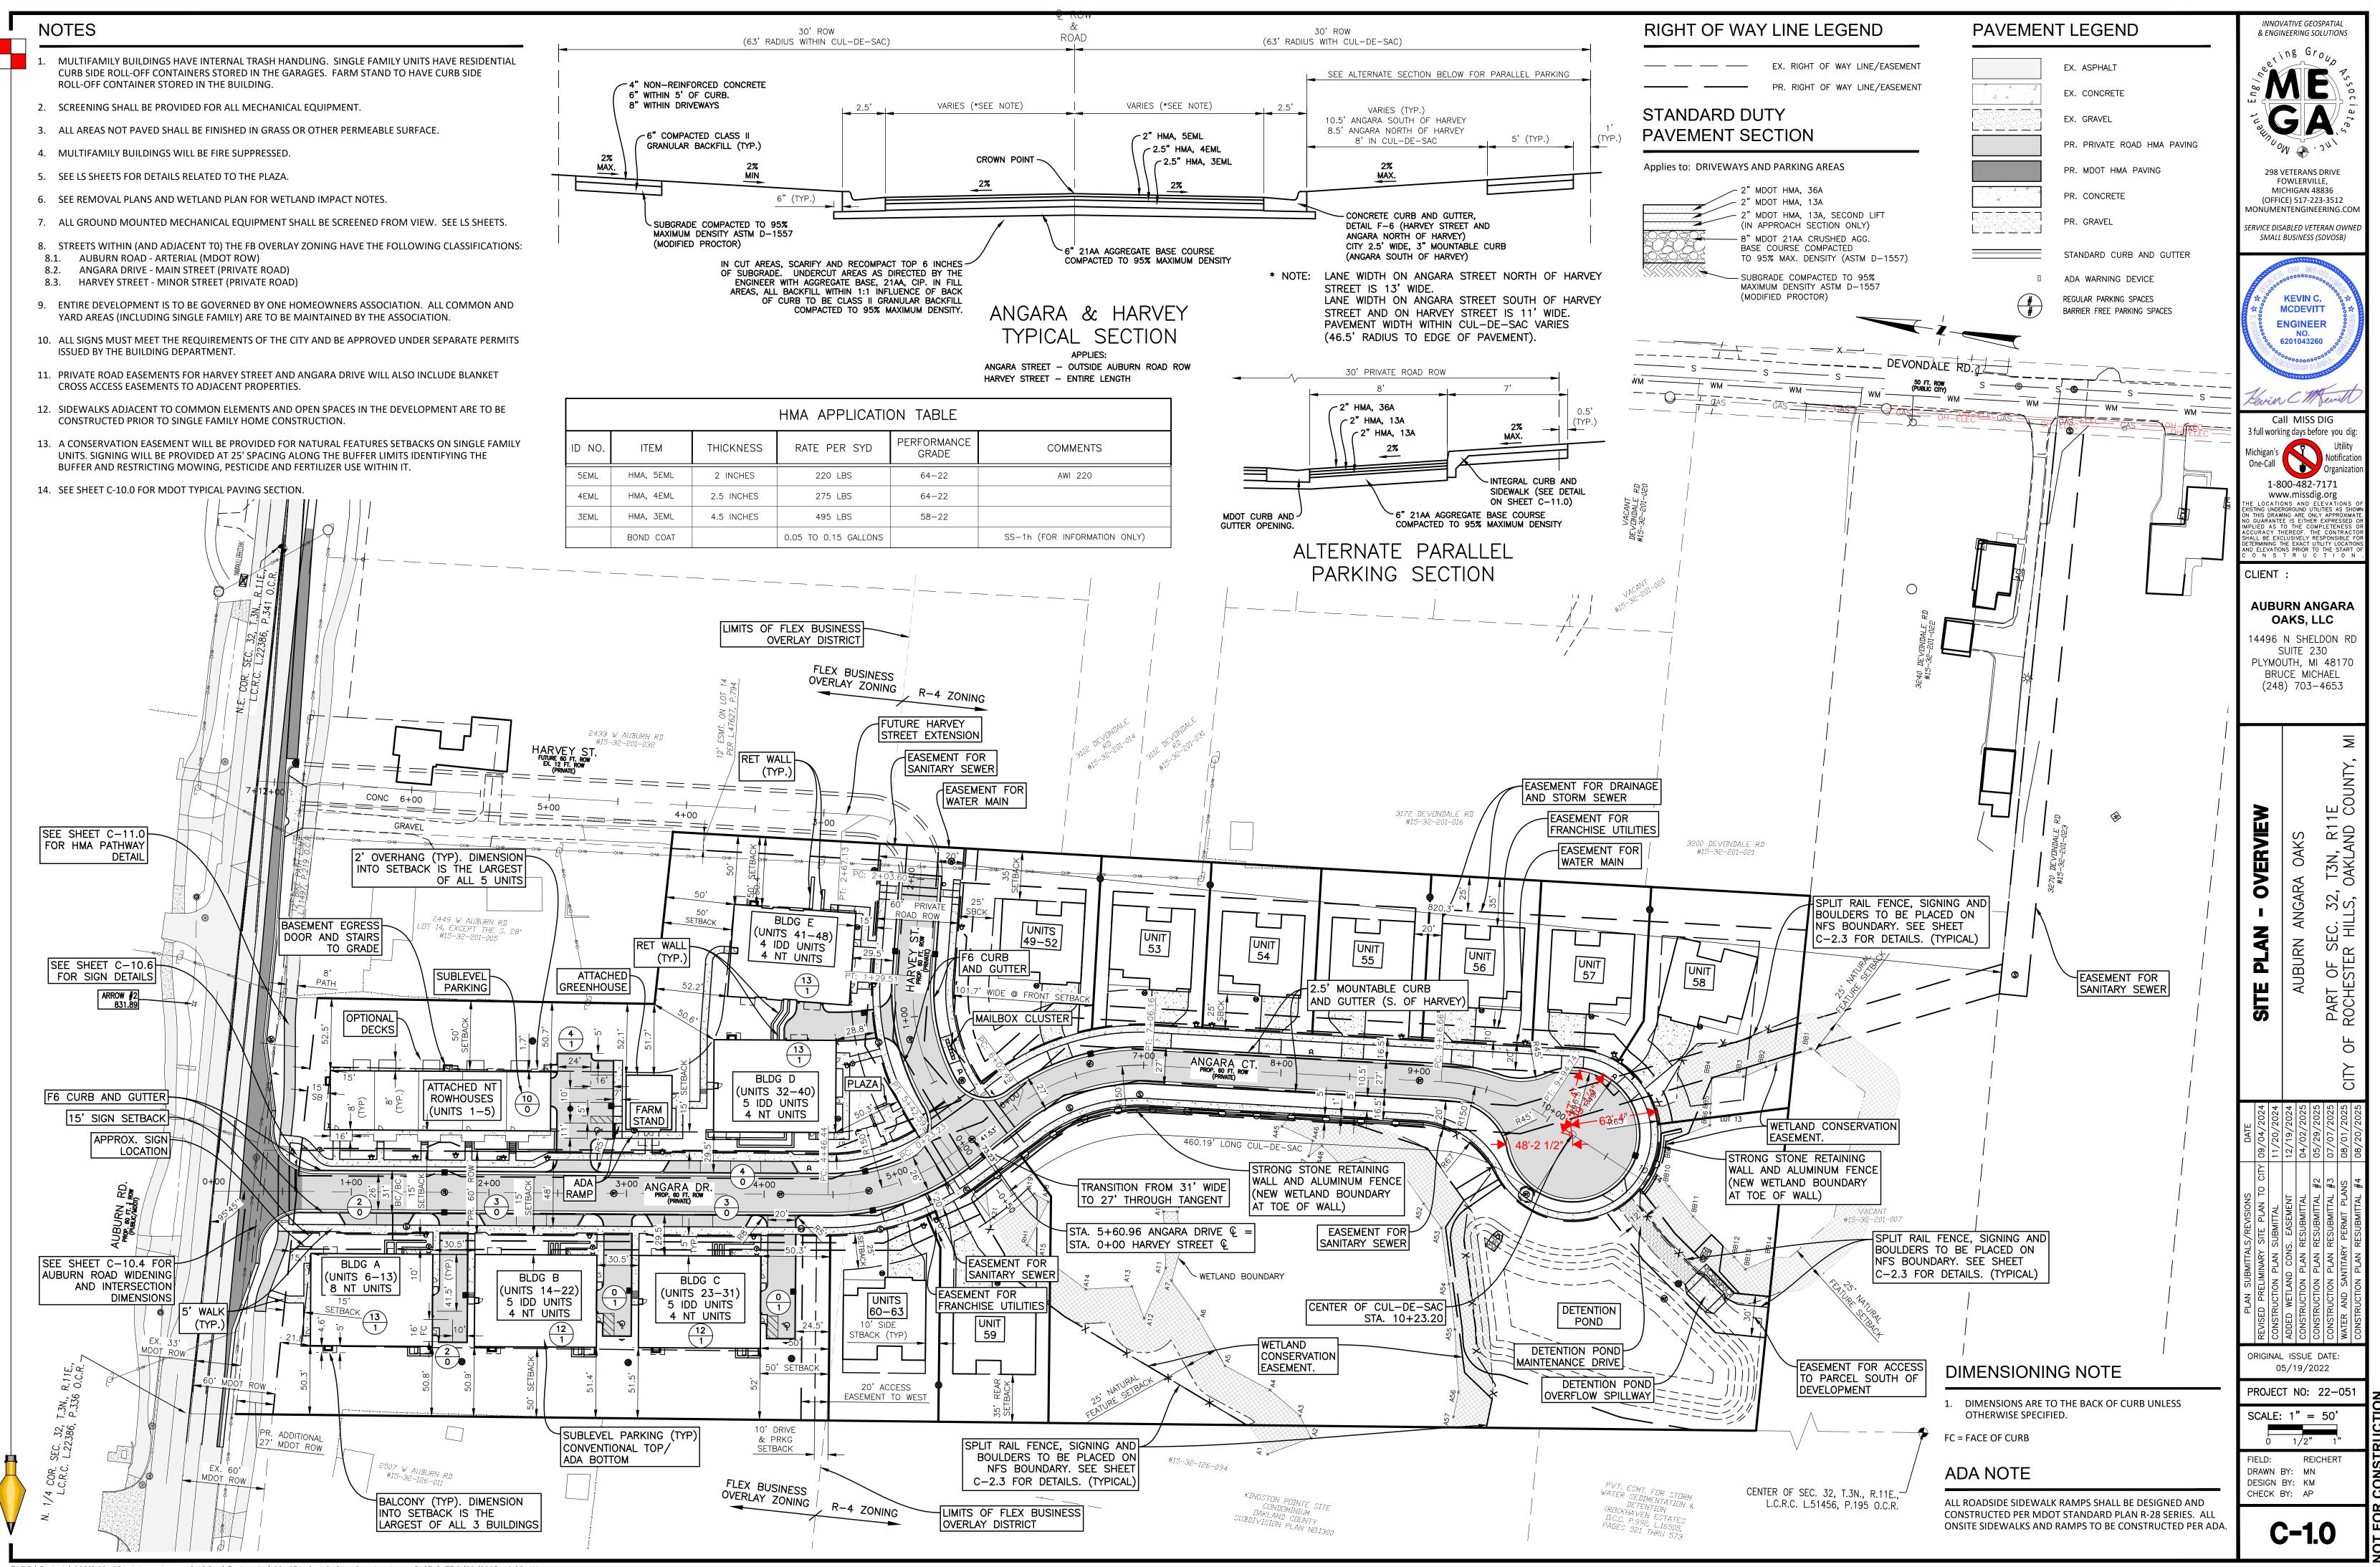
ORIGINAL ISSUE DATE: 05/19/2022

PROJECT NO: 22-051 SCALE: 1" = 30'

FIELD: REICHERT

DRAWN BY: MN DESIGN BY: KM CHECK BY: AP

CD-1.3



ZONING INFORMATION

THIS ZONING INFORMATION IS TAKEN FROM ROCHESTER HILLS ZONING ORDINANCE DATED: 02/14/2024 (INCL FB OVERLAY ORDINANCE)

SUBJECT PARCEL ZONING:	SUBJECT	PARCEL		OSED DING	MAXIMUM OF BU	I HEIGHT IILDING	Bl	JILDING SE	ETBACKS (FT	-)	PARKINO	SETBAC	KS (FT)
FB FLEX BUSINESS OVERLAY	AREA (AC)	WIDTH AT BUILDING SITE (FT)	BLDG A,B,C AREA (SF)	BLDG D,E AREA (SF)	IN STORIES	IN FEET	FRONT (MIN/MAX)	SIDE (INTERIOR)	SIDE (PERIMETER) (1)	REAR	FRONT FACADE	SIDE (2)	REAR (2)
REQUIRED	2	N/A	N/A	N/A	2 / 3	30 / 45	15 / 70	0	25 (50' ADJACENT TO RESIDENTIAL	50	40	10	10
PROVIDED	9.03	-	-	_	2	-	15 / 46.6	N/A	-	50	41.5	24.5	57.6

1. SETBACK LISTED FOR 2 STORY BUILDINGS UNDER 30 FEET TALL.

2. SETBACK FROM RESIDENTIAL ZONING DISTRICTS ONLY.

SUBJECT PARCEL ZONING:	SUBJECT	PARCEL	MAXIMUM OF BU	I HEIGHT JILDING	BU	JILDING SE	ETBACKS (F	Т)	MAXIMUM % LOT AREA	MINIMUM FLOOR
R-4 RESIDENTIAL	AREA (SF)	WIDTH AT BUILDING SITE (FT)	IN STORIES	IN FEET	FRONT (MIN/MAX)	SIDE (EACH)	SIDE (TOTAL)	REAR	COVERED BY ALL BUILDINGS	AREA (SF)
REQUIRED	9,600	80 FEET	2	30	25	10	20	35	30%	912
PROVIDED	9,600	80 FEET	1	N/A	25	10	20	35	30%	2,033


ADJACENT ZONING


R-4 ONE-FAMILY RESIDENTIAL R-4 ONE-FAMILY RESIDENTIAL R-4 ONE-FAMILY RESIDENTIAL

STRIPING DETAILS

CROSSWALK S	TRI	PIN	G DI	MEN	ISIC)NS	TAB	LE
CROSSWALK	И	/1	W2*		T		d	
TYPE	Min.	Max,	Min.	Max.	Min.	Max.	Min.	Max.
Transverse					6"	24"		
Longitudinal Bar	12"	24"	12"	60"				
Longitudinal Bar Pair	8"	12"	24"	60"			8"	12"
Ladder	12"	24"	12"	60"	6"	24"		
Transverse Diagonal	12"	24"	12"	60"	6"	24"		

* Ensure lateral spacing W2 does not exceed 2.5 times the width of longitudinal bars.

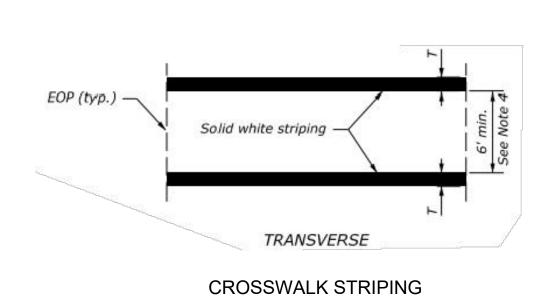

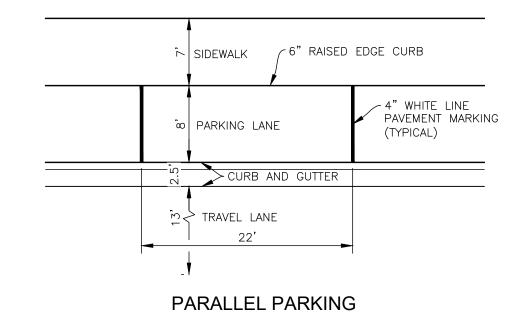

PROPOSED USE

MULTIFAMILY

SEE UNIT COUNT TABLE FOR DISTRIBUTION OF NEUROTYPICAL (NT) AND INTELECTUALLY AND DEVELOPMENTALLY DISABLED (IDD)

ATTACHED ROWHOUSES (UNITS 1-5): CONDOS AGE TARGETED FOR ACTIVE ADULTS (AGE 45-74) (NT)

SINGLE FAMILY

RANCH TOWNHOMES: 7 SINGLE FAMILY HOMES (UNITS 53-59 ARE CONDOS AGE TARGETED TO ACTIVE ADULTS (AGE 45-75) (NT) 2 SINGLE FAMILY HOMES (UNITS 49 - 52 AND 60 - 63) ARE CONDOS WITH SUITES FOR IDD

PLACES OF INTEREST

1,329 SQ FT (GFA) COMMUNITY GARDEN / GREENHOUSE (NO SALES)

PLAZA W/ LANDSCAPE GARDENS AND BENCHES

SEE LANDSCAPE PLANS FOR MORE INFORMATION ON PLACES OF INTEREST

PROPOSED PARKING

REQUIRED PARKING NON-RESIDENTIAL (FARMSTAND): 1.0 PARKING SPACE PER 400 SFT 1329 SFT / 400 = 5 SPACES FARMSTAND =

MULTIFAMILY (SEE TABLE TO RIGHT FOR REQUIREMENTS) APARTMENTS/ROWHOUSES = 74 SPACES

MINIMUM REQUIRED PARKING = 79 SPACES MINIMUM

MIMINUM REQUIRED FOR VISITORS = 0.5 PER MULTIFAMILY NT UNIT = 12 SPACES (INCLUDED IN ABOVE)

MAXIMUM PARKING = 1.25 X MIN PARKING = 99 SPACES MAXIMUM

PARKING PROVIDED:

RESIDENT PARKING (INSIDE BUILDINGS) PARKING ON MULTIFAMILY SUBLEVELS =

73 STANARD SPACES 5 BARRIER FREE SPACES

RESIDENT/VISITOR PARKING SPACES (OUTSIDE BUILDINGS) BARRIER FREE PARKING = 3 SPACES STANDARD SPACES IN BUILDING A DRIVE = 2 SPACES STANDARD SPACES IN LOT AT ROWHOUSES = 4 SPACES PARALLEL PARKING ON STREET = 12SPACES

TOTAL PARKING PROVIDED = 91 STANDARD SPACES

> NOTE: SINGLE FAMILY DETACHED HOMES EACH HAVE 2 CAR GARAGES AND SPACE FOR 2+ VEHICLES IN DRIVEWAY.

8 BARRIER FREE (ALL VAN ACCESSIBLE)

UNIT COUNT / TYPE / PARKING

MULTIF	AMILY U	JNIIS		PARKING	
BLDG/UNIT#	UNIT TYPE	BLDG	IDD8 SPACES PER UNIT	NT - 1.5 PER UNIT + .5 VISITOR	REQUIRE SPACES
1	NT	ROWHOUSE		2	2
2	NT	ROWHOUSE		2	2
3	NT	ROWHOUSE		2	2
4	NT	ROWHOUSE		2	2
5	NT	ROWHOUSE		2	2
Bldg A-6	NT	Α		2	2
Bldg A-7	NT	Α		2	2
Bldg A-8	NT	Α		2	2
Bldg A-9	NT	Α		2	2
Bldg A-10	NT	Α		2	2
Bldg A-11	NT	Α		2	2
Bldg A-12	NT	Α		2	2
Bldg A-13	NT	Α		2	2
Bldg B-14	IDD	В	0.8		0.8
Bldg B-15	IDD	В	0.8		0.8
Bldg B-16	IDD	В	0.8		0.8
Bldg B-17	IDD	В	0.8		0.8
Bldg B-18	IDD	В	0.8		0.8
Bldg B-19	NT	В		2	2
Bldg B-20	NT	В		2	2
Bldg B-21	NT	В		2	2
Bldg B-22	NT	В		2	2
Bldg C-23	IDD	С	0.8		0.8
Bldg C-24	IDD	С	0.8		0.8
Bldg C-25	IDD	С	0.8		0.8
Bldg C-26	IDD	С	0.8		0.8
Bldg C-27	IDD	С	0.8		0.8
Bldg C-28	NT	С		2	2
Bldg C-29	NT	С		2	2
Bldg C-30	NT	С		2	2
Bldg C-31	NT	С		2	2
Bldg D-32	IDD	D	0.8	_	0.8
Bldg D-33	IDD	D	0.8		0.8
Bldg D-34	IDD	D	0.8		0.8
Bldg D-35	IDD	D	0.8		0.8
Bldg D-36	IDD	D	0.8		0.8
Bldg D-37	NT	D		2	2
Bldg D-38	NT	D		2	2
Bldg D-39	NT	D		2	2
Bldg D-20	NT	D		2	2
Bldg E-41	IDD	E	0.8	_	0.8
Bldg E-42	IDD	E	0.8		0.8
Bldg E-43	IDD	E	0.8		0.8
Bldg E-44	IDD	E	0.8		0.8
Bldg E-44	NT	E	0.0	2	2
Bldg E-45	NT	E		2	2
Bldg E-40	NT	E		2	2
Bldg E-47	NT	E		2	2
DIUE L-40	1 141	_			۷

			SINGLE FAMILY U	NITS		
UNIT#	UNIT TYPE	GRADE	FLOOR PLAN	LOT WIDTH (FT)	LOT DEPTH (FT)	LOT AREA (SFT)
Unit 49-52	IDD	Flat	Michigan (MI)	101.7	123.9	14,549
Unit 53	ТИ	Daylight	Michigan (MI)	80	120	9,649
Unit 54	NT	Daylight	Michigan (MI)	80	120	9,600
Unit 55	NT	Daylight	Michigan (MI)	80	120	9,600
Unit 56	NT	Daylight	Michigan (MI)	80	120	9,600
Unit 57	NT	Daylight	Michigan (MI)	80	120	9,554
Unit 58	NT	Daylight	Michigan (MI)	111.2	154.9	18,483
Unit 59	NT	Flat	Michigan (MI)	80	154	14,058
Unit 60-63	IDD	Flat	Michigan (MI)	80	134.2	11,140
		TOTAL SING	LE FAMILY UNITS =	9		

UNIT TYPES

NT = NEURO-TYPICAL

IDD = INTELLECUTALLY/DEVELOPMENTALLY DISABLED

TRIP GENERATION - ITE 10TH EDITION

ITE (10TH EDITION) TRIP GENERATION

Project No.: 21-051	Date: _	1/12/2024
Project Name: Angara Drive Senior Living Development	Calculated by:	Kevin C. McDevitt, P.I

Single Family

91 REGULAR SPACES

8 BARRIER FREE SPACES

Land Use	ITE Code	TE Code A mount		ITE 10t	h Edition - I	Per Unit	Avei	age Daily T	raffic	AM Peak Hour		P	PM Peak Hour		
Land Ose	TTE Code	Amount	Units	ADT	a.m. Peak	p.m. Peak	In (50%)	Out (50%)	Total	In (33%)	Out (67%)	Total	In (61%)	Out (39%)	Total
Senior Adult Housing - Detached	251	9	Dwellings	4.27	0.24	0.3	19	19	38	0.7	1.5	2.2	1.6	1.1	2.7

Multi Family - Intellectually/Developmentally Disabled

ADT a.m. Peak p.m. Peak In (50%) Out (50%) Total In (33%) Out (67%) Total In (61%) Out (39%) Total		Land Use	ITE Code	Amount	Units	HEIU	ın Eannon - J	Per Omi	Avei	age Dany 11	гатие	А	M Peak Hot	11.	F	W Peak Hot	11.
Continuing Care Retirement Community 255 19 Dwellings 2.4 0.14 0.16 23 23 46 0.9 1.8 2.7 1.8 1.2 3.0		Land Ose	TTE Code	Amount	Onits	ADT	a.m. Peak	p.m. Peak	In (50%)	Out (50%)	Total	In (33%)	Out (67%)	Total	In (61%)	Out (39%)	Total
	Cont	nuing Care Retirement Community	255	19	Dwellings	2.4	0.14	0.16	23	23	46	0.9	1.8	2.7	1.8	1.2	3.0

Multi Family - Neotraditional

Mixed Use Age Restricted Residential

ADT a.m. Peak p.m. Peak In (50%) Out (50%) Total In (33%) Out (67%) Total In (61%) Out (39%) Total	Land Use	ITE Code	Amount	I Inita	HEIOU	n Edition - I	er Unit	Aver	age Daily 11	rallic	Α	M Peak Ho	ur	P.	M Peak Hou	.r
Senior Adult Housing - Attached 252 29 Dwellings 3.7 0.2 0.26 54 54 107 1.9 3.9 5.8 4.6 2.9 7.5	Land Ose	TIE Code	Amount	Units	ADT	a.m. Peak	p.m. Peak	In (50%)	Out (50%)	Total	In (33%)	Out (67%)	Total	In (61%)	Out (39%)	Total
	Senior Adult Housing - Attached	252		Dwellings	3.7	0.2		54	54	107	1.9	3.9	5.8	4.6	2.9	7.5

Farm Stand - ITE 10th Ed. did not provide ADT Numbers - Assuming closed mid-day, open morning and afternoon so just added a.m. and p.m. peaks for ADT Average Daily Traffic ADT a.m. Peak p.m. Peak In (50%) Out (50%) Total In (33%) Out (67%) Total In (61%) Out (39%) Total

Farmers Market	858	0.0305	Acres	354.74	174.9	179.84	6	6	11	1.7	3.6	5.3	3.4	2.1	5.5
Total Development - Angara Drive Mixed Use Residential															
Total Development - Aligar	a Dilve Mixeu	OSC ICCSI	uciitiai												
								age Daily T							

Development - Angara Drive Mixed Use Residential														
Land Use						Average Daily Traffic			AM Peak Hour			PM Peak Hour		
							In (50%)	Out (50%)	Total	In (33%)	Out (67%)	Total	In (61%)	Out (39%)

DRAWN BY: MN DESIGN BY: KM

CHECK BY: AP

ORIGINAL ISSUE DATE: 05/19/2022

PROJECT NO: 22-051

REICHERT

SCALE: 1" = 50'

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MICHIGAN 48836

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> **KEVIN C. MCDEVITT**

ENGINEER

NO. 6201043260

Kevin CM Ferris

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DETERMINING THE EXACT UTILITY LOCATION
AND ELEVATIONS PRIOR TO THE START C
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AUBURN ANGARA

OAKS, LLC

14496 N SHELDON RD


SUITE 230

PLYMOUTH, MI 48170

BRUCE MICHAEL (248) 703-4653


CLIENT:

FIELD:

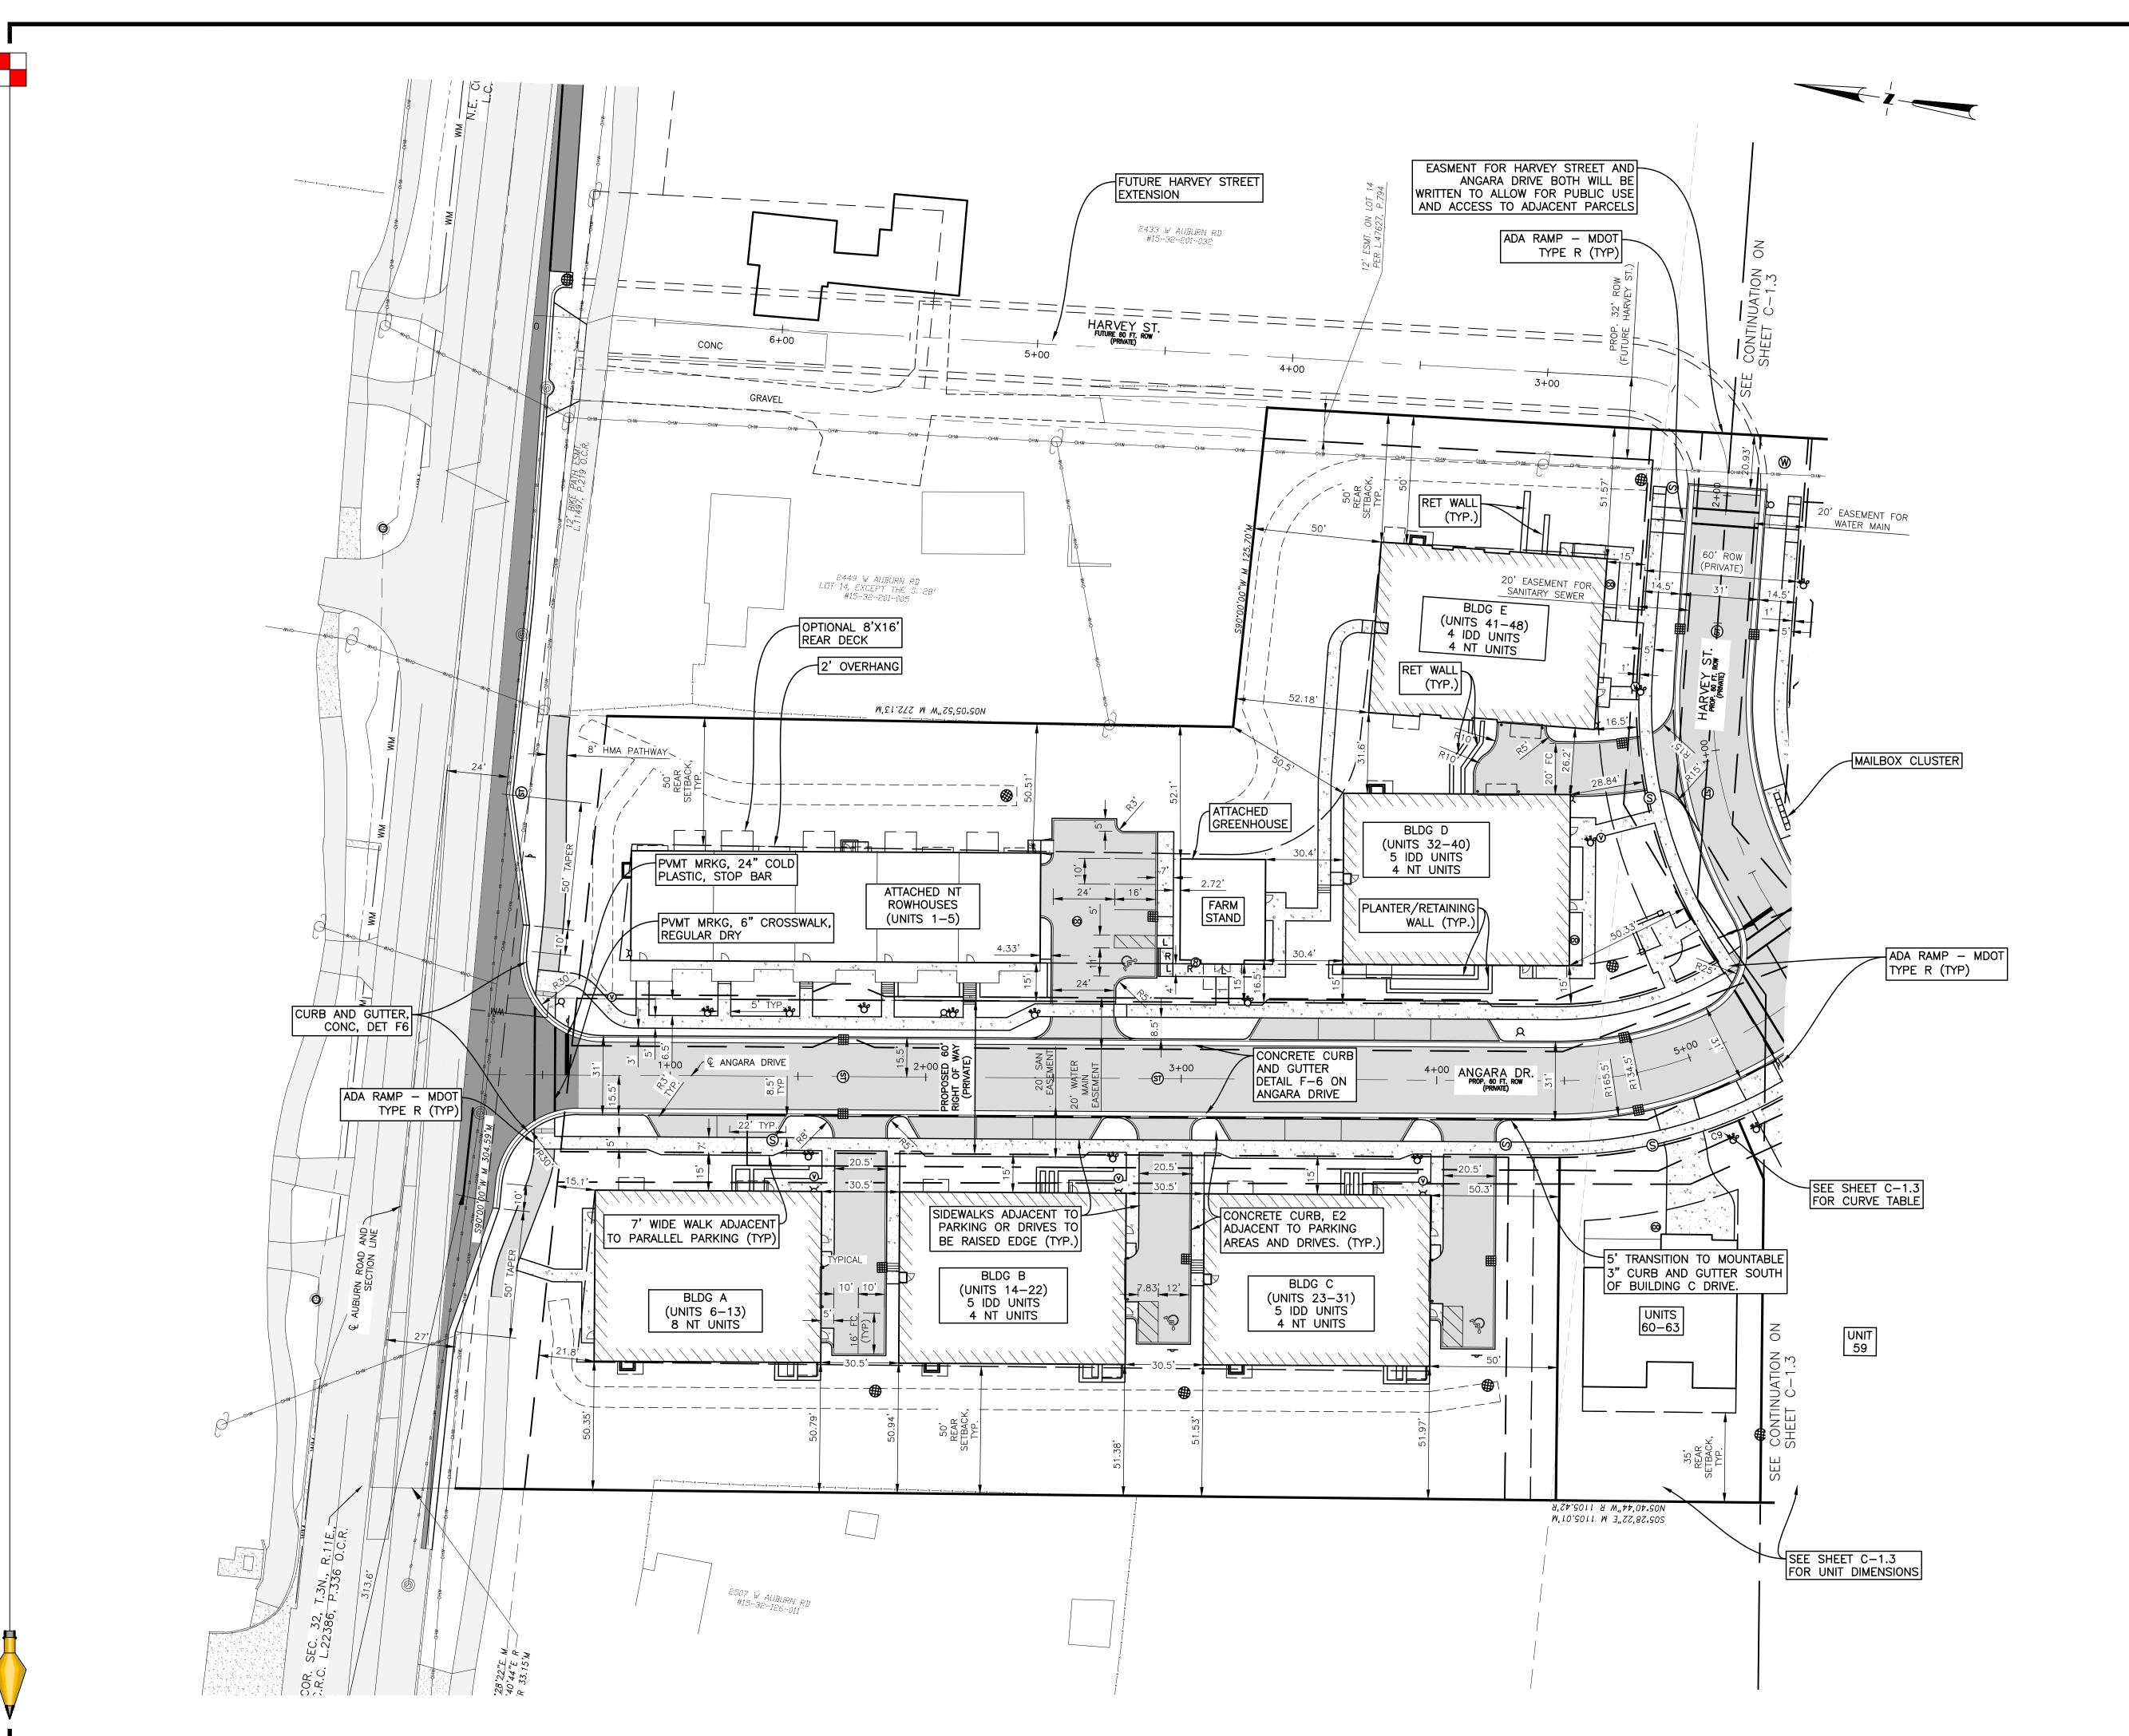

FILE:P:\Projects\2022\22-051 Auburn Angara Sub\Dwg\Engineering\22-051_C-1.2_Dim-Pav.dwg PLOT DATE:8/20/2025 10:09 AM

PAVEMENT LEGEND

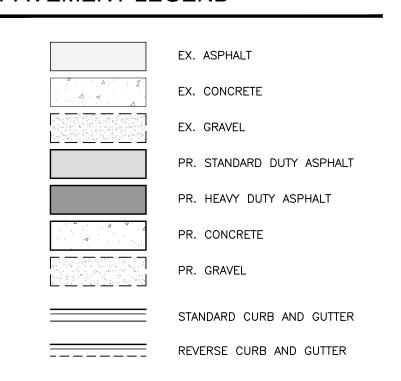

DIMENSIONING NOTE

1. DIMENSIONS ARE TO THE BACK OF CURB UNLESS OTHERWISE SPECIFIED.

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> KEVIN C. MCDEVITT ENGINEER NO. 6201043260

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> S R11E ND COUNTY MI

N ANGARA OAKS SEC. 32, T3N, R11E HILLS, OAKLAND C

PART OF SEC. 3
OF ROCHESTER HILLS

12/19/2024 04/02/2025 #2 05/29/2025 #3 07/07/2025 IS 08/01/2025 C

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TION PLAN RESUBMITTAL #2

TION PLAN RESUBMITTAL #3

TION PLAN RESUBMITTAL #3

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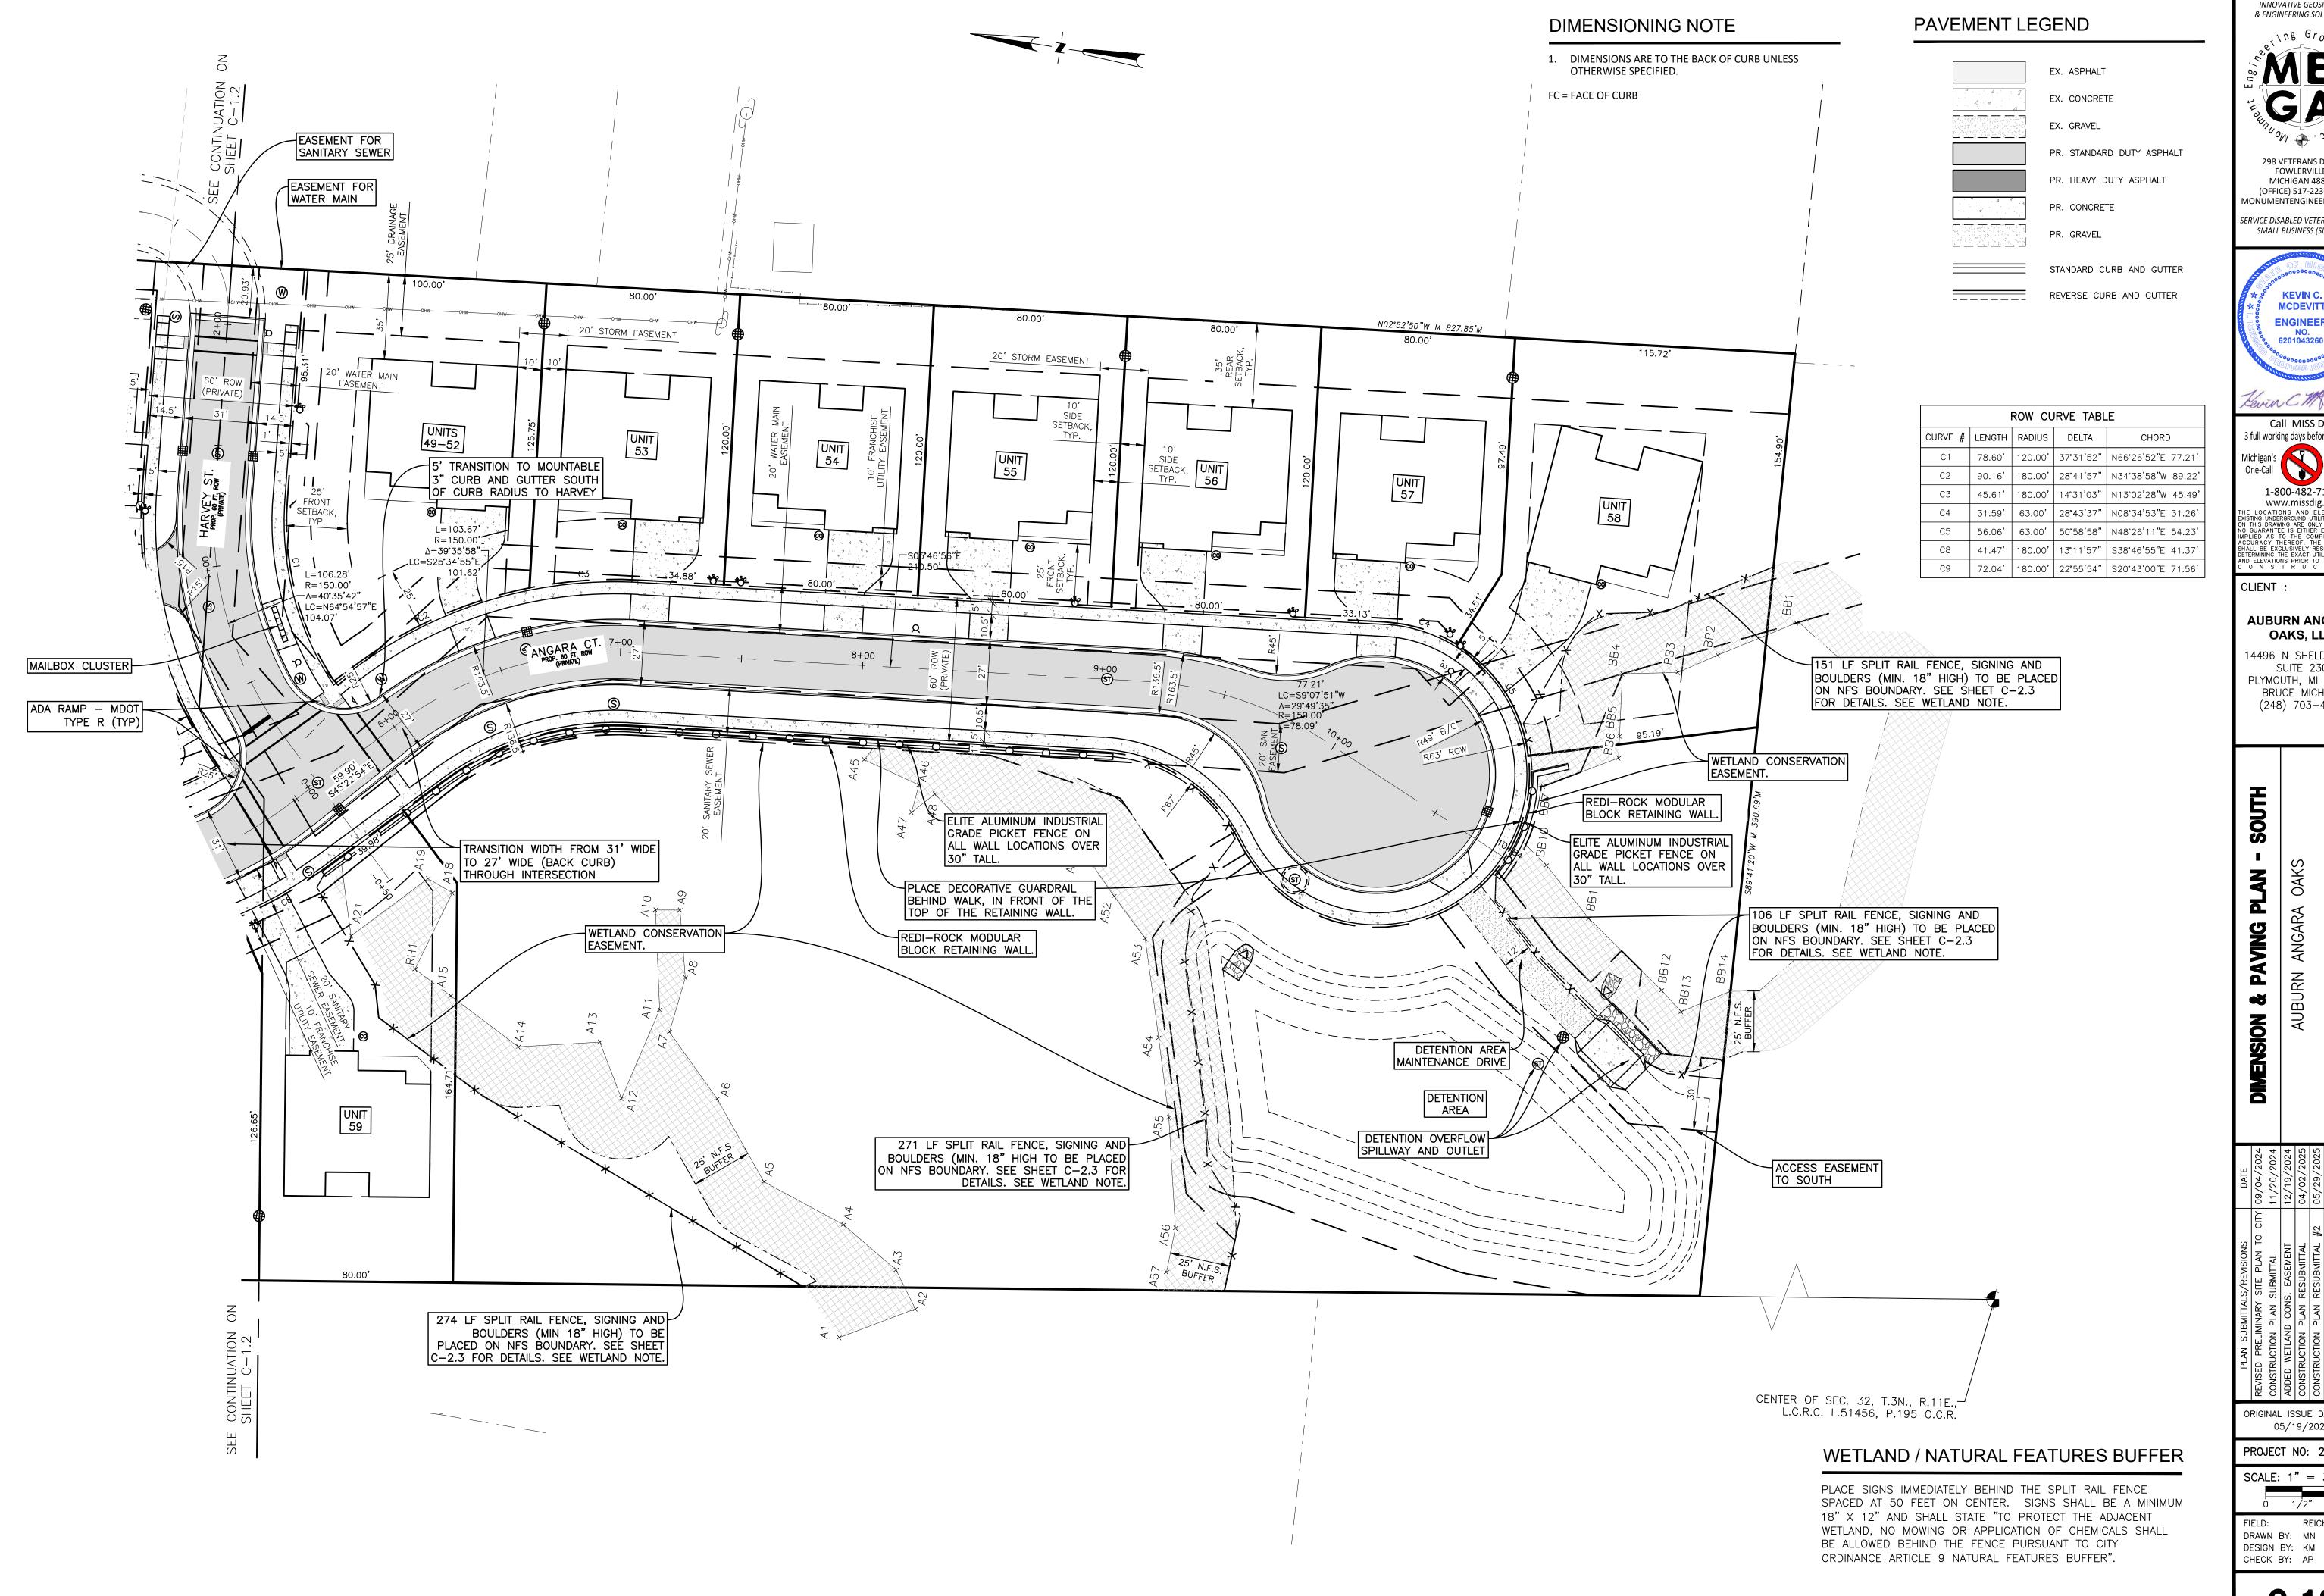
ORIGINAL ISSUE DATE: 05/19/2022

PROJECT NO: 22-051

SCALE: 1" = 30' 0 1/2" 1"

FIELD: REICHERT
DRAWN BY: MN
DESIGN BY: KM
CHECK BY: AP

C-1.2



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Kevin CM Levis

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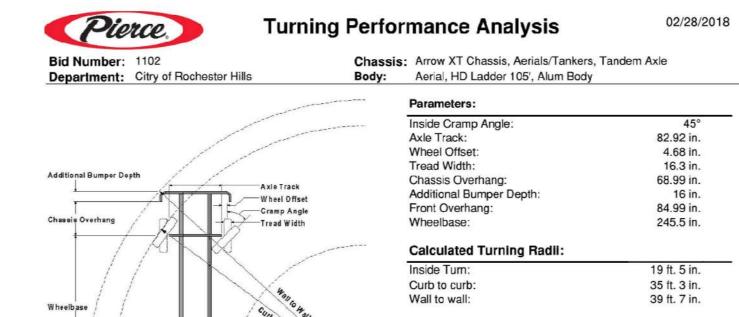
ORIGINAL ISSUE DATE: 05/19/2022

PROJECT NO: 22-051 SCALE: 1" = 30'

1/2" FIELD: REICHERT DRAWN BY: MN

CHECK BY: AP C-1.3

EMERGENCY VEHICLE WAS PROVIDED BY THE FIRE MARSHALL WITHIN THE MARKED UP SITE PLAN SUBMITTAL FOR PSP2022-0031 ON DATE 01/03/2023.



Category	Option	Description
Axle, Front, Custom	0018453	Axle, Front, Oshkosh TAK-4, Non Drive, 22,800 lb, Qtm/AXT/DCF
Wheels, Front	0019611	Wheels, Front, Alcoa, 22.50" x 12.25", Aluminum, Hub Pilot
Tires, Front	0594821	Tires, Front, Goodyear, G296 MSA, 425/65R22.50, 20 ply
Bumpers	0606536	Bumper, 16" Extended, Steel Painted, Arrow XT
Aerial Devices	0673137	Aerial, 105' Heavy Duty Ladder (500 dry/500 water)

Inside Turning Radius


Comments:

RHFD 105' turn radius

Actual Inside cramp angle may be less due to highly specialized options.

Curb to Curb turning radius calculated for 9.00 inch curb.

AUTOTURN EMERGENCY VEHICLE

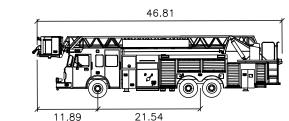

MFPD 100' Aerial Platform Pierce Arrow XT

Lock to Lock Time : 6.0 Steering Angle

Note: THE ABOVE TEMPLATE IS THE CLOSEST TRUCK AVAILABLE FOR USE IN THE STANDARD AUTOTURN LIBRARIES. IT HAS A SIMILAR PHYSICAL LAYOUT, WITH THE SAME LOCK ANGLE AND SLIGHTLY LARGER WHEELBASE AND TRACK.

FIRE DEPARTMENT NOTES

- 1. A KNOX KEY SYSTEM SHALL BE INSTALLED ON EACH MULTI-UNIT BUILDING IN A LOCATION APPROVED BY THE FIRE CODE OFFICIAL. ORDERING INFORMATION IS AVAILABLE THROUGH THE KNOX COMPANY AT WWW.KNOXBOX.COM (IFC 2006 SEC.1028.2)
- 2. FIRE LANES SHALL BE DESIGNATED BY THE FIRE CODE OFFICIAL, AND SHALL BE CONSPICUOUSLY POSTED ON BOTH SIDES OF THE FIRE LANE, WITH FIRE LANE SIGNS SPACED NOT MORE THAN 100 FEET APART. FIRE LANE SIGNS SHALL READ "NO STOPPING, STANDING, PARKING, FIRE LANE" AND SHALL CONFORM TO THE MICHIGAN MANUAL OF UNIFORM TRAFFIC CONTROL DEVICES (FIRE PREVENTION ORDINANCE CHAPTER 58, SEC 503)
- 3. CONSTRUCTION SITES SHALL BE SAFEGUARDED IN ACCORDANCE WITH IFC 2006 CHAPTER 14.
- 4. OPEN BURNING IS NOT PERMITTED, INCLUDING THE BURNING OF TRASH, DEBRIS, OR LAND CLEARING. OPEN BURNING FOR WARMING OF SAND AND / OR WATER FOR THE PREPARATION OF MORTAR SHALL BE WITHIN THE CITY OF ROCHESTER HILLS BURN PERMIT GUIDELINES FIRE PREVENTION ORDINANCE CHAPTER 58, SEC 307.6.2 & 307.6.2.3) MORTAR PERMIT CAN BE APPLIED FOR ONLINE AT WWW.ROCHESTERHILLS.ORG/FIRE IN THE "FOR YOUR BUSINESS"
- 5. PROVIDE A "NO PARKING FIRE DEPARTMENT CONNECTION" SIGN OVER EACH FIRE DEPARTMENT CONNECTION.
- 6. FDC'S SHALL NOT BE OBSTRUCTED BY LANDSCAPING, PARKING, OR ANY OTHER PERMANENT OR TEMPORARY MATERIALS OR DEVICES.
- 7. IF THE FIRE DEPARTMENT CONNECTION IS NOT LOCATED ON THE STREET FRONT OF THE BUILDING, A WHITE / CLEAR STROBE LIGHT SHALL BE TIED INTO THE FIRE ALARM SYSTEM AND INSTALLED OVER THE FDC.
- 8. SEE ARCHITECTURAL PLANS FOR BUILDING CONSTRUCTION MATERIALS AND INFORMATION PERTAINING TO BUILDING FIRE CODES.
- 9. ON STREET PARKING (EXCEPT FOR THE 12 NOTED PARKING SPACES) WILL NOT BE PERMITTED IN THE AREA OF THE MULTI-FAMILY BUILDINGS DUE TO THE NATURE OF THE ROADWAY BEING USED AS THE AERIAL FIRE APPARATUS ACCESS ROAD. FIRE LANE SIGNS WILL BE POSTED AND ENFORCED IN THESE AREAS.
- 10. THIS PROJECT MAY BE REQUIRED TO PERFORM EMERGENCY RADIO SIGNAL STRENGTH TESTING. TESTING FAILURE WILL REQUIRE INSTALLATION OF AN IN-BUILDING TWO-WAY EMERGENCY RESPONDER COMMUNICATION SYSTEM. CONTACT RHFD FOR MORE INFORMATION REGARDING THIS EQUIPMENT.

250' RADIUS FIRE

CITY OF ROCHESTER HILLS HYDRANT FLOW TEST

Location: Auburn Rd @ Angara Galoulations Performed By: Wagne Rubel


Number of Hydrania Flowing: Number of Outlets Open: Size of Outlet, D (inches): Friction Loss Coefficient, od: Static Pressure, P_s (psi): Residual Pressure, Pr (psi): Pito Pressure, Pp (psi): ___Residual-Flow, Q, (GPM);-

HYDRANT PRESSURE TEST

—Q; = 29.830;D²(P;)^{,63}#Outlets $Q_f = Q_f((P_s - 20) / (P_s - P_s))^{0.64}$ Fire Flow at 20 psi, Q_f (GPM):

Supply Main Size (plio hydrant): Supply Main Size (static hydrant):

Drawing of Flow Test Site (include location of flow & test hydrant):

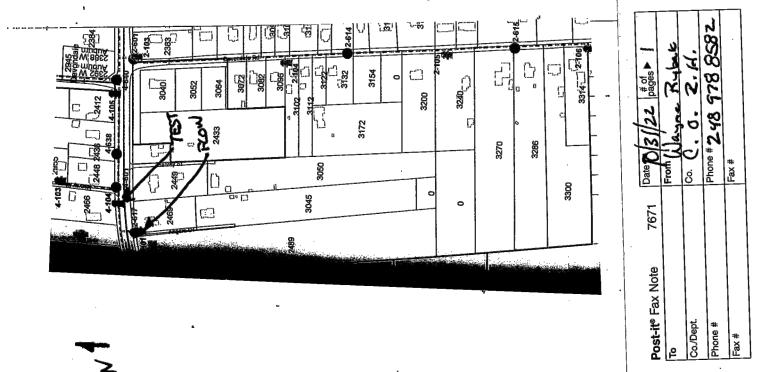

DIMENSIONING NOTE

- 1. DIMENSIONS ARE TO THE BACK OF CURB UNLESS OTHERWISE SPECIFIED.
- FC = FACE OF CURB

BUILDING SQUARE FOOTAGE

MULTIFAMIL`	Y
BUILDING/UNIT	TOTAL SF
ROWHOUSE STYLE CO	ONDOS
TOP 2 FLOORS (LIVING)	11,097
(BASEMENT)	7,347
APARTMENT BUILDI	NGS
A (TOP 2 FLOORS - LIVING)	11,792
A (BASEMENT)	5,896
B (TOP 2 FLOORS)	11,792
B (BASEMENT)	5,896
C (TOP 2 FLOORS)	11,792
C (BASEMENT)	5,896
D (TOP 2 FLOORS)	11,792
D (BASEMENT)	5,896
E (TOP 2 FLOORS)	11,792
E (BASEMENT)	5,896
SINGLE FAMI	LY
1	2,449 (GROSS)
2	2,449 (GROSS)
3	2,449 (GROSS)
4	2,449 (GROSS)
5	2,449 (GROSS)
6	2,449 (GROSS)
7	2,449 (GROSS)
8	2,449 (GROSS)
9	2,449 (GROSS)

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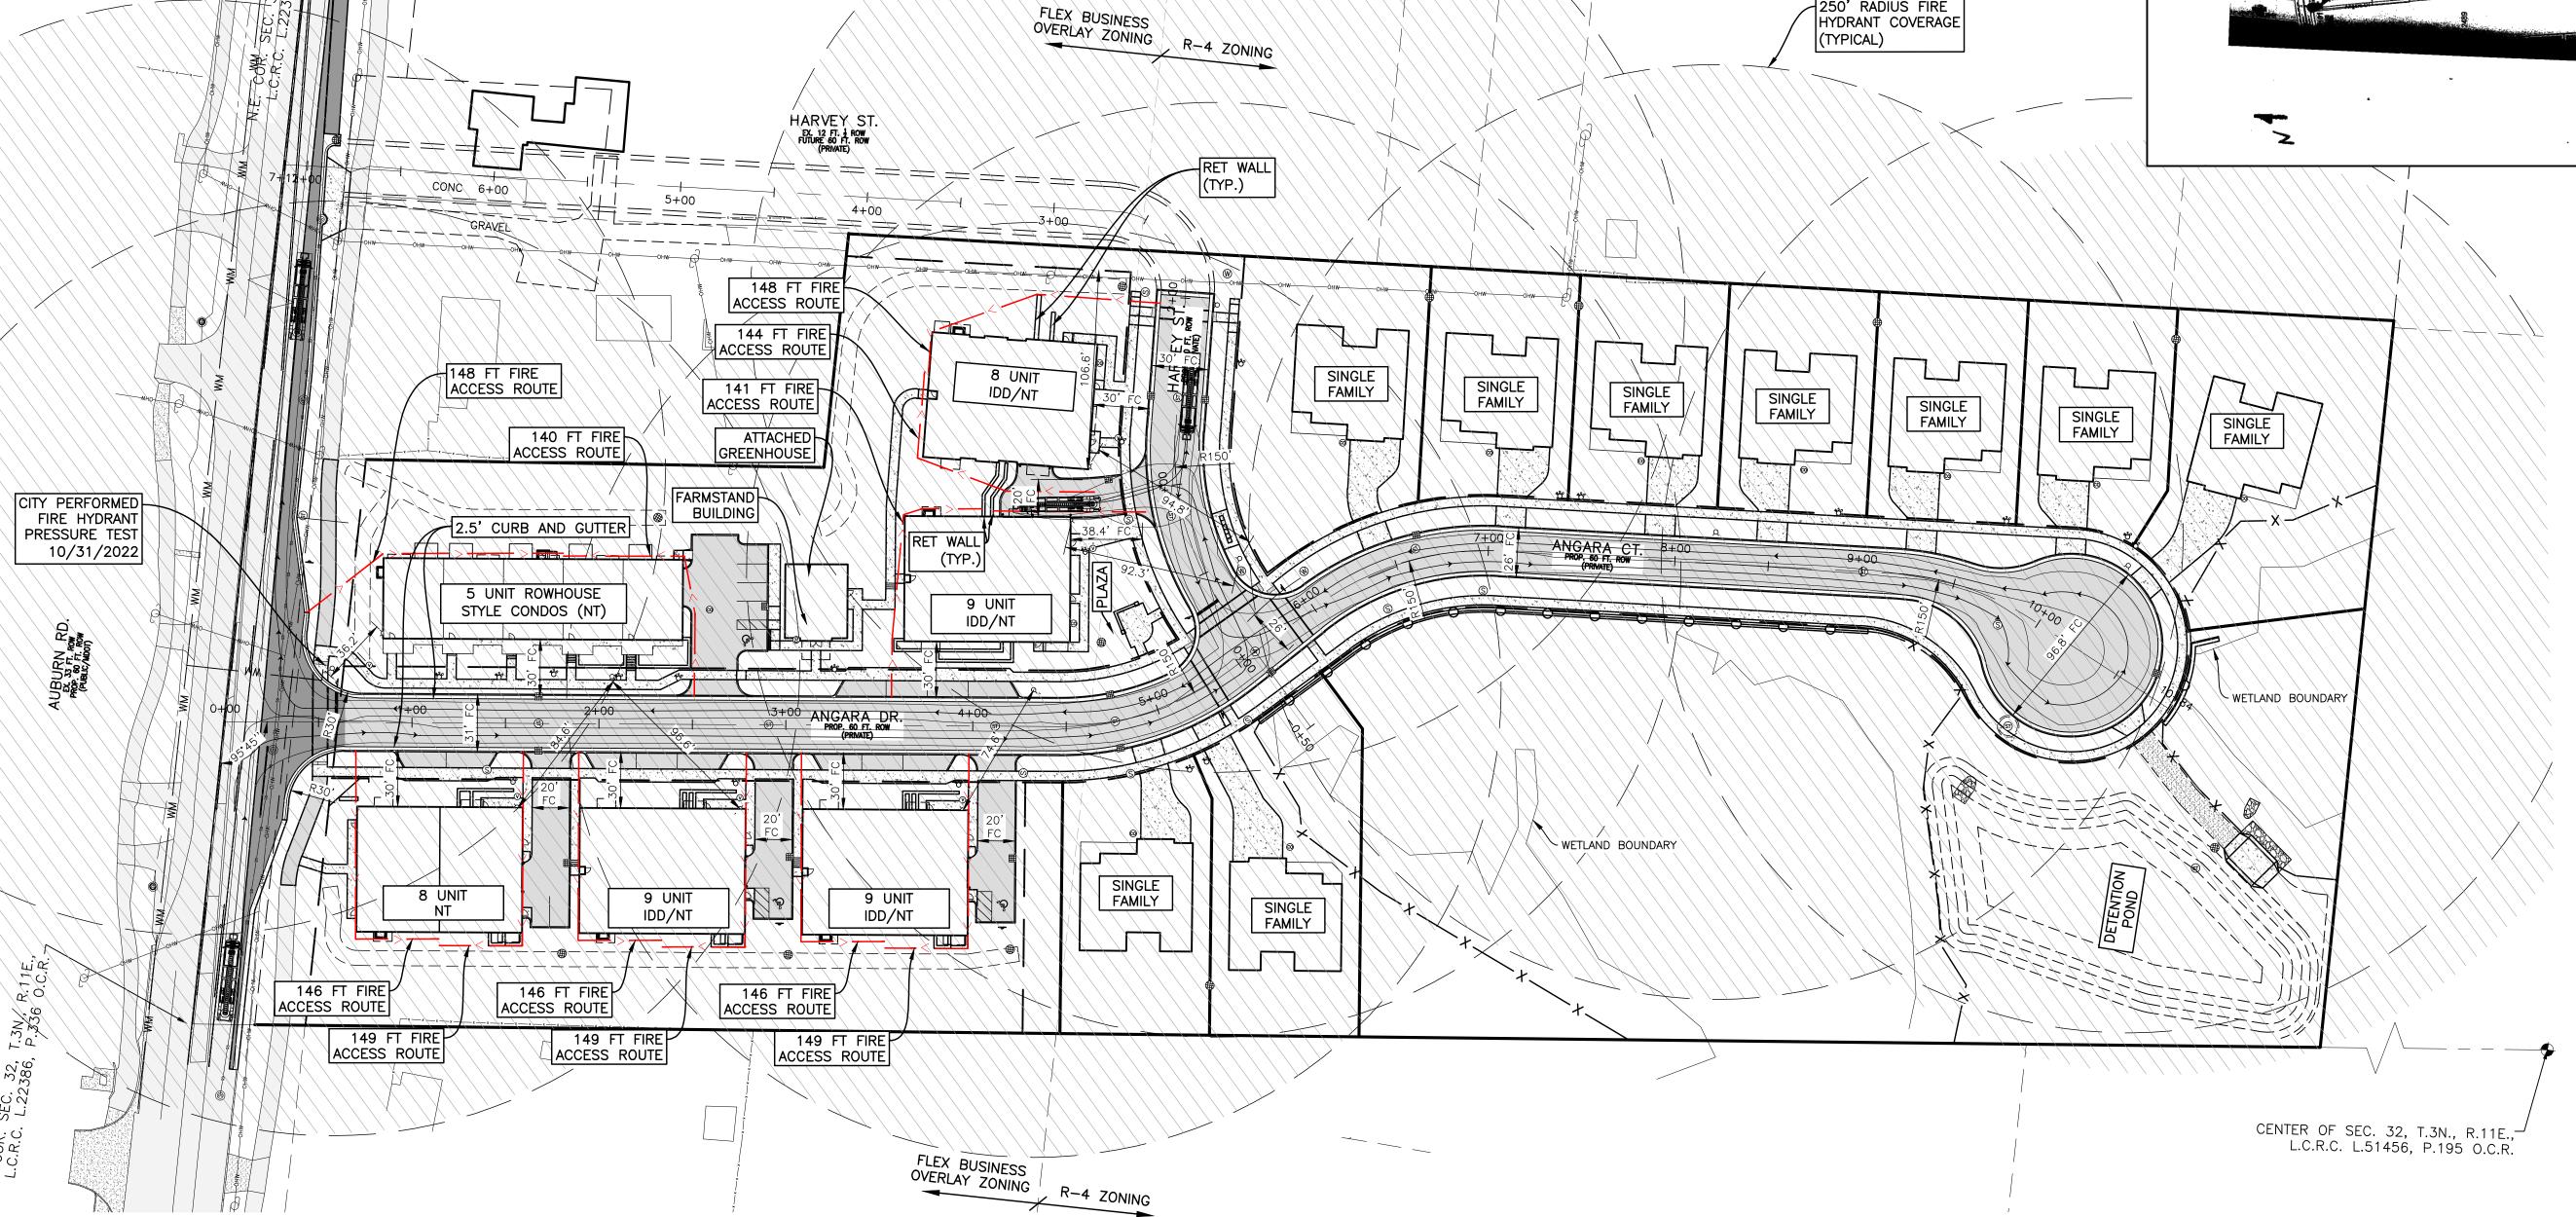
PROTECTION

ORIGINAL ISSUE DATE:

05/19/2022 PROJECT NO: 22-051

REICHERT DRAWN BY: MN DESIGN BY: KM CHECK BY: AP

C-2.1



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Michigan's One-Call Utility Organization 1-800-482-7171 TWWW.missdig.org

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OAKS ANGARA AUBURN CODE

ORIGINAL ISSUE DATE: 05/19/2022

PROJECT NO: 22-051 SCALE: 1" = 50'

1/2" FIELD: DRAWN BY: MN

REICHERT DESIGN BY: KM CHECK BY: AP

BUILDING CODE ANALYSIS - SINGLE FAMILY HOMES

Project Address: Auburn Anagra Oaks Development - Single Family Style homes 3046 Anagra Drive Rochester Hills, Michigan 48309 Description of Work: Proposed new single family detached homes. 2015 Michigan Residential Code (Includes Building, Mechanical, Electrical & Plumbing) 2015 Michigan Residential Code - Chapter 11 (Energy) 2019 NFPA, 13D, Fire Sprinkler Systems 2013 NFPA 72 - Fire Alarm Code

BUILDING CODE ANALYSIS - MULTIFAMILY BUILDINGS

```
Code Analysis summary, tagged to Planning Review comments. See Architectural
 sheet T1.2 for complete information
  Project Address:
 Auburn Anagra Oaks Development - Charlevoix Model Multi-Family Building.
 3046 Anagra Drive
 Rochester Hills, Michigan 48309
 Description of Work:
 Proposed new 9 unit, residiential apartment (condominium) building.
 Michigan Building Code (2021) ICC/ANSI A117.1 and Michigan Barrier Free Design Law (2017)
 MI Commercial Energy Code (2021) International Fire Code
                         (2019) NFPA 13 - Fire Sprinkler Systems
                                                                                                  (2019)
 Michigan Mechnical Code (2021) NFPA 72 - Fire Alarm Code
 Michigan Plumbing Code (2021) Michigan Electrical Code (IEC + Part 8 State amendments) (2023)
Residential (Primary use - dwelling units/ accessory spaces)
Use Group
Use Group
Use Group
S-2
 Separated Mixed Use:
                             Per Sect. 508.4, requires min. 1 hour fire separation between S and R
                              uses (in building w/ 903.3.1.1 [full NFPA-13] compliant sprinkler system)
 Type of Construction: VB - (2) stories above grade w/ (1) story below grade garage
 ALLOWABLE HEIGHT and BUILDING AREAS (per TABLES 504.3, 504.4 & 506.2):
 ALLOWABLE HEIGHT:
                                                Sprinkler system equipped*
                                               Height (Feet) Height (Stories)
 Use Group:
S-2 (Parking garage) @ Type 5B constr'n
                                                60 feet
                                                                3 stories
R-2 (Permanent dwelling) @ Type 5B constr'r
                                                 60 feet
                                                                3 stories
 ACTUAL building height in Feet/Stories
                                                 29'-11"
                                                                 2 Stories
*NFPA 13 complying with Section 903.3.1.1 (and NOT NFPA13R 903.3.1.2)
 ALLOWABLE BUILDING AREA (per story):
Floor (Use Groups):
                                              Max. Allowed* (sf) Provided (sf)
                                                                  5,588
Basement (Garage) Level: (S-2)
                                                  40,500
                                                                 5,700
First Floor: (R-2)
                                                 21,000
                                                                  5,708
 Second Floor: (R-2)
                                                 21,000
TOTAL ACTUAL BLDG. AREA
                                                                  16,996
*NFPA 13 complying with Section 903.3.1.1(and NOT NFPA13R 903.3.1.2)
 CHAPTER 9 Fire Protection Systems

        Yes
        X
        No

        13
        X
        13R

        Yes
        No
        X

        Yes
        X
        No

        Yes
        No
        X

        Yes
        No
        X


          (903) Automatic Sprinkler System Fully Sprinkled
               NFPA 13 or 13R
          (905) Standpipe System *
          (907) Alarm System
                Smoke Control System
               Fire Control Room
          * highest floor is 21'-4" = less than 30' above lowest fire vehicle access
 Separation of multiple buildings on site per Sect. 503.1.2, 602
               Exterior Rating based on Fire Separation Distance per Table 602
                            Fire Sep'n Dist. (ft) Req'd Rating UL Listing and Notes
                                                0 hr.
0 hr.
0 hr.
0 hr.
                            10' or more
               East
                            10' or more
               South
                            10' or more
               West
                            10' or more
```

BUILDING CODE ANALYSIS - FARM STAND BUILDING


Code Analysis summary, tagged to Planning sheet T1.2 for complete information	Review comments	s. See Architectural	
Project Address: Auburn Anagra Oaks Development - Product 3046 Anagra Drive Rochester Hills, Michigan 48309 Description of Work:	e Sales Market Bu	ilding and Greenhouse.	
Proposed new one-story Market building for tand attached agricultural greenhouse for pro		s	
MI Commercial Energy Code (2021) Inter ASHRAE 90.1 (2019) NFP Michigan Mechnical Code (2021) NFP	national Fire Code A 13 - Fire Sprinkl A 72 - Fire Alarm	er Systems	(201) (202) (201) (201) (202)
Mercantile (Retail market space for produce substitution Utility (Agricultrual greenhouse for production		Use Group <u>M</u> Use Group <u>U</u>	
Unseparated Mixed Use: Per Sect. 508. entire building		allowances shall apply to the	
Type of Construction: VB - (1) storie	s above grade on	slab-on-grade	
ALLOWABLE HEIGHT and BUILDING AREA	AS (per TABLES 5	04.3, 504.4 & 506.2):	
ALLOWABLE HEIGHT:	NOT oprinkler o	ystem equipped*	
Use Group:	<u> </u>	Height (Stories)	
M (Mercantile) - Type 5B constr'n*	Height (Feet) 40 feet	1 stories	
U (Greenhouse) - Type 5B constr'n*	40 feet	1 Story	
ACTUAL building height in Feet/Stories	17-8 1/2"	1 Story	
ALLOWABLE AREA SUMMARY (per story):		system required, per Section 903.2	
Floor (Use Groups):	Max. Allowed (sf)	Provided (sf)	
M (Mercantile) - Type 5B constr'n*	9,000	476	
U (Greenhouse) - Type 5B constr'n*	5,500	801	
TOTAL ACTUAL BLDG. AREA (unseparated	9,000	1,277	
	*no sprinkler	system required, per Section 903.2	
CHAPTER 9 Fire Protection Systems (903) Automatic Sprinkler System F NFPA 13 or 13R (905) Standpipe System * (907) Alarm System Smoke Control System Fire Control Room	Fully Sprinkled	Yes NoX 13 13Rn/a Yes NoX Yes NoX Yes NoX Yes NoX	
Separation of multiple buildings on site per S			
Exterior Rating based on Fire			
Fire Sep'n Dist. North 10' or more East 10' or more	(ft) Req'd Rating 0 hr. 0 hr.	UL Listing and Notes n/a n/a	

BUILDING CODE ANALYSIS - ROWHOUSE STYLE ATTACHED CONDOS

Code Analysis summary, tagged to Planning sheet T1.2 for complete information	Review comments	s. See Architectural
Project Address: Auburn Anagra Oaks Development - Rowhol 3046 Anagra Drive Rochester Hills, Michigan 48309	use-style Multi-Far	mily Building.
Description of Work: Proposed new 5 unit, residiential apartment (condominium) bui	ldina.
Reference Standards: Michigan Building Code (2021) ICC MI Commercial Energy Code (2021) Intel ASHRAE 90.1 (2019) NFF Michigan Mechnical Code (2021) NFF	ANSI A117.1 and mational Fire Code A 13 - Fire Sprink A 72 - Fire Alarm	Michigan Barrier Free Design Law (201 e (202 ler Systems (201
Residential (Primary use - dwelling units/ acc Storage (Low-hazard storage / parking garag		Use Group R-2 Use Group S-2
		hour fire separation between S and R III NFPA-13] compliant sprinkler system)
Type of Construction: VB - (2) storie	s above grade w/	(1) story below grade garage
ALLOWABLE HEIGHT and BUILDING AREA	AS (per TABLES 5	04.3, 504.4 & 506.2):
ALLOWABLE HEIGHT:	Sprinkler sys	tem equipped*
Use Group:	Height (Feet)	Height (Stories)
S-2 (Parking garage) @ Type 5B constr'n	60 feet	3 stories
R-2 (Permanent dwelling) @ Type 5B constr	n 60 feet	3 stories
ACTUAL building height in Feet/Stories	27'-9"	2 Stories
*NFPA 13 complying with Section 903.3.1.1 (a ALLOWABLE BUILDING AREA (per story):	nd <u>NOT</u> NFPA13F	R 903.3.1.2)
Floor (Use Groups):	Max. Allowed* (sf	Provided (sf)
Basement (Garage) Level: (S-2)	40,500	4,315
First Floor: (R-2)	21,000	6,782
Second Floor: (R-2)	21,000	7,347
TOTAL ACTUAL BLDG. AREA		18,444
*NFPA 13 complying with Section 903.3.1.1(ar	nd NOT NFPA13R	903.3.1.2)
CHAPTER 9 Fire Protection Systems (903) Automatic Sprinkler System I NFPA 13 or 13R (905) Standpipe System *	Fully Sprinkled	Yes X No
(907) Alarm System Smoke Control System Fire Control Room * highest floor is 21'-1" = less than 3	80' above lowest fi	re vehicle access
Smoke Control System Fire Control Room		re vehicle access
Smoke Control System Fire Control Room * highest floor is 21'-1" = less than 3	ect. 503.1.2, 602	
Smoke Control System Fire Control Room * highest floor is 21'-1" = less than 3 Separation of multiple buildings on site per S	ect. 503.1.2, 602 Separation Distand	ce per Table 602
Smoke Control System Fire Control Room * highest floor is 21'-1" = less than 3 Separation of multiple buildings on site per S Exterior Rating based on Fire Fire Sep'n Dist. North 10' or more	ect. 503.1.2, 602 Separation Distance (ft) Req'd Rating 0 hr.	ce per Table 602 UL Listing and Notes n/a
Smoke Control System Fire Control Room * highest floor is 21'-1" = less than 3 Separation of multiple buildings on site per S Exterior Rating based on Fire Fire Sep'n Dist.	ect. 503.1.2, 602 Separation Distand (ft) Req'd Rating	ce per Table 602 UL Listing and Notes

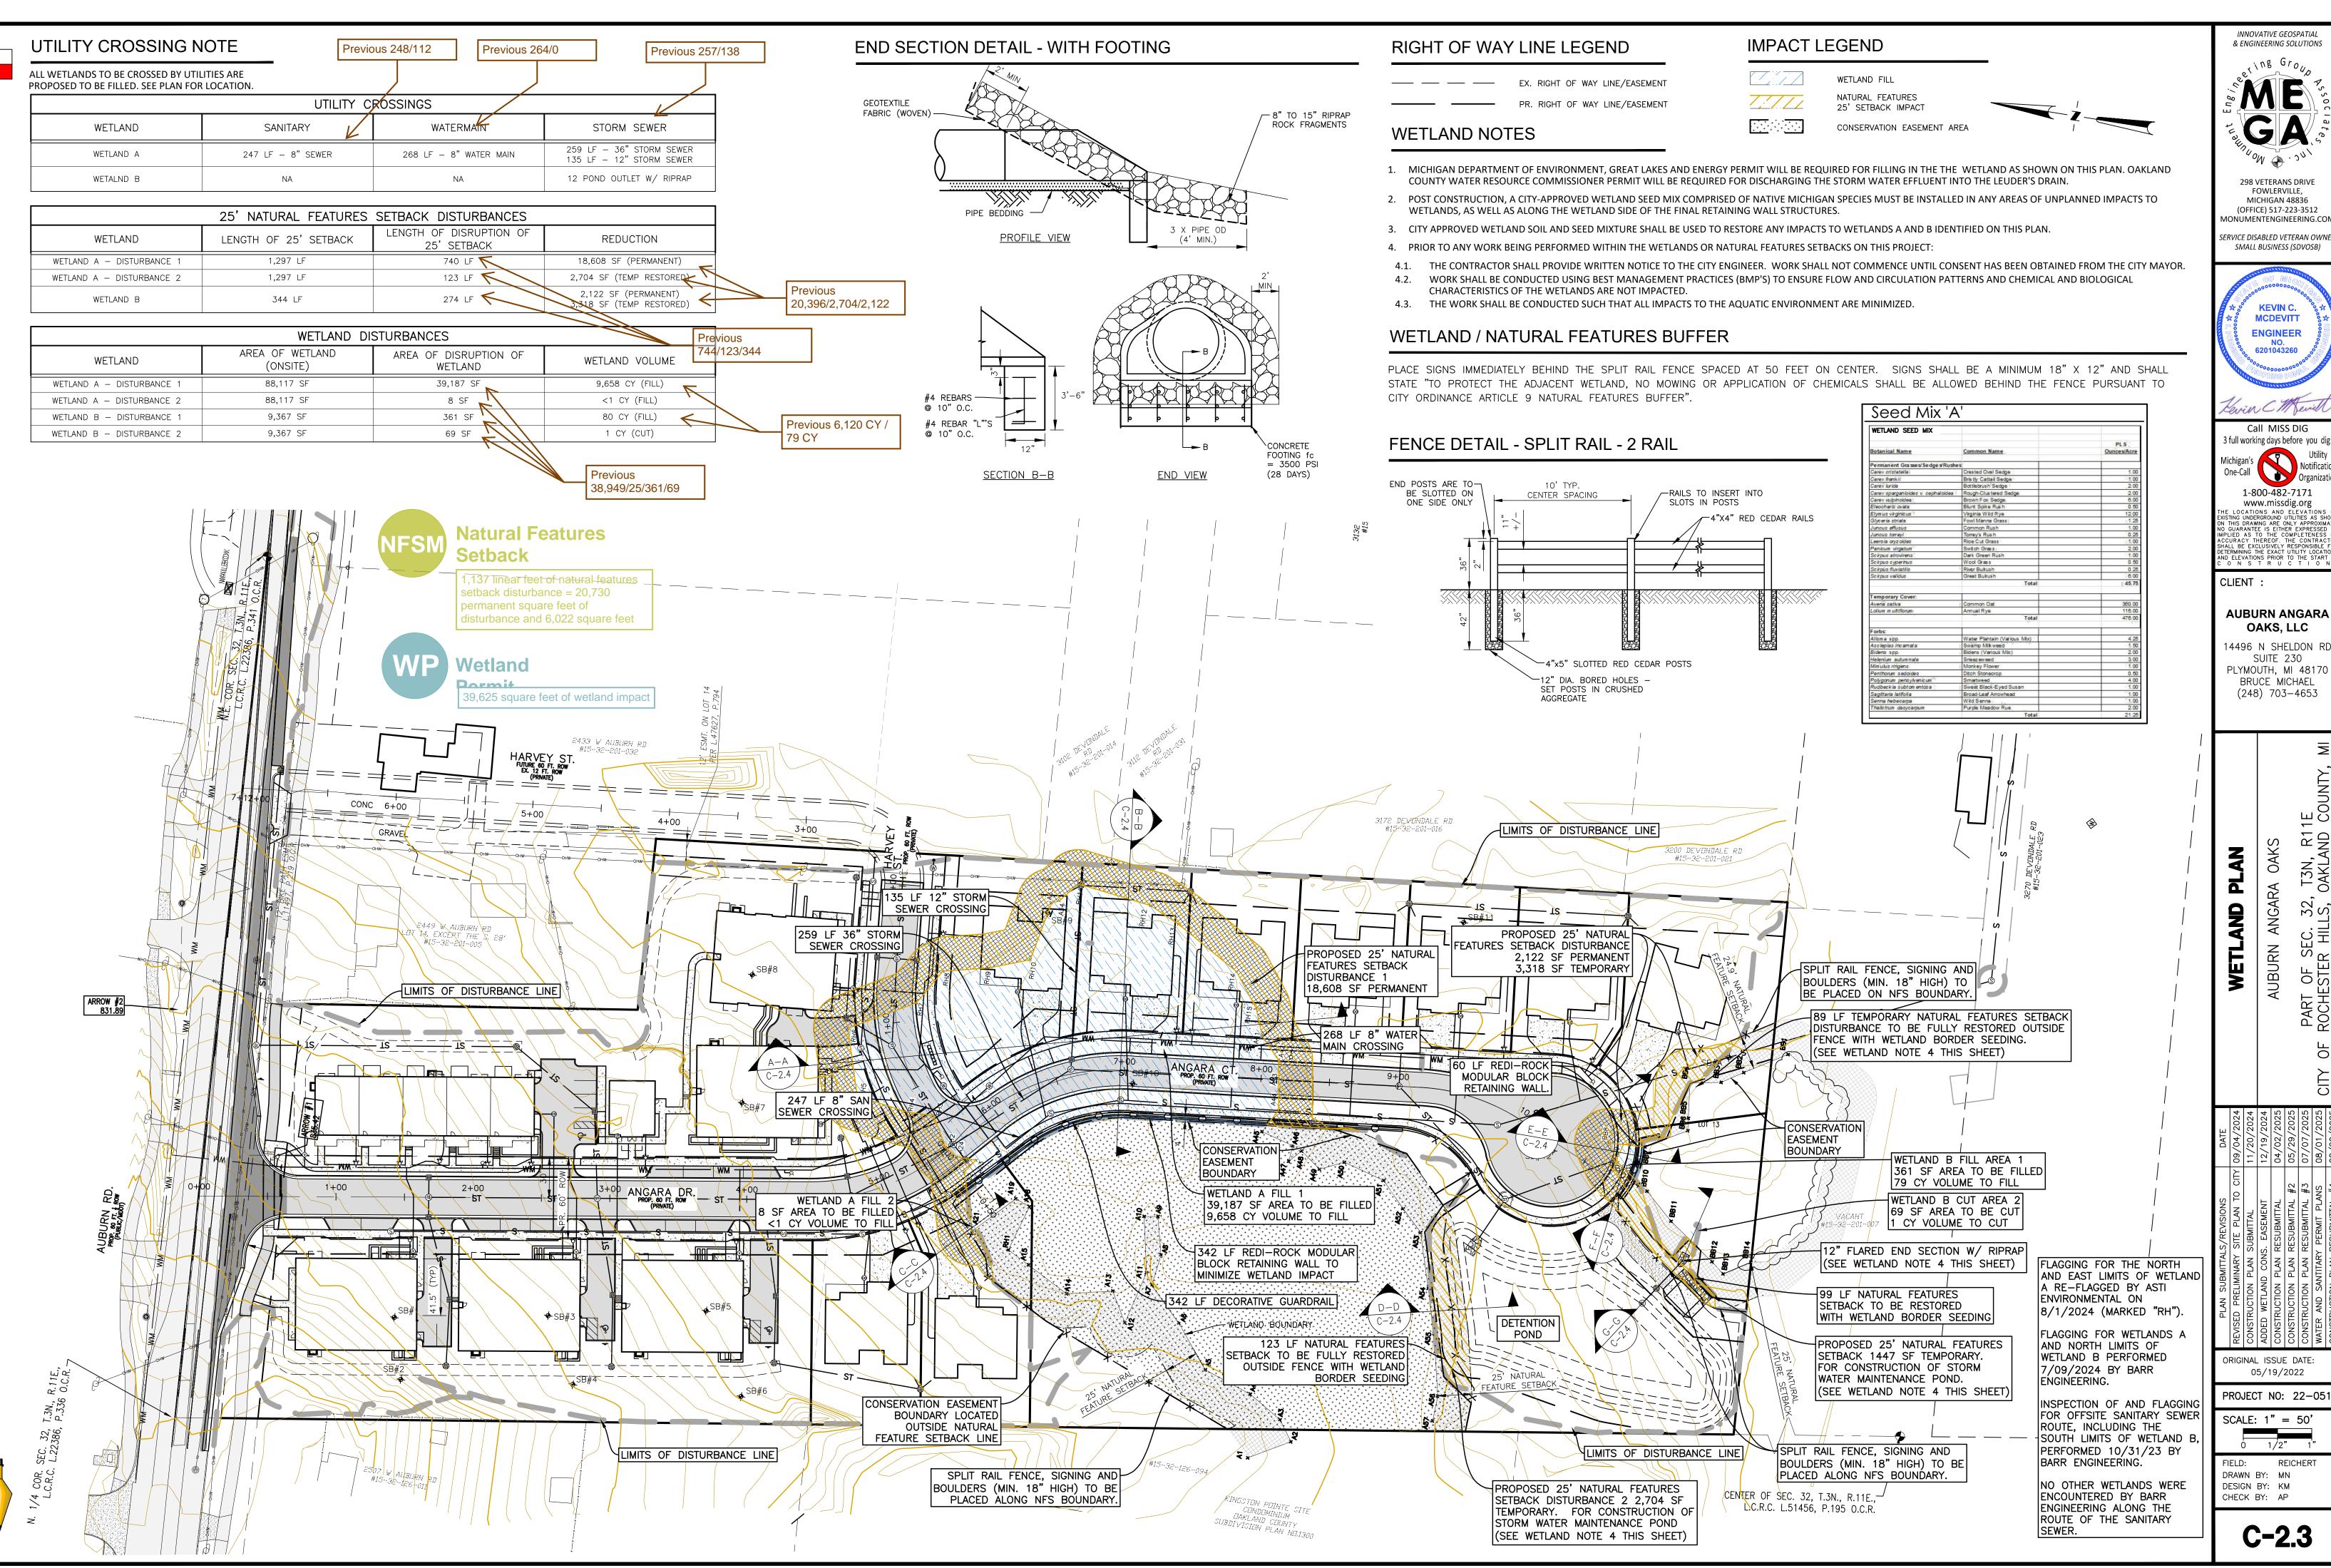

FILE:P:\Projects\2022\22-051 Auburn Angara Sub\Dwg\Engineering\22-051_C-2.3_Wetland Plan.dwg PLOT DATE:8/20/2025 10:09 AM

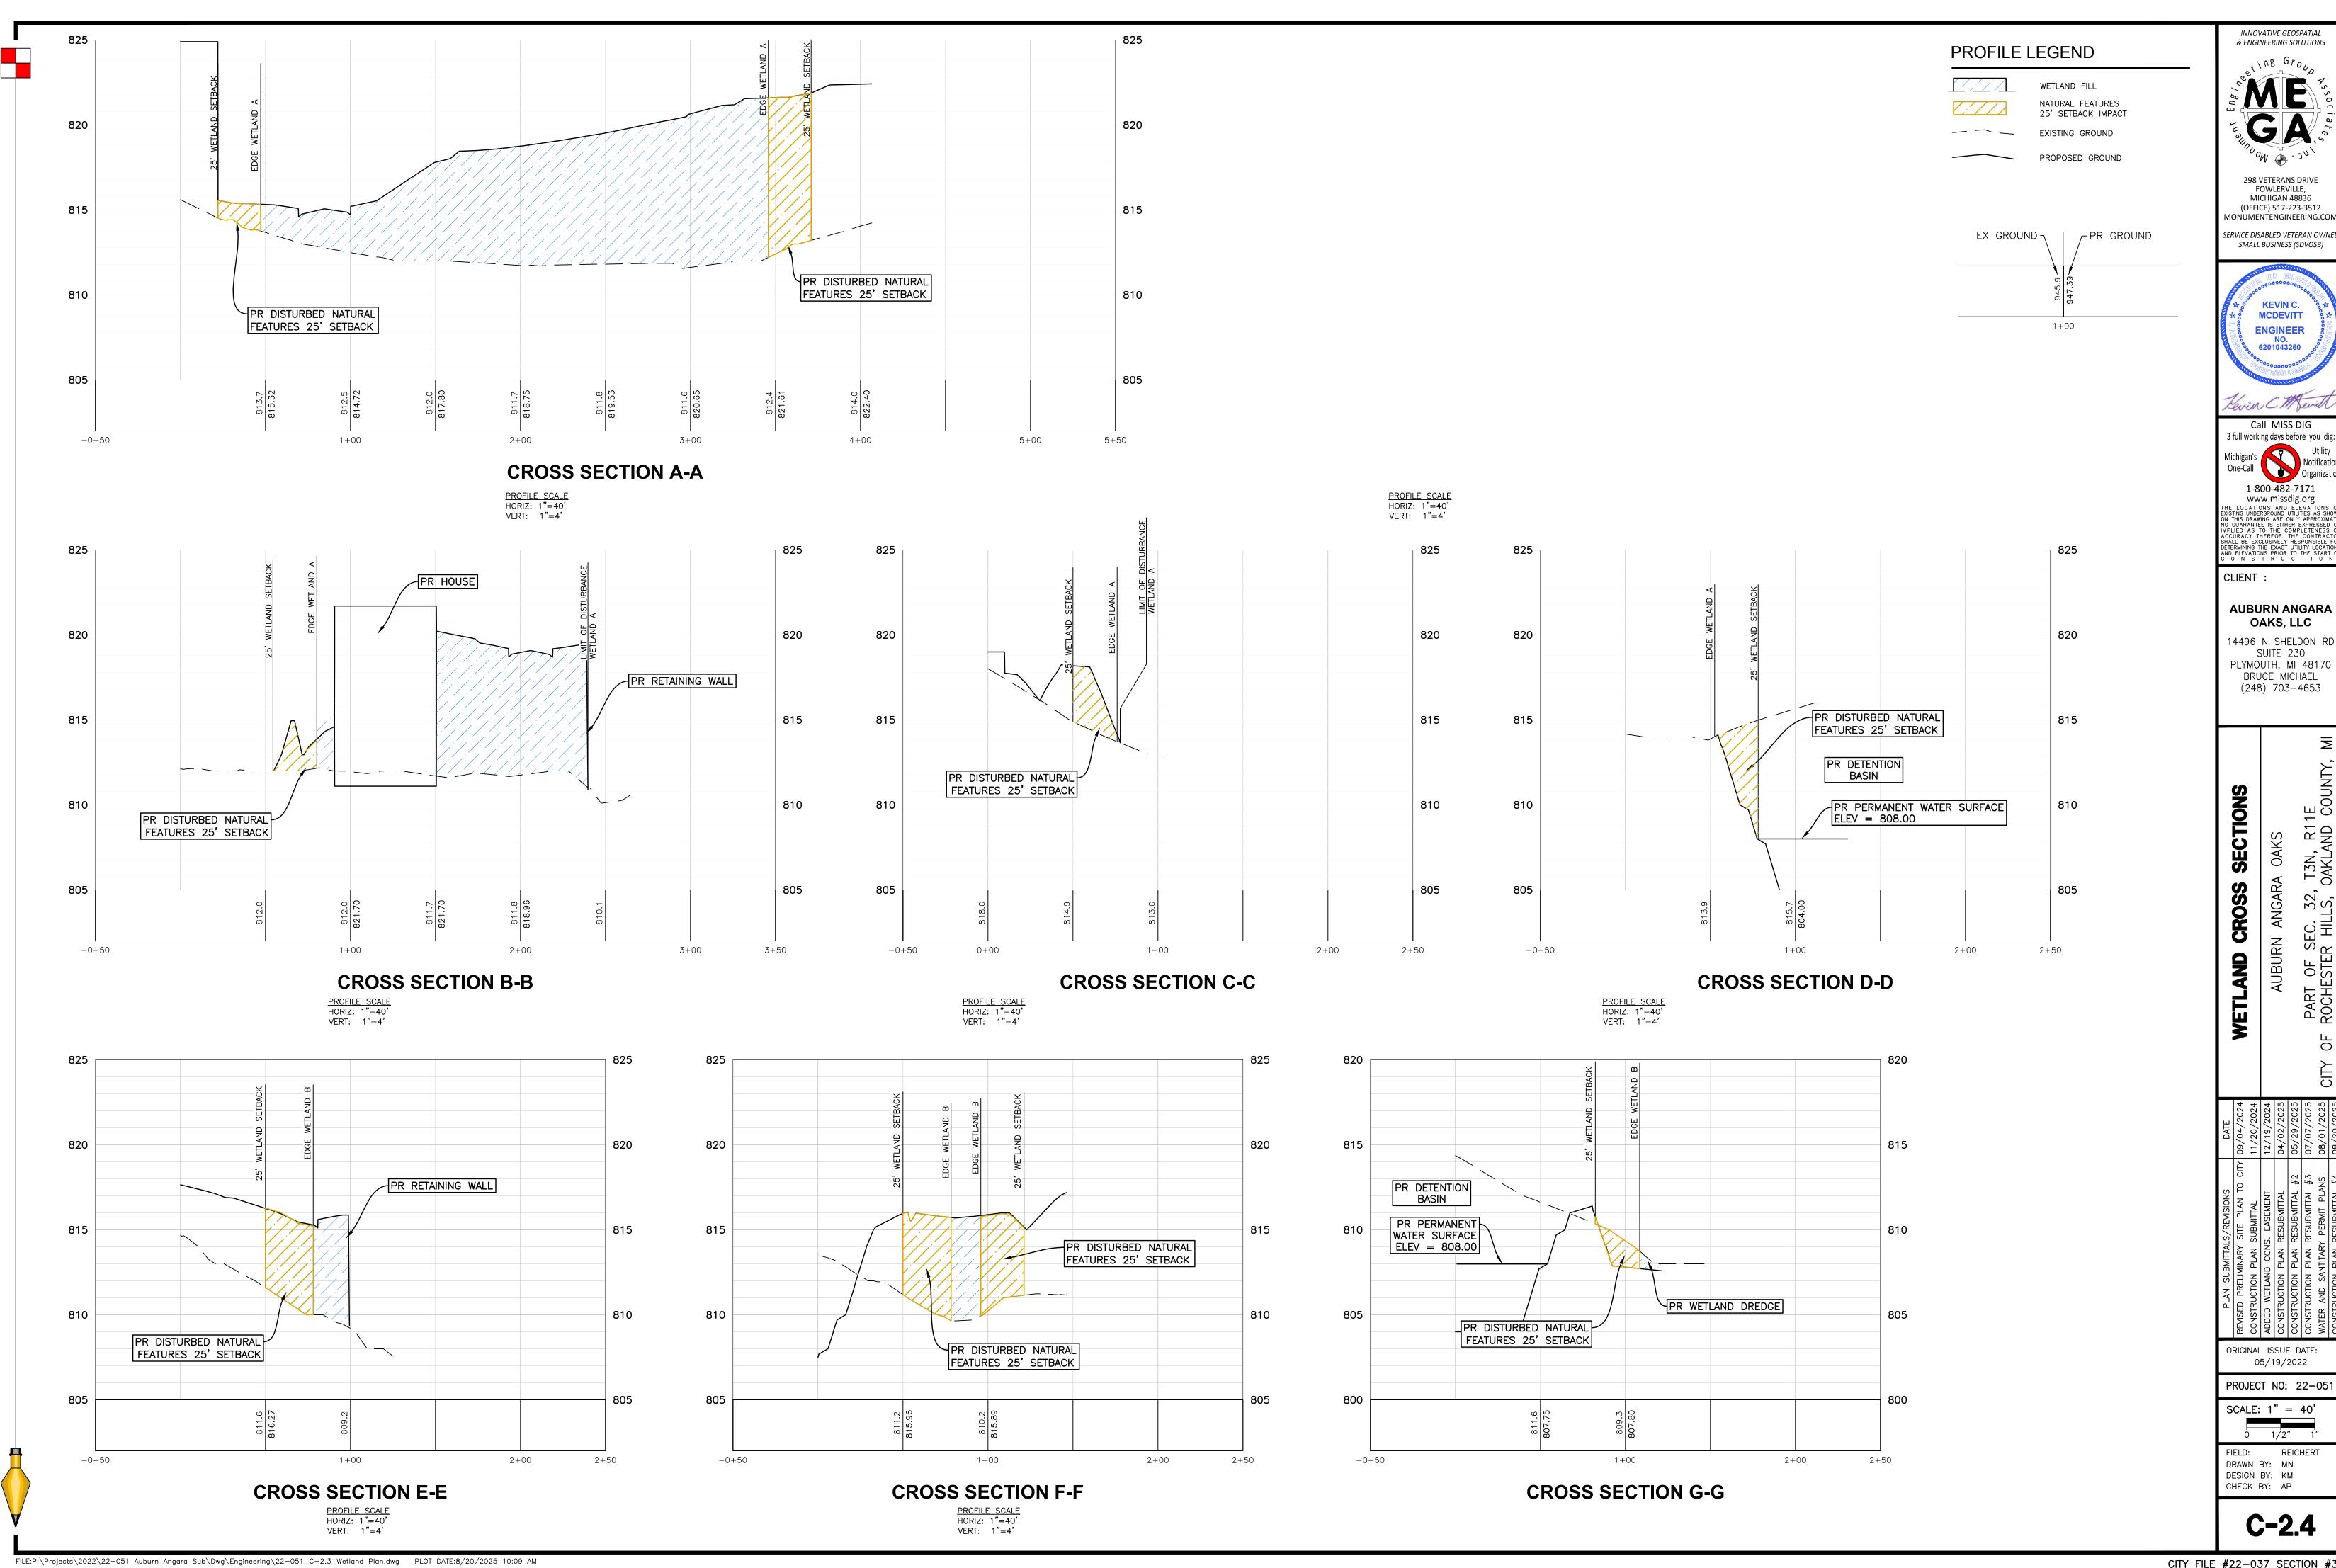

REICHERT


KEVIN C.

MCDEVITT

ENGINEER NO. 6201043260

OAKS

AUBURN

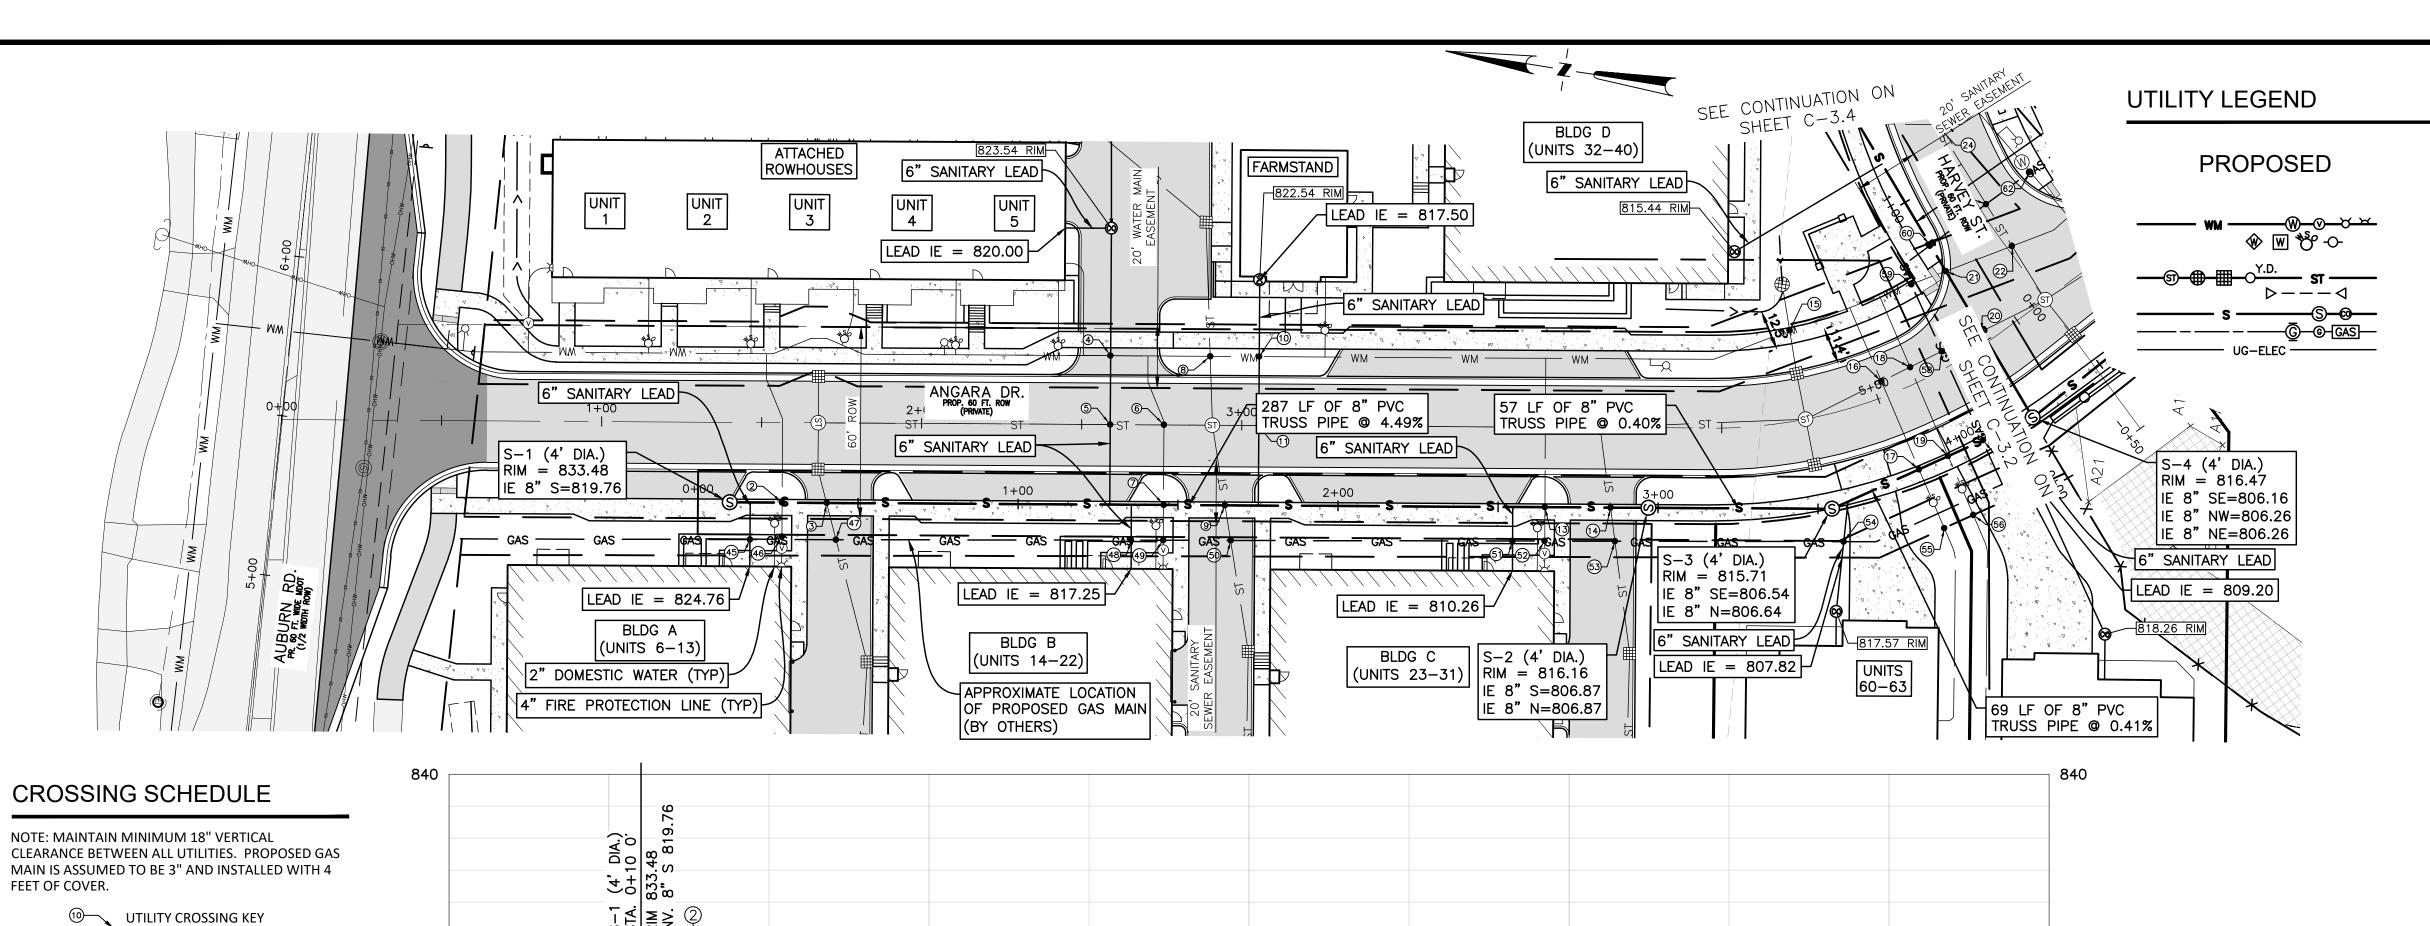

UTILITY CROSSING KEY

161.60

4" D.I. WATER LEAD (BLDG C)

(TYPICAL)

#BP=810.56

TP=809.03'

57 LF OF 8" PVC

TRUSS PIPE @ 0.40%

P⊨808.06'́

VERT: 1"=3"

' WATER LEAD (UNIT 59)

" WATER LEAD (UNIT 60)

BP=809.72

TP=807.09'

69 LF OF 8" PVC TRUSS PIPE @ 0.41%

~4" D.I. WATER LEAD (BLDG A)

TP=819.07'

4" D.I. WATER LEAD (BLDG B)-

287 LF OF 8" PVC

TRUSS PIPE @ 4.49%

BP=817.76'

TP=814.39

⊬TP=813.48°

ANGARA DRIVE - SANITARY SEWER 0+00 TO STA. 4+00

TP=819.74

EXISTING

UG ELEC (ELEC, CABLE, FIBER)

WATER MAIN, MH, VALVE IN BOX, HYDRANT WATER WELL, METER, STOP BOX, POST INDICATOR VALVE

STORM SEWER, MH, CB, INLET, DOWN SPOUT, YARD DRAIN CULVERT/ END SECTION SANITARY SEWER, MH, CLEAN OUT UG GAS, MH, VALVE, LINE MARKER

SANITARY SEWER NOTES

- 1. SANITARY "MH" SHALL HAVE EJIW 1040 FRAME WITH TYPE A COVER.
- 2. ALL SEWER LEADS SHALL BE PVC SDR 23.5 PIPE.
- 3. ALL SEWER MAIN SHALL BE PVC TRUSS PIPE (200 PSI) FOR OPEN CUT AND SDR 26 PIPE FOR DIRECTIONAL BORE.
- 4. ALL SANITARY LEADS SHALL HAVE CLEANOUTS INSTALLED A MAXIMUM 5' FROM THE BUILDING FACE. BUILDING CLEANOUTS SHALL BE IDENTIFIED ON THE BUILDING MEP

SANITARY SEWER QUANTITIES

	QTY	UNIT	ITEM
,	413	LF	8" PVC TRUSS PIPE
	232	LF	6" PVC SDR 23.5
	3	EA	4' MANHOLE
	2	EA	CLEANOUT

QTY	UNIT	ITEM
413	LF	8" PVC TRUSS PIPE
232	LF	6" PVC SDR 23.5
3	EA	4' MANHOLE
2	EA	CLEANOUT

SANITARY SEWER BASIS OF DESIGN

Monument Engineering Group Associates, Inc.

298 Veterans Drive, Fowlerville, MI 48836 (517) 223-3512 monumentengineering.com

Date: 3/27/2025


PROJECT NAME: PROJECT LOCATION: City of Rochester Hills, Oakland County, Michigan MEGA PROJECT NO.: 22-051

THE FOLLOWING CALCULATIONS UTILIZE A MODIFED OAKLAND COUNTY METHODOLOGY WHERE 1 UNIT EQUALS ONE MULTI-FAMILY RESIDENTIAL DWELLING WITH AN ASSUMED NUMBER OF PERSONS PER DWELLING OF 2.44.

NUMBER OF UNITS = 49 MF UNITS, 30 FUTURE UNITS AND 9 SF UNITS = 88 UNITS ASSUMED NUMBER OF PEOPLE PER UNIT = EQUIVALENT POPULATION = UNITS x PEOPLE PER UNIT = 88 x 2.44 = 214.72 PEOPLE AVERGAGE DAILY FLOW = POPULATION x 100 GPDPC = 214.72 x 100 = 21472 GPD = 0.0332 CFS PEAKING FACTOR = $(18 + (P^0.5))/(4 + (P^0.5)) = 4.136637138$ (USE MAXIMUM OF 4)

PEAK HOUR FLOW = PEAKING FACTOR x AVERAGE DAILY FLOW =

85888 GPD = 0.1329 CFS 59.6 GPM

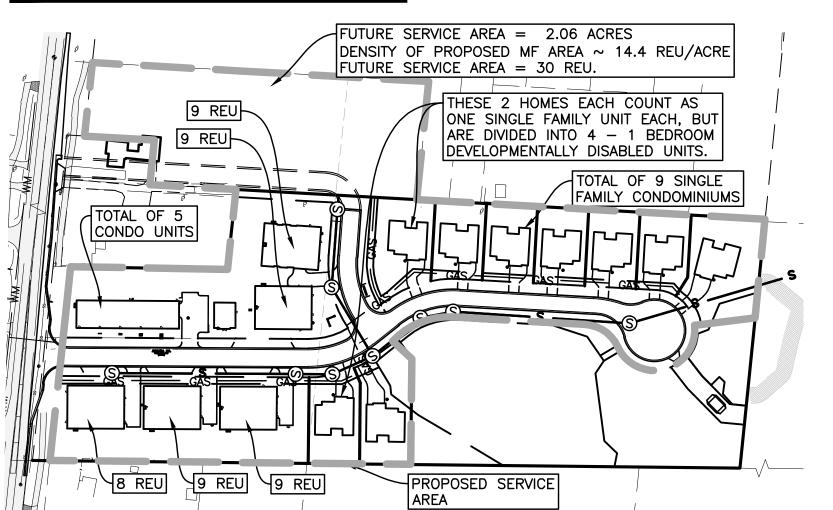

(ALONG 4+00 2 **5**

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NO GUARANTEE IS EITHER EXPRESSED
MPLIED AS TO THE COMPLETENESS
ACCURACY THEREOF. THE CONTRACT
SHALL BE EXCLUSIVELY RESPONSIBLE F
DETERMINING THE EXACT UTILITY LOCATIO
AND ELEVATIONS PRIOR TO THE START
CONSTRUCTOR

AUBURN ANGARA

OAKS, LLC

14496 N SHELDON RE

SUITE 230

PLYMOUTH, MI 48170

BRUCE MICHAEL (248) 703-4653

CLIENT:

ORIGINAL ISSUE DATE: 05/19/2022

PROJECT NO: 22-051 SCALE: 1" = 30'1/2" FIELD: REICHERT DRAWN BY: MN DESIGN BY: KM CHECK BY: AP

C-3.1

SANITARY SERVICE AREA MAP

835

830

825

810

,4+ 0,18 0,18 0,18 0,18

STA STA

₩BP=809.84'

//TP=807.05

4+00

63.48

FILE:P:\Projects\2022\22-051 Auburn Angara Sub\Dwg\Engineering\22-051_C-3.1_San.dwg PLOT DATE:8/20/2025 10:10 AM

ABBREVIATIONS: IE = INVERT ELEVATION

TP = TOP OF PIPE BP = BOTTOM OF PIPE

2 4" WATER LEAD / FIRE = 825.99

(3) 12" STORM SEWER BP = 825.28

 $| 4 \rangle$ 8" WATER MAIN BP = 817.92

(5) 12" STORM SEWER BP = 819.70

7 4" WATER LEAD / FIRE = 817.76

9 12" STORM SEWER BP = 817.21

(10) 6" SANITARY LEAD BP = 815.83

(11) 12" STORM SEWER BP = 815.79

(13) 4" WATER LEAD / FIRE = 810.56

(14) 12" STORM SEWER BP = 810.30

SUPPRESSION BP

(17) 1" WATER LEAD BP

(19) 1" WATER LEAD BP

6" SANITARY LEAD TP

6" SANITARY LEAD TP

(45) GAS MAIN BP

(51) GAS MAIN BP

8" SANITARY SEWER TP = 819.74

8" SANITARY MAIN TP = 819.07

6" SANITARY LEAD TP = 816.14

6" SANITARY LEAD TP = 815.73

8" SANITARY SEWER TP = 814.39

8" SANITARY SEWER TP = 813.48

8" WATER MAIN TP = 814.33

6" SANITARY LEAD TP = 814.87

8" SANITARY SEWER TP = 809.03

8" SANITARY SEWER TP = 808.07

8" SANITARY SEWER TP = 807.09

8" SANITARY SEWER TP = 807.05

6" SANITARY LEAD TP = 810.59

6" SANITARY LEAD TP = 807.95

= 809.72

= 809.84

~ 827.28

= 825.09

= 817.58

~ 812.26

= 812.51


~ 819.15


820

815

810

-0+50

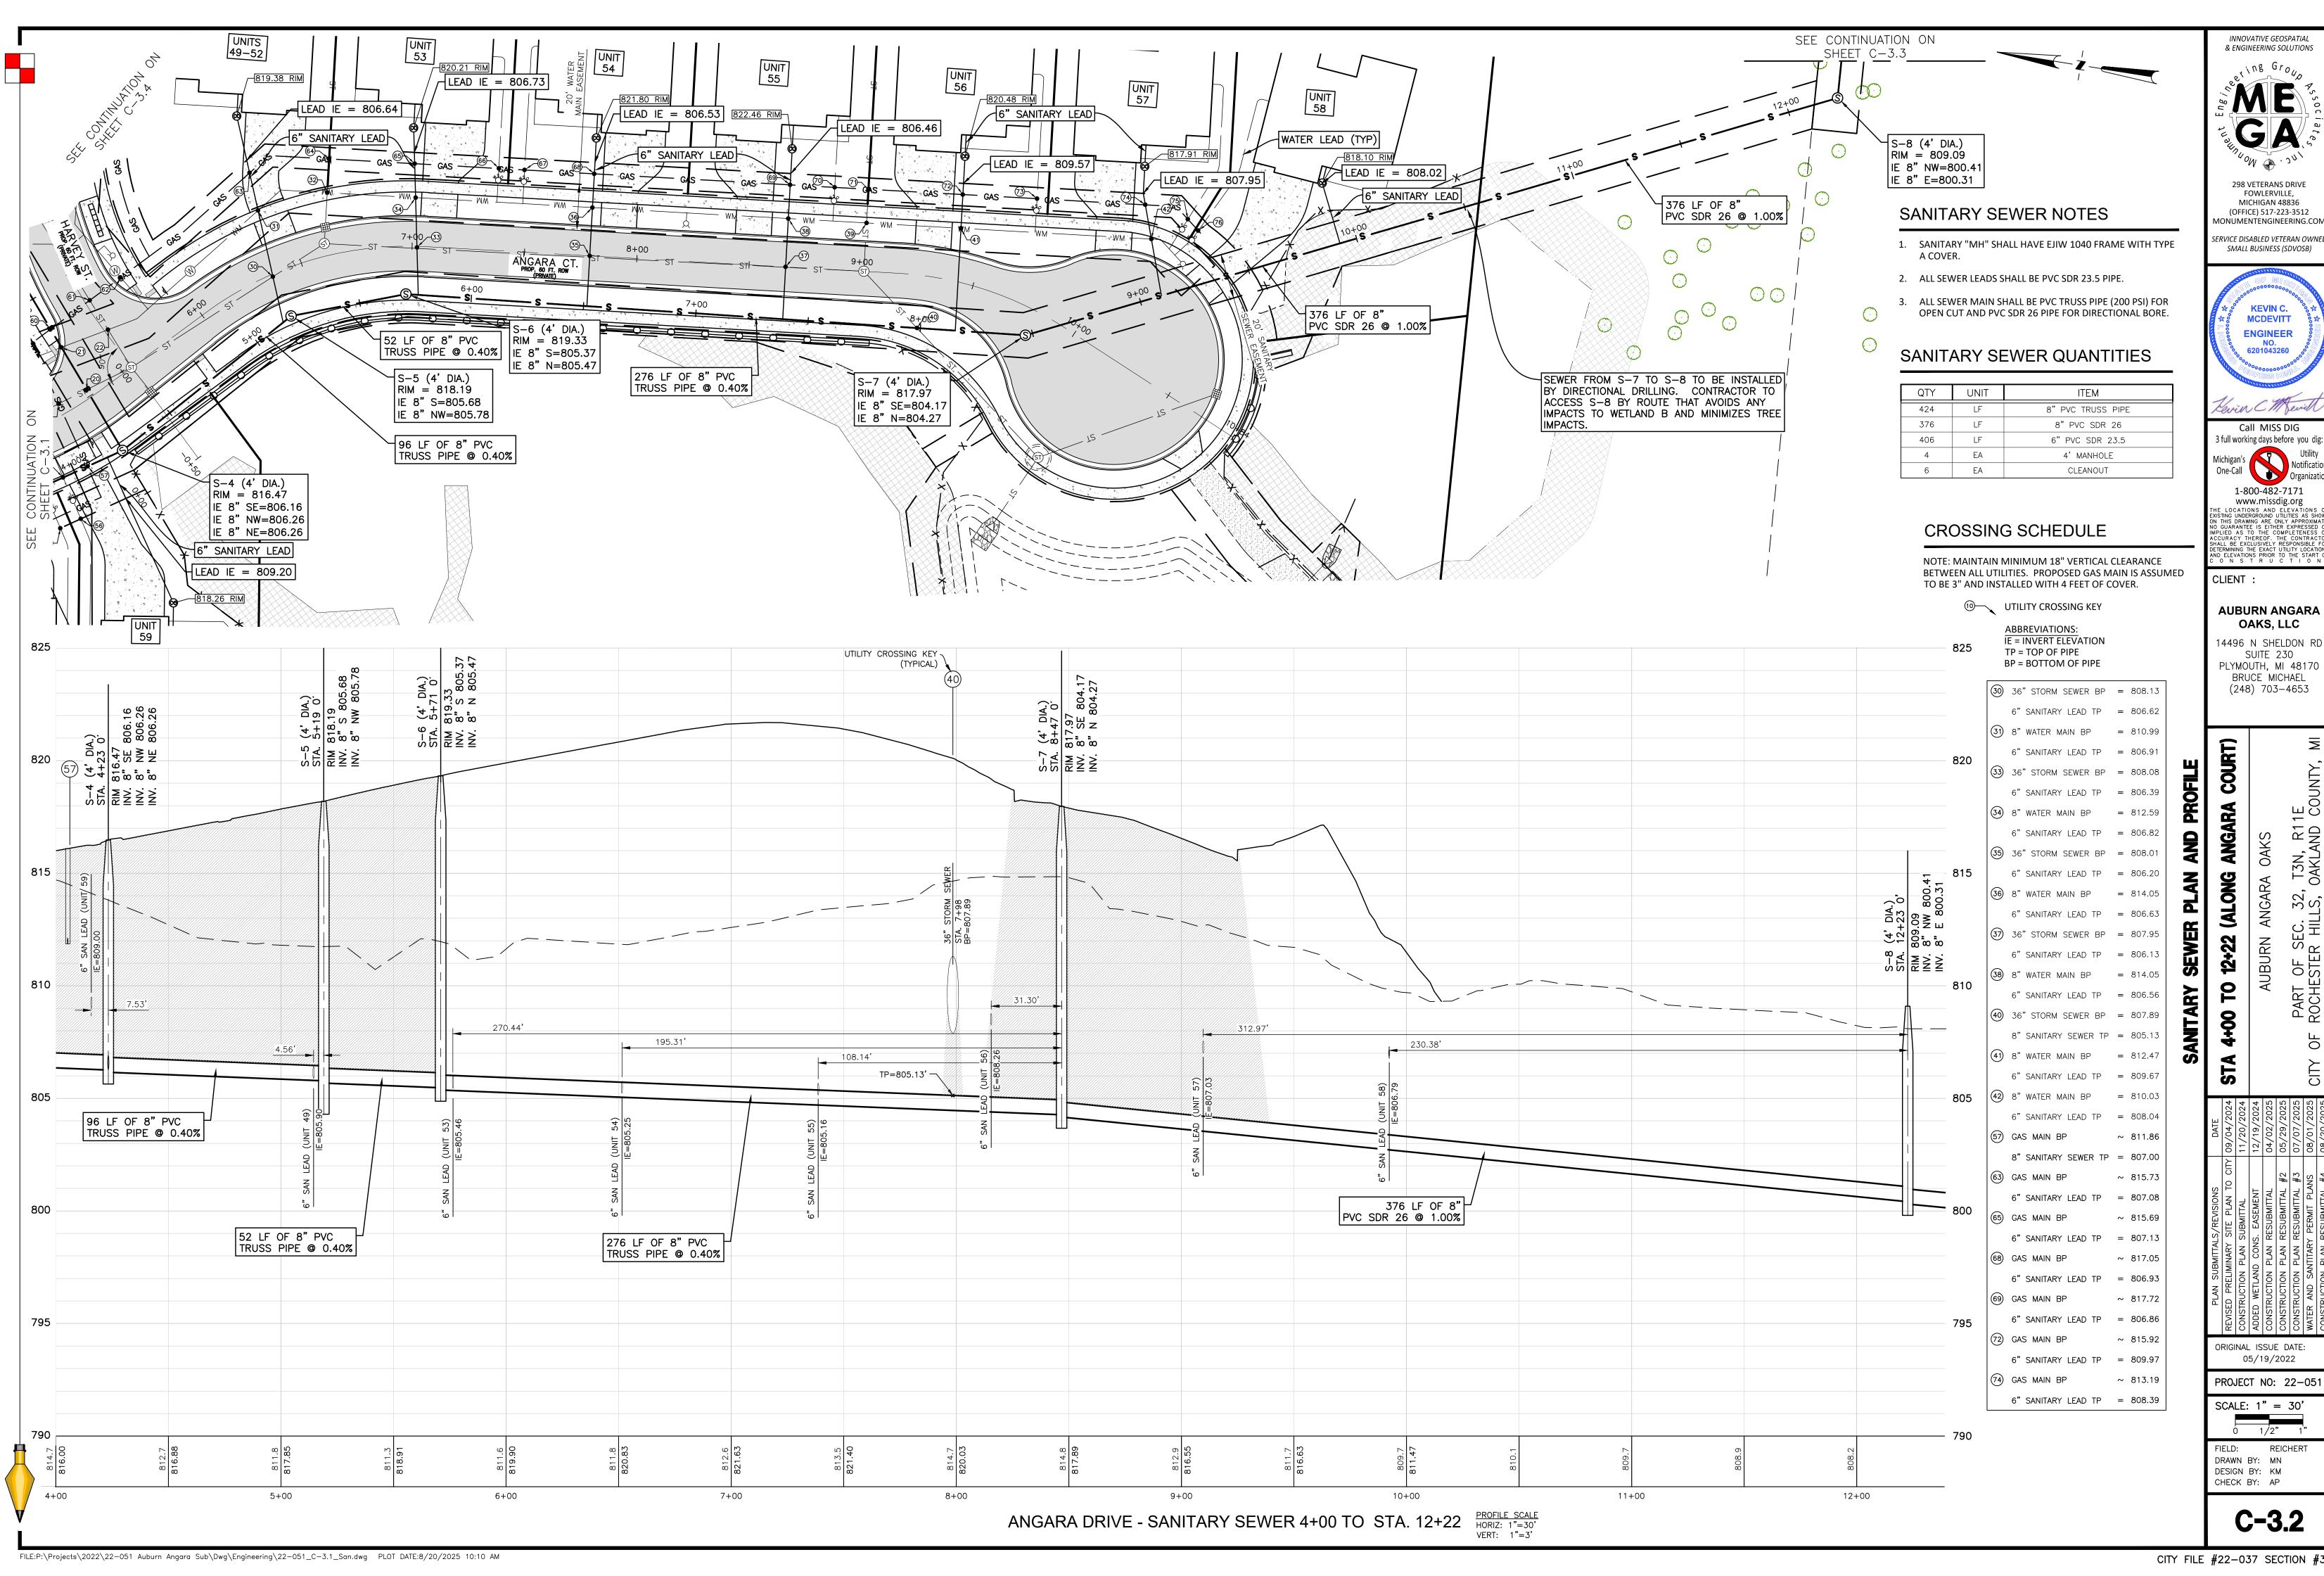

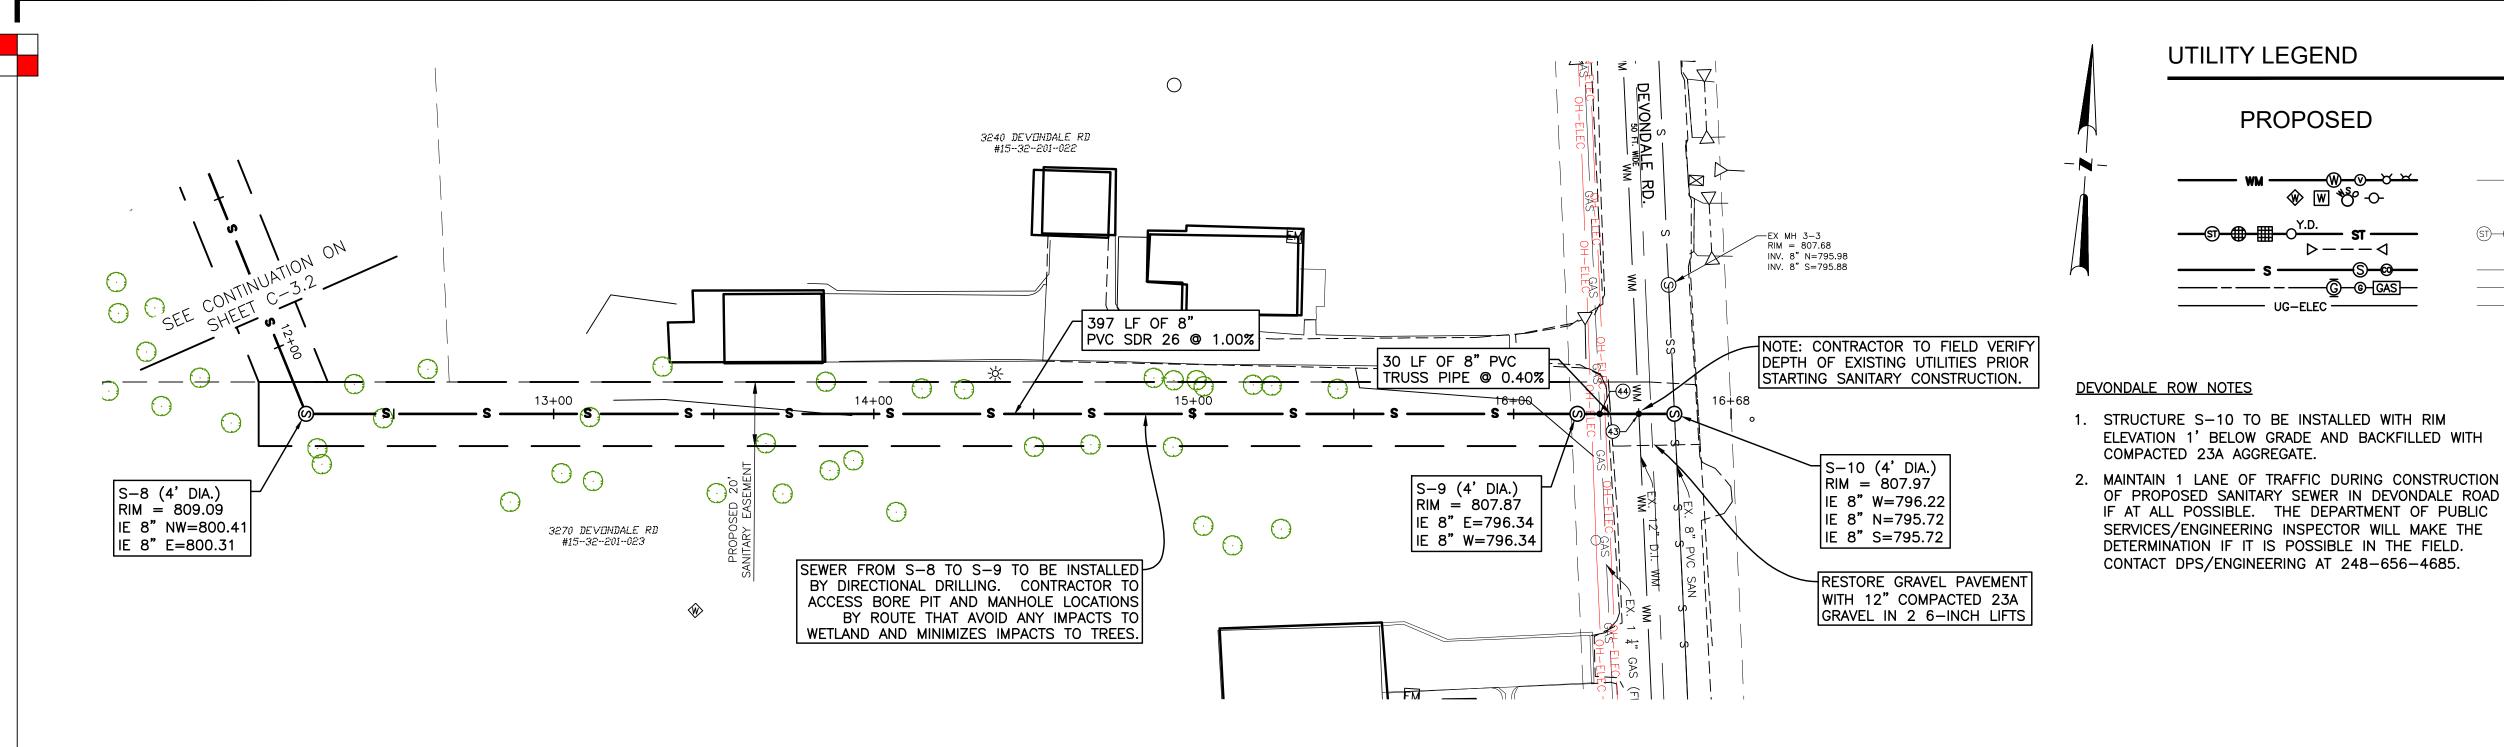

UTILITY LEGEND

PROPOSED

EXISTING

WATER MAIN, MH, VALVE IN BOX, HYDRANT WATER WELL, METER, STOP BOX, POST INDICATOR VALVE

STORM SEWER, MH, CB, INLET, DOWN SPOUT, YARD DRAIN CULVERT/ END SECTION SANITARY SEWER, MH, CLEAN OUT GAS GAS UG GAS, MH, VALVE, LINE MARKER

UG-ELEC UG ELEC (ELEC, CABLE, FIBER)

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DETERMINING THE EXACT UTILITY LOCATION
AND ELEVATIONS PRIOR TO THE START (
C O N S T R U C T I O N

CLIENT:

AUBURN ANGARA OAKS, LLC

14496 N SHELDON RD SUITE 230 PLYMOUTH, MI 48170 BRUCE MICHAEL (248) 703-4653

SOUTH)

0

(OFFSITE

2

SANITARY SEWER NOTES

- 1. SANITARY "MH" SHALL HAVE EJIW 1040 FRAME WITH TYPE A COVER.
- 2. ALL SEWER LEADS SHALL BE PVC SDR 23.5 PIPE.
- 3. ALL SEWER MAIN SHALL BE PVC TRUSS PIPE (200 PSI) FOR OPEN CUT AND PVC SDR 26 PIPE FOR DIRECTIONAL BORE.

SANITARY SEWER QUANTITIES

QTY	UNIT	ITEM
30	LF	8" PVC TRUSS PIPE
397	LF	8" PVC SDR 26 PIPE
3	EA	4' MANHOLE
1	EA	4' MANHOLE TAP

BETWEEN ALL UTILITIES. PROPOSED GAS MAIN IS ASSUMED TO BE 3" AND INSTALLED WITH 4 FEET OF COVER.

10 UTILITY CROSSING KEY

ABBREVIATIONS: IE = INVERT ELEVATION TP = TOP OF PIPE BP = BOTTOM OF PIPE

43)	EX. 12" WATER MAIN BP	=	~801.48
	8" SANITARY SEWER TP	=	796.93
44	EX. GAS MAIN BP	=	~805.4
	8" SANITARY SEWER TP	=	796 98

CROSSING SCHEDULE

NOTE: MAINTAIN MINIMUM 18" VERTICAL CLEARANCE

_				
	43)	EX. 12" WATER MAIN BP	=	~801.48
		8" SANITARY SEWER TP	=	796.93
	44)	EX. GAS MAIN BP	=	~805.4
		8" SANITARY SEWER TP	=	796.98

ORIGINAL ISSUE DATE:

PROJECT NO: 22-051 SCALE: 1" = 30'

05/19/2022

1/2" FIELD: REICHERT DRAWN BY: MN DESIGN BY: KM CHECK BY: AP

C - 3.3

-8 TO BE | FILE:P:\Projects\2022\22-051 Auburn Angara Sub\Dwg\Engineering\22-051_C-3.1_San.dwg | PLOT DATE:8/20/2025 10:10 AM

13+00

397 LF OF 8" PVC SDR 26 @ 1.00%

810

805

12+00

AT AVOID

825

820

810

805

800

795

17+50

UTILITY CROSSING KEY -

30 LF OF 8" PVC TRUSS PIPE @ 0.40%

INSTALL 1' DEEP SUMP FOR TESTING.
SUMP TO BE FILLED WITH CONCRETE
AFTER SUCCESSFUL PASSING OF
APPLICABLE TESTS.

OFFSITE - SANITARY SEWER STA. 12+22 TO STA 17+00

PROFILE SCALE
HORIZ: 1"=30' VERT: 1"=3'

(TYPICAL)

10 (4° DIA.) 10 (4° DIA.) 16+50 0′ 807.97 8" W 796.2 8" N 795.7 8" S 795.7

STA.

BP=805.4'

(ASSUMED BP BASED ON 3' COVER)

- BP=801.48'

ON 6' COVER)

✓ TP=796.93'

EX. 12" D.I. WATER MAIN (DEPTH UNKNOWN)

(ASSUMED BP BASED

INSTALL TEMPORARY MECHANICAL STYLE

17+00

WATER TIGHT BULKHEADS. TO BE REMOVED ONLY AFTER SUCCESSFUL COMPLETION OF APPLICABLE TESTS.

EX. 1 ½" PLASTIC GAS MAIN (FROM MAPPING, DEPTH UNKNOWN)

CITY FILE #22-037 SECTION #32

WATER MAIN, MH, VALVE IN BOX, HYDRANT WATER WELL, METER, STOP BOX, POST INDICATOR VALVE

STORM SEWER, MH, CB, INLET, DOWN SPOUT, YARD DRAIN CULVERT/ END SECTION SANITARY SEWER, MH, CLEAN OUT GAS GAS UG GAS, MH, VALVE, LINE MARKER UG-ELEC UG ELEC (ELEC, CABLE, FIBER)

- 3. ALL SEWER MAIN SHALL BE PVC SDR 26 PIPE FOR OPEN
- 4. ALL SANITARY LEADS SHALL HAVE CLEANOUTS INSTALLED A MAXIMUM 5' FROM THE BUILDING FACE. BUILDING CLEANOUTS SHALL BE IDENTIFIED ON THE BUILDING MEP

SANITARY SEWER QUANTITIES

	QTY	UNIT	ITEM
,	265	LF	8" PVC TRUSS PIPE
	79	LF	6" PVC SDR 23.5
	2	EA	4' MANHOLE
	1	EA	8" BULKHEAD
	2	EA	CLEANOUT

CROSSING SCHEDULE

NOTE: MAINTAIN MINIMUM 18" VERTICAL CLEARANCE BETWEEN ALL UTILITIES. PROPOSED GAS MAIN IS ASSUMED TO BE 3" AND INSTALLED WITH 4 FEET OF COVER.

10 UTILITY CROSSING KEY

ABBREVIATIONS: IE = INVERT ELEVATION TP = TOP OF PIPE BP = BOTTOM OF PIPE

20	24" STORM SEWER BP	=	808.90
	8" SANITARY SEWER TP	=	807.04
21	8" WATER MAIN BP	=	808.84
	8" SANITARY SEWER TP	=	807.14
23)	4" WATER LEAD / FIRE SUPPRESSION BP	=	809.02
	8" SANITARY SEWER TP	=	807.35
25)	12" STORM SEWER BP	=	809.19
	8" SANITARY SEWER TP	=	807.49
27)	8" SANITARY SEWER BP	=	806.93
	4" WATER LEAD / FIRE SUPPRESSION TP	=	805.43
29	12" STORM SEWER BP	=	809.61
	6" SANITARY LEAD TP	=	808.11
60	GAS MAIN BP	~	811.58
	8" SANITARY SEWER TP	=	807.18

SANITARY SEWER NOTES

- 1. SANITARY "MH" SHALL HAVE EJIW 1040 FRAME WITH TYPE A COVER.
- 2. ALL SEWER LEADS SHALL BE PVC SDR 23.5 PIPE.
- CUT AND PVC C 900 LOCK JOINT PIPE FOR DIRECTIONAL

20	24" STORM SEWER BP	=	808.90
	8" SANITARY SEWER TP	=	807.04
21)	8" WATER MAIN BP	=	808.84
	8" SANITARY SEWER TP	=	807.14
23)	4" WATER LEAD / FIRE SUPPRESSION BP	=	809.02
	8" SANITARY SEWER TP	=	807.35
25)	12" STORM SEWER BP	=	809.19
	8" SANITARY SEWER TP	-	807.49
27)	8" SANITARY SEWER BP	=	806.93
	4" WATER LEAD / FIRE SUPPRESSION TP	=	805.43
29	12" STORM SEWER BP	=	809.61
	6" SANITARY LEAD TP	=	808.11
60	GAS MAIN BP	~	811.58
	8" SANITARY SEWER TP	-	807.18

2+94 (ALONG HARVE OAKS ANGARA JBURN 2 9 STA

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AUBURN ANGARA OAKS, LLC

14496 N SHELDON RD SUITE 230 PLYMOUTH, MI 48170 BRUCE MICHAEL

(248) 703-4653

CLIENT:

STREET)

IMINARY SITE PLAN TO CITY 09/04/2024	09/04/2024	
PLAN SUBMITTAL	11/20/2024	
ND CONS. EASEMENT	12/19/2024	
PLAN RESUBMITTAL	04/02/2025	
PLAN RESUBMITTAL #2	05/29/2025	
PLAN RESUBMITTAL #3	07/07/2025	
antitary permit plans	08/01/2025	


ORIGINAL ISSUE DATE:

05/19/2022 PROJECT NO: 22-051

SCALE: SEE ABOVE 1/2" FIELD: REICHERT

DRAWN BY: MN DESIGN BY: KM CHECK BY: AP

C-3.4

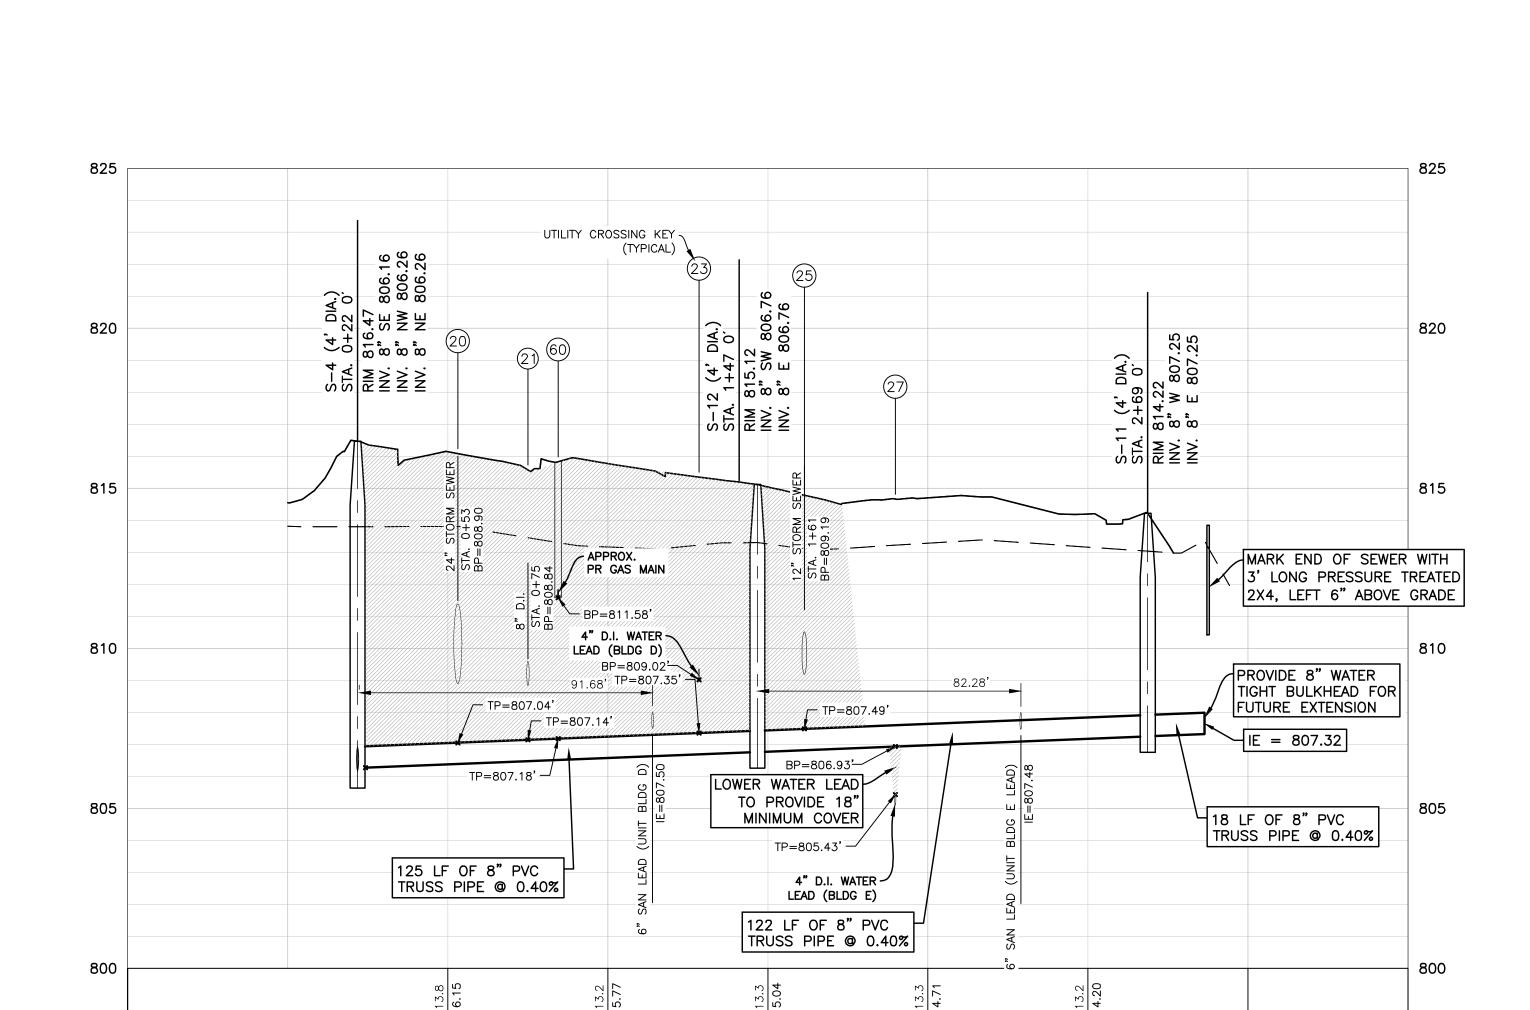

BLDG E (UNITS 41-48)

S-12 (4' DIA.) RIM = 815.12 IE 8" SW=806.76

IE 8" E=806.76

125 LF OF 8" PVC TRUSS PIPE @ 0.40%

122 LF OF 8" PVC TRUSS PIPE @ 0.40%

5" SANITARY LEAD [∕

S-11 (4' DIA.)

RIM = 814.22

IE 8" W=807.25 IE 8" E=807.25

> 18 LF OF 8" PVC TRUSS PIPE @ 0.40%

> > PROVIDE 8" WATER TIGHT BULKHEAD FOR

- IE = 807.32

FUTURE EXTENSION

3+00

3+50

BLDG D

(UNITS 32-40)

6" SANITARY LEAD

IE = 808.04

IE 8" SE=806.16 IE 8" NW=806.26

TIE 8" NE=806.26

HARVEY STREET - SANITARY SEWER S-11 TO S-4 PROFILE SCALE
HORIZ: 1"=30'
VERT: 1"=3'

1+00

2+00

-0+50

2433 W AUBURN RD #15-32-201-032

23 LF 1" TYPE K COPPER DOMESTIC WATER LEAD (TYP.)

-|65 LF 8" D.I. WM

STA. 2+24

11.25° D.I. BEND

/ 5 LF 8" D.I. WM

STA. 2+30

11.25° D.I. BEND | ∫

FARMSTAND

21 LF 2" TYPE K COPPERDOMESTIC WATER LEAD

(UNITS 23-31)

67 LF 4" CL 54 D.I

FIRE PROTECTION LINE

BLDG D

(UNITS 32-40)

SHEET C-4.2

19 LF 8" D.I. WM

STA. 3+83, 2.0' I

SEE CONTINUATION ON

√147 LF 8" D.I. WM

8" x 6" x 8" D.I. TEE

22.5° D.I. BEND

22.5° D.I. BEND

140 LF 1" TYPE K COPPER DOMESTIC WATER LEAD

UNITS

DOMESTIC WATER LEAD

153 LF 1" TYPE K COPPER

ີ|STA. 3+98

STA. 4+87

ქ5 LF 8" D.I. WM├

22.5° D.I. BEND STA. 4+81

20 LF 8" D.I. WM

2449 W AUBURN RD LOT 14, EXCEPT THE S. 28' #15-32-201-005

ATTACHED ROWHOUSES

22.5° D.I. BEND

|12 LF 8" D.I. WM├

STA. 1+02

22.5° D.I. BEND

FDC

96 LF 8" D.I. WM

6" SANITARY LEAD (TYP)

21 LF 2" TYPE K COPPER

DOMESTIC WATER LEAD

BLDG A

(UNITS 6-13)

68 LF 4" CL 54 D.I.

FIRE PROTECTION LINE

STA. 1+15

4 LF 8" D.I. WM

22.5° D.I. BEND

┤12 LF 8" D.I. WM│

24 LF 8" D.I. WM

HYD-2

∏STA. 1+57, 3.8' ι

| 4 LF 6" D.I.

STA. 1+57

121 LF 2" TYPE K COPPER

DOMESTIC WATER LEAD

BLDG B

(UNITS 14-22)

68 LF 4" CL 54 D.I.

FIRE PROTECTION LINE

8" x 6" x 8" D.I. TEE


 \Box STA. 1+20

_ 22.5° D.I. BEND

STA. 1+32

PROPOSED

EXISTING

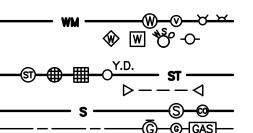

WATER MAIN, MH, VALVE IN BOX, HYDRANT WATER WELL, METER, STOP BOX, POST INDICATOR VALVE STORM SEWER, MH, CB, INLET, DOWN SPOUT, YARD DRAIN

CULVERT/ END SECTION SANITARY SEWER, MH, CLEAN OUT — GAS — GAS — UG GAS, MH, VALVE, LINE MARKER UG ELEC (ELEC, CABLE, FIBER)

WATER NOTES

- WATER MAIN TO BE INSTALLED WITH 6' EARTH COVER PER CITY OF ROCHESTER HILLS DESIGN STANDARDS.
- PROPOSED MULTIFAMILY BUILDINGS A THROUGH E ARE TO HAVE SPRINKLED FIRE SUPPRESSION. SIAMESE CONNECTION TO BE INSTALLED NEAR MAIN ENTRANCE ON SIDE FACING STREET.
- WATER MAIN TO BE CONSTRUCTED BY EXTENDING THE EXISTING 8 INCH WATER LINE CROSSING AUBURN ROAD TO THE EXISTING HYDRANT AFTER REMOVING THE HYDRANT AND CLOSING THE 8" VALVE IN AUBURN ROAD.

CONTRACTOR SHALL PROVIDE BRACING WITHIN THE EXISTING GATE WELL TO ENSURE THAT THE GATE VALVE CAN NOT SEPARATE UPON REMOVAL OF THE EXISTING HYDRANT TEE.

WATER VALVE IS TO REMAIN CLOSED UNTIL NEW WATER MAIN HAS BEEN ACCEPTED BY THE CITY OF ROCHESTER HILLS AFTER PASSING ALL PRESSURE AND BACTERIOLOGICAL TESTING.

EXISTING HYDRANT REMOVED IN AUBURN ROAD SHALL NOT BE USED ON THE PROJECT AND SHALL BE RETURNED TO CITY OF ROCHESTER HILLS DPS.

WATER MAIN QUANTITIES

QTY	UNIT	ITEM
493	LF	8" DI CL 54 WATER MAIN
18	LF	6" DI CL 54 WATER MAIN
382	LF 4" DI CL 54 PRIVATE FIRE SUPPRE	
117	LF	2" TYPE K COPPER WATER SERVICE
408	LF	1" TYPE K COPPER WATER SERVICE
3	EA	STANDARD HYDRANT ASSEMBLY

NOTE: MAINTAIN MINIMUM 18" VERTICAL CLEARANCE TO BE 3" AND INSTALLED WITH 4 FEET OF COVER.

	BP = BOTTOM	OF	PIPE
2	4" WATER LEAD / FIRE SUPPRESSION BP	=	825.99
	8" SANITARY SEWER TP	=	819.74
4	8" WATER MAIN BP	=	817.92
	6" SANITARY LEAD TP	=	816.14
6	12" STORM SEWER BP	=	818.89
	4" WATER LEAD / FIRE SUPPRESSION TP	=	817.39
7	4" WATER LEAD / FIRE SUPPRESSION BP	=	817.76
	8" SANITARY SEWER TP	=	814.39
8	12" STORM SEWER BP	=	816.73
	8" WATER MAIN TP	=	815.17
10	6" SANITARY LEAD BP	=	815.83
	8" WATER MAIN TP	=	814.33
12	12" STORM SEWER BP	=	812.23
	4" WATER LEAD / FIRE SUPPRESSION TP	=	810.73
13	4" WATER LEAD / FIRE SUPPRESSION BP	=	810.56
	8" SANITARY SEWER TP	=	809.03
15	12" STORM SEWER BP	=	810.90
	8" WATER MAIN TP	=	809.00
16	24" STORM SEWER BP	=	808.97
	1" WATER LEAD TP	=	807.47
17	1" WATER LEAD BP	=	809.72
	8" SANITARY SEWER TP	=	807.09
18	24" STORM SEWER BP	=	808.95
	1" WATER LEAD TP	=	807.45
19	1" WATER LEAD BP	=	809.84
	8" SANITARY SEWER TP	=	807.05
21)	8" WATER MAIN BP	=	808.84
	8" SANITARY SEWER TP	=	807.14
46	GAS MAIN BP	~	827.36
	4" FIRE SUPPRESSION TP 1" WATER LEAD TP	=	825.61
49	GAS MAIN BP	~	819.11
	4" FIRE SUPPRESSION TP 1" WATER LEAD TP	=	817.36
52	GAS MAIN BP	~	812.14
	4" FIRE SUPPRESSION TP 1" WATER LEAD TP	=	810.39
(55)	GAS MAIN BP	~	812.00
	1" WATER LEAD TP	=	810.25
56	GAS MAIN BP	~	812.30
	1" WATER LEAD TP	=	810.55
59	GAS MAIN BP	~	811.53

8" WATER MAIN TP

= 809.38

QTY	UNIT	ITEM
493	LF	8" DI CL 54 WATER MAIN
18	LF	6" DI CL 54 WATER MAIN
382	LF	4" DI CL 54 PRIVATE FIRE SUPPRESSION
117	LF	2" TYPE K COPPER WATER SERVICE
408	LF	1" TYPE K COPPER WATER SERVICE
3	FΔ	STANDARD HYDRANT ASSEMBLY

CROSSING SCHEDULE

BETWEEN ALL UTILITIES. PROPOSED GAS MAIN IS ASSUMED

10 UTILITY CROSSING KEY

ABBREVIATIONS: IE = INVERT ELEVATION TP = TOP OF PIPE BP = BOTTOM OF PIPE

4" WATER LEAD / FIRE SUPPRESSION BP	=	825.99
8" SANITARY SEWER TP	=	819.74
8" WATER MAIN BP	=	817.92
6" SANITARY LEAD TP	=	816.14
12" STORM SEWER BP	=	818.89
4" WATER LEAD / FIRE SUPPRESSION TP	=	817.39
4" WATER LEAD / FIRE SUPPRESSION BP	=	817.76
8" SANITARY SEWER TP	=	814.39
12" STORM SEWER BP	=	816.73
8" WATER MAIN TP	=	815.17
6" SANITARY LEAD BP	=	815.83
8" WATER MAIN TP	=	814.33
12" STORM SEWER BP	=	812.23
4" WATER LEAD / FIRE SUPPRESSION TP	=	810.73
4" WATER LEAD / FIRE SUPPRESSION BP	=	810.56
8" SANITARY SEWER TP	=	809.03
12" STORM SEWER BP	=	810.90
8" WATER MAIN TP	=	809.00
24" STORM SEWER BP	=	808.97
1" WATER LEAD TP	=	807.47
1" WATER LEAD BP	=	809.72
8" SANITARY SEWER TP	=	807.09
24" STORM SEWER BP	=	808.95
1" WATER LEAD TP	=	807.45
1" WATER LEAD BP	=	809.84
8" SANITARY SEWER TP	=	807.05
8" WATER MAIN BP	=	808.84
8" SANITARY SEWER TP	=	807.14
GAS MAIN BP	~	827.36
4" FIRE SUPPRESSION TP 1" WATER LEAD TP	=	825.61
GAS MAIN BP	~	819.11
4" FIRE SUPPRESSION TP 1" WATER LEAD TP	=	817.36
GAS MAIN BP	~	812.14
4" FIRE SUPPRESSION TP 1" WATER LEAD TP	=	810.39
GAS MAIN BP	~	812.00
1" WATER LEAD TP	=	810.25
GAS MAIN BP	~	812.30
1" WATER LEAD TP	=	810.55
CAS MAIN RP	~	811 53

ing Group 298 VETERANS DRIVE FOWLERVILLE,

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CLIENT:

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14496 N SHELDON RD SUITE 230 PLYMOUTH, MI 48170 BRUCE MICHAEL (248) 703-4653

ORIGINAL ISSUE DATE: 05/19/2022

PROJECT NO: 22-051 SCALE: 1" = 30'

1/2" FIELD: REICHERT DRAWN BY: MN DESIGN BY: KM CHECK BY: AP

C-4.1

ARROW #2

8<u>31.</u>89

23 LF 1" TYPE K COPPERH

DOMESTIC WATER LEAD (TYP.)

33 LF 2" TYPE K COPPER

CAUTION!!

INGRESS/EGRESS. 834.96

— | NM ||-

REMOVE EXISTING 8"X6"

HYDRANT TEE AND EXTEN

OH WIRES CROSS

CLOSE EXISTING VALVE DURING CONSTRUCTION. SEE NOTE 3.

FIRE PROTECTION LINE

STA. 0+05, 6.9' L

7 LF 6" D.I.


8" WATER MAIN

4 LF 8" D.I. WM

STA. 0+05

′ × 6″ × 8″ D.I. TEE

DEFLECT WATER MAIN THROUGH 2 JOINTS TOTAL ANGLE 5'53'

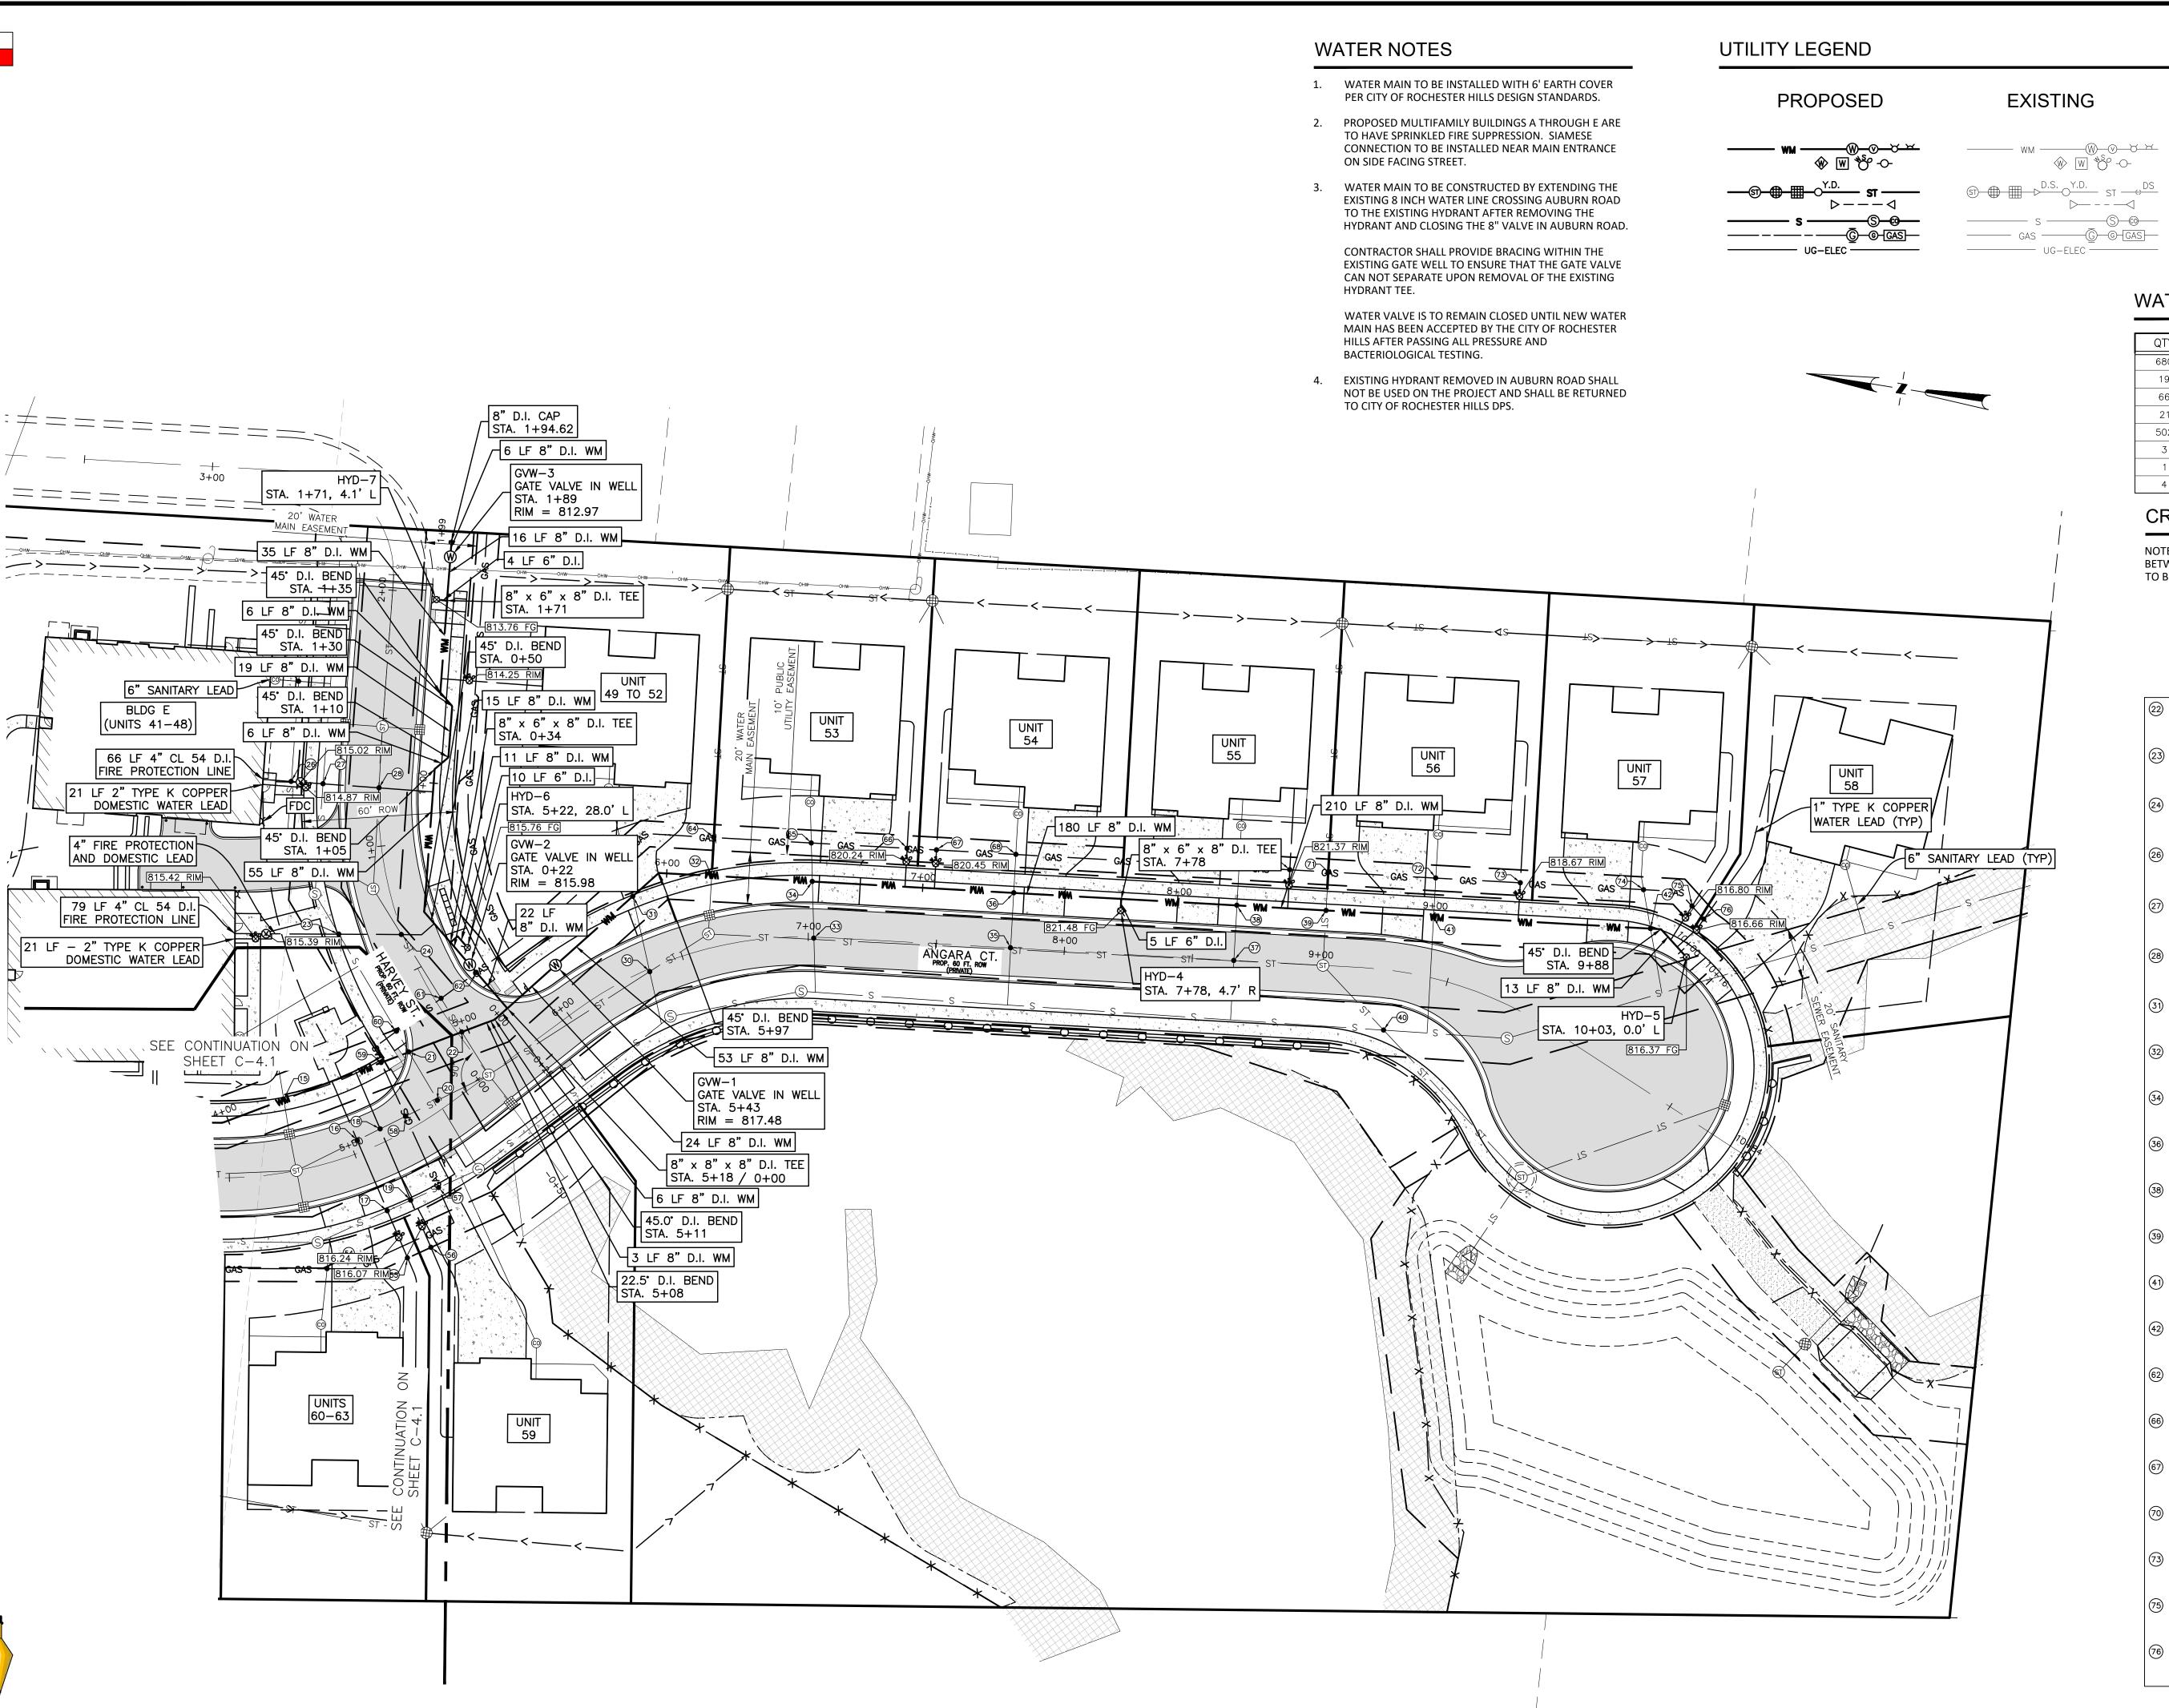

WATER MAIN, MH, VALVE IN BOX, HYDRANT WATER WELL, METER, STOP BOX, POST INDICATOR VALVE

STORM SEWER, MH, CB, INLET, DOWN SPOUT, YARD DRAIN CULVERT/ END SECTION SANITARY SEWER, MH, CLEAN OUT UG ELEC (ELEC, CABLE, FIBER)

WATER MAIN QUANTITIES

QTY	UNIT	ITEM
680	LF	8" DI CL 54 WATER MAIN
19	LF	6" DI CL 54 WATER MAIN
66	LF	4" DI CL 54 PRIVATE FIRE SUPPRESSION
21	LF	2" TYPE K COPPER WATER SERVICE
502	LF	1" TYPE K COPPER WATER SERVICE
3	EA	8" GATE VALVE IN WELL
1	EA	8" D.I. CAP
4	EA	STANDARD HYDRANT ASSEMBLY

CROSSING SCHEDULE

NOTE: MAINTAIN MINIMUM 18" VERTICAL CLEARANCE BETWEEN ALL UTILITIES. PROPOSED GAS MAIN IS ASSUMED TO BE 3" AND INSTALLED WITH 4 FEET OF COVER.

10 UTILITY CROSSING KEY

ABBREVIATIONS: IE = INVERT ELEVATION TP = TOP OF PIPE BP = BOTTOM OF PIPE

	BP = BOTTON	/I OF	PIPE
<u></u>	18" STORM SEWER BP		808.53
(22)	8" WATER MAIN TP		807.03
(23)	4" WATER LEAD/FIRE		
23)	SUPPRESSION BP		809.02
\bigcirc	8" SANITARY SEWER TP		807.35
(24)	18" STORM SEWER BP	=	808.60
_	4" WATER LEAD/FIRE SUPPRESSION TP	=	807.10
26)	12" STORM SEWER BP	=	809.48
	4" FIRE SUPPRESSION TP 1" WATER LEAD TP	=	807.98
27)	8" SANITARY SEWER BP	=	806.93
	4" WATER LEAD/FIRE SUPPRESSION TP	=	805.43
28)	18" STORM SEWER BP	=	808.73
	4" WATER LEAD/FIRE SUPPRESSION TP	=	807.23
31)	8" WATER MAIN BP	=	810.99
	6" SANITARY LEAD TP	=	806.91
32	8" WATER MAIN BP	=	811.74
	12" STORM SEWER TP	=	809.83
34)	8" WATER MAIN BP	=	812.59
	6" SANITARY LEAD TP	=	806.82
36)	8" WATER MAIN BP	=	814.05
	6" SANITARY LEAD TP	=	806.63
38)	8" WATER MAIN BP	=	814.05
	6" SANITARY LEAD TP	=	806.56
39	8" WATER MAIN BP	=	813.41
	12" STORM SEWER TP	=	809.60
41)	8" WATER MAIN BP	=	812.47
	6" SANITARY LEAD TP	=	809.67
42	8" WATER MAIN BP	=	810.03
	6" SANITARY SEWER TP	=	808.04
62	GAS MAIN BP	~	811.95
	8" WATER MAIN TP	=	810.38
66	GAS MAIN BP	~	816.04
	1" WATER LEAD TP	=	814.29
67	GAS MAIN BP	~	816.30
	1" WATER LEAD TP	=	814.55
70	GAS MAIN BP	~	817.44
	1" WATER LEAD TP	=	815.69
73)	GAS MAIN BP	~	814.47
	4" WATER LEAD TR		810.70

= 812.72

~ 812.43

= 810.68

~ 812.59

= 810.84

1" WATER LEAD TP

1" WATER LEAD TP

1" WATER LEAD TP

(76) GAS MAIN BP

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KEVIN C. MCDEVITT ENGINEER 6201043260

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CLIENT:

AUBURN ANGARA OAKS, LLC

14496 N SHELDON RD SUITE 230 PLYMOUTH, MI 48170 BRUCE MICHAEL (248) 703-4653


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ORIGINAL ISSUE DATE: 05/19/2022

PROJECT NO: 22-051 SCALE: 1" = 30'

FIELD: REICHERT DRAWN BY: MN DESIGN BY: KM CHECK BY: AP

C-4.2

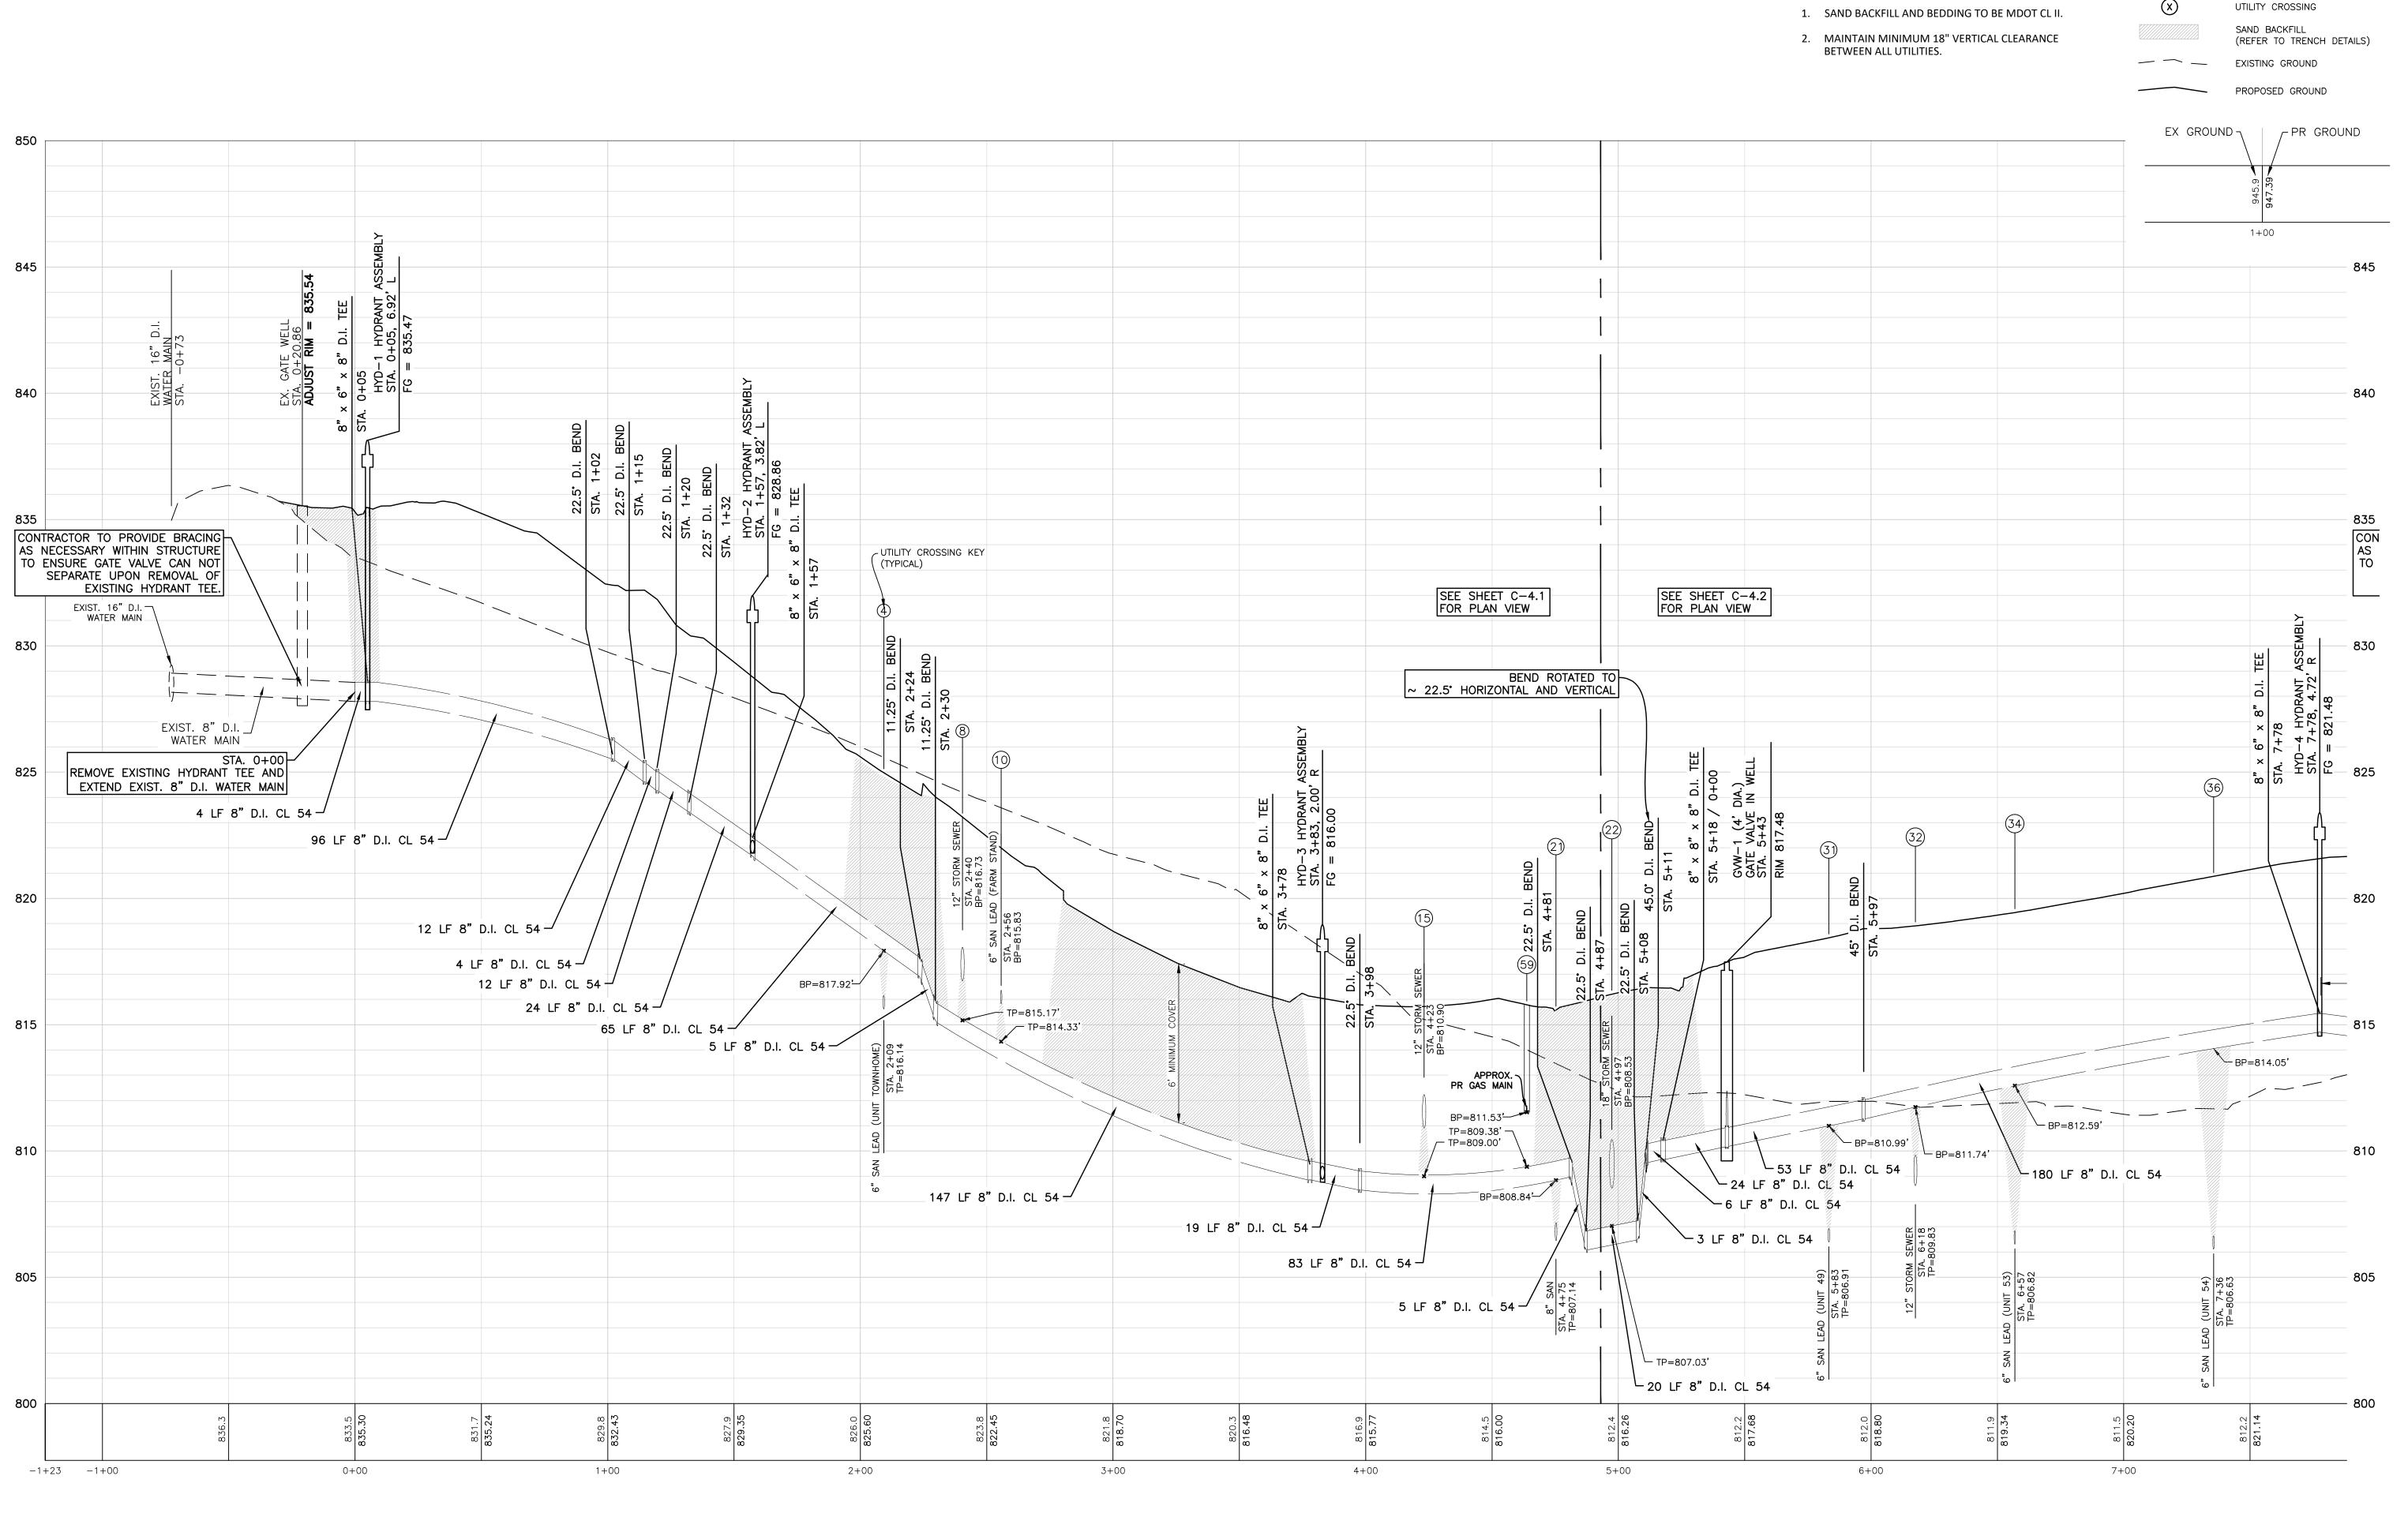

ANGARA DRIVE - WATER MAIN 0+00 TO 8+50

PROFILE SCALE
HORIZ: 1"=30"
VERT: 1"=3"

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PROFILE LEGEND

NOTES

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KEVIN C.

MCDEVITT

ENGINEER

NO.
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MAIN PROFILES

N ANGARA OAKS
SEC. 32, T3N, R11E
HILLS, OAKLAND COUNTY, N

WATER MAIN PRC
AUBURN ANGARA
ITY OF ROCHESTER HILLS, OAI

 UCTION
 PLAN
 SUBMITTAL
 11/20/2024

 WETLAND
 CONS.
 EASEMENT
 12/19/2024

 UCTION
 PLAN
 RESUBMITTAL
 #2
 05/29/2025

 UCTION
 PLAN
 RESUBMITTAL
 #3
 07/07/2025

 AND
 SANTITARY
 PERMIT
 PLANS
 08/01/2025

 UCTION
 PLAN
 RESUBMITTAL
 #4
 08/20/2025

ORIGINAL ISSUE DATE:

ORIGINAL ISSUE DATE: 05/19/2022

PROJECT NO: 22-051

SCALE: SEE ABOVE

0 1/2" 1"

FIELD: REICHERT

FIELD: REICHERT
DRAWN BY: MN
DESIGN BY: KM
CHECK BY: AP

C-4.3

NOTES

1. SAND BACKFILL AND BEDDING TO BE MDOT CL II.

2. MAINTAIN MINIMUM 18" VERTICAL CLEARANCE BETWEEN ALL UTILITIES.

PROFILE LEGEND

UTILITY CROSSING SAND BACKFILL (REFER TO TRENCH DETAILS) EXISTING GROUND

PROPOSED GROUND

EX GROUND 7 PR GROUND

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AND ELEVATIONS PRIOR TO THE START C
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MAIN PROFILES


OAKS

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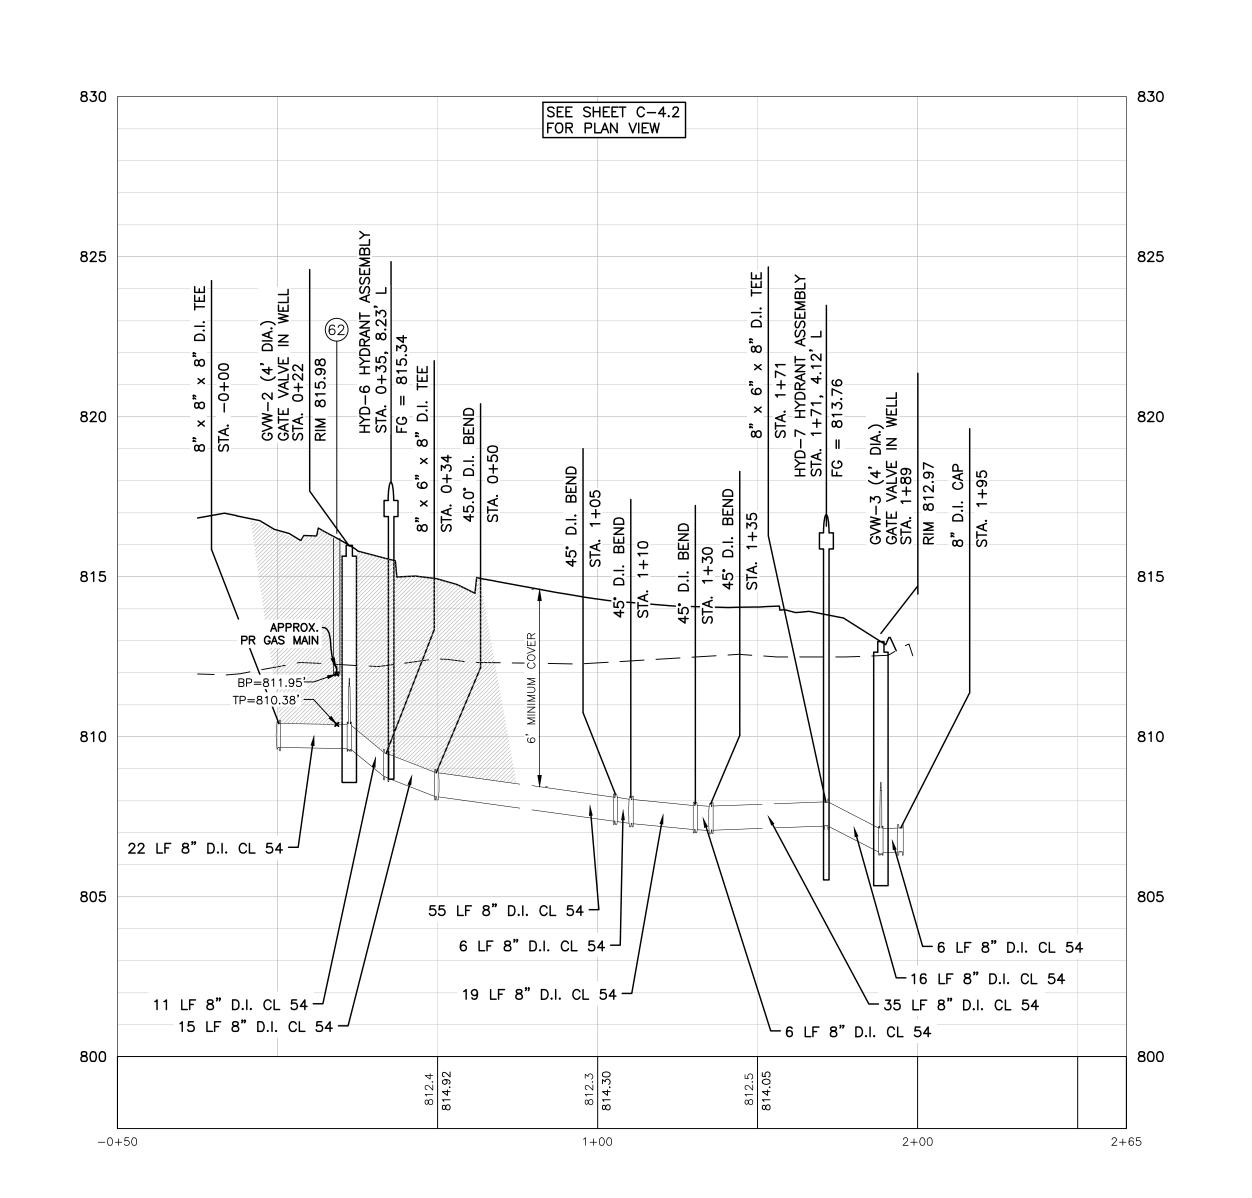
PROJECT NO: 22-051 SCALE: SEE ABOVE

FIELD: REICHERT DRAWN BY: MN DESIGN BY: KM CHECK BY: AP

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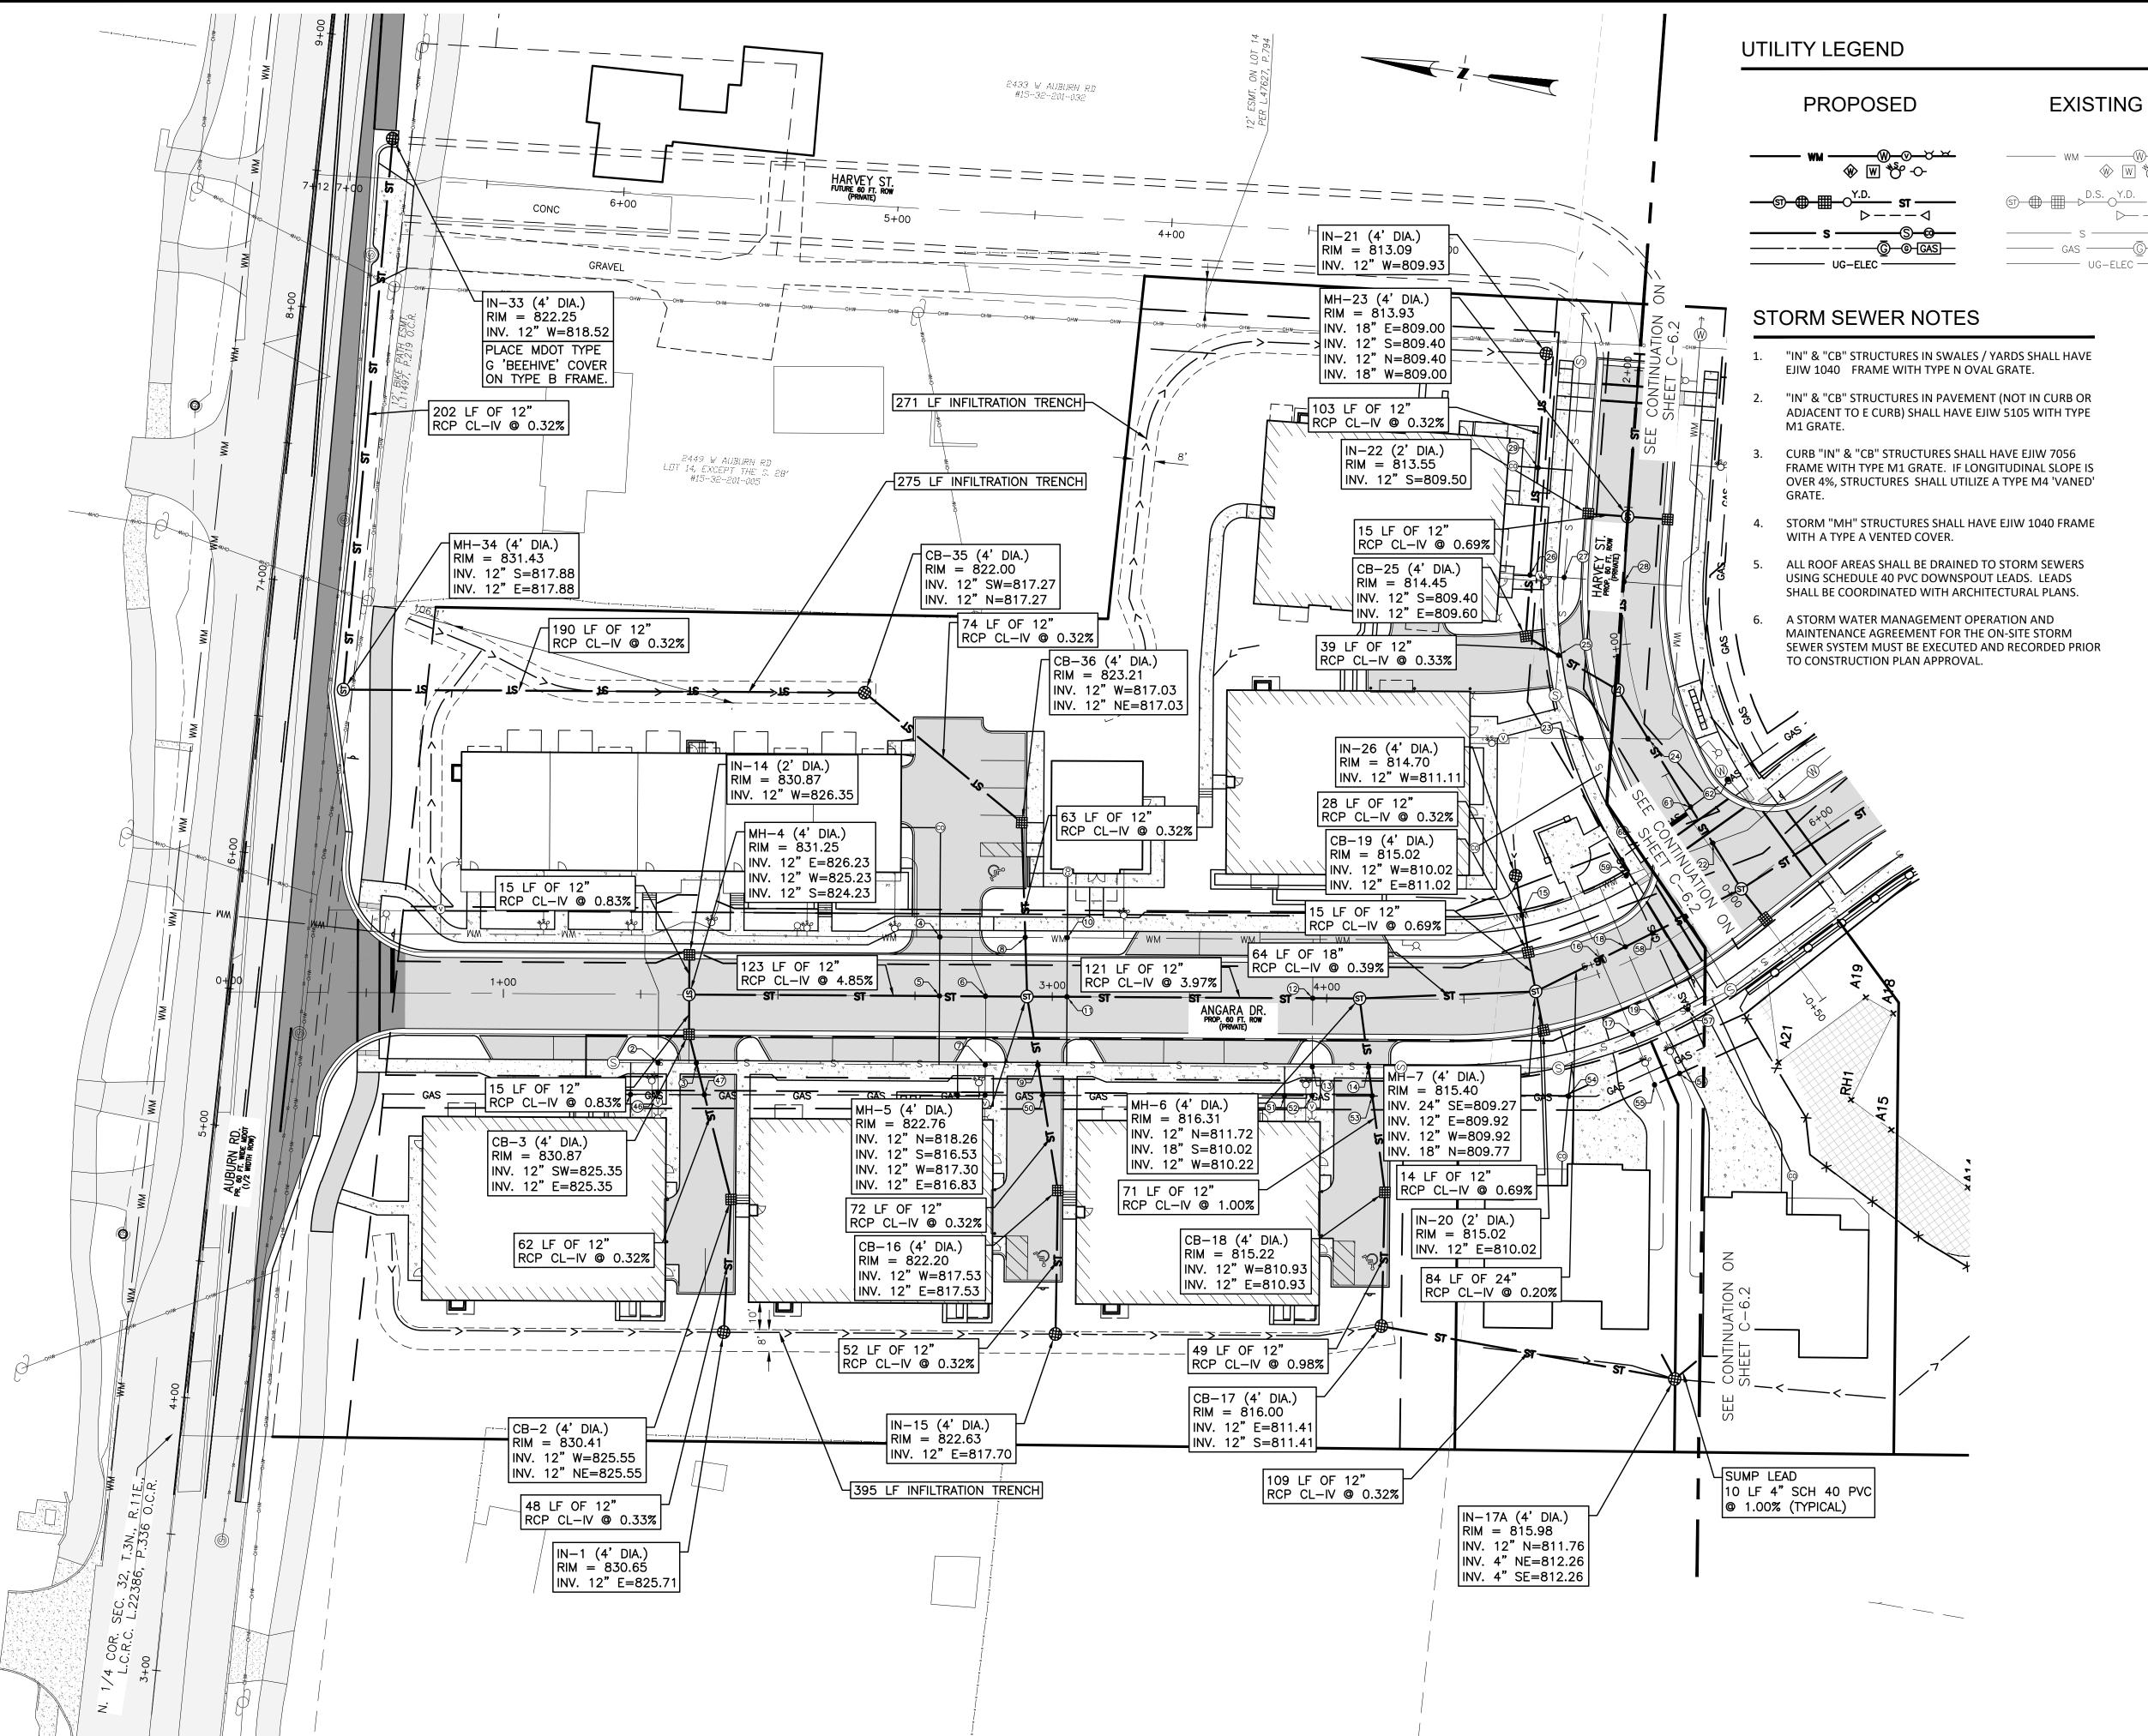




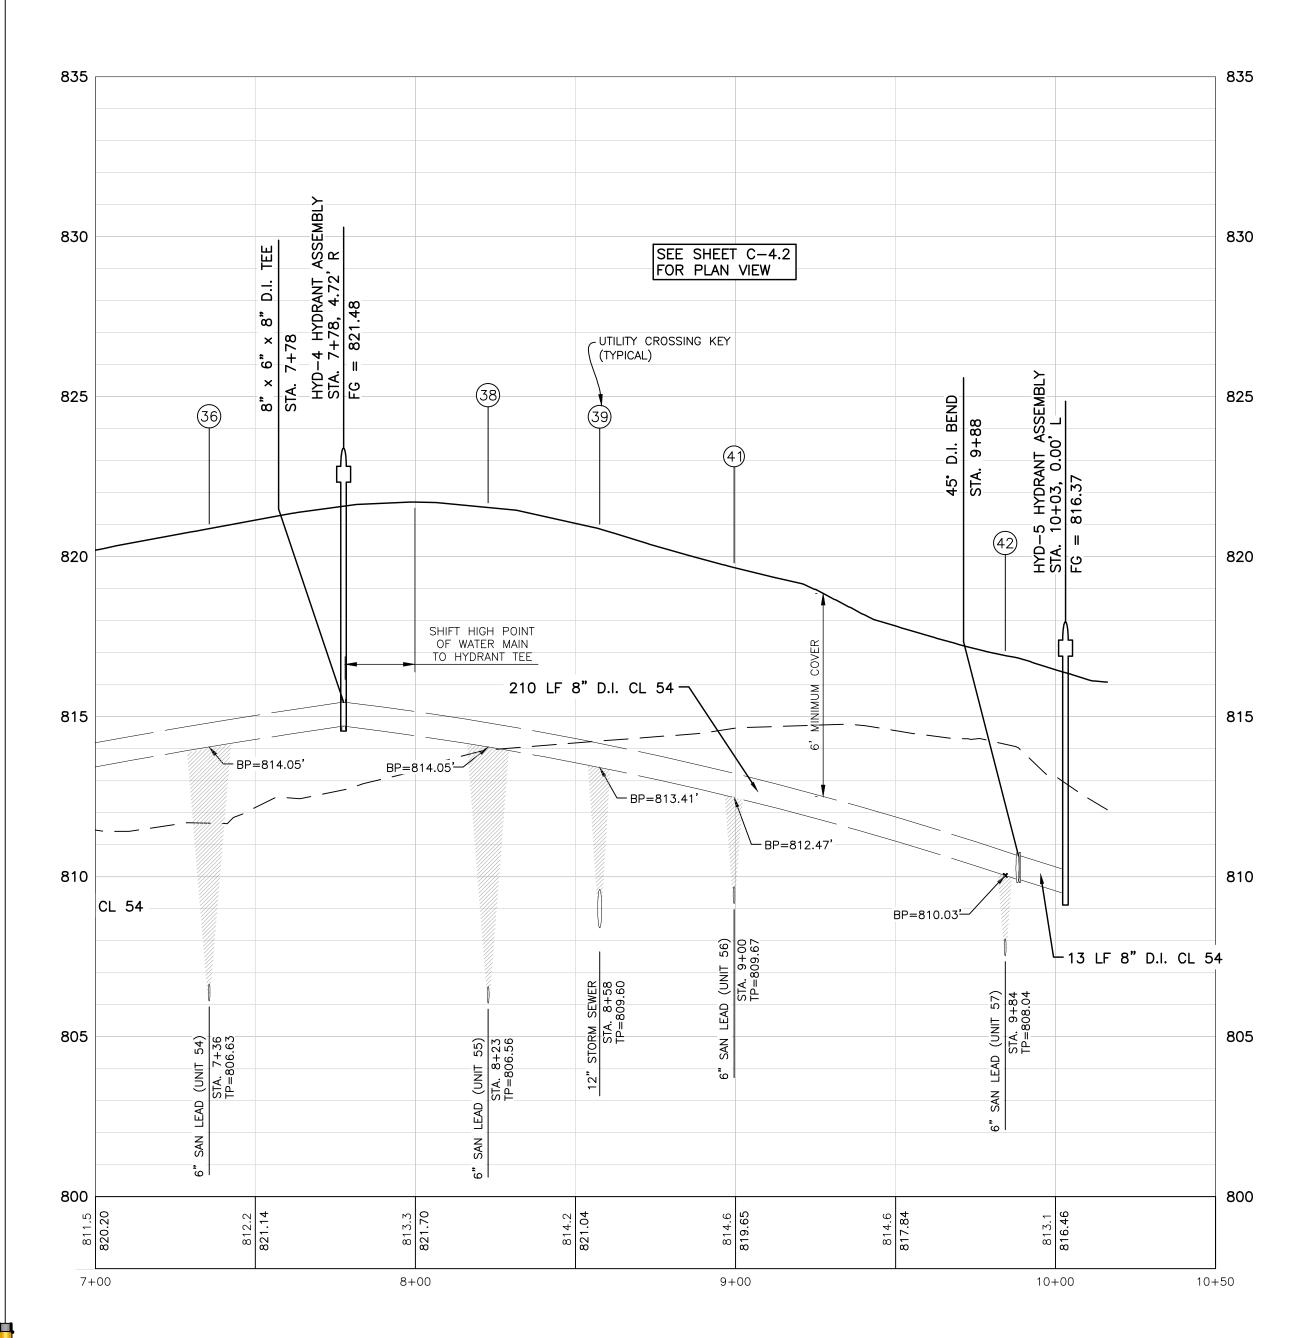

HARVEY STREET - WATER MAIN STA. 0+00 TO END

PROFILE SCALE
HORIZ: 1"=30'
VERT: 1"=3'



WATER MAIN, MH, VALVE IN BOX, HYDRANT WATER WELL, METER, STOP BOX, POST INDICATOR VALVE

STORM SEWER, MH, CB, INLET, DOWN SPOUT, YARD DRAIN CULVERT/ END SECTION SANITARY SEWER, MH, CLEAN OUT UG GAS, MH, VALVE, LINE MARKER

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MCDEVITT

ENGINEER

NO. 6201043260

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14496 N SHELDON RE

SUITE 230

PLYMOUTH, MI 48170

BRUCE MICHAEL

(248) 703-4653

OAKS

ANGARA

CLIENT:

UG ELEC (ELEC, CABLE, FIBER)

- "IN" & "CB" STRUCTURES IN SWALES / YARDS SHALL HAVE
- "IN" & "CB" STRUCTURES IN PAVEMENT (NOT IN CURB OR ADJACENT TO E CURB) SHALL HAVE EJIW 5105 WITH TYPE
- CURB "IN" & "CB" STRUCTURES SHALL HAVE EJIW 7056 FRAME WITH TYPE M1 GRATE. IF LONGITUDINAL SLOPE IS OVER 4%, STRUCTURES SHALL UTILIZE A TYPE M4 'VANED'
- STORM "MH" STRUCTURES SHALL HAVE EJIW 1040 FRAME
- USING SCHEDULE 40 PVC DOWNSPOUT LEADS. LEADS SHALL BE COORDINATED WITH ARCHITECTURAL PLANS.
- SEWER SYSTEM MUST BE EXECUTED AND RECORDED PRIOR

QTY	UNIT	ITEM	
1480	LF	12" CL IV RCP	
64	LF	18" CL IV RCP	
84	LF	24" CL IV RCP	
3	EA	2' INLET	
16	EA	4' CATCH BASIN	
5	EA	4' MANHOLE	

CROSSING SCHEDULE

BETWEEN ALL UTILITIES. PROPOSED GAS MAIN IS ASSUMED TO BE 3" AND INSTALLED WITH 4 FEET OF COVER.

BP = BOTTOM OF PIPE				
3	12" STORM SEWER BP	=	825.28	
	8" SANITARY MAIN TP	=	819.07	
(5)	12" STORM SEWER BP	=	819.70	
	6" SANITARY LEAD TP	=	815.73	
6	12" STORM SEWER BP	=	818.89	
	4" WATER/FIRE SUPPRESSION LEAD TP	=	817.39	
8	12" STORM SEWER BP	=	816.73	
	8" WATER MAIN TP	=	815.17	
9	12" STORM SEWER BP	=	817.21	
	8" SANITARY SEWER TP	=	813.48	
11)	12" STORM SEWER BP	=	815.79	
	6" SANITARY LEAD TP	=	814.87	
12	12" STORM SEWER BP	=	812.23	
	4" WATER/FIRE SUPPRESSION LEAD TP	=	810.73	
14	12" STORM SEWER BP	=	810.30	
	8" SANITARY SEWER TP	=	808.07	
15)	12" STORM SEWER BP	=	810.90	
	8" WATER MAIN TP	=	809.00	
16)	24" STORM SEWER BP	=	808.97	
	1" WATER LEAD TP	=	807.47	
18	24" STORM SEWER BP	=	808.95	
	1" WATER LEAD TP	=	807.45	
20	24" STORM SEWER BP	=	808.90	
	8" SANITARY SEWER TP	=	807.04	
25)	12" STORM SEWER BP	=	809.19	
	8" SANITARY SEWER TP	=	807.49	
26	12" STORM SEWER BP	=	809.48	
	4" FIRE SUPPRESSION TP 1" WATER LEAD TP	=	807.98	
29	12" STORM SEWER BP	=	809.61	
	6" SANITARY LEAD TP	=	808.11	
47)	GAS MAIN BP	~	828.12	
	12" STORM SEWER TP	=	826.53	
50	GAS MAIN BP	~	820.08	
	12" STORM SEWER TP	=	818.58	
(53)	GAS MAIN BP	~	813.24	
	12" STORM SEWER TP	=	811.74	
58	GAS MAIN BP	~	812.92	

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NOTE: MAINTAIN MINIMUM 18" VERTICAL CLEARANCE

10 UTILITY CROSSING KEY

ABBREVIATIONS: IE = INVERT ELEVATION TP = TOP OF PIPE

3	12" STORM SEWER BP	=	825.28
	8" SANITARY MAIN TP	=	819.07
(5)	12" STORM SEWER BP	=	819.70
	6" SANITARY LEAD TP	=	815.73
6	12" STORM SEWER BP	=	818.89
	4" WATER/FIRE SUPPRESSION LEAD TP	=	817.39
8	12" STORM SEWER BP	=	816.73
	8" WATER MAIN TP	=	815.17
9	12" STORM SEWER BP	=	817.21
	8" SANITARY SEWER TP	=	813.48
11)	12" STORM SEWER BP	=	815.79
	6" SANITARY LEAD TP	=	814.87
12	12" STORM SEWER BP	=	812.23
	4" WATER/FIRE SUPPRESSION LEAD TP	=	810.73
14)	12" STORM SEWER BP	=	810.30
	8" SANITARY SEWER TP	=	808.07
15)	12" STORM SEWER BP	=	810.90
	8" WATER MAIN TP	=	809.00
16)	24" STORM SEWER BP	=	808.97
	1" WATER LEAD TP	=	807.47
18)	24" STORM SEWER BP	=	808.95
	1" WATER LEAD TP	=	807.45
20	24" STORM SEWER BP	=	808.90
	8" SANITARY SEWER TP	=	807.04
25)	12" STORM SEWER BP	=	809.19
	8" SANITARY SEWER TP	=	807.49
26	12" STORM SEWER BP	=	809.48
	4" FIRE SUPPRESSION TP 1" WATER LEAD TP	=	807.98
29	12" STORM SEWER BP	=	809.61
	6" SANITARY LEAD TP	=	808.11
47)	GAS MAIN BP	~	828.12
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	12" STORM SEWER TP	=	818.58
53	GAS MAIN BP	~	813.24
	12" STORM SEWER TP	=	811.74
(58)	GAS MAIN BP	~	812.92
	24" STORM SEWER TP	=	811.42

STORM SEWER QUANTITIES


RTH SEWER

> ORIGINAL ISSUE DATE: 05/19/2022

PROJECT NO: 22-051 SCALE: 1" = 30'1/2"

FIELD: REICHERT DRAWN BY: MN DESIGN BY: KM CHECK BY: AP

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KEVIN C.

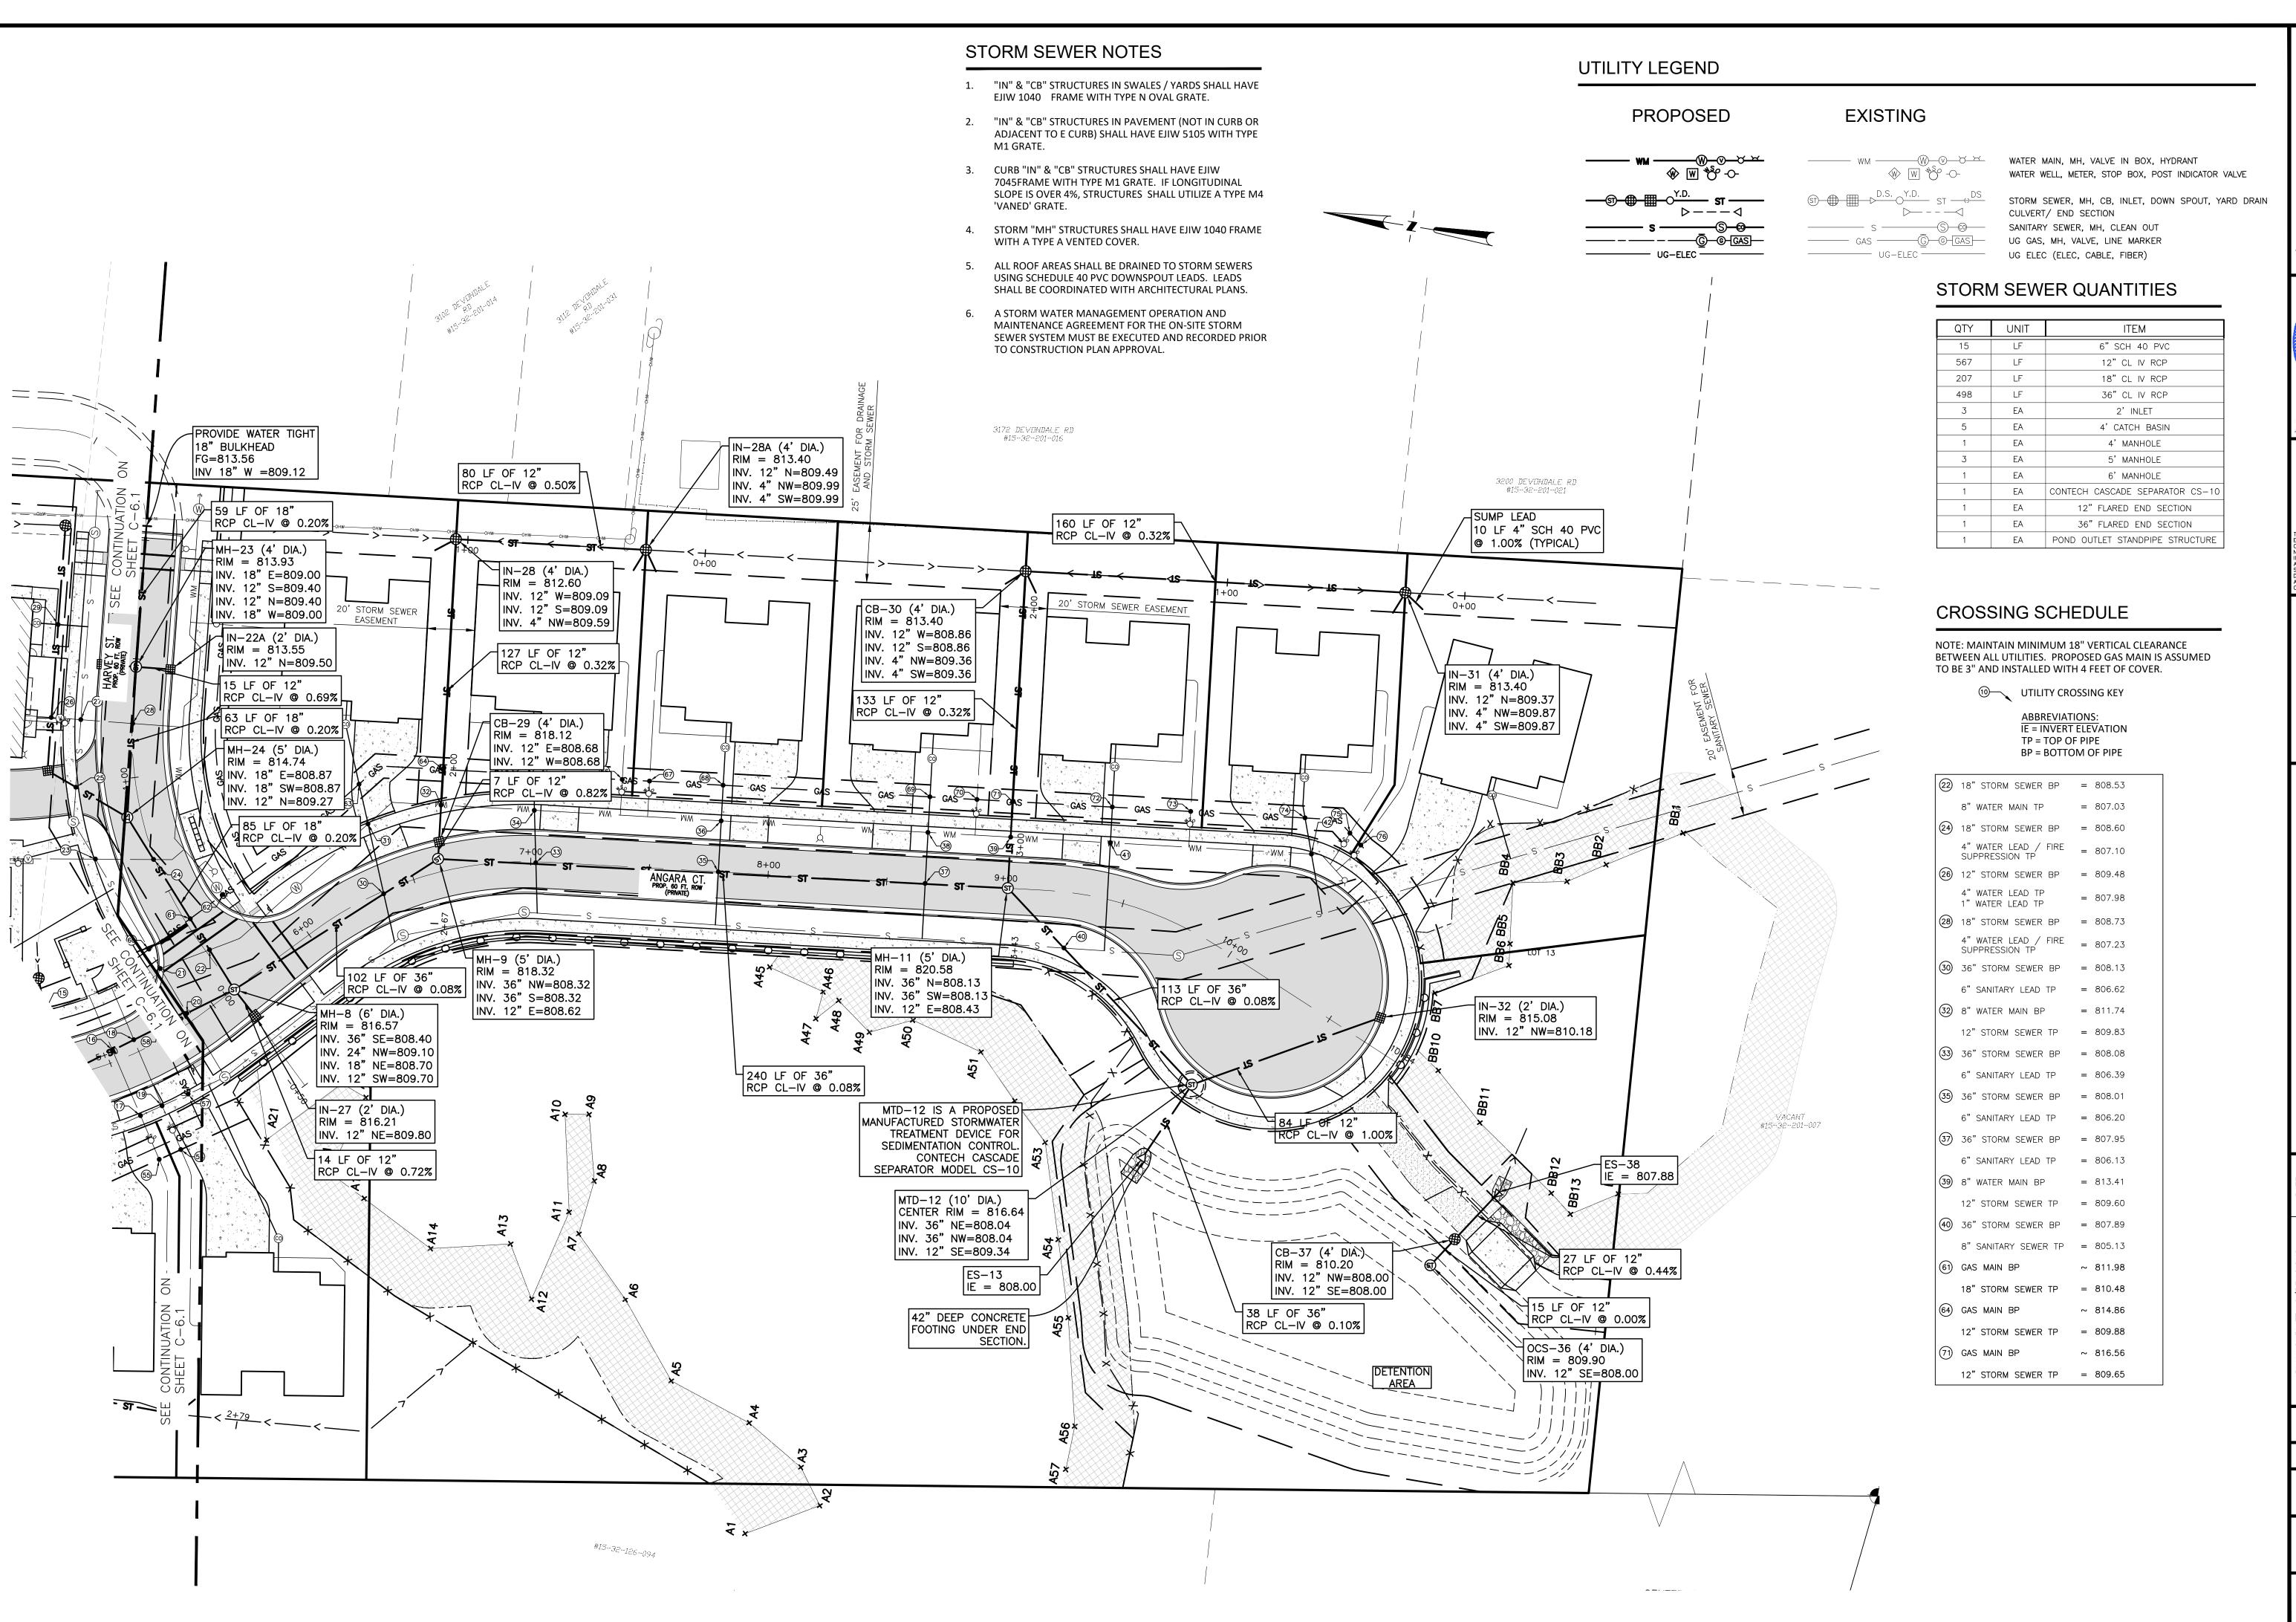** ON MCDEVITT

** ENGINEER

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AUBURN ANGARA

OAKS, LLC

14496 N SHELDON RD
SUITE 230

PLYMOUTH, MI 48170
BRUCE MICHAEL
(248) 703-4653

ANGARA OAKS
C. 32, T3N, R11E

80

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 D CONS. EASEMENT
 12/19/2024

 PLAN RESUBMITTAL
 04/02/2025

 PLAN RESUBMITTAL #2
 05/29/2025

 PLAN RESUBMITTAL #3
 07/07/2025

 NTITARY PERMIT PLANS
 08/01/2025

 PLAN RESUBMITTAL #4
 08/20/2025

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PROJECT NO: 22-051

SCALE: 1" = 30'

0 1/2" 1"


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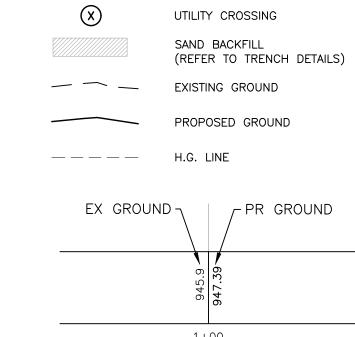
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CHECK BY: AP

C-6.2




PROFILE LEGEND

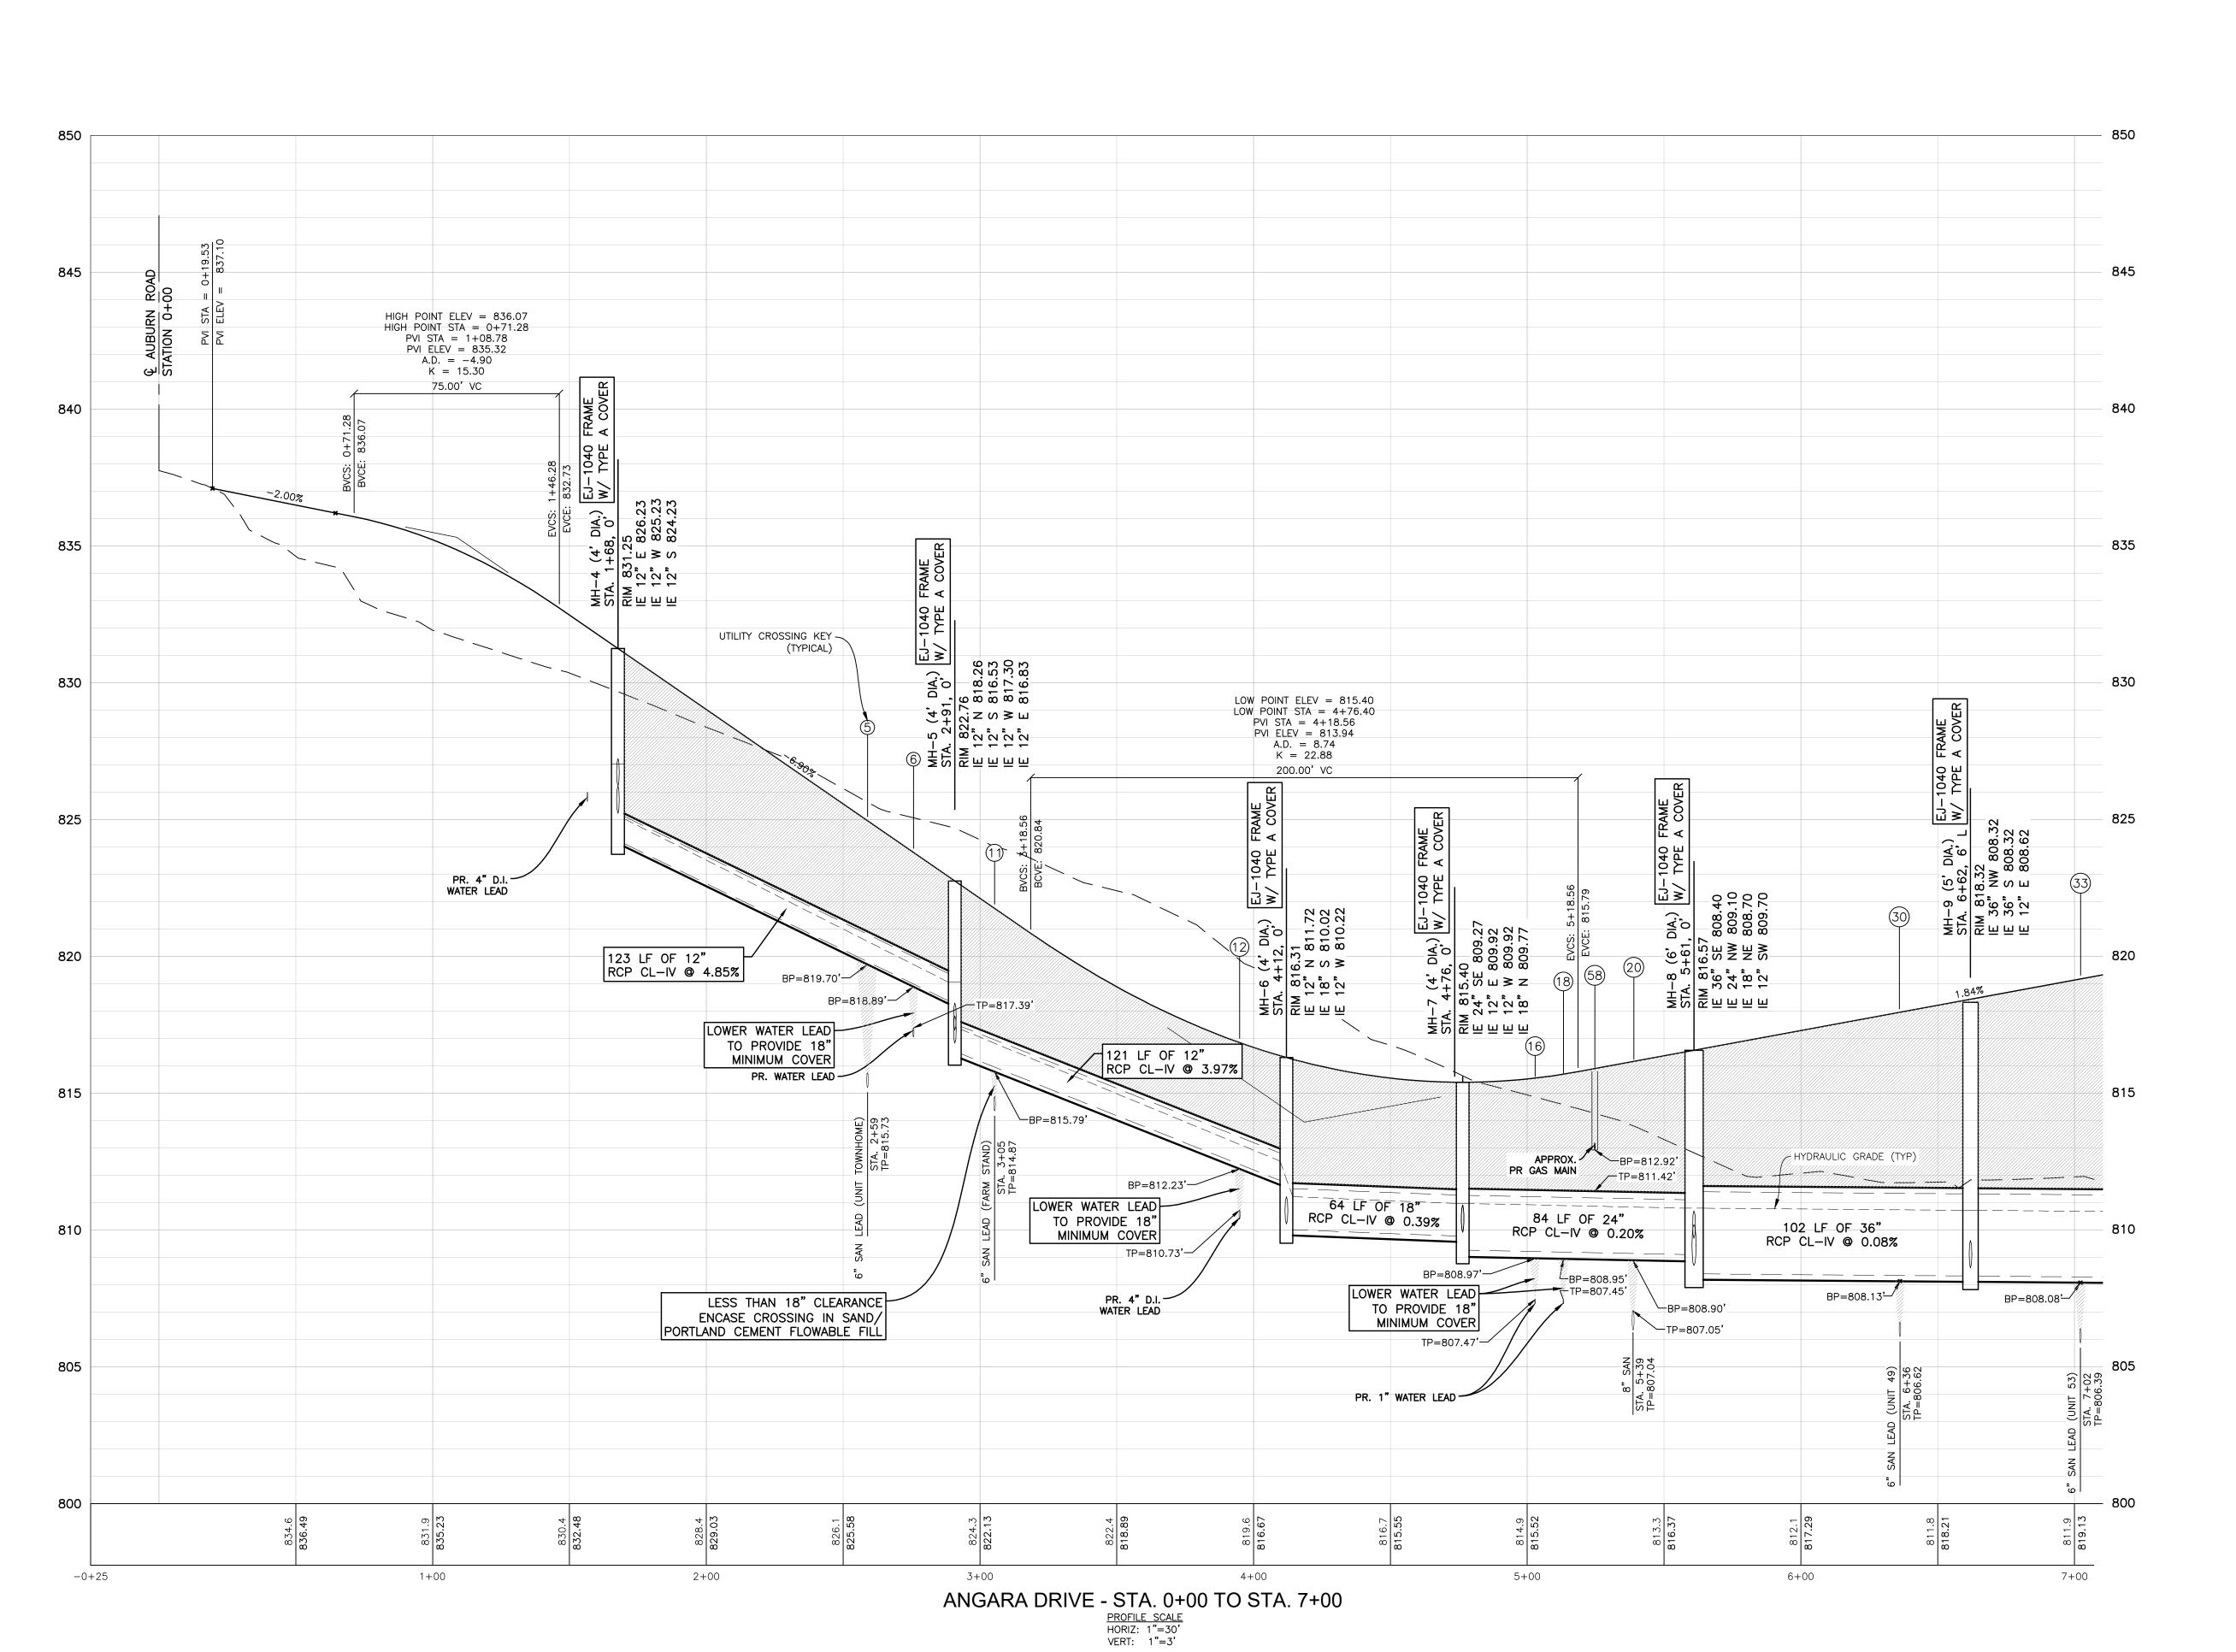

NOTES

1. SAND BACKFILL AND BEDDING TO BE MDOT CL II.

2. MAINTAIN MINIMUM 18" VERTICAL CLEARANCE BETWEEN ALL UTILITIES.

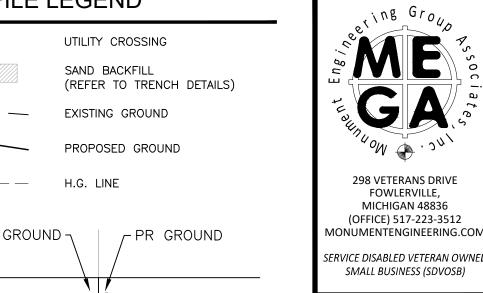

KEVIN C. MCDEVITT ENGINEER 6201043260

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THE LOCATIONS AND ELEVATIONS C
EXISTING UNDERGROUND UTILITIES AS SHOV
ON THIS DRAWING ARE ONLY APPROXIMAT
NO GUARANTEE IS EITHER EXPRESSED C
IMPLIED AS TO THE COMPLETENESS C
ACCURACY THEREOF. THE CONTRACTC
SHALL BE EXCLUSIVELY RESPONSIBLE FO
DETERMINING THE EXACT UTILITY LOCATION
AND ELEVATIONS PRIOR TO THE START C
C O N S T R U C T I O N

CLIENT:

AUBURN ANGARA OAKS, LLC

14496 N SHELDON RD SUITE 230 PLYMOUTH, MI 48170 BRUCE MICHAEL (248) 703-4653

OAKS ANGARA

STORM

DRIVE


ORIGINAL ISSUE DATE: 05/19/2022

PROJECT NO: 22-051 SCALE: SEE ABOVE

0 1/2" 1 FIELD: REICHERT DRAWN BY: MN DESIGN BY: KM

CHECK BY: AP C-6.3

PROFILE LEGEND

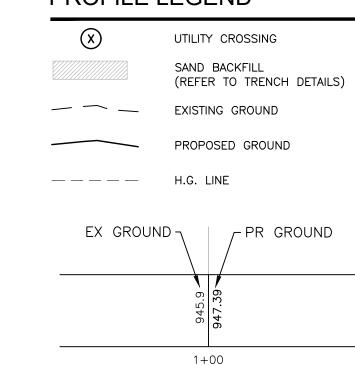

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298 VETERANS DRIVE

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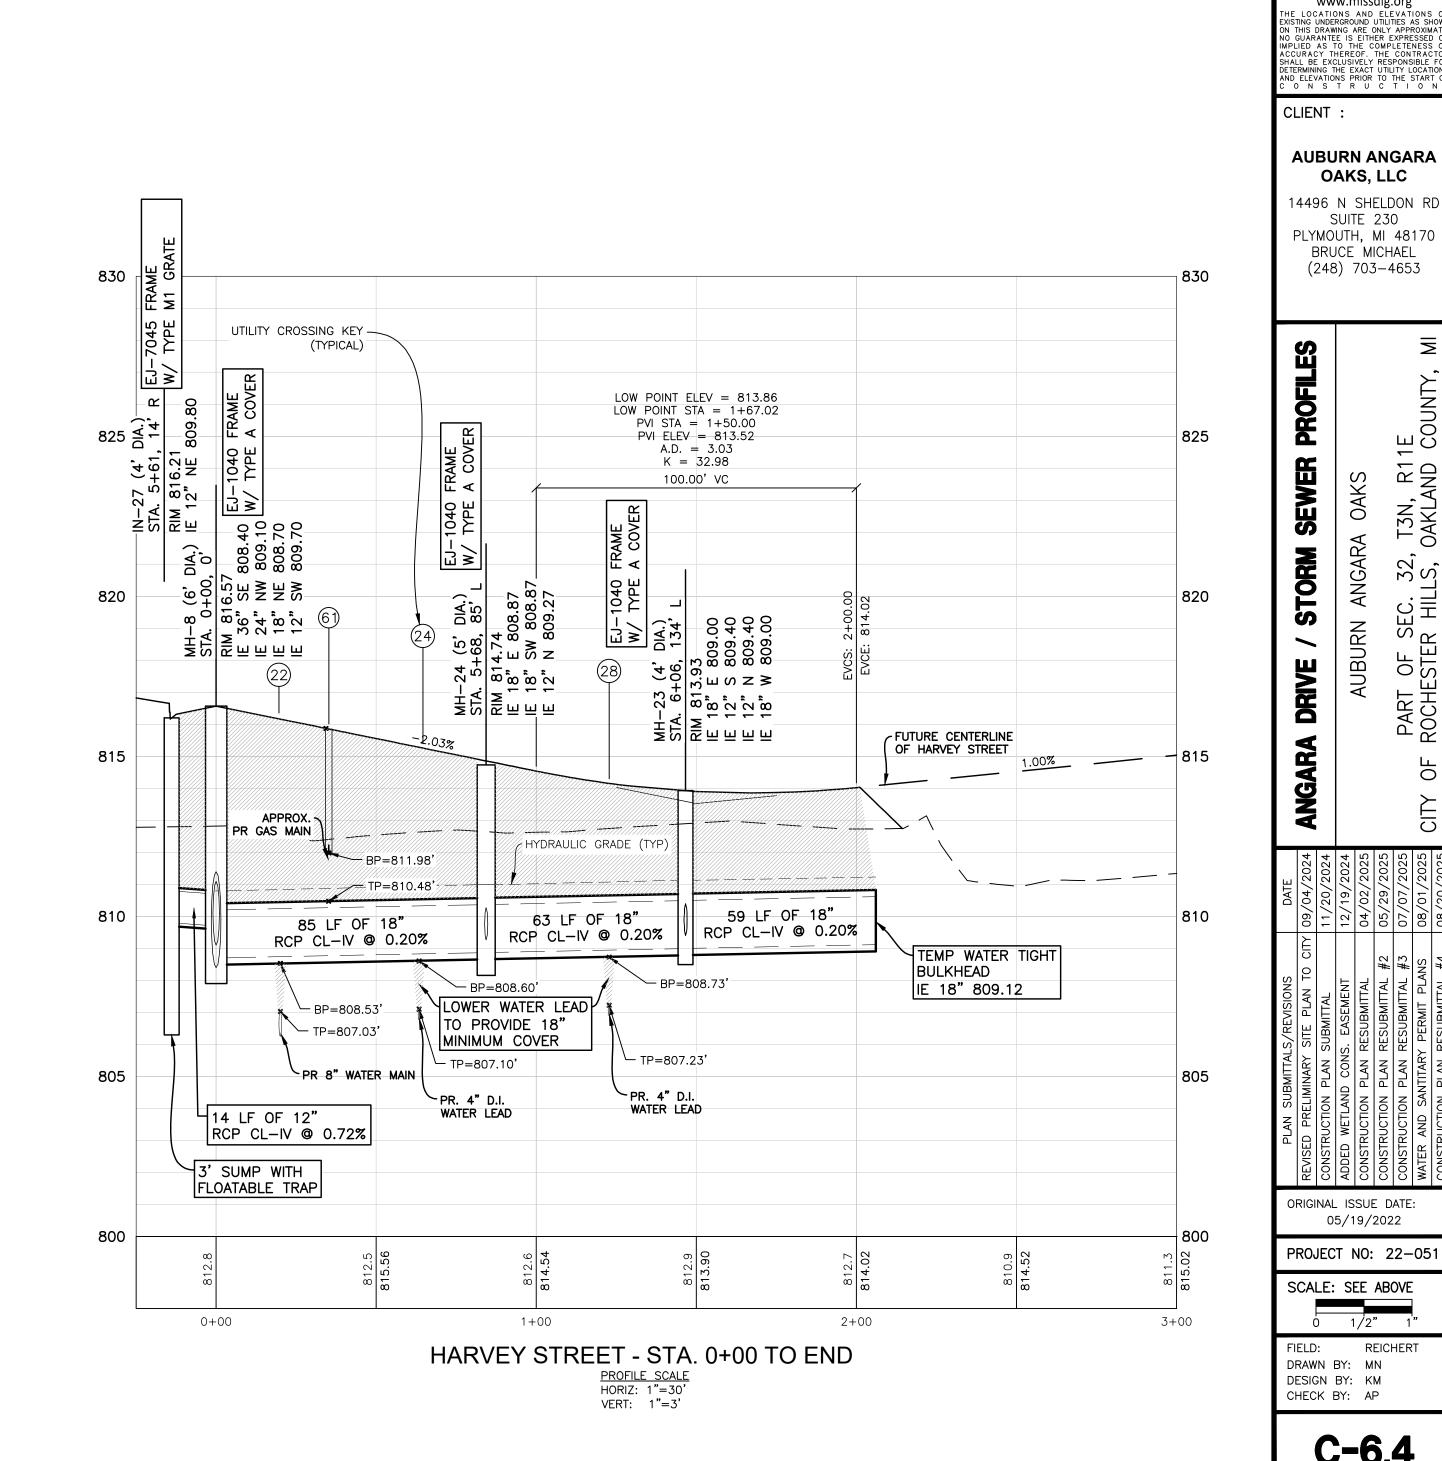
BRUCE MICHAEL


OAKS

ANGARA

NOTES

- 1. SAND BACKFILL AND BEDDING TO BE MDOT CL II.
- 2. MAINTAIN MINIMUM 18" VERTICAL CLEARANCE BETWEEN ALL UTILITIES.



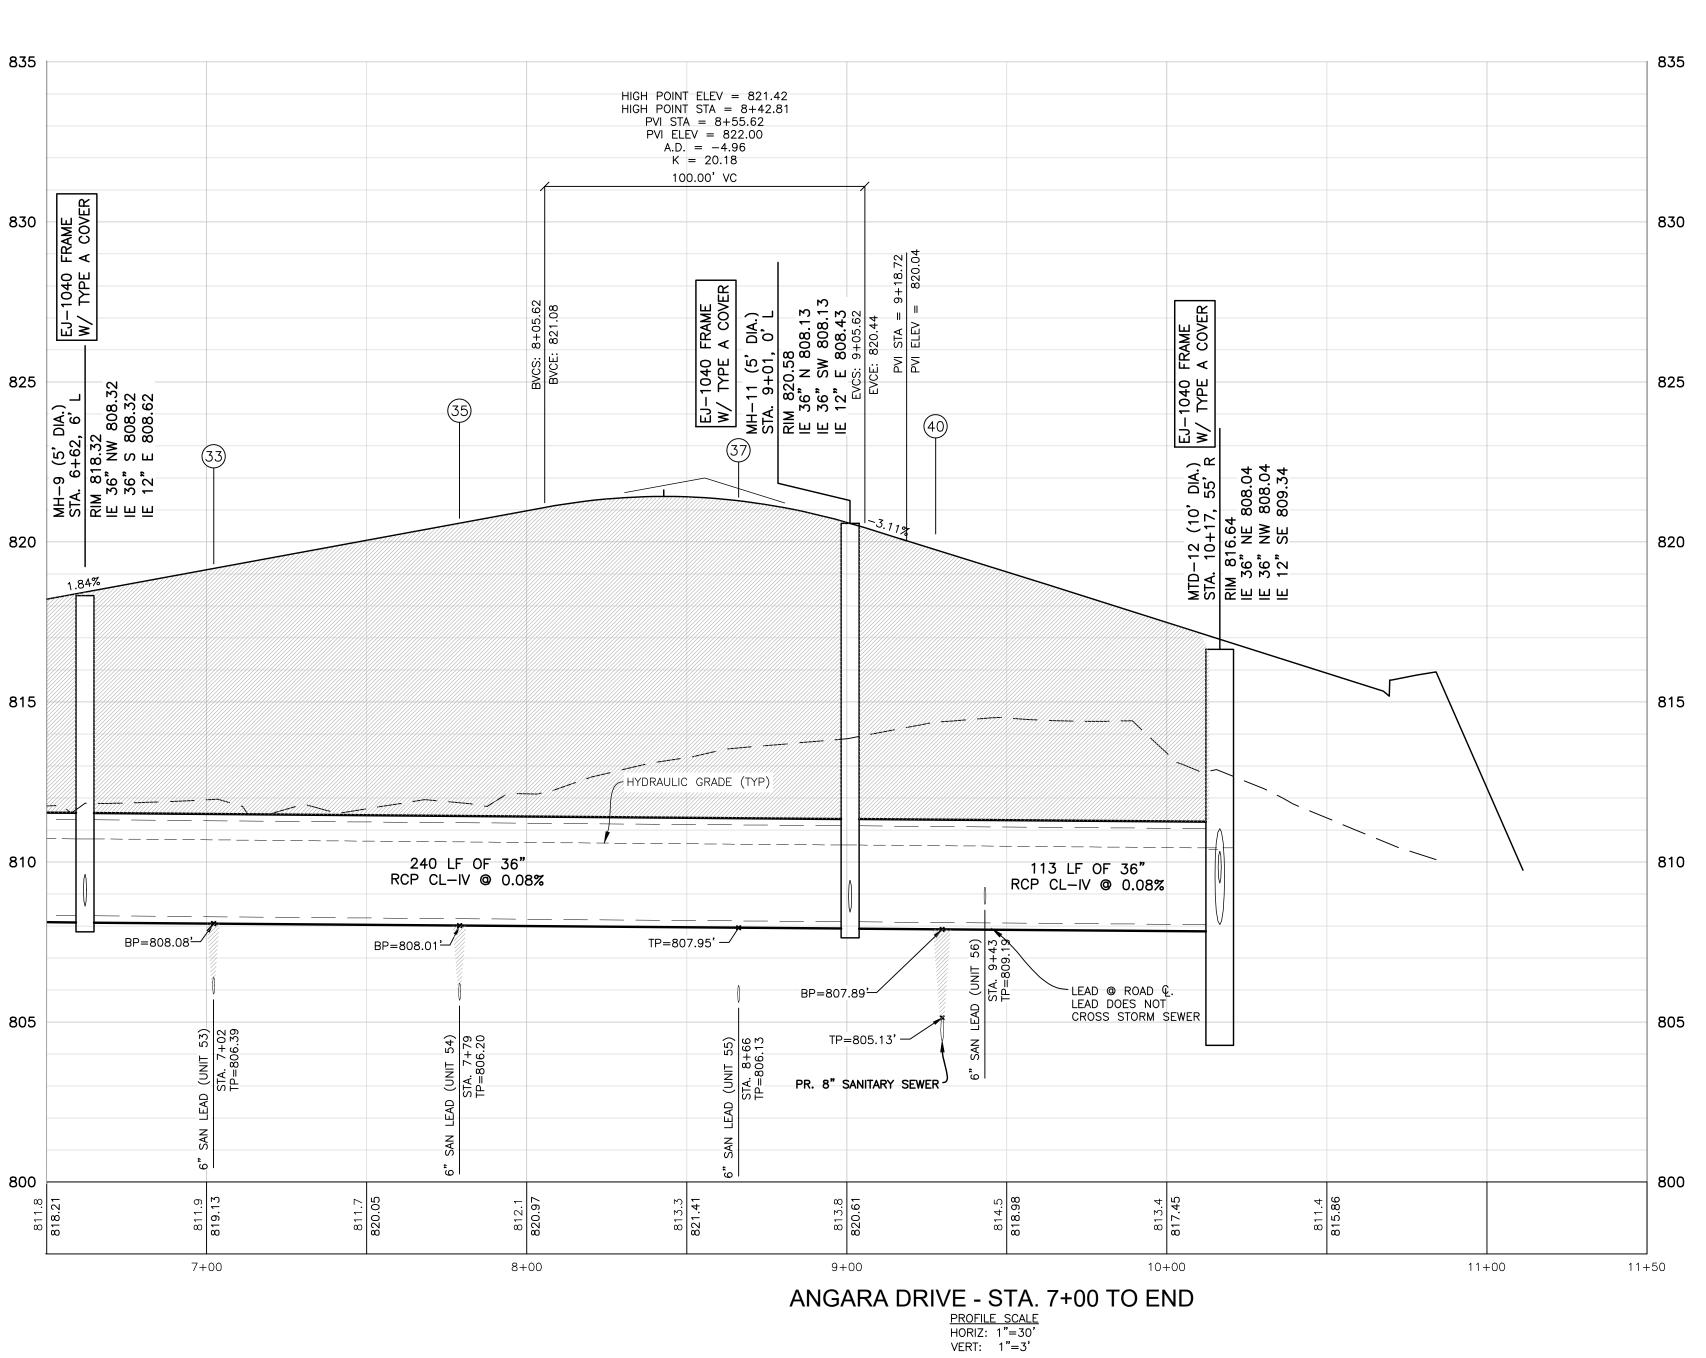



05/19/2022

0 1/2" 1

C-6.4

REICHERT

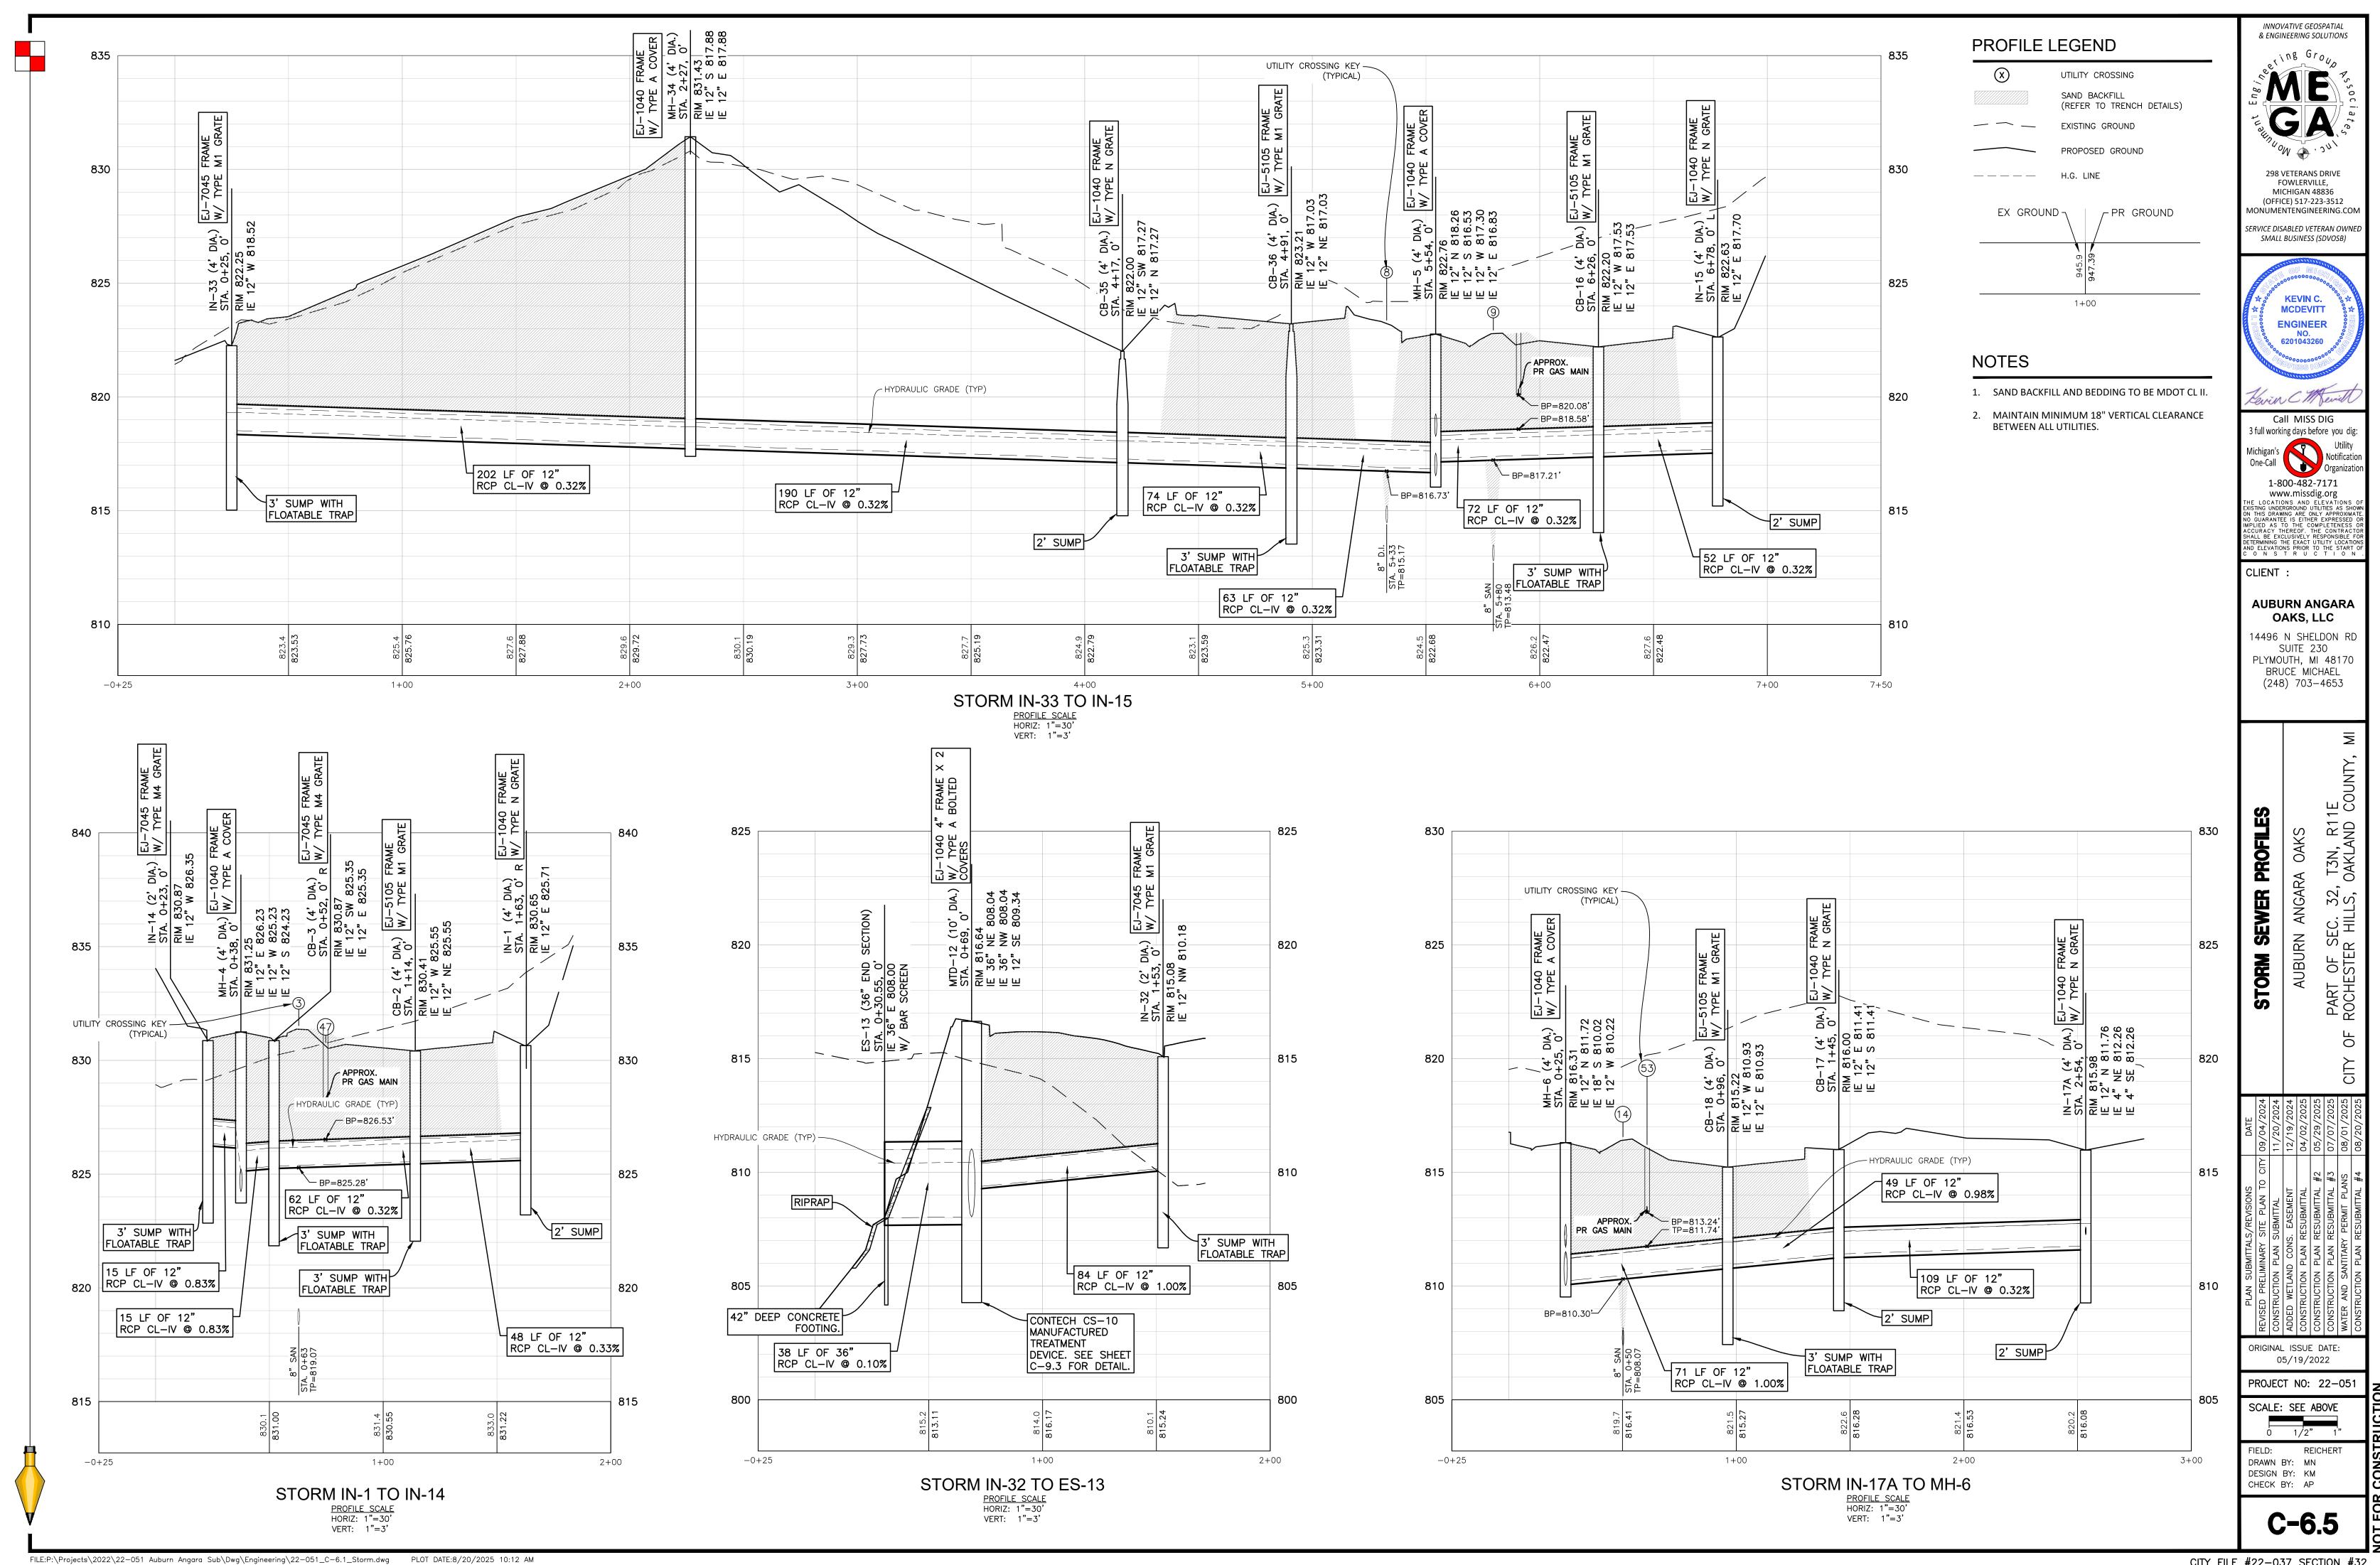

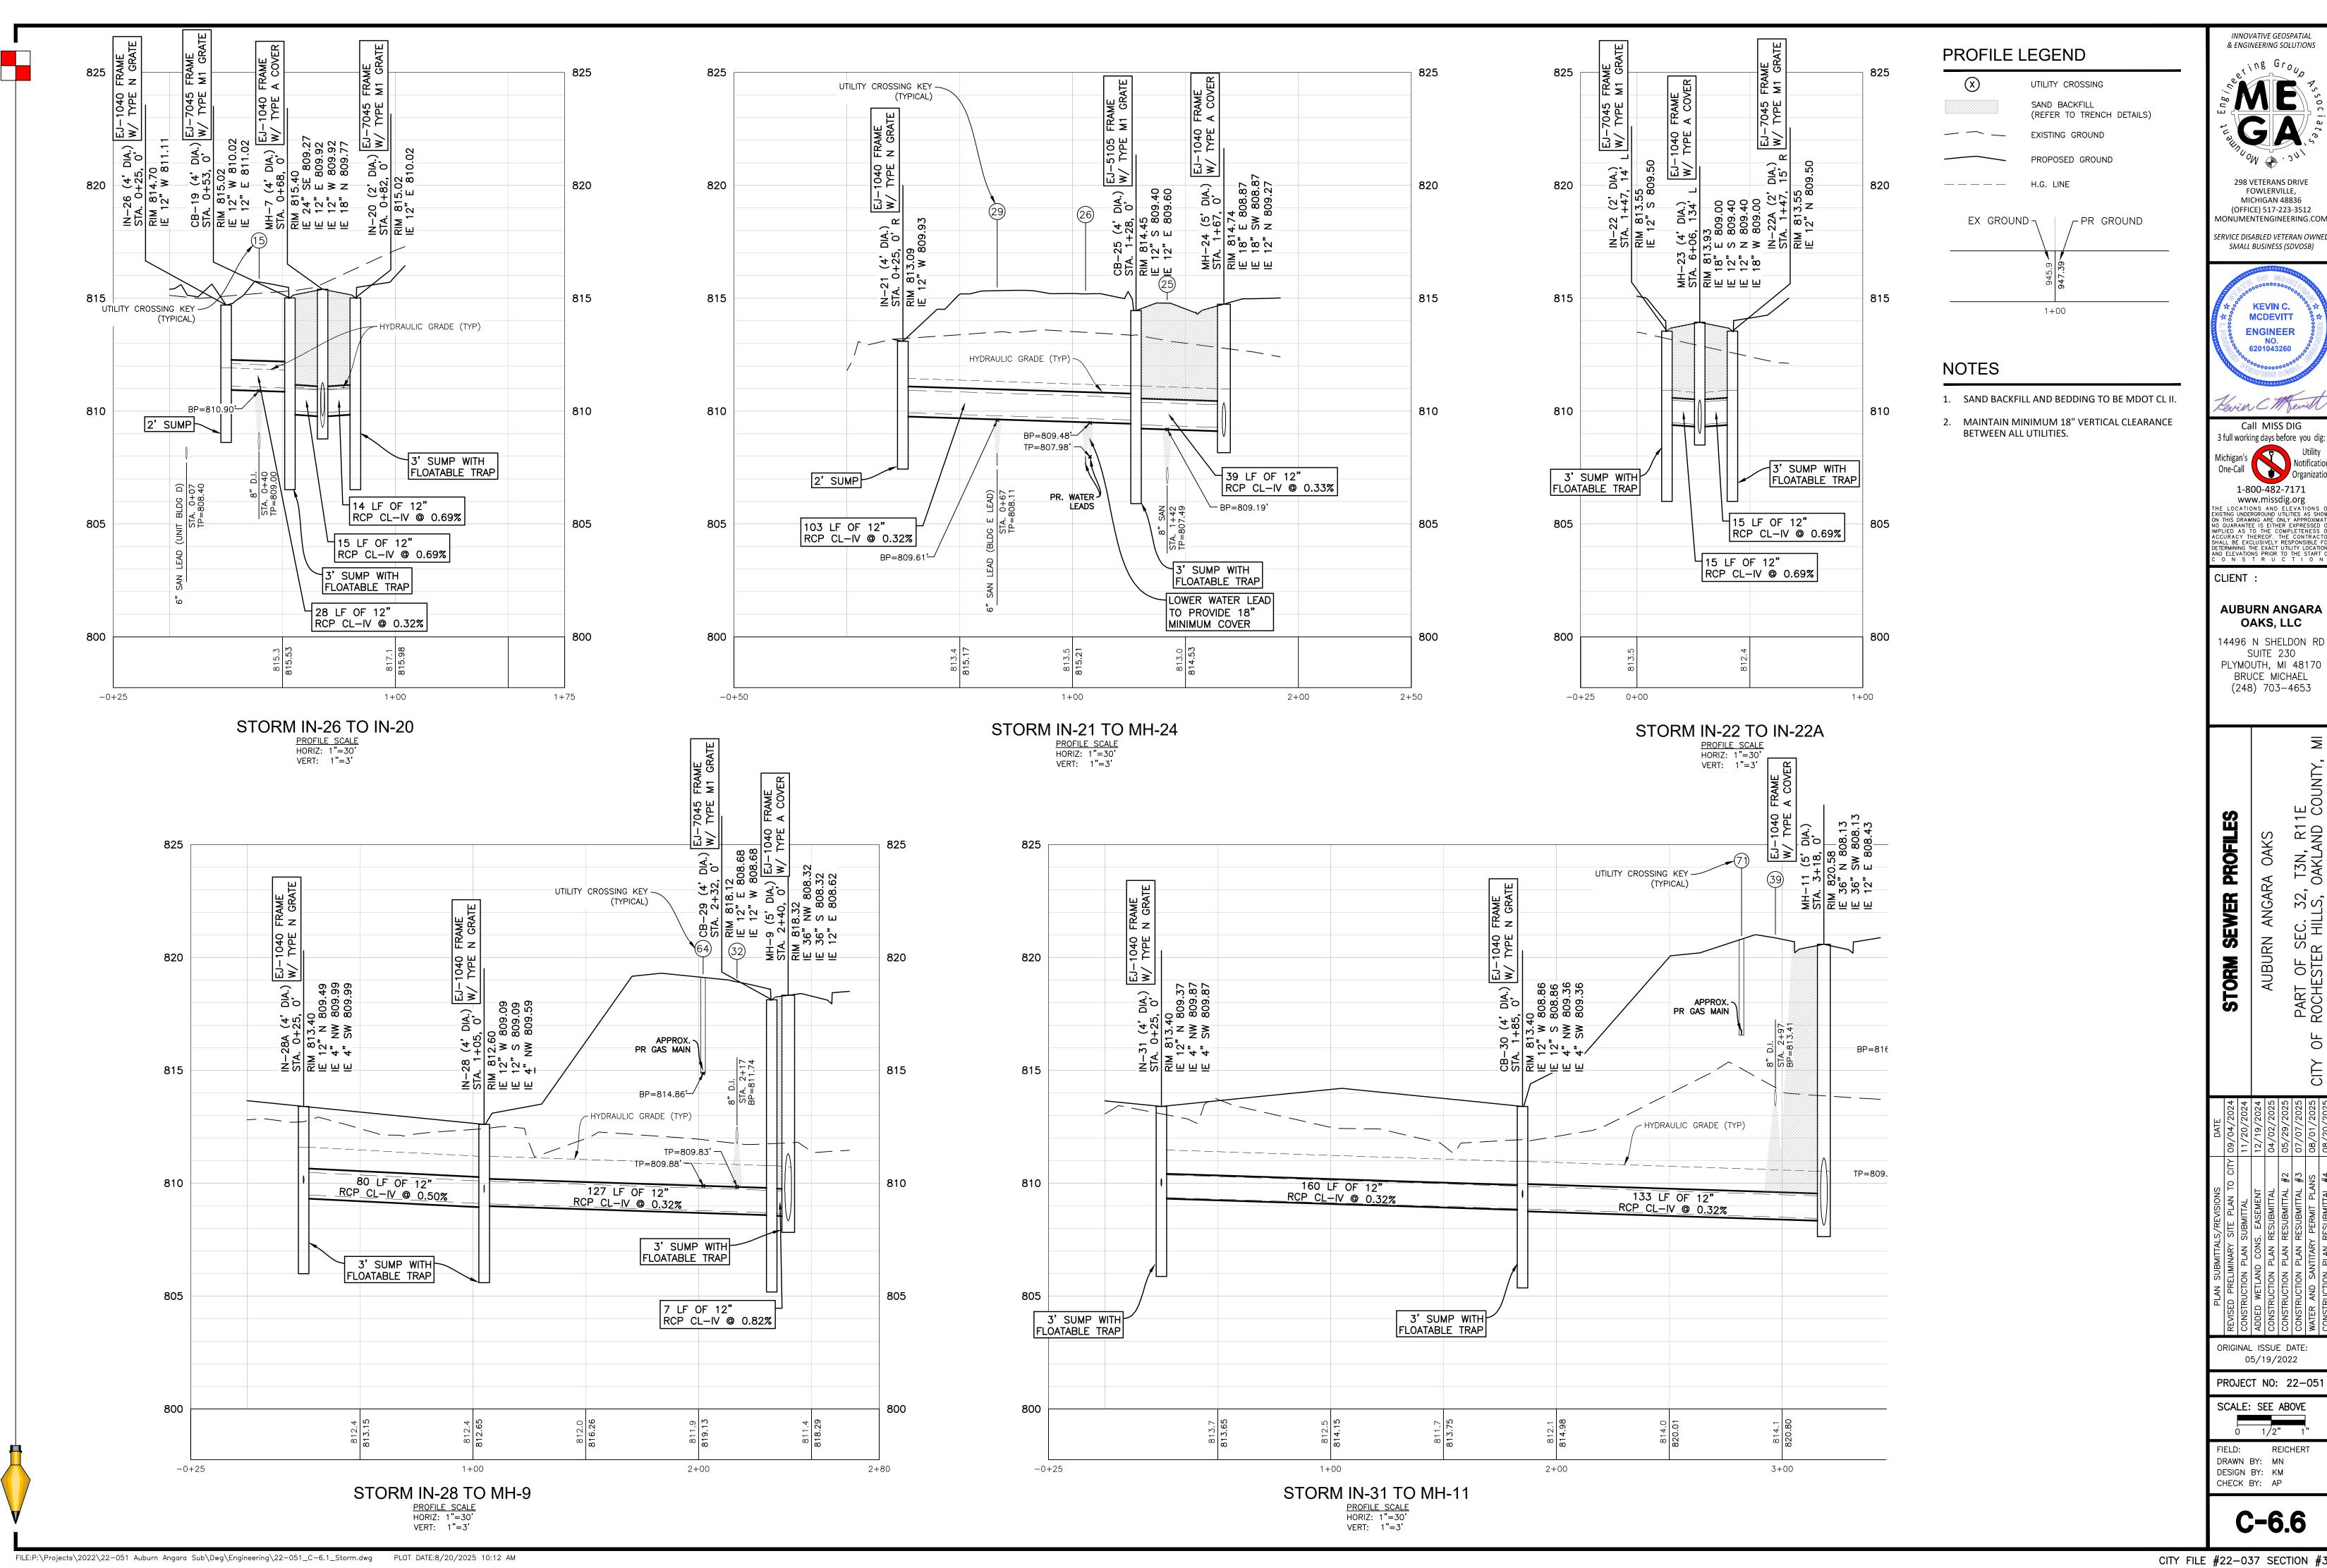

CITY FILE #22-037 SECTION #32