ST. PAUL'S ALBANIAN CATHOLIC COMMUNITY CHURCH CONTACT: FRANK GJOKAJ 525 WEST AUBURN ROAD ROCHESTER HILLS, MICHIGAN 48307 (586) 323-2911 (586) 323-2912 FAX

ENGINEER

GIFFELS WEBSTER ENGINEERS, INC. CONTACT: PAULIN MODI, PE 407 E. FORT STREET SHITE 600 DETROIT, MI 48226 (313) 962-4442 (313) 962-5068 FAX

BENCHMARKS

PK NAIL ON N. FACE OF LITHITY POLE ON SOUTH SIDE OF AUBURN ROAD AT END OF GUARD RAIL BRIDGE OVER M-59. ELEV. 780.39 (USGS) TAG #17559 PK NAIL ON N. FACE OF UTILITY POLE ON SOUTH SIDE OF AUBURN ROAD +/- 50' ELEV. 766.87 (USGS)


UTILITY STATEMENT

THE UNDERGROUND UTILITIES SHOWN HAVE BEEN LOCATED FROM FIELD SURVEY INFORMATION AND EXISTING DRAWINGS. THE SURVEYOR MAKES NO GUARANTEES THAT THE UNDERGROUND UTILITIES SHOWN COMPRISE ALL SUCH UTILITIES IN THE AREA, ETHER IN SERVICE OR ABADONED. THE SURVEYOR FURTHER DOES NOT WARRANT THAT THE UNDERGROUND UTILITIES SHOWN ARE IN THE EXACT LOCATION INDICATED ALTHOUGH HE DOES CERTIFY THAT THEY ARE LOCATED AS ACCURATELY AS POSSIBLE FROM INFORMATION AVAILABLE.

(R) = UTILITY SHOWN FROM RECORDS OR PLANS, & FIELD LOCATED WHERE POSSIBLE.

PRIOR TO THE PLANNED BUILDING IMPROVEMENTS, AND/OR CONSTRUCTION, THE RESPECTIVE UTILITY COMPANIES MUST BE NOTIFIED TO STAKE THE PRECISE LOCATION OF THEIR UTILITIES.

ST. PAUL'S ALBANIAN CATHOLIC **COMMUNITY CHURCH** PARKING LOT ADDITION CITY OF ROCHESTER HILLS OAKLAND COUNTY, MICHIGAN PART OF NORTH 1/2 OF SECTION 34, T-3-N., R-11-E.

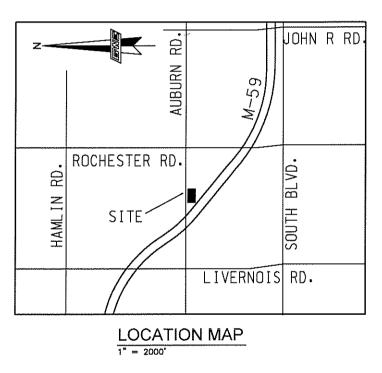

ISSUED FOR	DATE	SHEETS ISSUED
OWNER REVIEW	09.23.04	FULL SET
REVISED PER SITE PLAN REVIEW	D8_11_D8	FULL SET
SITE PLAN APPROVAL	11.01.08	FULL SET

Giffels-Webster Engineers, Inc.

407 E. FORT STREET SUITE 600 DETROIT MICHIGAN 48226 (313) 962-4442

NOT TO BE USED AS CONSTRUCTION DRAWING

SHEET INDEX:


COVER

- SP1 OVERALL SITE PLAN SP2 PRELIMINARY SITE PLAN
- L1 PRELIMINARY SITE PLAN
- L2 LANDSCAPE DETAILS AND SECTIONS
- 13 TREE REMOVAL PLAN
- E1 ELECTRICAL SITE PLAN


LEGAL DESCRIPTION

RECORDED IN LIBER 48, PAGE 55 OF PLATS, CAKLAND COUNTY RECORDS, ALL
BEING A PART OF THE NORTH CORNER OF SECTION 34, T—3—N., R—11—E., CITY OF
ROCHESTER HILLS, CAKLAND COUNTY, MICHIGAN, AND BEING MORE PARTICULARILY
DESCRIBED AS: COMMENCING AT THE NORTH CORNER OF SAD SECTION 34. THENCE
5,425 99°E., 80.14 FEET ALONG THE NORTH—SOUTH LINE OF SAD SECTION 34. TO A
POINT ON THE SOUTH RIGHT—0F—WAY LINE OF AUBURN ROAD (VARIABLE WIDTH), SAD
POINT BEING THE POINT OF BEGINNING; THENCE N.8970/35°E., 315.46 FEET ALONG SAD
SOUTH RIGHT—0F—WAY LINE TO A POINT ON THE EAST LINE OF SAID "SUPERMISOR'S
PLAT NO.5"; THENCE SI'S'33" E., 1259.01 FEET ALONG SAD EAST LINE TO A
POINT AT THE NORTHEAST CORNER OF SAID "SUPERMISOR'S PLAT OF AVON CROFTS
SUBBINSION NO.1"; THENCE SI'S'33" E., 250.69 FEET ALONG SAD EAST LINE OF SAD
SUBBINSION NO.1"; THENCE SI'S'33" E., 250.69 FEET ALONG SAD CURRY TO THE
RIGHT 252.85 FEET, SAID CURRY HAVING A RADIUS OF 3522.72 FEET, CENTRAL ANGLE OF
RIGHT 252.85 FEET, SAID CURRY HAVING A RADIUS OF 3522.72 FEET, CENTRAL ANGLE OF
SUBBINSION NO.1"; THENCE ALONG SAD NORTHERLY RIGHT—0F—WAY LINE ALONG A CURRY TO THE
RIGHT 252.85 FEET, SAID CURRY HAVING A RADIUS OF 3522.72 FEET, CENTRAL ANGLE OF
SUBBINSION NO.1"; THENCE ALONG SAD DON'S SUBBINSION NO.1"; THENCE ALONG SAD SOUTHERLY
LINE TO A POINT ON THE SOUTHERLY LINE OF LOTS 39 THROUGH 40 OF SAD
SUBPRISOR'S PLAT NO.5"; THENCE S.89"30"36"W, 128.15 FEET ALONG SAD COMMON LOT
SUBPRISOR'S PLAT NO.5"; THENCE S.89"30"36"W, 128.15 FEET ALONG SAD COMMON LOT
SUBPRISOR'S PLAT NO.5"; THENCE S.89"30"36"W, 128.15 FEET ALONG SAD COMMON LOT
SUBPRISOR'S PLAT NO.5"; THENCE S.89"30"36"W, 128.15 FEET ALONG SAD COMMITTERLY
RIGHT—OF—WAY LINE (1) ON A CURVE TO THE RIGHT 852.09 FEET, SAD CURVE HAVING
A RADIUS OF 3622.72 FEET, CENTRAL ANGLE OF 13"28"35" AND LONG CHORD BEARING
OF N.42202"34"W, 850.13 FEET AND, (2) NO.35"18"35"W


SUBJECT TO ANY EASEMENTS, RESTRICTIONS OR RIGHTS OF WAY RECORDED OR OTHERWISE.

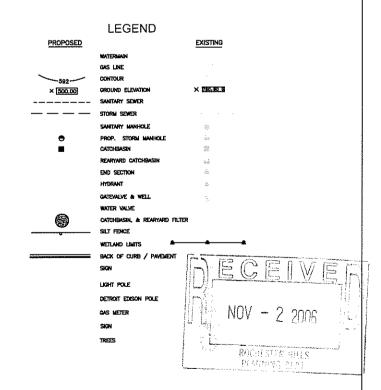

CITY FILE #98-037.3 Copyright © 2004 Giffele-Webster Engineers, Inc.
No reproduction shall be made without the prior
written consent of Chile-Webster Progresses, Inc. GWE #14793.10

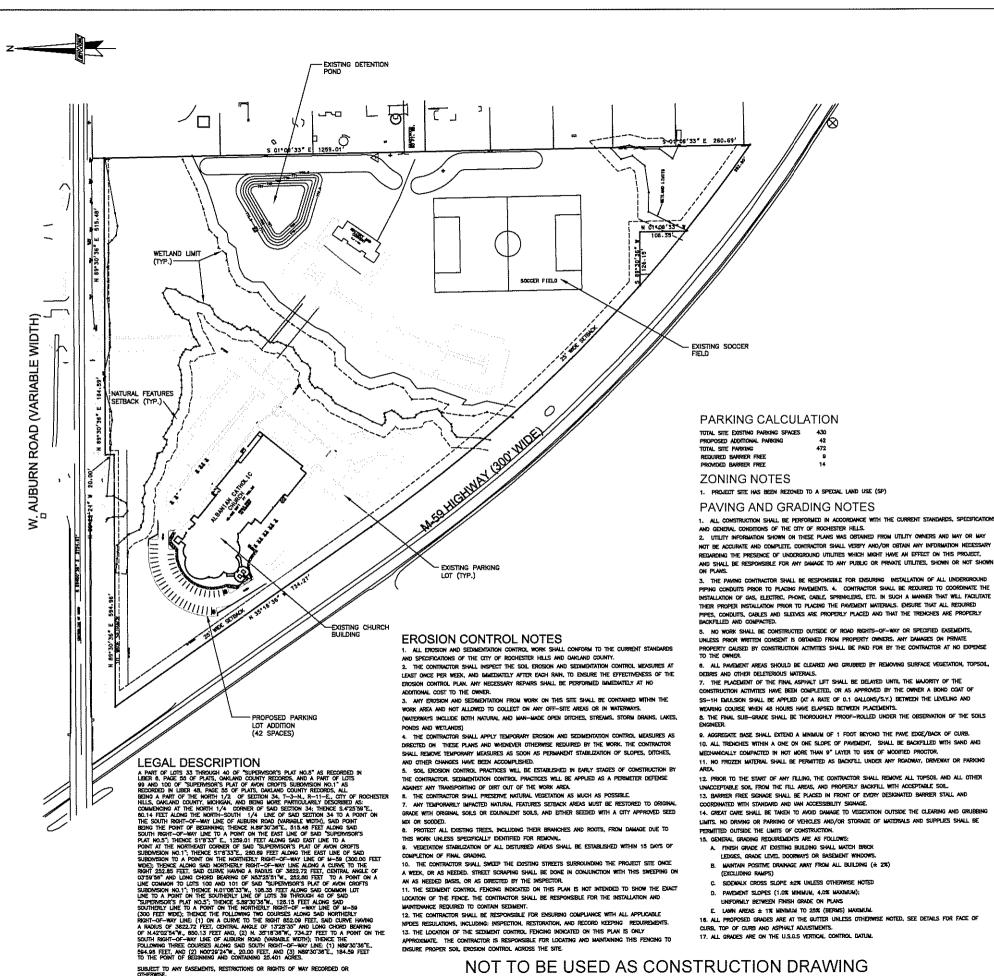

SUBJECT TO ANY EASEMENTS, RESTRICTIONS OR RIGHTS OF WAY RECORDED OR COMPRISE.

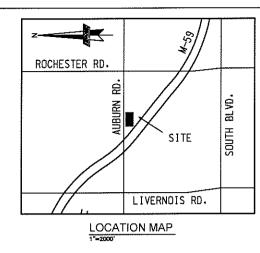

GENERAL NOTES

- 1. ALL WORK SHALL BE DONE IN ACCORDANCE WITH THE CURRENT STANDARDS, SPECIFICATIONS, AND GENERAL CONDITIONS OF THE CITY OF ROCHESTER HILLS.
- 2. LITE ITY INFORMATION SHOWN ON THESE PLANS WAS OPTAINED FROM LITELITY OWNERS AND THEREFORE MAY NOT BE ACCURATE OR COMPLETE. THE CONTRACTOR SHALL YEARY AND OBTAIN ANY REPORTATION NECESSARY REGARDING THE PRESENCE OF UNDERGROUND UTILITIES WHICH MIGHT HAVE AN IMPACT ON THIS
- 3. IT SHALL BE THE CONTRACTOR'S RESPONSIBILITY TO VERBY LOCATIONS AND ELEVATIONS OF EXISTING LITILITIES AT PROPOSED CONNECTIONS AND/OR CROSSINGS, AND TO NOTIFY THE ENGINEER OF ANY
- DIGITIES OF THESE PLANS.
 4. 72 HOURS PRIOR TO EXCAVATION, THE CONTRACTOR SHALL CONTACT MISS DIG AT (800) 482-7171 FOR THE LOCATION OF UNDERGROUND CAS AND CABLE FACILITIES, AND SHALL ALSO NOTIFY REPRESENTATIVES OF OTHER UTILITIES LOCATED IN THE VICINITY OF THE WORK. IT SHALL BE THE CONTRACTOR'S RESPONSIBILITY TO VETRY AND/OR OBTAIN INFORMATION NECESSARY REGARDING. THE PRESENCE OF UNDERGROUND UTILITIES WHICH MIGHT AFFECT THIS JOB.
- INSURANCE REQUIRED BY THE ISSUING AGENCIES SHALL BE PROVIDED BY THE CONTRACTOR, AND MUST BE KEPT CURRENT. CONTRACTOR IS RESPONSIBLE FOR ALL OTHER FEES, INSPECTION COSTS, ETC., AND SHALL
- 8. THE CONTRACTOR SHALL BE RESPONSIBLE FOR SECURING ALL WORK AREAS TO ENSURE THE SAFETY ALL CONSTRUCTION FENCING AS NECESSARY.
- THE CONTRACTOR SHALL PROVIDE FOR CONTROLLED ACCESS TO THE SITE FOR USE BY THE WAROUS WORK FORCES, EMERGENCY VEHICLES, OCCUPANTS, VISITORS, ETC. THROUGHOUT CONSTRUCTION. THIS
- A THE CONTRACTOR IS RECIERED TO CONFINE CONSTRUCTION ACTIVITIES TO THE LIMITS OF THE SITE AS
- ALL ELEVATIONS ON THESE PLANS ARE ON THE U.S.G.S VERTICAL CONTROL DATUM
- 11. ALL CONSTRUCTION SHALL HAVE INSPECTION PROVIDED BY THE CITY'S ENGINEER, THE CONTRACTOR SHALL CONTACT THE CITY OF ROCHESTER HILLS 48 HOURS BEFORE THE START OF CONSTRUCTION. 12. THE CONTRACTOR SHALL BE RESPONSIBLE FOR DUST CONTROL, AND SHALL PROVIDE ALL NECESSAR MATERIAL AND FOLIPMENT TO KEEP DUST IN CHECK AT ALL TIMES, THE CONTRACTOR SHALL RESPOND IMMEDIATELY TO ANY AND ALL COMPLANTS. DUST CONTROL SHALL BE INCIDENTAL TO THE PROJECT.

 13. DURING CONSTRUCTION, THE CONTRACTOR MAY ENCOUNTER SPRINKLER HEADS, PIPING, LIGHTING AND BURIED ELECTRICAL CABLE, MALBOXES, FENCES, SIGNS, ETC., THAT MAY OR MAY NOT BE INDICATED ON THESE PLANS. THE CONTRACTOR SHALL REPLACE AND/OR RESTORE ALL COMPONENTS OF SUCH SYSTEMS. REDUIREMENTS, OR AS SPECIFIED NEREIN: WHICHEVER IS MORE STRINGENT
- MATERIALS, MATCHING EXISTING MATERIALS IN QUALITY AND THICKNESS, OR PER MINIMUM REDUIREMENTS:
- POLES. THE CONTRACTOR IS RESPONSIBLE FOR DETERMINING THE QUANTITY AND DIRECTION OF OVERHEAD 18. REESTABLISH VEGETATION ON ALL DISTURBED AREAS BY MEANS OF SEED AND MULCH.
- FERTILIZER AND EROSION MAT OR STRAW MULCH, AND AS REQUIRED BY THE LANDSCAPING PLANS AND SPECIFICATIONS.

- 1. INSTALL MUD MATS, SILT FENCE AND INLET FILTERS AT ALL EXISTING LOCATIONS AS SHOWN AND AS REQUIRED TO ACHIEVE ON-SITE CONTAINMENT.
- 2. RISTALL STORM SEWER AND ALL ASSOCIATED STORM WATER IMPROVEMENTS AS SHOWN ON PLANS. IMMEDIATELY INSTALL INLET FILTERS AT ALL CATCH BASINS.
- 3. ROUGH GRADE THE PROJECT "WORK AREA" AS NEEDED.
- 4. INSTALL PAVEMENT BACKFILL AND SEED & MULCH ALL DISTURBED AREAS.
- INSTALL LANDSCAPING MATERIALS AS INDICATED PER PLANS & RE-SEED, FERTILIZE AND MULCH ALL

- ALL PERMITS REQUIRED SHALL BE OBTAINED BY THE CONTRACTOR, ALL PERMIT FEES, BONDS, AND
- ACCESS MUST PROVIDE FOR THE REMOVAL OF MUD FROM VEHICLES TIRES AND SHALL BE CONTINUOUSLY
- SHOWN ON THE CONSTRUCTION PLANS. ANY DAMAGE OR DISRUPTION TO ADJACENT SITES IS THE RESPONSIBILITY OF THE CONTRACTOR TO CORRECT IMMEDIATELY.
- 10. PROTECTION OF EXISTING TIRES, AS RECURRED, SHALL BE SOLELY THE CONTRACTOR'S RESPONSIBILITY
- 13. LITELTY POLES SHOWN ON THESE DRAWINGS ARE INTENDED TO SHOW ONLY THE LOCATION OF EXISTING
- 17. CLEANUP AND RESTORATION SHALL CONSIST OF FINE GRADING OF CONSTRUCTION AREAS, REMOVAL OF CONSTRUCTION SIGNS, ETC. TOPSOIL SHALL BE SPREAD OVER ALL DISTURBED AREAS, FOLLOWED BY SEED,
- RESPONSIBILITY OF THE CONTRACTOR. ALL COST ASSOCIATED WITH DEWATERING SHALL BE INCIDENTAL TO THE CONTRACT.
- 19. NO OVERHEAD UTILITIES ARE PRESENT ON-SITE.

EROSION CONTROL SEQUENCE

CITY FILE #98-037.3

Copyright @2004 Giffuls Values Engineers, Inc. No reproduction shall be made without the prior settles, consent of Giffuls, Made Frances, but

SITE

VERALL : PAUL'S CHURY OF ROCHESTE

Q º ₽

₹გ

PRINCIPAL:

MANAGER-

IND. REVIEW:

T-3-N R-11-E

CATHOLIC

ST.

Z ₹ Z

Giffels-Webster Engineers, I were . Law sumerors . Lawsone . Law sinest surfe doo looking, law to (313) sez 4442 (313) sez 2008 for

SECTION:

DESIGN: DRAWN: КM

РΜ

MK

DATE: 09.18.04 SCALE: 1 =100 SP1

AN AS NEEDED BASIS, OR AS DIRECTED BY THE INSPECTOR.

11. THE SEDIMENT CONTROL FENCING INDICATED ON THIS PLAN IS NOT INTENDED TO SHOW THE EXAC

C. SIDEWALK CROSS SLOPE #2% UNLESS OTHERWISE NOTED

D. PAVEMENT SLOPES (1.0% NINIMUM, 4.0% MAXIMUM);

UNIFORMLY BETWEEN FINISH GRADE ON PLANS

CURB. TOP OF CURB AND ASPHALT ADJUSTMENTS.

NOT TO BE USED AS CONSTRUCTION DRAWING

E LAWN AREAS ± 1% MINIMUM TO 25% (BERMS) MAXIMUM


18. ALL PROPOSED GRADES ARE AT THE GUTTER UNLESS OTHERWISE NOTED, SEE DETAILS FOR FACE OF

12. THE CONTRICTOR SHALL BE RESPONSILE FOR ENSURING COMPLANCE WITH ALL APPLICABLE NPDES RESULATIONS, INCLUDING: INSPECTION, RESTORATION, AND RECORD KEEPING REDUREMENTS.

13. THE LOCATION OF THE SEDIMENT CONTROL FENCING INDICATED ON THIS PLAN IS ONLY

10. THE CONTRACTOR SHALL SWEEP THE EXISTING STREETS SURROUNDING THE PROJECT SITE ONCE A WEEK, OR AS NEEDED, STREET SCRAPING SHALL BE DONE IN CONJUNCTION WITH THIS SWEEPING ON

LOCATION OF THE FENCE. THE CONTRACTOR SHALL BE RESPONSIBLE FOR THE INSTALLATION AND MAINTENANCE REQUIRED TO CONTAIN SEDIMENT

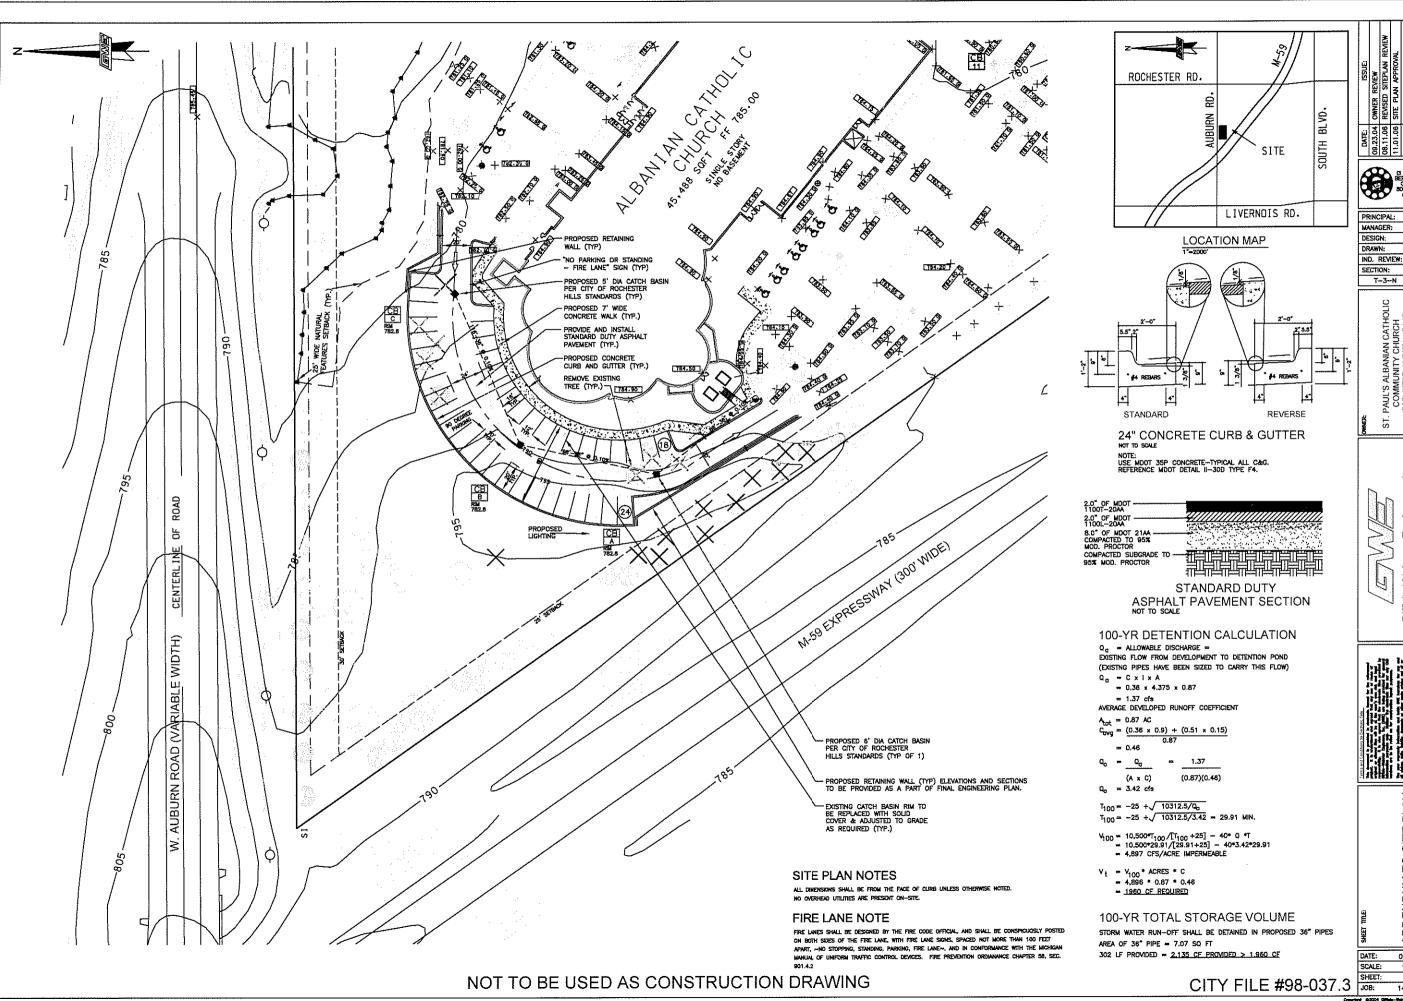

Copyright 02004 Stiffeds Hebeler Engineers, inc. He reproduction shall be made alliqued the prior written opened of Giffeds Metaler Engineers, inc.

KM

PM

МK

T-3-N R-11-E

ST.


Giffels-Webster Engineers, Inc. errs - Lwo swernes - Rowers - Lwo sure worn wor E. Fort mean sure doo between the tasse (313) 902-442 (313) 902-2008 for

SITE PLAN KING ADDITION COUNTY, MI

ADDENDUM TO S ST. PAUL'S CHURCH PARKIN CITY OF ROCHESTER HILLS, OA

09.18.04 1"=30'

SP2

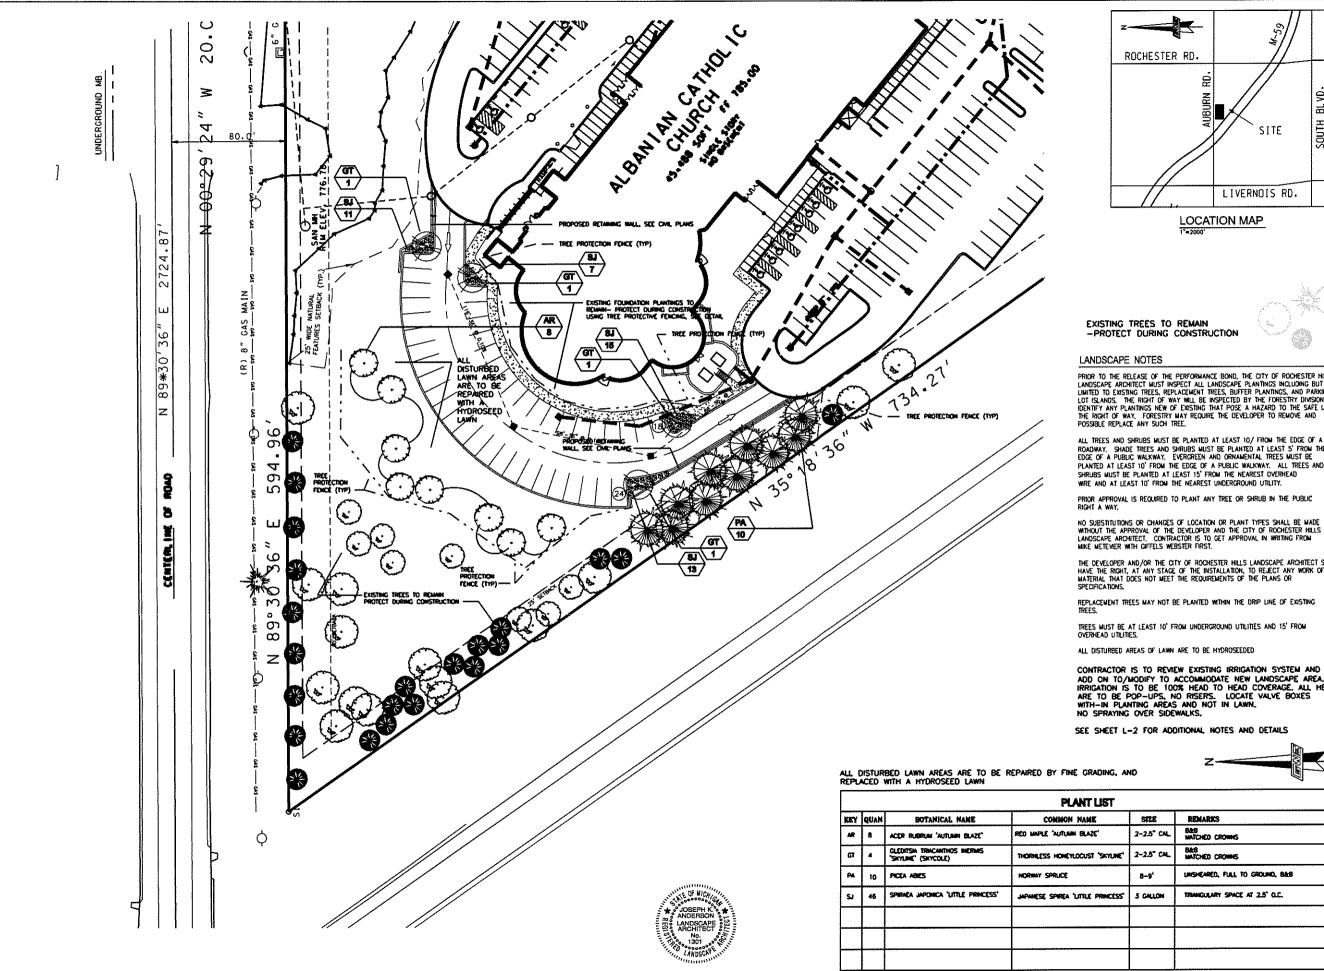

퓹 SOUTH

PRIOR TO THE RELEASE OF THE PERFORMANCE BOND, THE CITY OF ROCHESTER HILLS LANDSCAPE ARCHITECT MUST INSPECT ALL LANDSCAPE PLANTINGS INCLUDING BUT NOT LIMITED TO EXISTING TREES, REPLACEMENT TREES, BUFFER PLANTINGS, AND PARKING LOT ISLANDS. THE RIGHT OF WAY WILL BE INSPECTED BY THE FORESTRY DIMISON TO IDENTIFY ANY PLANTINGS NEW OF EXISTING THAT POSE A HAZARD TO THE SAFE USE OF THE RIGHT OF WAY, FORESTRY MAY REQUIRE THE DEVELOPER TO REMOVE AND POSSIBLE REPLACE ANY SUCH TREE.

ALL TREES AND SHRUBS MUST BE PLANTED AT LEAST 10/ FROM THE EDGE OF A PUBLIC ROADWAY. SHADE TREES AND SHRUBS MUST BE PLANTED AT LEAST 5' FROM THE EDGE OF A PUBLIC WALKWAY. EVERGREEN AND ORNAMENTAL TREES MUST BE PLANTED AT LEAST 10' FROM THE EDGE OF A PUBLIC WALKWAY. ALL TREES AND

PRIOR APPROVAL IS REQUIRED TO PLANT ANY TREE OR SHRUB IN THE PUBLIC RIGHT A WAY.

THE DEVELOPER AND/OR THE CITY OF ROCHESTER HILLS LANDSCAPE ARCHITECT SHALL HAVE THE RIGHT, AT ANY STACE OF THE INSTALLATION, TO REJECT ANY WORK OF MATERIAL THAT DOES NOT MEET THE REQUIREMENTS OF THE PLANS OR

TREES MUST BE AT LEAST 10' FROM UNDERGROUND UTILITIES AND 15' FROM OVERHEAD UTILITIES.

CONTRACTOR IS TO REVIEW EXISTING IRRIGATION SYSTEM AND TO ADD ON TO/MODIFY TO ACCOMMODATE NEW LANDSCAPE AREA, IRRIGATION IS TO BE 100% HEAD TO HEAD COVERAGE, ALL HEADS ARE TO BE POP-UPS, NO RESETS. LOCATE VALVE BOXES WITH-IN PLANTING AREAS AND NOT IN LAWN.



	PLANTLIST								
	QUAN	BOTANICAL NAME	COMMON NAME	STZE	REMARKS				
	8	ACER RUBRUM 'AUTUMM BLAZE'	RED MAPLE "AUTUMM BLAZE"	2-2.5" CAL.	BAS MATCHED CROWNS				
	4	GLEDITSIA TRIACANTHOS IMERIAIS "SKYLIME" (SKYCOLE)	THORNLESS HONEYLOCUST "SKYLINE"	2-2.5" CAL.	BACE MATCHED CROMMS				
	10	PICEA ABES	NORMAY SPRUCE	8-9'	UNSHEARED, FULL TO GROUND, B&B				
	46	SPIRAEA JAPONICA 'LITTLE PRINCESS'	JAPANESE SPIREA 'UITLE PRINCESS'	5 GALLON	TRANGULARY SPACE AT 2.5" O.C.				
1									

PRINCIPAL: MANAGER: PM DESIGN: им WW DRAWN: IND. REVIEW: SECTION: 34 T-3-N R-11-E

ST.

Giffels-Webster I

PRELIMINARY
LANDSCAPE PLAN

DATE: 06.20.06 1"=30" SCALE: SHEET: L1


JOB: 14795.11


Copyright 62004 (Eleta-Metaliar Engineers, Inc., No reproduction shall be made without the prior writing consent of Officia-Metaliar Degineers, Inc.

LANDSCAPE DEVELOPMENT NOTES


- 1.) All existing and/or proposed site utilities shall be field located, flagged, and verified
- prior to any tandscape or irrigation construction.

 2.) All specified and installed plant material shall be in full and strict accordance with American Nurseryman Standards (latest edition) and be:
 - Nursery grown, State Department of Agriculture inspected and approved.
- No. 1 grade with straight, unscared trunks & well-developed uniform crowns on trees. Warranted for 2 years from date of acceptance
- 3.) Specified planting soil mixture for all strub and perennial beds shall be three (3) parts specimed planting soll mixture for all single and pereinted beas state to the rice (3) parts well-distinker, screened organic lopsoid, to one (1) part imported clean sand, to one (1) part Canadiansphagnum peat mass, to one (1) part Natural Compost (Weed-Free)-complete with 10% natural poultry monure, install 12th minimum depth in all pereintial, groundcover, annual, and shrub beds. All beds must be excovated, remove and dispose (off-site) existing earth/soil to accept proposed plant mixture.
- 4.) Proposed stredded hardwood bark mulch shall be seasoned for a minimum 6 months, dark brown in color, and installed 4" deep under all proposed trees (included in unit cost), 4" deep in all strub and Iree beds, and 2" deep in all perennial and groundcover beds. Pack bank in retaining wall joints—after thoroughly cleaning joints.
- 5.) All proposed form and landscape areas shall be watered by an automatically operated sprinkler irrigation system. Irrigation system is to be head to head coverage, all pop-ups, no risers allowed. Install all valve boxes in planting areas, not in form areas.
- All proposed plant material must be approved by the Landscape Architect prior to installation and/or delivery to the site.
- The Landscape Contractor shall keep the street and drive clean and free of dirt and debris at all times, and shall thoroughly sweep and/or wash the drive at the end of each
- The Londscape Contractor shall stake the location of all proposed trees for the Londscape Architect to approve prior to planting. The Londscape Contractor shall also set on-site all shrubs, perennials, amamental grasses, vines, and groundcovers as per plan for the Landscape Architect to approve prior to planting.
- All dead and unacceptable plant materials shall be replaced by the Landscape Contractor during the warranty period. The warranty period shall be TWO (2) years from the Acceptance of Installation issued by the Landscope Architect.
- All landscape areas shall have proper drainage that prevents excess water from standing on lawn areas of around trees and shrubs.
- 11.) Install "Permotoc" oluminum landscape edging "<u>Proline"</u> per Monufacturer's specifications where indicated on plans. Color: BRONZE
- 12.) If plant list numbers differ from plans, the plans will supersede

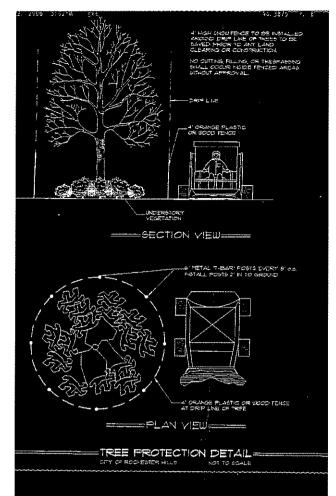

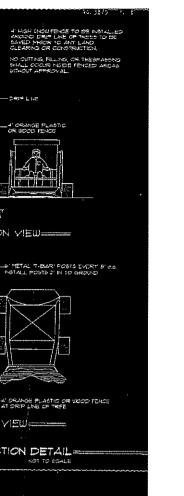



No Scale

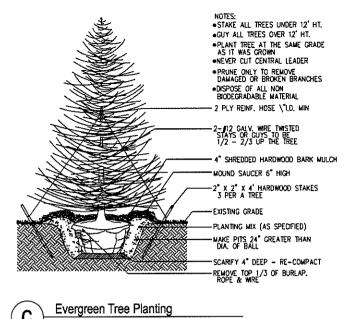

No Scale

 PRUNE ONLY TO REMOVE DAMAGED OR BROKEN BRANCHES *DISPOSE OF ALL NON BIODEGRADABLE MATERIAL 4" SHREDDED HARDWOOD BARK MULCH - MOUND SAUCER 4" HIGH EXISTING GRADE PLANTING MIX (AS SPECIFIED) REMOVE TOP 1/3 OF BURLAP, ROPE & WIRE MAKE PITS 12" GREATER THAN DIA, OF BALL 4" COMPACTED PLANT MIX Shrub Planting No Scale

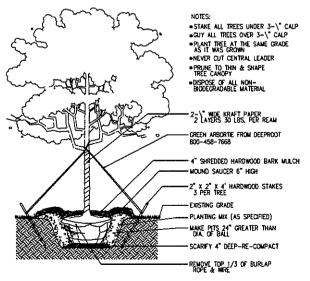

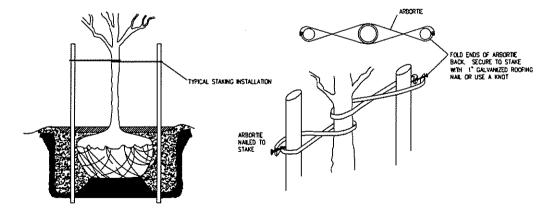

GREEN ARBORTE SHALL BE FASTENED TO STAKES IN A MANNER WHICH PERMITS TREE MOVEMENT AND SUPPORTS THE TREE

4" SHREDDED HARDWOOD BARK MULCH -MOUND SAUCER 4" HIGH -EXISTING GRADE -PLANTING MIX (AS SPECIFIED) REMOVE TOP 1/3 OF BURLAP, MAKE PITS 12" CREATER THAN - CONTINUOUS TRENCH OF PLANT MIXTURE -4" COMPACTED PLANT MIX Hedge Planting a

Deciduous Tree Planting

No Scale


MANAGER: PM DESIGN: WM DRAWN: WM IND. REVIEW: SECTION: 34 T-3-N R-11-E

ST. I

LANDSCAPE DETAILS AND NOTES PAUL'S CHURCH PARKING ADDITION OF ROCHESTER HILLS, DAKLAND COUN

DATE: 05.20.06 SCALE: 1"=30" SHEET: L-2 JOB: 14793,11

Copyright C2004 Diffuse-Material Copyrights, Inc., No. reproduction shall be made without the prior writing common of Gillets-Material Engineers, No.

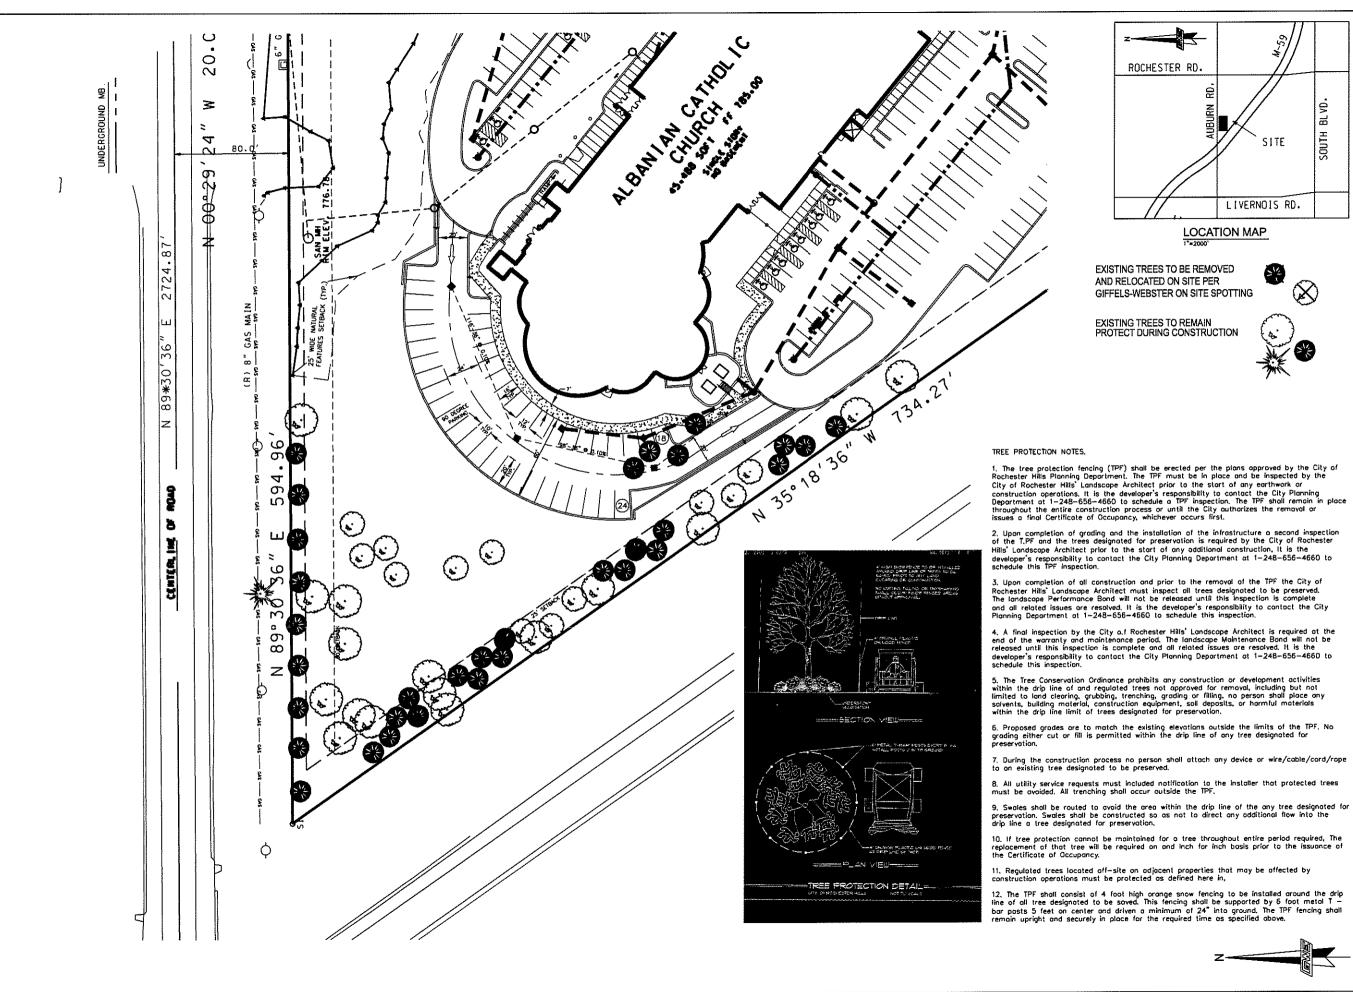

핆 SOUTH



 The tree protection fencing (TPF) shall be erected per the plans approved by the City of Rochester Hills Planning Department. The TPF must be in place and be inspected by the City of Rochester Hills Landscape Architect prior to the start of any earthwork or construction operations. It is the developer's responsibility to contact the City Planning Department at 1-248-656-4660 to schedule a TPF inspection. The TPF shall remain in place throughout the entire construction process or until the City authorizes the remayal or issues a final Certificate of Occupancy, whichever occurs first.

2. Upon completion of grading and the installation of the infrastructure a second inspection of the T.PF and the trees designated for preservation is required by the City of Rochester Hills' Landscape Architect prior to the start of any additional construction, it is the developer's responsibility to contact the City Planning Department at 1-248-656-4660 to schedule this TPF inspection.

3. Upon completion of all construction and prior to the removal of the TPF the City of Rochester Hills' Londscope Architect must inspect all trees designated to be preserved. The landscape Performance Bond will not be released until this inspection is complete and all related issues are resolved. It is the developer's responsibility to contact the City Planning Department at 1–248–656–4660 to schedule this inspection.

4. A final inspection by the City o.! Rochester Hills' Landscope Architect is required at the end of the warranty and maintenance period. The landscape Maintenance Bond will not be released until this inspection is complete and all related issues are resolved. It is the developer's responsibility to contact the City Planning Department at 1-248-656-4660 to

5. The Tree Conservation Ordinance prohibits any construction or development activities within the drip line of and regulated trees not approved for removal, including but not limited to land clearing, grubbing, trenching, grading or filling, no person shall place any salvents, building material, construction equipment, soll deposits, or harmful materials within the drip line limit of trees designated for preservation.

Proposed grades are to match the existing elevations outside the limits of the TPF. No grading either cut or fill is permitted within the drip line of any tree designated for preservation.

11. Regulated trees located off—site on adjacent properties that may be affected by construction operations must be protected as defined here in,

12. The TPF shall consist of 4 foot high orange snow fencing to be installed around the drip line of all tree designated to be saved. This fencing shall be supported by 6 foot metal T - bar posts 5 feet on center and driven a minimum of 24° into ground. The TPF fencing shall remain upright and securely in place for the required time as specified above.



PRINCIPAL км MANAGER: РМ

DESIGN: INO. REVIEW: T-3-N R-11-E


ST.

Scare Acom ler Engineers

• Puwers • Luess
sure soo bered, M Giffels-Webster I

PLAN REMOVAL TREE

DATE: 06.20.05 SCALE: 1"-30" SHEET: L3 JOB; 14793.11

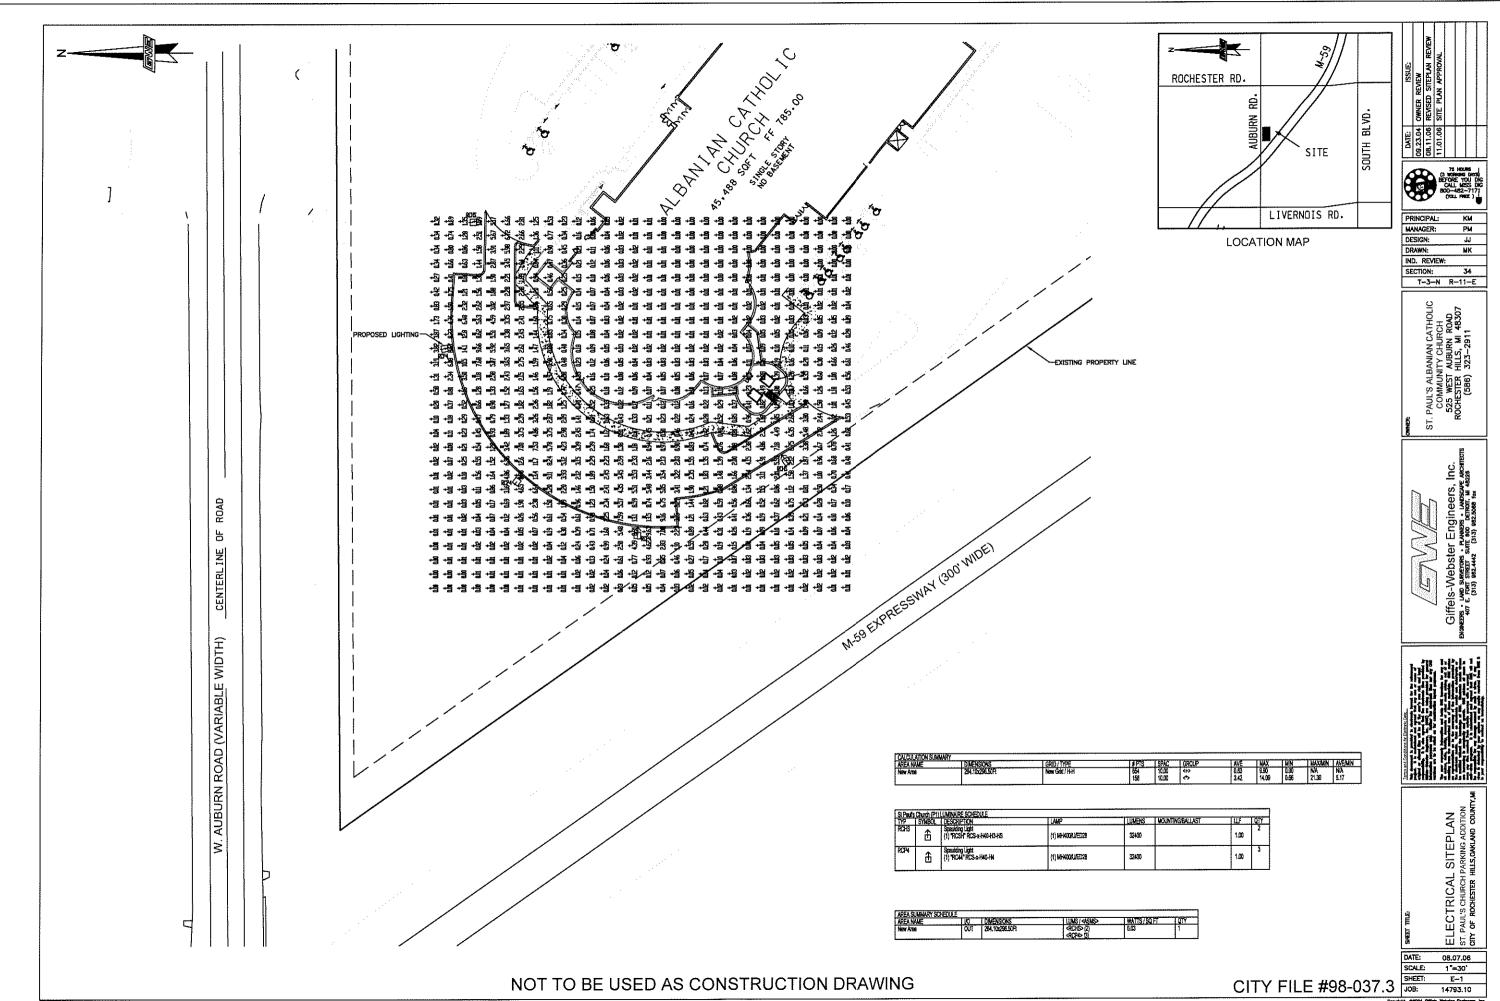

Deprint GEO Cities Moder Signam, So. No reproduction shall be much without the prior written command of Giffer Moder Conference and