
Adams Marketplace PROPOSED meijer

Rochester Hills, Michigan

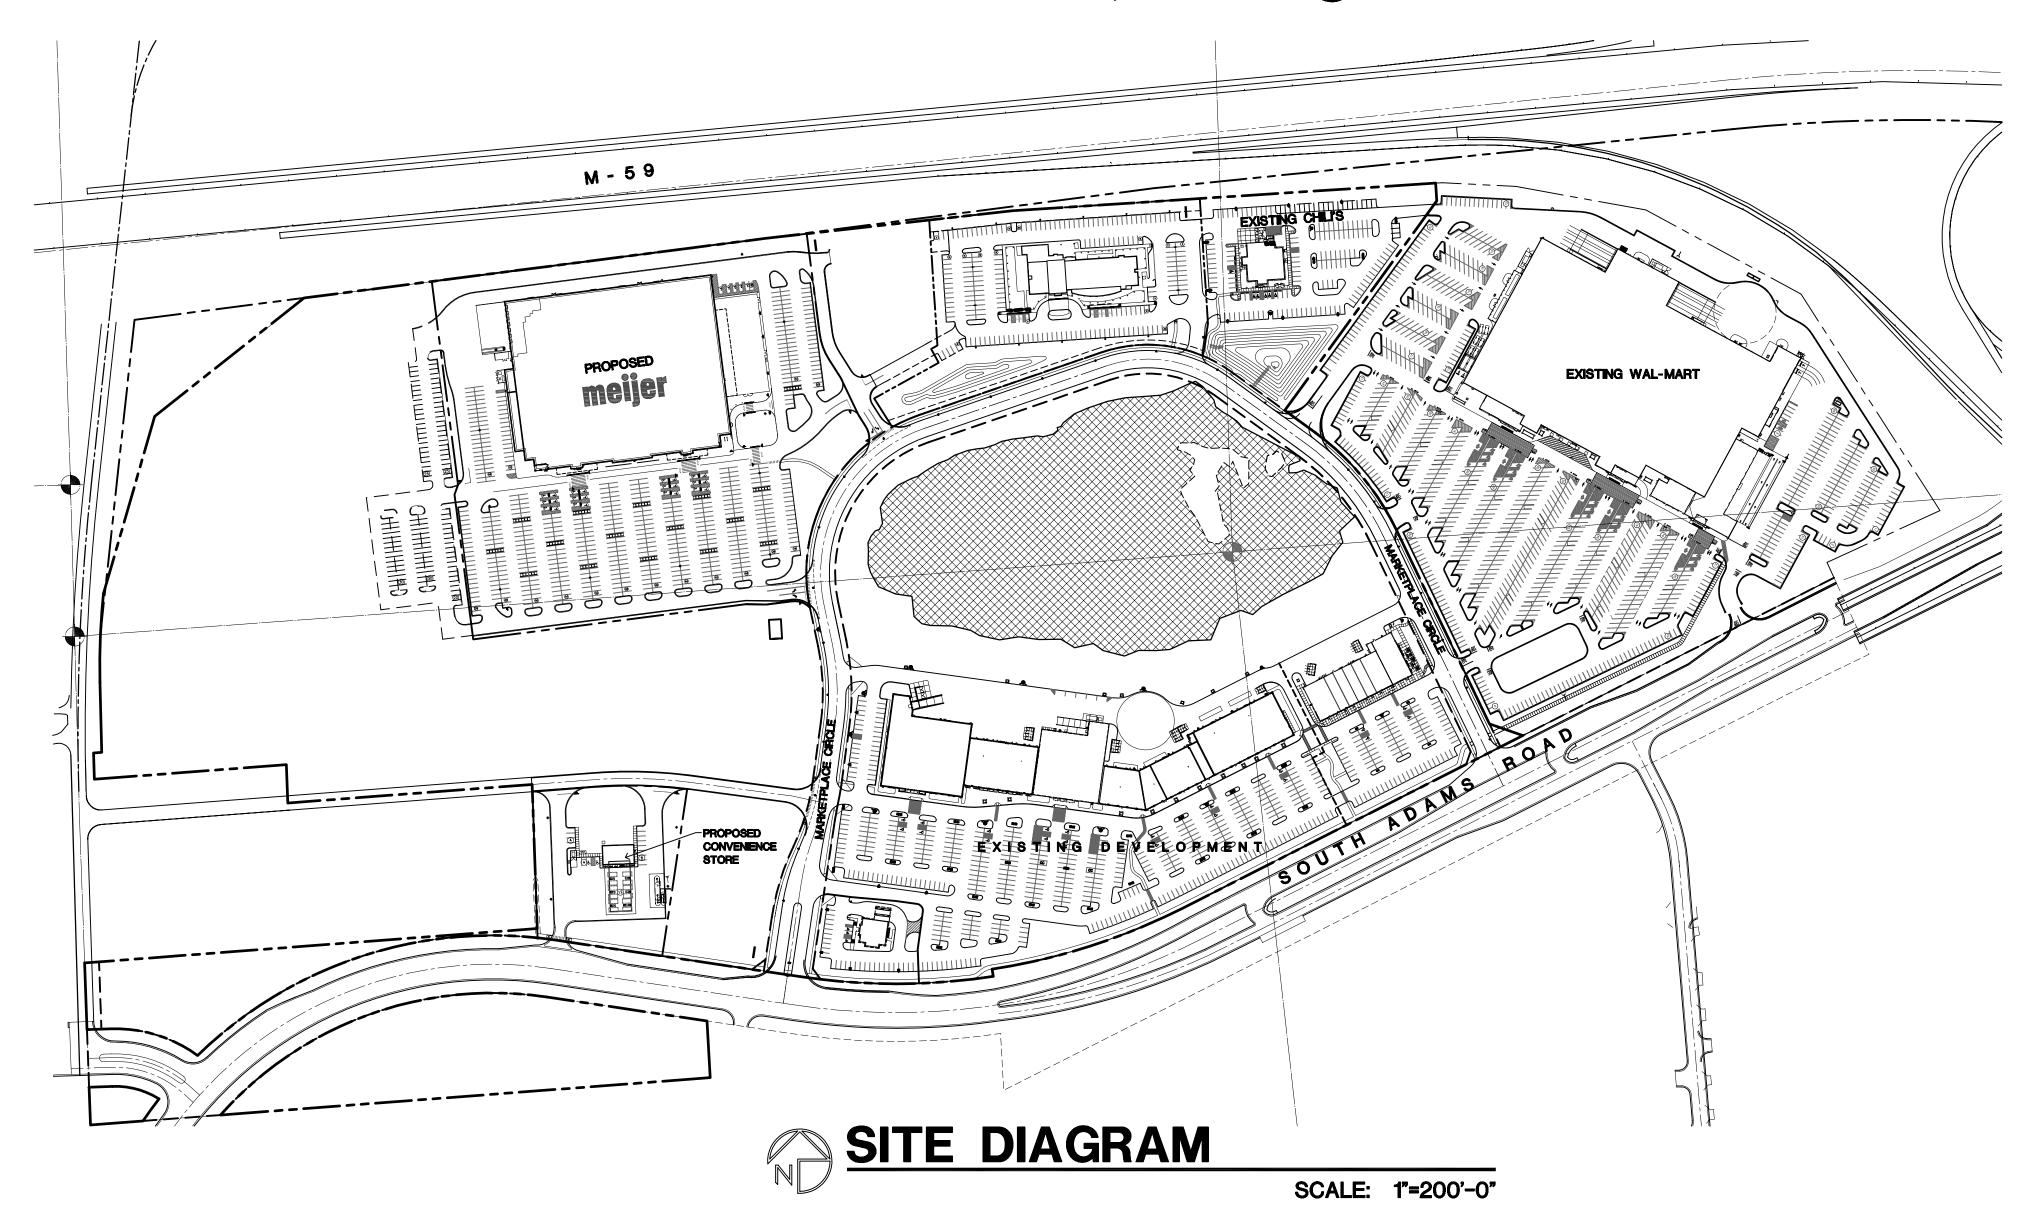

GENERAL NOTES:

ADJACENT PROPERTIES.

1.) THE SITE IS GOVERENED BY CONSENT JUDGEMENT AS OF APRIL 3, 2003 AND AMMENDED ON MAY 26, 2004.

2.) ALL EXTERIOR LIGHTING SHALL BE SHIELDED AND DIRECTED AWAY FROM

3.) ASPHALT SURFACING SHALL BE USED FOR ALL PARKING AREAS AND DRIVEWAYS, AND SHALL MEET ALL ORDINANCE REQUIREMENTS.

4.) ALL BUILDING AND SITE SIGNAGE SHALL BE SUBMITTED FOR REVIEW AT A LATER DATE AND WILL BE IN CONFORMANCE WITH THE CITY OF ROCHESTER HILLS AND THE CONSENT JUDGEMENT REQUIREMENTS. SEPARATE SIGN PERMIT WILL BE OBTAINED FROM THE BUILDING DEPT.

5.) BARRIER FREE RAMPS WILL BE PROVIDED AT ALL SIDEWALK APPROACHES.

6.) ALL ROOF TOP MECHANICAL EQUIPMENT WILL BE SCREENED BY BUILDING PARAPET WALLS AND/OR ROOF TOP UNIT SCREENING.

1.) TYPICAL BARRIER FREE PARKING SPACE DIMENSION IS 8'XI6' WITH EITHER A 5'XI6' ACCESS SPACE BETWEEN OR A 8'XI6' VAN ACCESSIBLE SPACE BETWEEN PER THE "MICHIGAN BARRIER FREE DESIGN MANUAL". ALL BF. SPACES SHALL BE MARKED WITH AN ABOVE GRADE SIGN.

8.) DIMENSIONS FOR PARKING SPACES AND MANEUVERING LANES ARE MEASURED FROM FACE OF CURB.

9.) THE SITE PLAN SHALL BE SUBJECT TO WRITTEN APPROVAL BY THE CITY'S FIRE MARSHALL.

10.) THE SITE PLAN SHALL BE SUBJECT TO WRITTEN APPROVAL BY THE CITY'S ENGINEER.

II.) FIRE LANES SHALL BE DESIGNATED BY THE FIRE CODE OFFICIAL, AND SHALL BE CONSPICUOUSLY POSTED ON BOTH SIDES OF THE FIRE LANE, WITH FIRE LANE SIGNS, SPACED NOT MORE THAN 100 FEET APART, ('NO STOPPING, STANDING, PARKING, FIRE-LANE'), AND IN CONFORMANCE WITH THE MICHIGAN MANUAL OF UNIFORM TRAFFIC CONTROL DEVICES. (FIRE PREVENTION ORDINANCE CHAPTER 58, SEC. 506).

12.) ALL PORTIONS OF A BUILDING SHALL BE WITHIN 150 FEET OF AN APPROVED FIRE DEPARTMENT ACCESS ROAD.

13.) FIRE DEPARTMENT ACCESS ROADS SHALL BE A MINIMUM 20' WIDE AND PAYED.

14.) FDC'S SHALL NOT BE OBSCURED OR OBSTRUCTED BY LANDSCAPING, PARKING OR BY ANY OTHER PERMANENT OR TEMPORARY MATERIALS OR DEVICE, SHALL BE LOCATED VISIBLY ON THE STREET FRONT OF THE BUILDING, AND WITHIN 100 FEET OF A FIRE HYDRANT, AND WITHIN 50 FEET OF AN APPROVED FIRE DEPARTMENT ACCESS ROAD. (FIRE PREVENTION ORDINANCE CHAPTER 58, SEC. 912.7 \$ SEC. 58-90.

15.) OPEN BURNING IS NOT PERMITTED INCLUDING THE BURNING OF TRASH, DEBRIS, OR LAND CLEARING MATERIALS. OPEN BURNING FOR WARMING OF SAND AND/OR WATER FOR THE PREPARATION OF MORTAR SHALL BE WITHIN THE CITY OF ROCHESTER HILLS BURN PERMIT GUIDELINES. (FIRE PREVENTION ORDINANCE CHAPTER 58, SE. 3016.2 & 3016.2.3)

16.) CONSTRUCTION SITE SHALL BE SAFEGUARDED IN ACCORDANCE WITH IFC 2006 CHAPTER 14, THIS INCLUDES MAINTAINING FIRE DEPARTMENT ACCESS ROADS AND FIRE HYDRANTS OPERATIONAL PRIOR TO BUILDING CONSTRUCTION. ALL FIRE HYDRANTS WILL BE OPERATIONAL PRIOR TO BUILDING CONSTRUCTION BASED ON THE IFC 2006.

17.) FIRE HYDRANT REQUIREMENTS WILL BE BASED ON CONSTRUCTION TYPE AND SQUARE FOOTAGE OF THE BUILDING.

18.) THERE WILL BE NO INDUSTRIAL WASTE OR PROPANE TANKS LOCATED ON-SITE.

19.) ALL CURBED PARKING LOT ISLANDS SHALL BE 2-3 FEET SHORTER THAN THE ADJACENT PARKING SPACES AND DRIVEWAYS.

21.) SEE PHOTOMETRIC PLAN FOR EXACT LOCATION OF PROPOSED LIGHT POLES.


22.) ACCESS TO PROPOSED CONSTRUCTION SITE SHALL BE PROVIDED AND MAINTAINED FROM BOTH NEW ADAMS ROAD AND MARKETPLACE CIRCLE.

23.) ALL HANDICAP SPACES ARE TO RECEIVE A HANDICAP SIGN AND HANDICAP SYMBOL PAINTED ON THE ASPHALT. THE STALL ADJACENT TO 8 FOOT STRIPED AISLE IS TO RECEIVE A "VAN ACCESSIBLE" SIGN.

24.) HANDICAP RAMPS TO HAVE MAXIMUM 1:12 SLOPE AND MUST BE CONSTRUCTED PER ADA AND MICHIGAN BARRIER FREE STANDARDS.

25.) A "KNOX" KEY SYSTEM SHALL BE INSTALLED, IN A LOCATION APPROVED BY THE FIRE CODE OFFICIAL. ORDERING INFORMATION IS AVAILABLE FROM THE FIRE DEPARTMENT. (IFC 2006 SEC. 506)

26.) DETECTABLE WARNING SURFACE SHALL COMPLY WITH THE REQUIREMENT PER THE AMERICAN NATIONAL STANDARD, ACCESSIBLE AND USABLE BUILDINGS AND FACILITIES, ICC/ANSI AII7.1-2003.

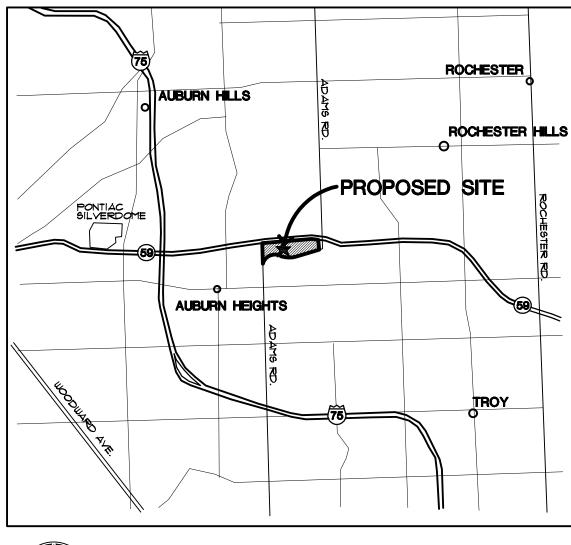

LOCATION MAP NOT TO SCALE

OWNER:

ROCHESTER HILLS
MARKETPLACE LLC

28470 THIRTEEN ROAD, SUITE 200
FARMINGTON HILLS, MICHIGAN 48334
(248) 855-5500
CONTACT: WILLIAM EISENBERG

LANDSCAPE ARCHITECT:

ATWELL-HICKS

140 MONROE CENTER
GRAND RAPIDS, MICHIGAN 49503
(616) 242-2000
CONTACT: JOHN ACKERMAN

CIVIL ENGINEER:

ATWELL-HICKS

140 MONROE CENTER
GRAND RAPIDS, MICHIGAN 49503
(616) 242-2000
CONTACT: STEVE ACHRAM

ZEIMET / WOZNIAK AND ASSOC. 40024 Grand River Avenue, Suite 100 Novi, Michigan 48375 (248) 442-1101 CONTACT: RICK HOFSES ARCHITECT:

FISHBECK, THOMPSON,

CARR & HUBER, INC.

DESIGNER ARCHITECT

1515 ARBORETUM DR.

GRAND RAPIDS, MI 49546

(616) 515-3824

CONTACT: GLENN SIGSBY

(616) 575-3824
CONTACT: GLENN SIGSBY

ROGVOY ARCHITECTS
COORDINATING ARCHITECT

32500 TELEGRAPH ROAD
SUITE 250
BINGHAM FARMS, MI 48025
(248)540-7700
CONTACT: MARK DRANE, A.I.A.

SHEET INDEX:

COVER	COVER			
C200		SITE LAYOUT PLAN		
SP-1.1		GRADING PLAN (STORE)		
SP-1.2		GRADING DETAILS		
SP-2		GRADING PLAN (CONVENIENCE STORE)		
5P-3		UTILITY PLAN (STORE)		
SP-4		UTILITY PLAN (CONVENIENCE STORE)		
SP-5		STORMWATER MANAGEMENT PLAN		
SP-6		EROSION CONTROL PLAN		
SP-7		ALTA / ACSM LAND TITLE SURVEY		
C600		LANDSCAPE PLAN		
C6Ø1		LANDSCAPE DETAILS		
C6Ø2		IRRIGATION PLAN		
C6Ø3		IRRIGATION PLAN		
C7ØØ		DETAILS		
C8Ø1		PHOTOMETRIC PLAN		
B-L		OVERALL FLOOR PLAN (STORE)		
B-L		BUILDING ELEVATIONS (STORE)		
A-1Ø1		FLOOR PLAN (CONVENIENCE STORE)		
В		BUILDING ELEVATIONS (CONVENIENCE STORE)		
EXHIBIT A		SIGHTLINE SECTION: VIEW POINT LOCATIONS		
EXHIBIT B		SIGHTLINE SECTIONS		
SUPPLEMENTAL DRAWINGS				
SHEET 26 OF 99		ADAMS ROAD RELOCATION		
SHEET 27 OF 99		ADAMS ROAD RELOCATION		

issued for:

REVISED 28 AUG. 08

SPA 2 SEPT. 08

REVISED 30 SEPT. 08

REVISED 28 OCT. 08

SPA 14 NOV. 08

Marketplace

ROGVOY
ARCHITECTS

32500 TELEGRAPH ROAD SUITE 250 BINGHAM FARMS, MICHIGAN 48025-2404

PH 248.540.7700 FX 248.540.2710 ARCHITECTS@ROGVOY.COM



drawing

COVER

DO NOT SCALE DRAWING


issue date: 14 Nov. 08 drawn: S.V. checked: M.D. approved: M.D.

file number:

CITY FILE NO. 08-005 SEC. 30

FIRE AND DELIVERY TRUCK ACCESS EXHIBIT

AUTOTURN

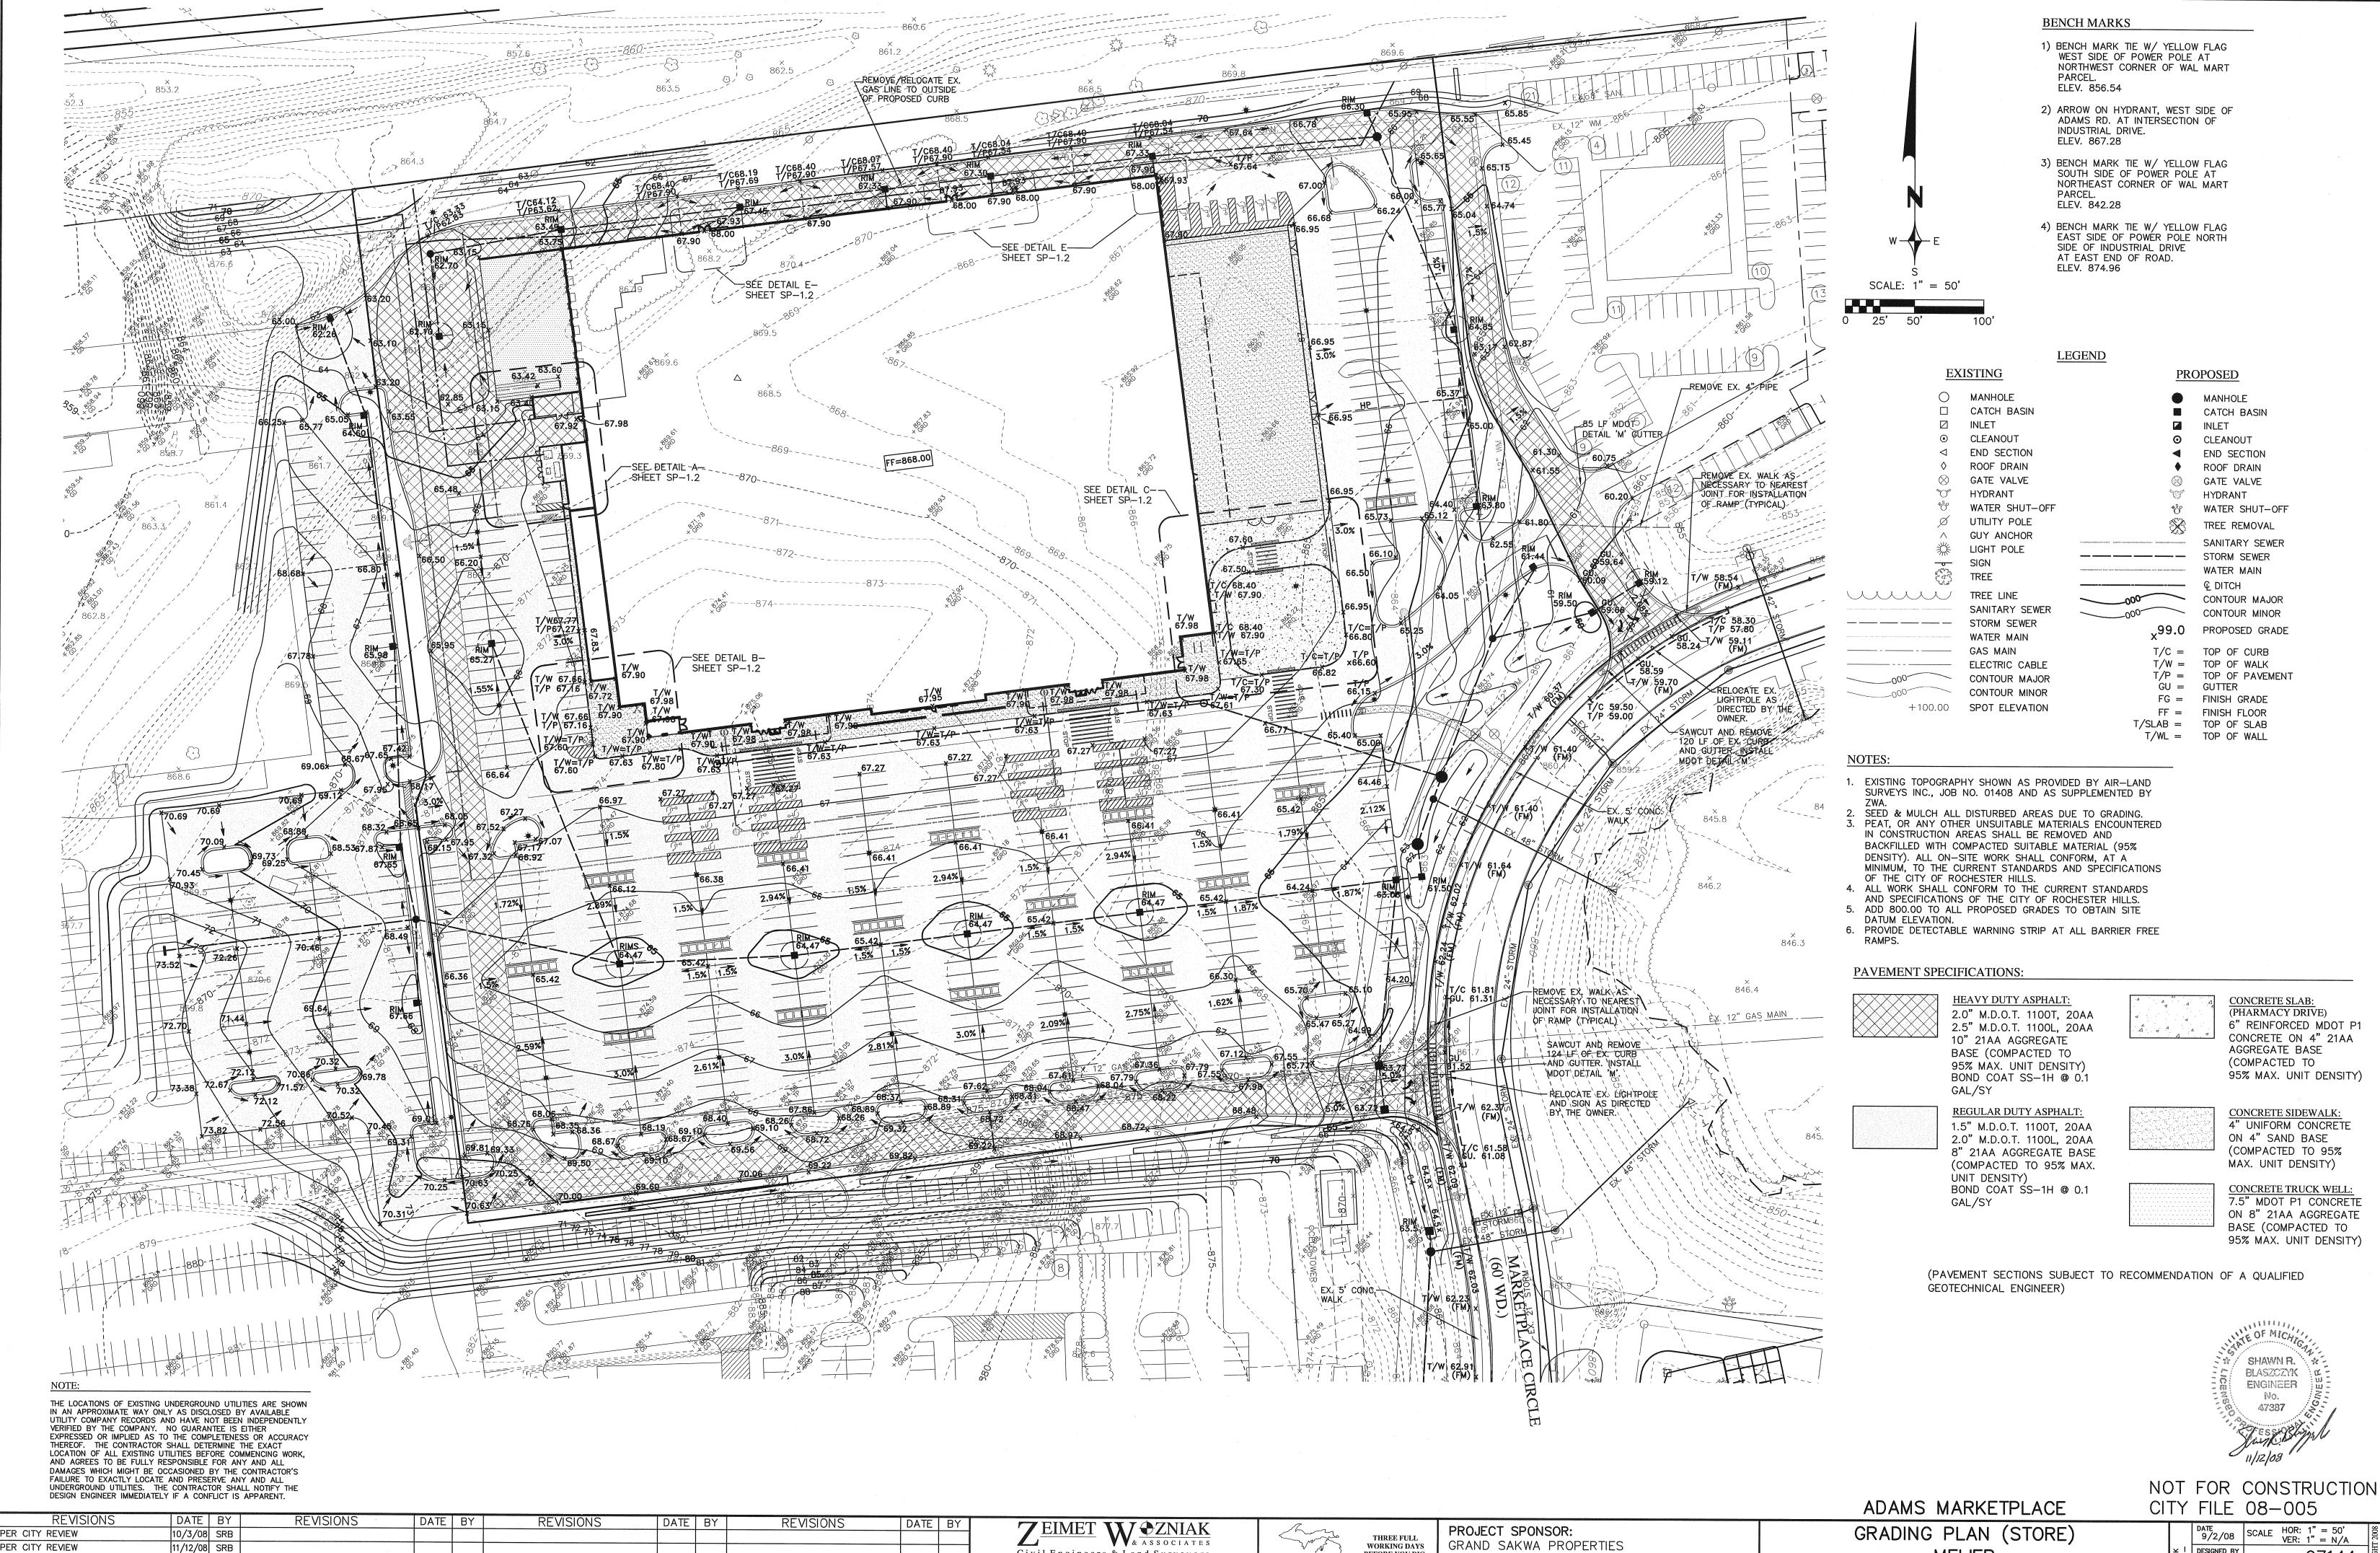

V & ASSOCIATES Civil Engineers & Land Surveyors 40024 GRAND RIVER AVE, SUITE 100 NOVI, MICHIGAN 48375 P: (248) 442-1101 F: (248) 442-1241 www.zeimetwozniak.com

PER CITY REVIEW

WORKING DAYS MISS DIG SYSTEM, INC. BEFORE YOU DIG, CALL THE MISS 1-800-482-7171


GRAND SAKWA PROPERTIES FARMINGTON HILLS, MI

28470 THIRTEEN MILE ROAD, SUITE 220 (248) 855-5500 GRADING PLAN (STORE) **MEIJER**

ROCHESTER HILLS, MICHIGAN

DATE 9/2/08 | SCALE | HOR: 1" = 50' VER: 1" = N/A DESIGNED BY SRB JOB NO. 97144 SHEET SP-1.1

DAB

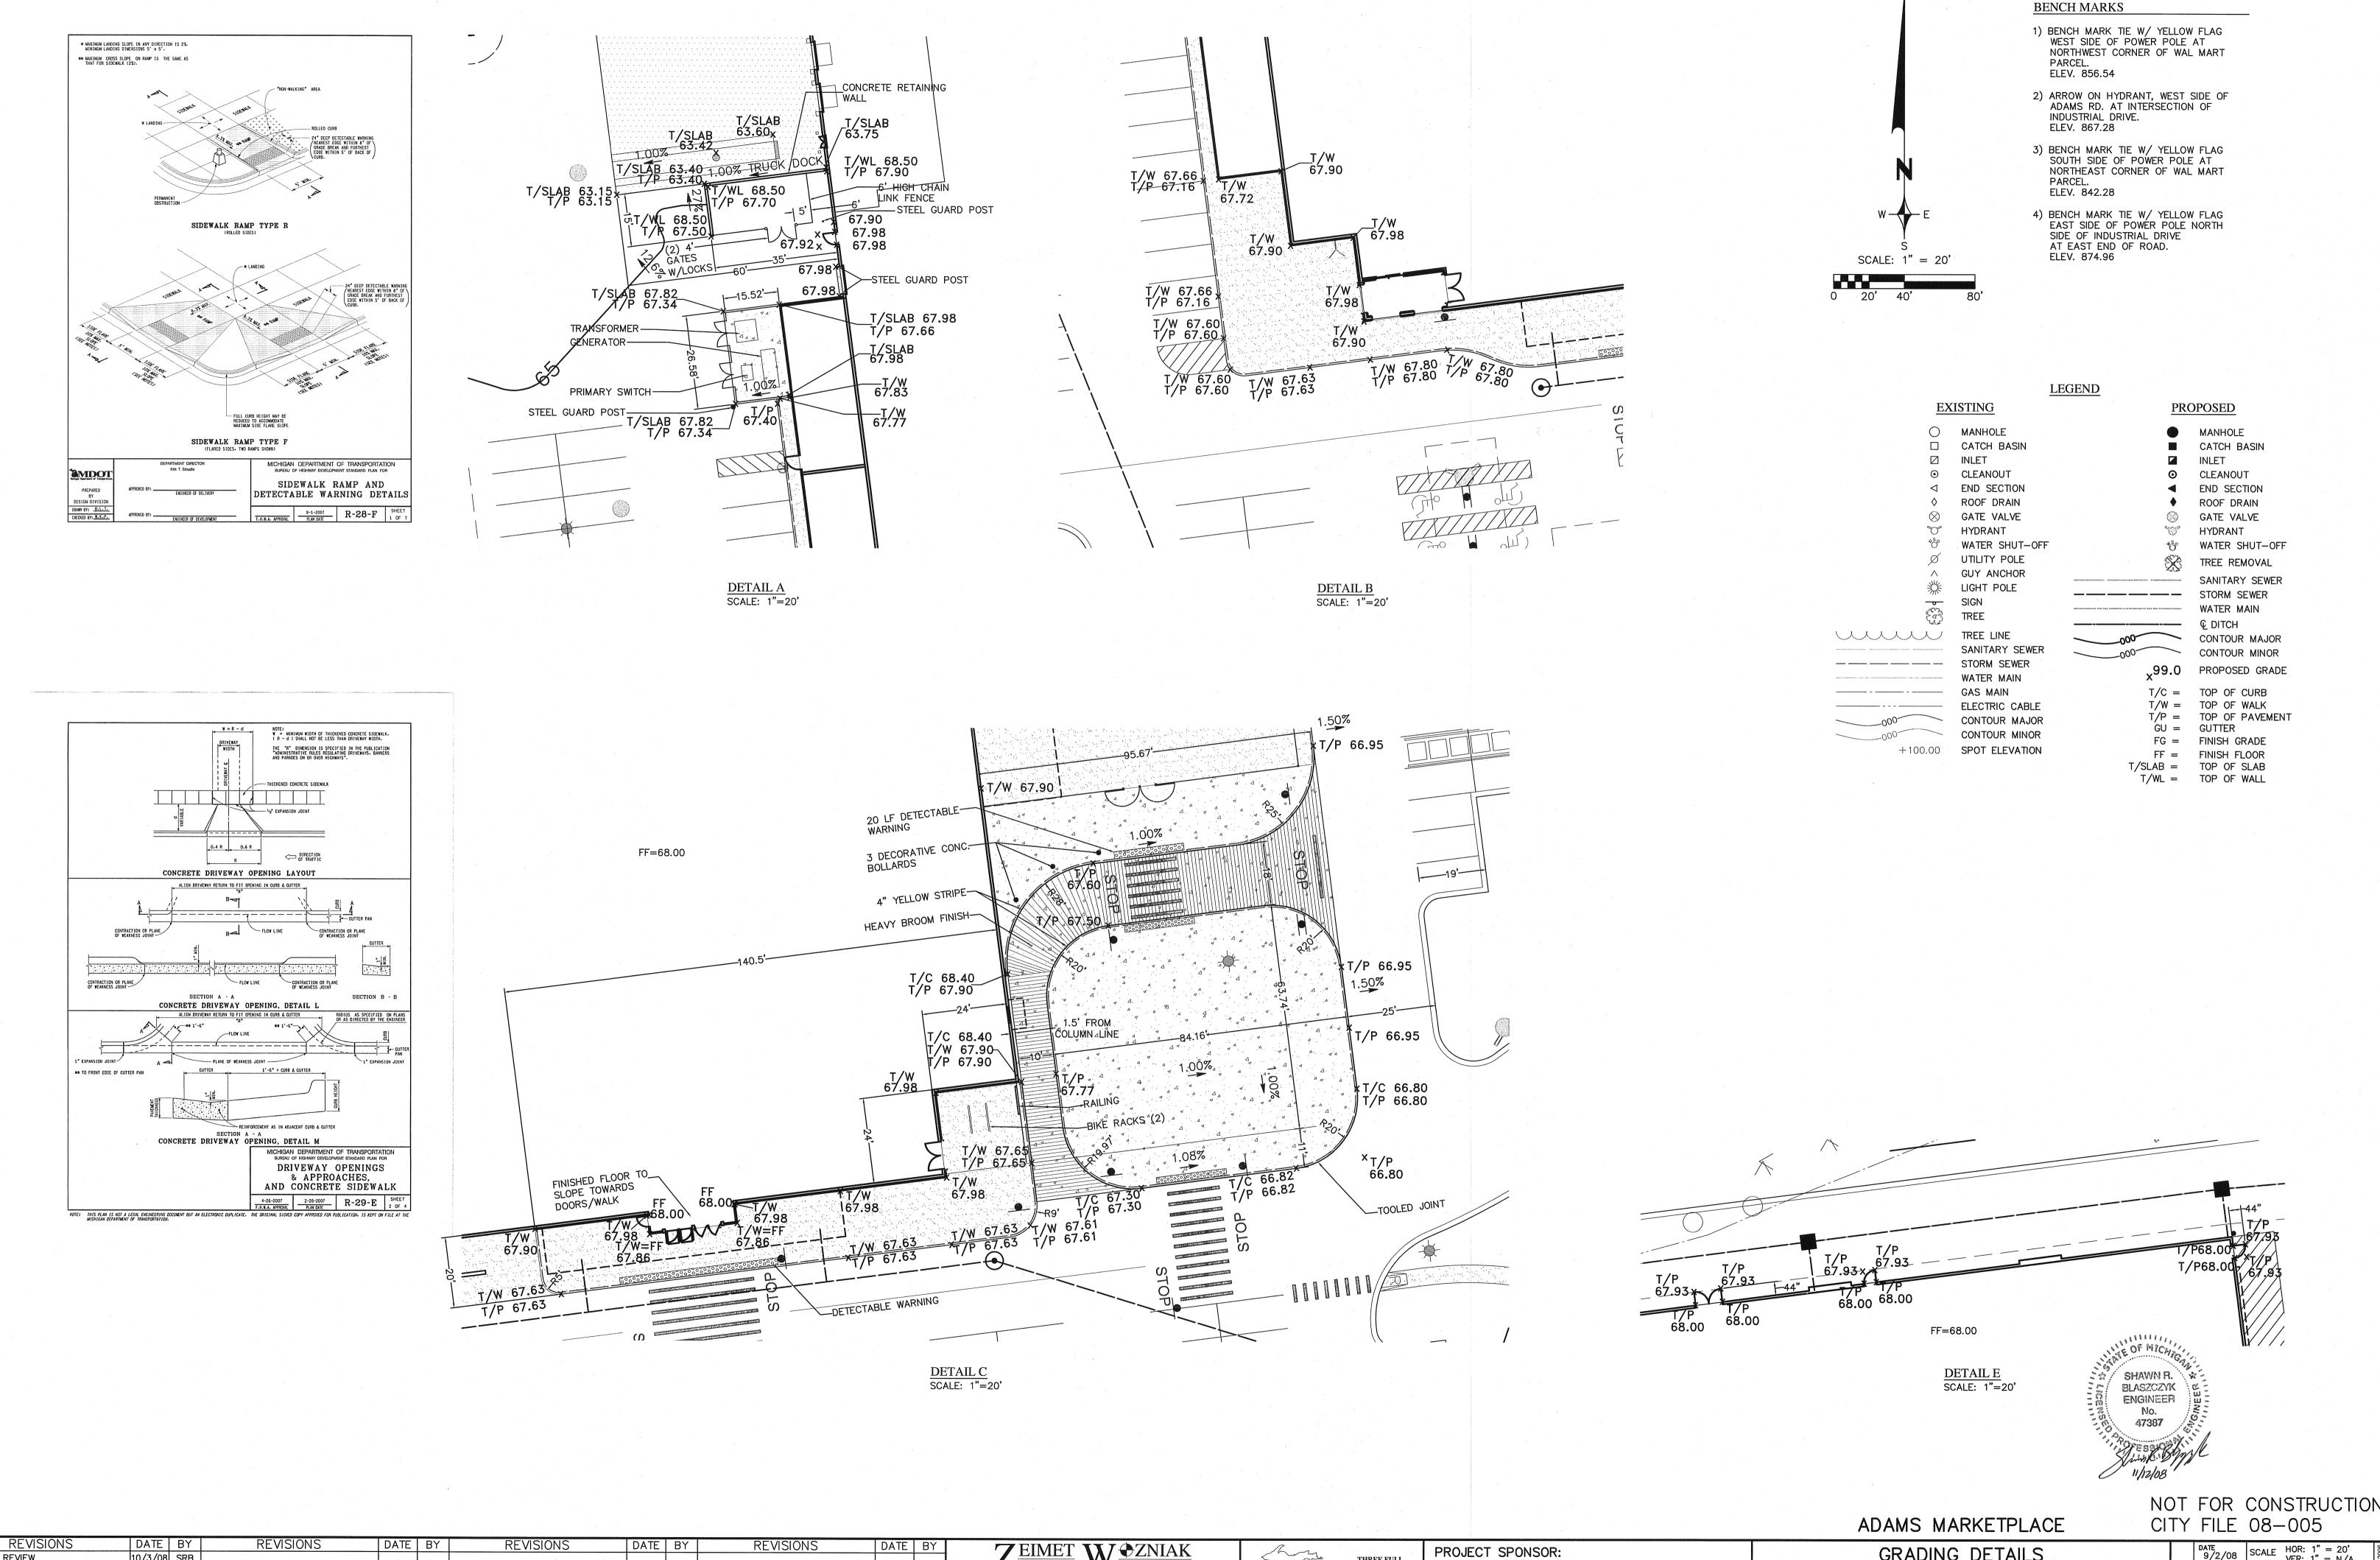

Civil Engineers & Land Surveyors 40024 GRAND RIVER AVE, SUITE 100

P: (248) 442-1101 F: (248) 442-1241 www.zeimetwozniak.com

NOVI, MICHIGAN 48375

THREE FULL WORKING DAYS

BEFORE YOU DIG,

MISS DIG SYSTEM, INC. BEFORE YOU DIG, CALL THE MISS

1-800-482-7171

GRAND SAKWA PROPERTIES

FARMINGTON HILLS, MI

28470 THIRTEEN MILE ROAD, SUITE 220

(248) 855-5500

PER CITY REVIEW

PER CITY REVIEW

10/3/08 SRB

11/12/08 SRB

GRADING DETAILS MEIJER ROCHESTER HILLS, MICHIGAN

PATE 9/2/08 SCALE HOR: 1" = 20' VER: 1" = N/A DESIGNED BY SRB JOB NO. 97144 DRAWN BY SHEET SP-1.2

SCALE: 1" = 50'

0 25' 50'

BENCH MARKS

- 1) BENCH MARK TIE W/ YELLOW FLAG WEST SIDE OF POWER POLE AT NORTHWEST CORNER OF WAL MART PARCEL.
- ELEV. 856.54 2) ARROW ON HYDRANT, WEST SIDE OF ADAMS RD. AT INTERSECTION OF

INDUSTRIAL DRIVE.

ELEV. 867.28

ELEV. 842.28

- 3) BENCH MARK TIE W/ YELLOW FLAG SOUTH SIDE OF POWER POLE AT NORTHEAST CORNER OF WAL MART PARCEL.
- 4) BENCH MARK TIE W/ YELLOW FLAG EAST SIDE OF POWER POLE NORTH SIDE OF INDUSTRIAL DRIVE AT EAST END OF ROAD. ELEV. 874.96

MANHOLE CATCH BASIN

END SECTION ROOF DRAIN

GATE VALVE

WATER SHUT-OFF

SANITARY SEWER

CONTOUR MAJOR CONTOUR MINOR PROPOSED GRADE

G OF MICH

SHAWN R.

BLASZCZYK

ENGINEER

No.

47387

TREE REMOVAL

STORM SEWER

WATER MAIN

T/C = TOP OF CURBT/W = TOP OF WALK

FG = FINISH GRADE

FF = FINISH FLOOR T/SLAB = TOP OF SLAB

T/WL = TOP OF WALL

GU = GUTTER

T/P = TOP OF PAVEMENT

HYDRANT

INLET CLEANOUT

LEGEND

<u>E</u>)	KISTING	PROPOSED	
	MANHOLE CATCH BASIN INLET CLEANOUT END SECTION ROOF DRAIN GATE VALVE HYDRANT WATER SHUT-OFF UTILITY POLE GUY ANCHOR LIGHT POLE SIGN		MANHOLE CATCH B INLET CLEANOU END SEC ROOF DR GATE VAI HYDRANT WATER S TREE REM SANITARY STORM S WATER M
	TREE TREE LINE SANITARY SEWER STORM SEWER WATER MAIN		© DITCH CONTOUR CONTOUR PROPOSE

NOTES:

1. EXISTING TOPOGRAPHY SHOWN AS PROVIDED BY AIR-LAND

GAS MAIN

+100.00 **SPOT ELEVATION**


ELECTRIC CABLE

CONTOUR MAJOR


CONTOUR MINOR

- SURVEYS INC., JOB NO. 01408. 2. SEED & MULCH ALL DISTURBED AREAS DUE TO GRADING. 3. PEAT, OR ANY OTHER UNSUITABLE MATERIALS ENCOUNTERED IN CONSTRUCTION AREAS SHALL BE REMOVED AND BACKFILLED WITH COMPACTED SUITABLE MATERIAL (95% DENSITY). ALL ON-SITE WORK SHALL CONFORM, AT A MINIMUM, TO THE CURRENT STANDARDS AND SPECIFICATIONS
- OF THE CITY OF ROCHESTER HILLS. 4. ALL WORK SHALL CONFORM TO THE CURRENT STANDARDS AND SPECIFICATIONS OF THE CITY OF ROCHESTER HILLS. 5. ADD 800.00 TO ALL PROPOSED GRADES TO OBTAIN SITE
- DATUM ELEVATION. 6. EXISTING BUILDINGS TO BE REMOVED BY OTHERS UNDER
- SEPARATE PERMIT. 7. PROVIDE DETECTABLE WARNING STRIP AT ALL BARRIER FREE

PAVEMENT SPECIFICATIONS:

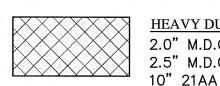

HEAVY DUTY ASPHALT: 2.0" M.D.O.T. 1100T, 20AA 2.5" M.D.O.T. 1100L, 20AA 10" 21AA AGGREGATE BASE (COMPACTED TO 95% MAX. UNIT DENSITY) BOND COAT SS-1H @ 0.1

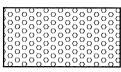

RAMPS.

8" REINFORCED MDOT P1 CONCRETE ON 4" 21AA AGGREGATE BASE (COMPACTED TO 95% MAX. UNIT DENSITY)



CONCRETE SIDEWALK: 4" UNIFORM CONCRETE ON 4" SAND BASE (COMPACTED TO 95% MAX. UNIT DENSITY)

CONCRETE TANK SLAB:

8" MDOT P1 CONCRETE

ON 4" 21AA AGGREGATE

BASE (COMPACTED TO 95% MAX. UNIT DENSITY

CONCRETE DUMPSTER PAD AND PUMP SLAB: 6" MDOT P1 CONCRETE ON 4" 21AA AGGREGATE BASE (COMPACTED TO 95% MAX. UNIT DENSITY)



2" M.D.O.T. 1100T 2" M.D.O.T. 1100L ON 4" 21AA AGGREGATE (COMPACTED TO 95% MAX. UNIT DENSITY) BOND COAT SS-1H @ 0.1 GAL/SY

NOT FOR CONSTRUCTION

DESIGN ENGINEER IMMEDIATELY IF A CONFLICT IS APPARENT. ADAMS MARKETPLACE CITY FILE 08-005 REVISIONS DATE BY REVISIONS DATE | BY REVISIONS DATE BY REVISIONS XXI OZNIAK GRADING PLAN (CONVENIENCE STORE) DATE 9/2/08 | SCALE HOR: 1" = 50' VER: 1" = N/A PROJECT SPONSOR: PER CITY REVIEW 10/3/08 SRB THREE FULL **V V** & ASSOCIATES GRAND SAKWA PROPERTIES WORKING DAYS PER CITY REVIEW 11/12/08 SRB DESIGNED BY SRB MEIJER Civil Engineers & Land Surveyors 40024 GRAND RIVER AVE, SUITE 100 JOB NO. 97144 BEFORE YOU DIG MISS DIG SYSTEM, INC. CALL THE MISS 28470 THIRTEEN MILE ROAD, SUITE 220 DIG SYSTEM NOVI, MICHIGAN 48375 FARMINGTON HILLS, MI ROCHESTER HILLS, MICHIGAN 1-800-482-7171 (248) 855-5500 DRAWN BY SHEET SP-2P: (248) 442-1101 F: (248) 442-1241 www.zeimetwozniak.com

INTEGRAL CURB-WALK DETAIL

NOTICE

CONSTRUCTION SITE SAFETY IS THE SOLE RESPONSIBILITY OF THE CONTRACTOR. NEITHER THE OWNER NOR THE ENGINEER SHALL BE EXPECTED TO ASSUME ANY RESPONSIBILITY FOR SAFETY OF THE WORK, OF PERSONS ENGAGED IN THE WORK, OF ANY NEARBY STRUCTURES, OR OF ANY OTHER PERSONS.

4 MAX.

MEET PROPOSED GRADE-PER PLAN

-10' WIDE EASEMENT-


2.00% CROSS SLOPE


PROPOSED PATHWAY


8' WIDE PATHWAY DETAIL

MEET EXISTING TOP OF


THE LOCATIONS OF EXISTING UNDERGROUND UTILITIES ARE SHOWN IN AN APPROXIMATE WAY ONLY AS DISCLOSED BY AVAILABLE UTILITY COMPANY RECORDS AND HAVE NOT BEEN INDEPENDENTLY VERIFIED BY THE COMPANY. NO GUARANTEE IS EITHER EXPRESSED OR IMPLIED AS TO THE COMPLETENESS OR ACCURACY THEREOF. THE CONTRACTOR SHALL DETERMINE THE EXACT LOCATION OF ALL EXISTING UTILITIES BEFORE COMMENCING WORK. AND AGREES TO BE FULLY RESPONSIBLE FOR ANY AND ALL DAMAGES WHICH MIGHT BE OCCASIONED BY THE CONTRACTOR'S FAILURE TO EXACTLY LOCATE AND PRESERVE ANY AND ALL UNDERGROUND UTILITIES. THE CONTRACTOR SHALL NOTIFY THE

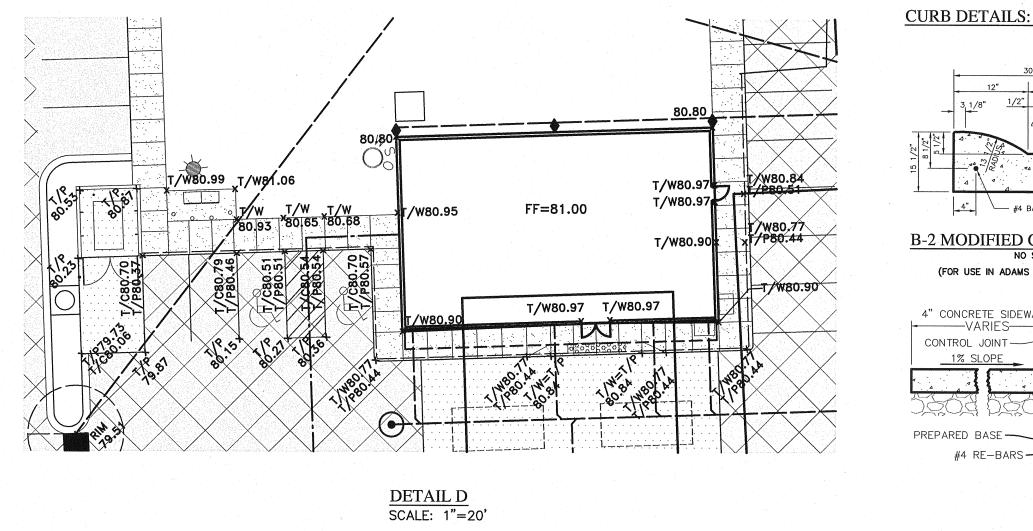

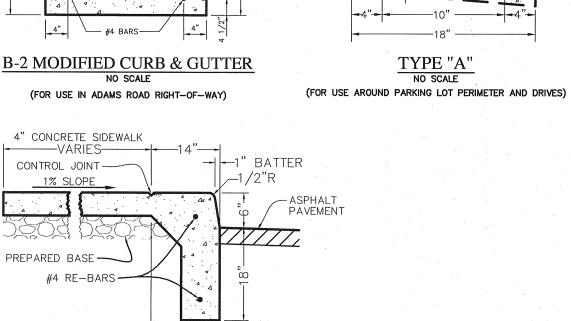

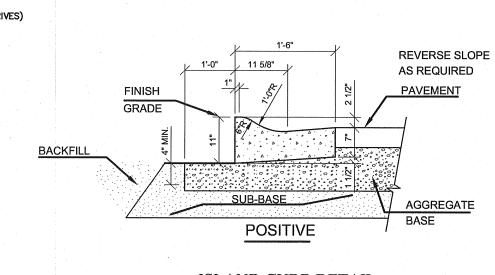

NEGATIVE

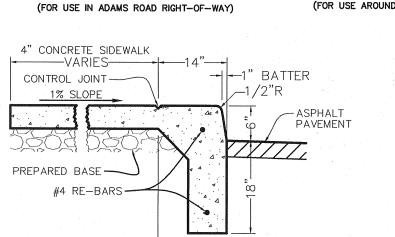

ISLAND CURB DETAIL NO SCALE

—10" ————————4"**-**

GAL/SY

ASPHALT PATHWAY:

