## CITY OF ROCHESTER HILLS FIRE STATION #5

251 E. TIENKEN, ROCHESTER HILLS, MICHIGAN 48309

## OWNER

CITY OF ROCHESTER HILLS 1000 ROCHESTER HILLS DRIVE

#### **ARCHITECT**

CHMP, INC 5198 TERRITORIAL ROAD GRAND BLANC, MICHIGAN 48439

#### STRUCTURAL

SNYDER & STALEY ENGINEERING, P.L.C. 3085 BAY ROAD SUITE 6 SAGINAW, MI 48603

## MECHANICAL / ELECTRICAL **ENGINEER**

DICLEMENTE SIEGEL DESIGN 1075 FAST BRISTOL ROAD (810) 238-7114 (FAX)

#### SHEET No. TITLE TITLE SHEET

TOPOGRAPHICAL SURVEY DEMOLITION PLAN SITE PLAN

#### **ARCHITECTURAL**

FLOOR PLAN- NEW WORK

#### **ELECTRICAL**


E-2 ELECTRICAL SITE PLAN

# SIDE VIEW PI AN VIEW **LAVATORY**

1. BUILDING AND STRUCTURAL 2. PLUMBING

3. MECHANICAL 4. ELECTRICAL

CODE REVIEW

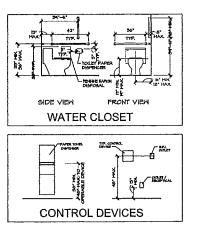

### DRAWING SYMBOLS

## Δ SECTION CUT $\bigcirc$ WINDOW REFERENCE $\Theta$ Δ REVISION NUMBER


(2012) (2012) (2011)

#### **ABBREVIATIONS**

_			INTERIOR
œ	AT	INT.	INTERIOR
<	ANGLE	JAN.	JANITOR
A.B.	ANCHOR BOLT	J.B /J. BOX	JUNCTION BOX
A.C.	AIR CONDITIONING	LAM.	LAMINATE
ACOUST.	ACOUSTICAL	LAV.	LAVATORY
ACCOUNT.	ACCOUNTAGE	LAT.	p. William
ADJ.	ADJUSTABLE	LL.	LANDLORD
A.F.F.	ABOVE FINISH FLOOR	MAS.	MASONRY
ALT.	ALTERNATE	MATL.	MATERIAL
ALUM.	ALUMINUM	MAX.	MAXIMUM
		MECH.	MECHANICAL
ARCH.	ARCHITECTURAL	MECH.	MECHANICAL
BLKG,	BLOCKING	MET.	METAL.
B.M.	BENCH MARK	MISC.	MISCELLANEOUS
BOT.	BOTTOM	MIN.	MINIMUM
			MASONRY OPENING
BRG.	BEARING	M.O.	
B.U.R.	BUILT UP ROOF	N.I.C.	NOT IN CONTRACT
CHNL.	CHANNEL	N.T.S.	NOT TO SCALE
C.T.	CERAMIC TILE	O.C.	ON CENTER
CJ.	CONTROL JOINT	O.D.	OUTSIDE DIAMETER
C.L./ Q	CENTER UNE	OPNG.	OPENING
CLG.	CEILING	OPP.	OPPOSITE
520	OLILING	0.11	
			D1 4 D20 0 1 44 H414 200
C.O.	CLEAN OUT	PLLAM.	PLASTIC LAMINATE
COL.	COLUMN	PL/ R	PLATE
CONC.	CONCRETE	PLYWO.	PLYWOOD
CONST. JT.	CONSTRUCTION JOINT	PR.	PAIR
CONT.	CONTINUOUS	R.A.	RETURN AIR
DBL.	DOUBLE	R.	RADIUS
DET.	DETAIL.	R.D.	ROOF DRAIN
DIA /Ø		REF.	REFRIGERATOR
	DIAMETER		
DIV.	DIVISION	REINF.	REINFORCING
DN.	DOWN	REQ.	REQUIRED
DW.	DISHWASHER	S.A.	SUPPLY AIR
D.S.	DOWN SPOUT	SFS	SURFACE FOUR SIDES
DWG.	DRAWING	S.C.	SOLID CORE
EA.	EACH	SHT.	SHEET
E.J.	EXPANSION JOINT	SPEC.	SPECIFICATION
L.U.	CAT AND ON TO	ur co.	DI LON JOINION
ELEC.	ELECTRICAL	S.S.	SERVICE SINK
ELEV.	ELEVATION	ST.STL.	STAINLESS STEEL
EQ.	EQUAL	STL.	STEEL
EST.	ESTIMATE	STOR.	STORAGE
E.W.	EACH WAY	STR.	STRUCTURAL
E.W.C.	ELECTRICAL WATER COOLER	Τ.	THERMOSTAT
EXP.	EXPANSION	T.C.	TOP OF CURB
	EXTERIOR	TEN.	TENANT
EXT.			
FIN. FLR./F.F.	FINISH FLOOR	T.G.C.	TENANT'S GENERAL CONTRACTOR
FIN.	FINISH	T.P. 1	TOP OF PAVING
FLR.	FLOOR	TYP.	TYPICAL
			UNLESS NOTED OTHERWISE
F.S.	FLOOR SINK	U.N.O.	
F.B.O.	FURNISHED BY OWNER	V.J.F.	VERIFY IN FIELD
F.D.	FLOOR DRAIN	V.T.R.	VENT THROUGH ROOF
FDN.	FOUNDATION	W.H.	WATER HEATER
0.4	ONIOE	W.I.	WROUGHT IRON
GA.	GAUGE		
GALV.	GALVANIZED	W.P.	WORK POINT
G.C.	GENERAL CONTRACTOR	W.R.	WATER RESISTANT
G.J.	GALVANIZED IRON	WT.	WEIGHT
H.B.	HOSE BIBB	W/	WITH
11.0.	HOOF DIGG	**/	******
H.C.	HOLLOW CORE	W/O	WITHOUT
HOWE.	HARDWARE		
H.M.	HOLLOW METAL		
I.D.	INSIDE DIAMETER		



LOCATION MAP

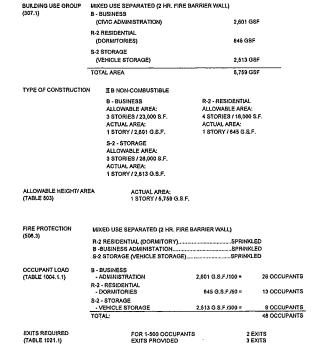

**BUILDING CODE INFORMATION** 

SPECIFICATIONS AND DRAWINGS AND SHALL SATISFY ALL APPLICABLE CODES, ORDINANCES. AND REQUIATIONS OF ALL GOVERNING BODIES INVOLVED. ALL PERMITS AND LICENSES NECESSARY FOR THE PROPER EXECUTION OF THE WORK SHALL BE SECURED AND PAID FOR


> MICHIGAN BUILDING CODE NATIONAL ELECTRICAL CODE


**CODE REVIEW INFORMATION - FIRE STATION #5** 



TITLE SHEET PROJECT No. 14003900 DECEMBER 11, 2014 ISSUED FOR: SITE PLAN APPROVAL **CITY FILE #14-019** 



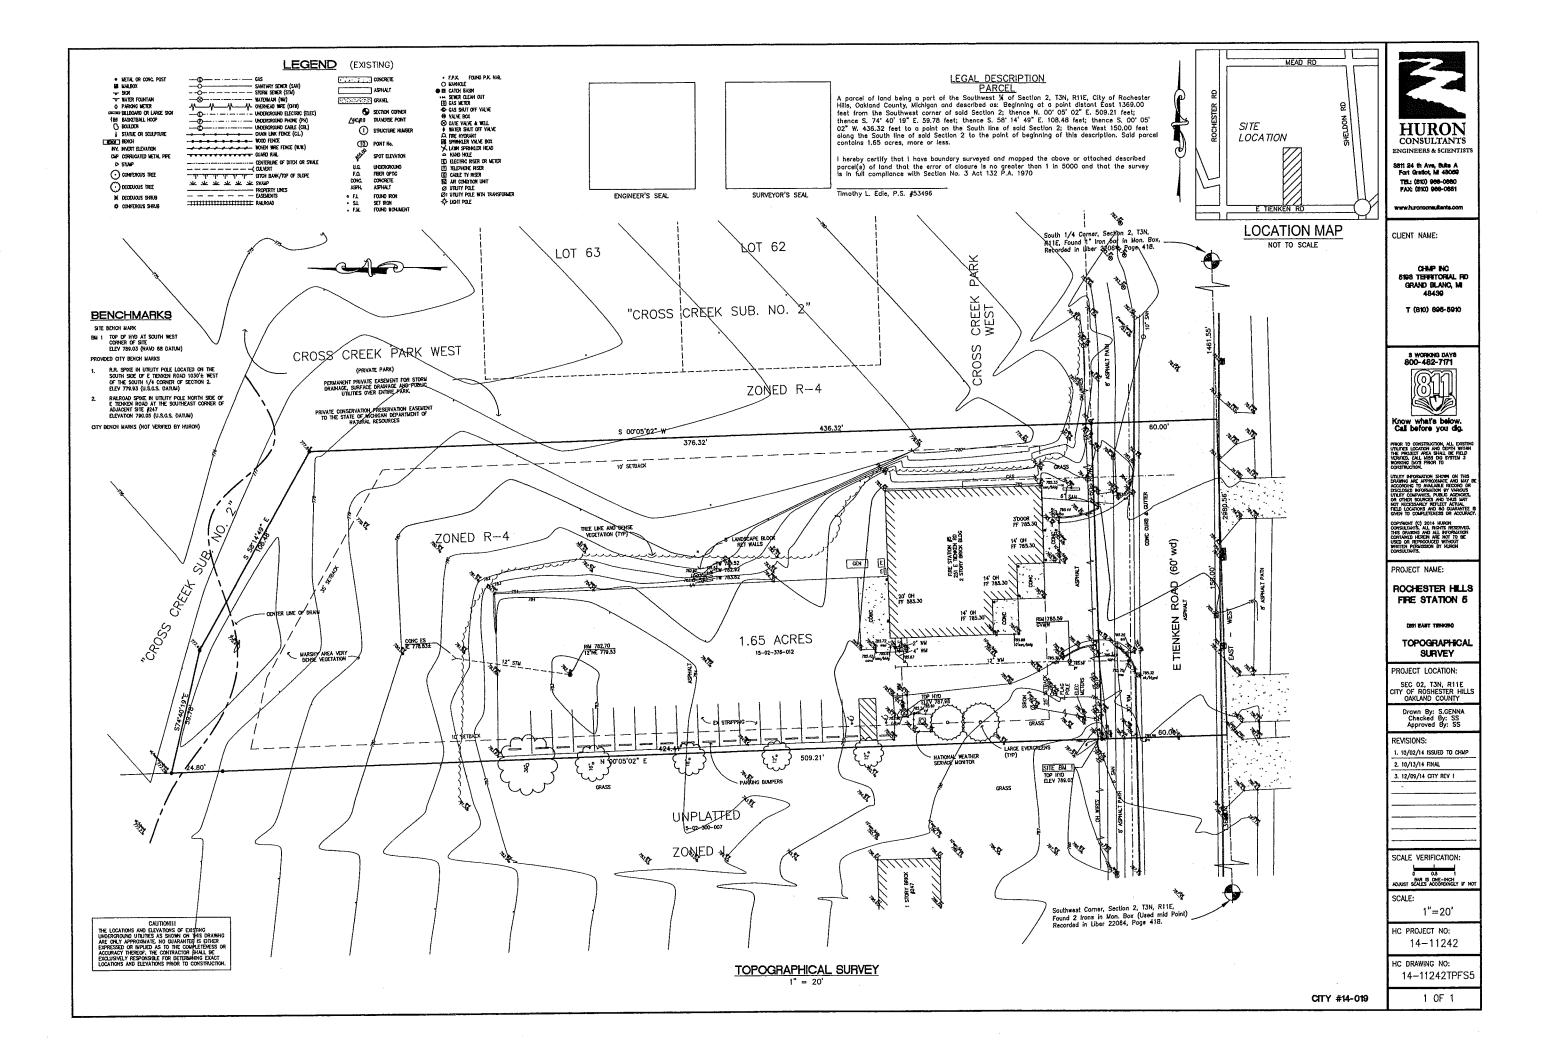

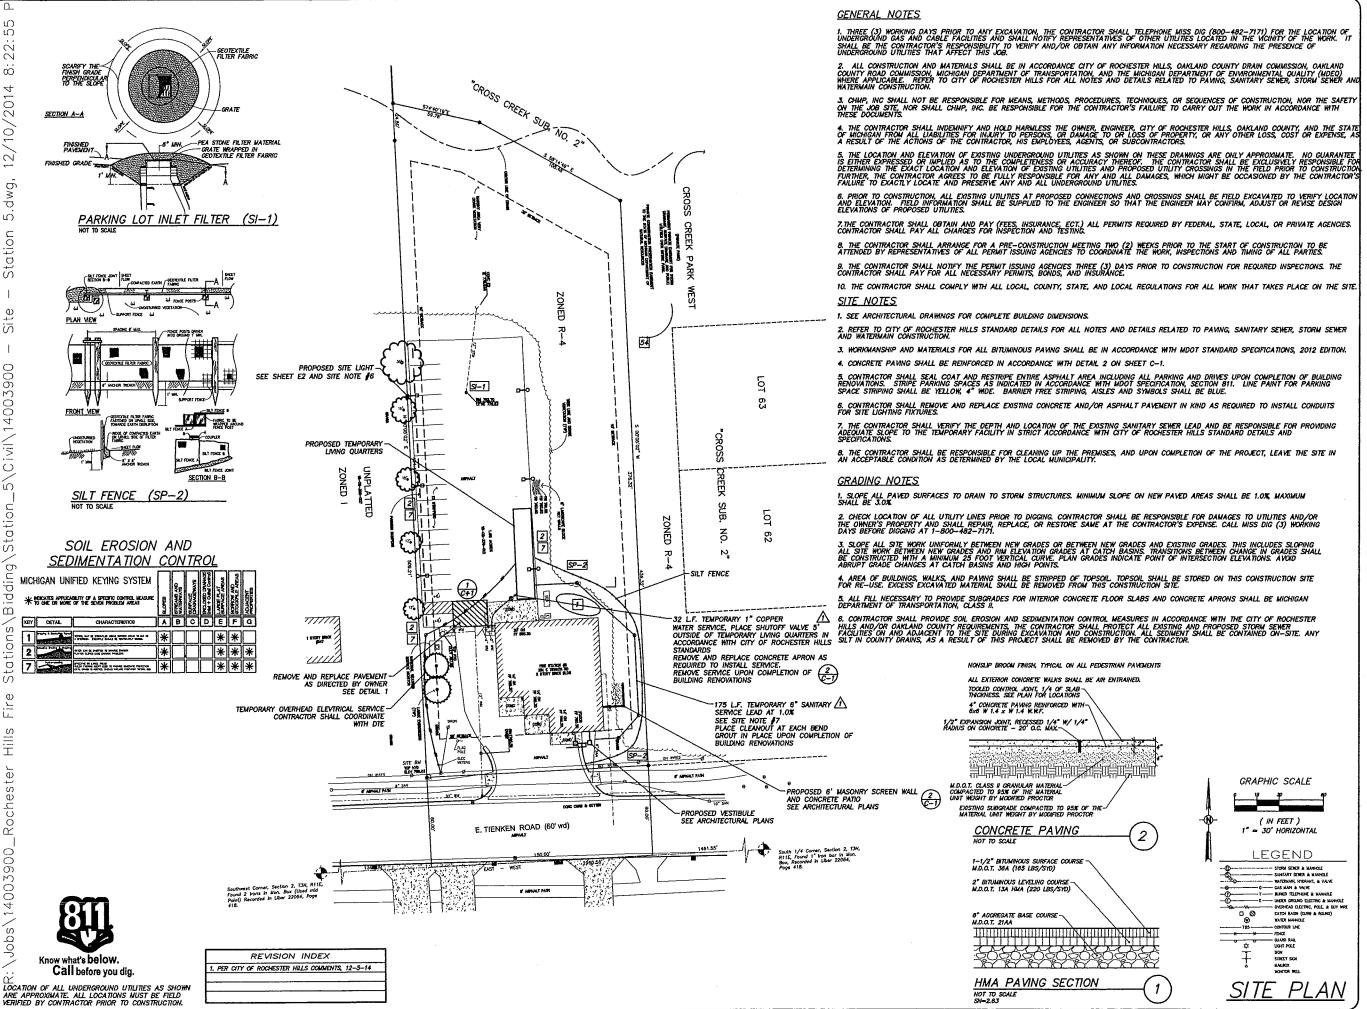

CHMP INC.

5100 TERRITORIAL ROAD

4RAND SLANC, MI 48400
TELEPHONE 810/806-5010




ARCHITECTURE
ENGINEERING
LANDSCAPE ARCHITECTURE
BURVEYING

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FOR: 三 **IMPROVEMENTS** 民業 Ш NOL I < BUILDING  $\mathbf{O}$ S 0 区三 Y AND 0 ш #E  $\Omega$ 

PROJECT NO. 14003400
DATE DRAWN: 11-17-14
DATE REVISED: 12-10-14
DRAWN BY KEC
CHECKED FOR DATE
SITE PLAN REVIEW 11-17-14
SITE PLAN APPROVAL 12-11-14
CHEST NO.

CITY FILE #14-019

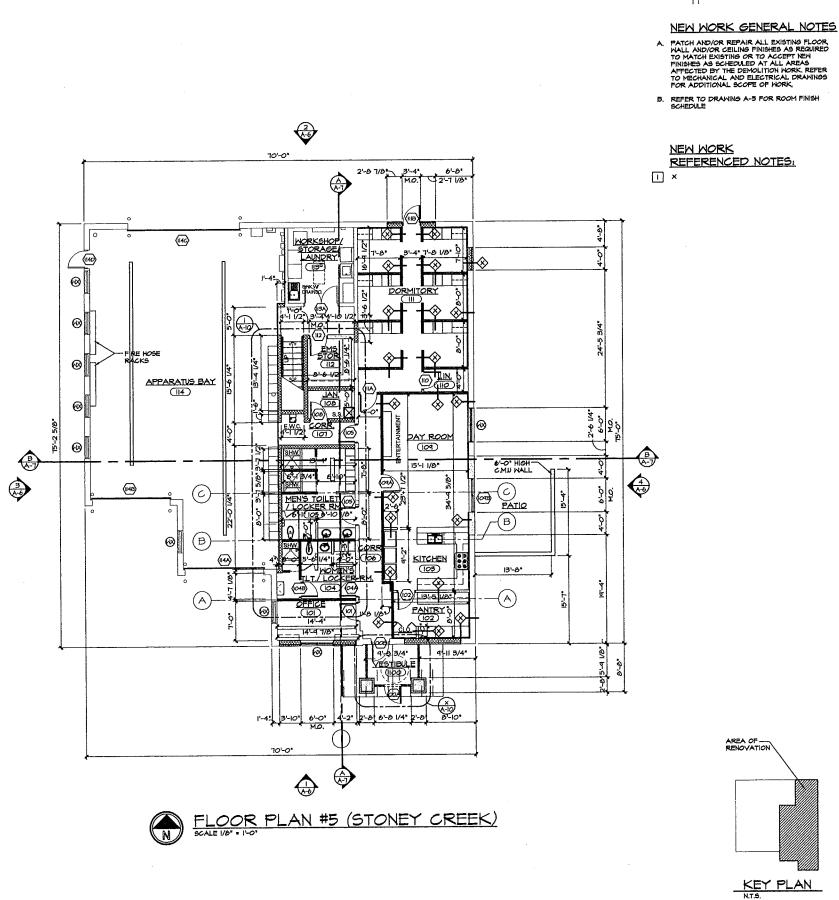

NEW WORK LEGEND

Partition Type - Refer To Wall Types Legend -SHEET A-2

AND BUILDING IMPROVEMENTS FOR:
Y OF ROCHESTER HILL:
FIRE STATION #5 SITE A

CHMP INC.
6108 TERRITORIAL ROAD
GRAND BLANC, MI 48488
TELEPHONE 810/686-8810

1400590 PROJECT NO. SEPT 8, 201 AS BUILT DATE VIII NWAF BOALE AS NOTED ISSUED FOR DATE NOV 17, 2014 STEP PLAN DEC 11, 2014 HEET NO.

CITY FILE - #14-019


FLOOR PLAN - MEZZANINE

MEZZANINE

(200)

MEZZANINE FINISH FLOOR EL 110'-0"

14'-4"

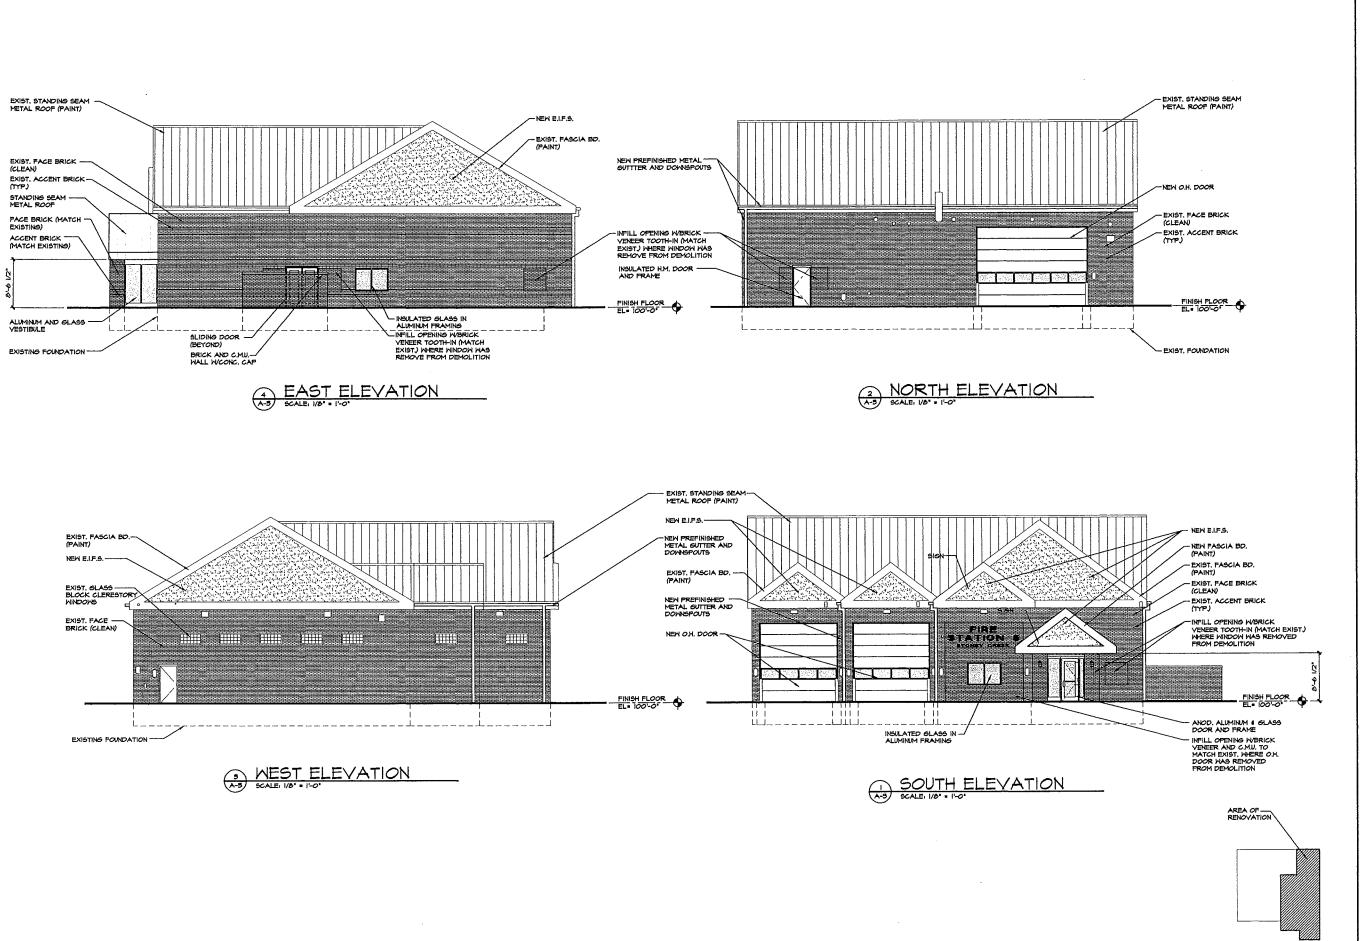

CHMP INC.

8108 TERRITORIAL ROAD

GRAND SLANG, MI 48430
TELEPHONE 810/808-8010



ARCHITECTURE
ENGINEERING
LANDSCAPE ARCHITECTUS
BURVEYING


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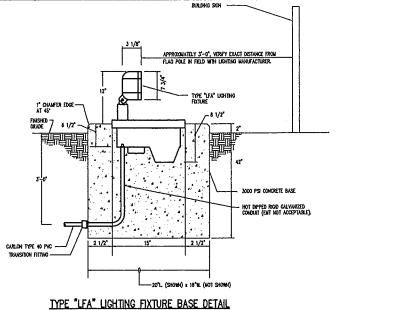
SITE AND BUILDING IMPROVEMENTS FOR:
CITY OF ROCHESTER HILLS
FIRE STATION #5
251 E. TIENKEN ROAD, ROCHESTER HILLS, MICHIGAN 48309

PROJECT NO. 14003400
DATE 9EPT 6, 2014
AS SHAT DATE
DRAWN BY JTS
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BOULED FOR DATE
SPETIONAL NOV IT, 2014
DEVELOPMENT DEC 11, 2014
SHEET NO.


CITY FILE - #14-019

KEY PLAN



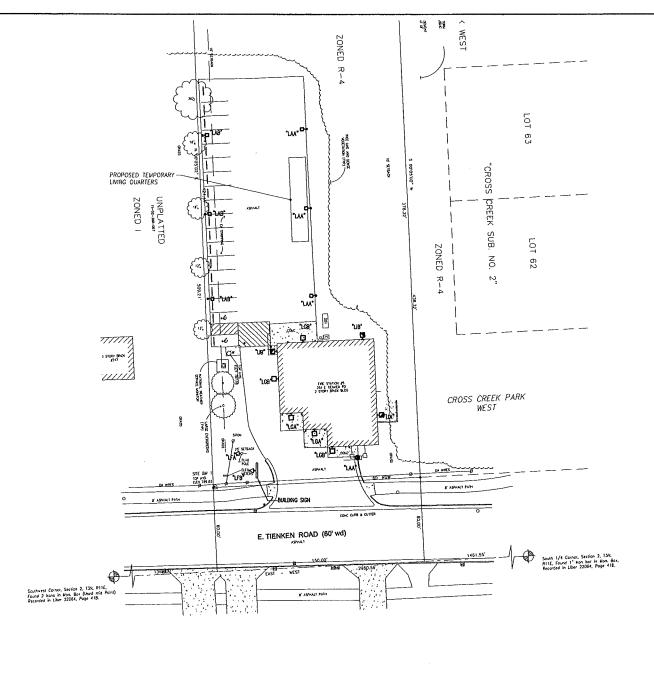

HOTE:
A. ALL WORK TO BE DONE BY THE CONTRACTOR, UNLESS OTHERWISE HOTED.

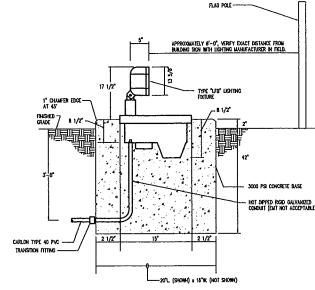

TYPE "LFB" LICHTING FIXTURE BASE DETAIL



4 WORKING DAYS BEFORE YOU DIG CALL MISS DIG 1-800-482-7171

PRIOR TO CONSTRUCTION, ALL LOCATIONS AND DEPTHS OF EXISTING UTILITIES (NICOMPLICT WITH PROPOSED IMPROVEMENTS SHALL BE VERIFIED IN THE FIELD, CALL M-1-8-8-0-1-G

Project No. 14-6921

CHMP INC.

SIDS TERRITORIAL ROAD QRAND BLANG, MI 48489 TELEPHONE 810/888-6810

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FOR:

D BUILDING IMPROVEMENTS FOR:

JF ROCHESTER HILLS

FIRE STATION #5

ENKEN ROAD, ROCHESTER HILLS, MICHIGAN 48309

FIENKEN F

251

AND I

SITE.

PROJECT NO.

AS BUILT DATE

RAWN BY

STE PLAN

DEVELOPMENT DESIGN

HECKED BY

SEPT 8, 20

DATE

NOV 17, 201-

Diclemente Siegel Design Inc.
1075 E Brital Rood, Britan, Michigan 48229
102281034 Feb 866238,7314
Engineerin

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Engineering and Architecture 14-6921.05

(1) EXISTING DTE CO. (DETROIT EDISON COMPANY) POWER POLE, TO PENAN.

- (2) NOICATES RELOCATED POSITION OF EXISTING TORNIADO ALARM SREN TOMER, SREN, SREN CONTROL PIANEL, TRANSFORMER, DISCONNECT SMITCH AND UNISTRUT, MILE TO NEW 1879-157, CROUTS F-21 & 23 IN ELETRICAL EQUIPMENT ROOM, 902 REFER TO CIVIL DRAWNG SHEET #0-1 FOR EXACT LOCATION.
- (3) NEW DTE CO. POWER POLE, PROVIDED AND INSTALLED BY DTE CO. VERSFY EXACT LOCATION IN FIELD WITH DTE CO.
- (B) NEW 4" DIAMETER UNDERGROUND CONDUIT STUBBED OUT TO POWER POLE AND CAPPED BY CONTRACTOR FOR COMCAST CABLE TELYSON CO. (COUCAST CTV CO.) SERVICE ENTRAIGHT FOR CONTRACT CTV CO.

  WHICH SHALL BE PROMOED AND INSTALLED BY CONCAST CTV CO.


  WERFY DOLCE ROUTING, TERMINATION POINT, POLE AND LOCATION WITH COMCAST CTV CO. IN FIELD.

**ELECTRICAL SITE PLAN** 

SCALE: 1" = 30'-0"

- (9) EXISTING DIE CO. OVERHEAD PRIMARY ELECTRICAL SERVICE WIRING TO REMAIN.
- (II) NEW DIE CO. OVERHEAD PRIMARY ELECTRICAL SERVICE WARNG, PROVIDED AND INSTALLED BY DTE CO.
- (1) NEW 120/208V-34-4W ELECTRIC SERVICE MCTER INCLUDING BASE AND C/T CABINET, PROVIDED BY DTE CO. AND INSTALLED ON SOE OF BUILDING BY CONTRACTOR.
- (2) NEW 4" DAWETER UNDERGROUND CONDUIT STUBBED OUT TO POWER POLE AND CLIPPED BY CONTRACTOR FOR CONCAST TEMPORE OS SERVED DIFFUNITION CLARES WHICH SHALL BE PROMIDED AND INSTALLED BY COMPAST CO. VEREY EXACT TEMPORTON PORT, POLE, ROUTING, AND LOCATION WITH COMPAST CO. IN FIELD.
- (I) NEW CONCRETE PAD AND FOOTINGS, PROVIDED AND INSTALLED BY CONTRACTOR PER DIE CO. STANDARDS/SPECIFICATIONS.

- (1) (2) NEW 4" DAMETER UNDERGROUND CONDUITS STUBBED OUT TO POWER POLE AND CAPPED BY COMPACTOR FOR DIE OA PROMAT ELECTRICAL SEMME DIFFIRMACE CARLES, WHICH SMALL BE PROVIDED AND INSTALLED BY DIE CO. VERRY DACE LOCATION, ROUTING, POLE AND TERMANION FORTY WHO THE CO. IN FILED.
- (5) NEW 120/2087-34-4W SECONDARY, PAD MOUNTED TRANSFORMER, PROVIDED AND INSTALLED BY DTE CO. PROVIDE 10"-0" CLEARANCE ON TRONT SIDE AND 4"-0" CLEARANCE ON THE OTHER THREE SIDES.
- (B) NEW UNDERGROUND 1°C.-2/10 AND 1/10 GROUND.
- (17) NEW UNDERGROUND 1°C.-2/12 AND 1/12 GROUND TYP. THIS CRICIAT.
- (B) FUTURE EMERGENCY GENERATOR INCLUDING REMOTE AMPUNICATOR PANEL, AUTOMATIC TRANSFER SMTCH, CONCRETE PAD AND GROUNDING BY OMMER. (19) 800 AND WHF RADIO ANTENNAS TO BE RISTALLED BY CONTRACTOR TO RELOCATED SIREN TOWER, ANTENNAS TO BE PROVIDED BY OTHERS.
- (2) 4" UNDERGROUND CONDUITS TO 800 AND WHF RADIO ECUPPLENT IN RADIO/DISPATCH \$157 BY CONTRACTOR, WARHG PROVIDED BY OTHERS, WISTALLED BY CONTRACTOR.

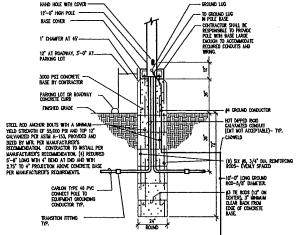

TYPICAL TYPE "LAA." AND "LAB" LIGHTING FIXTURE POLE BASE DETAIL

HOTE: ALL WORK TO BE DONE BY THE CONTRACTOR, UMIESS OTHERWISE MOIED.

NOT FOR CONSTRUCTION

12/10/14

These documents are two dimensional, traditional plan and specification documents that are not intended to be used by the contractor as always defined. First dimensional, equipment access, noting, misceleneous fittings, final installation and coordination is the contractor's responsibility.

4) ALL UTILITY COMPANY COSTS SHALL BE PAID FOR BY THE OWNER. (5) (2) NEW UNDERGROUND PARALLEL 3 1/2" SECONDARY ELECTRICAL SERVICE CONDUITS WITH (4) 500 NCM IN EACH, BY CONTRACTOR. (6) 8'W. X 8'H. X 3/4" D. CLASS A FIRE RATED MAIN TELEPHONE SERVICE PLYMODO BACKBOARD BY CONTRACTOR. (7) NEW 4" DAWETER UNDERGROUND CONDUIT STUBBED OUT TO POWER POLE AND CAPPED FOR ST. CLAR COUNTY FIER OPIC SERVICE DITARACT CABLES, WHICH SHALL BE PROVIDED AND INSTALLED BY CONTRACTOR. VERFY DOACT CABLE WOOL NAMEER, ROUTING, TERMATION POINT, POLE AND LOCATION WITH ST. CLAR COUNTY IN FIELD.