ROCHESTER HILLS RETAIL

FACADE RENOVATION & PARKING IMPROVEMENTS 1400 W. WALTON BLVD., ROCHESTER HILLS, MI 48309-1755

ARCHITECT

STUCKY VITALE ARCHITECTS 27172 WOODWARD AVENUE ROYAL OAK, MICHIGAN 48067 (248) 546-6700

CIVIL ENGINEER

PAUL BOOMER CREATIVE LAND PLANNING AND DESIGN

paul@creativelandllc.com

LANDSCAPE ARCHITECT NAGY DEVLIN LAND DESIGN 31736 WEST CHICAGO AVE. LIVONIA, MI. 48150 (734) 634-9208

PROJECT DATA:

BUILDING CODE AUTHORITY: CITY OF ROCHESTER HILLS

OWNER: CMP REAL ESTATE GROUP 6476 ORCHARD LAKE ROAD, SUITE A WEST BLOOMFIELD, MI. 48322 (248) 538-2000

cjonnaecmprealestategroup.com

(248) 538-9905

TYPE OF CONSTRUCTION:

USE GROUP:

UNCHANGED DUE TO SCOPE OF PROJECT

PROJECT AREA:

UNCHANGED DUE TO SCOPE OF PROJECT

WALTON BLVD.

PROJECT AREA

VICINITY MAP
SCALE: N.T.S.

APPLICABLE CODES: (COMMERCIAL):

BUILDING CODE: 2015 MICHIGAN REHABILITATION FOR EXISTING BUILDING 2015 MICHIGAN BUILDING CODE (MBC) AS AMENDED

2015 MICHIGAN MECHANICAL CODE AS AMENDED

2015 MICHIGAN PLUMBING CODE AS AMENDED

PLUMBING CODE:

2014 NATIONAL ELECTRIC CODE (NEC) AS AMENDED & MICHIGAN

AMMENDMENTS PART 8.

2015 MICHIGAN BUILDING CODE (CHAPTER 13) 2009 MICHIGAN UNIFORM ENERGY CODE ASHRAE 90.1-2013 ENERGY STANDARDS FOR BUILDINGS

2015 INTERNATIONAL FIRE CODE REFERENCED IN 2015 MICHIGAN **BUILDING CODE**

BARRIER FREE REQUIREMENTS:

2010 ADA STANDARDS FOR ACCESSIBLE DESIGN (DOJ) MBC-2012 (CHAPTER 11) ICC / ANSI 117.1 - 2009, EXCEPT SECTION 611 & 707

LIFE SAFETY CODES:

2015 NFPA 99 HEALTH CARE FACILITIES 2015 NFPA 101 LIFE SAFETY CODE

2013 NFPA 13 STANDARD FOR INSTALLATION OF SPRINKLER SYSTEMS 2013 NFPA 72 NATIONAL FIRE ALARM CODE

SITE PLAN DATA:

PARCEL ID. # 70-15-09-476-033

PROJECT DATA

ZONING DISTRICT: B3 - SHOPPING CENTER /BUSINESS


SITE AREA: 7.9884 AC

EXISTING RETAIL BUILDING A: 86.130SF EXISTING RETAIL BUILDING B: 10,870 SF TOTAL EXISTING RETAIL AREA: 97,000 SF

EXISTING PARKING:

PROPOSED PARKING IMPROVEMENTS/ RE-STRIPING: 404 SPACES

(INCL. 16 SP. HANDICAP)

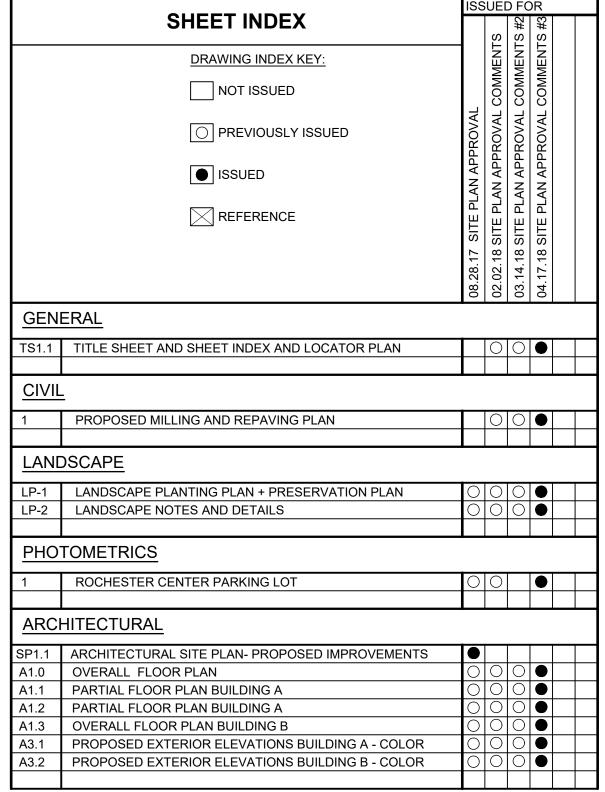

THESE CONSTRUCTION DRAWINGS WERE PREPARED FOR COMPLIANCE WITH THE MICHIGAN CONSTRUCTION CODES IN EFFECT AT THE TIME OF PERMIT SUBMITTAL. ALL ENGINEERS, CONTRACTORS AND SUPPLIERS INVOLVED WITH THIS PROJECT SHALL COMPLY WITH THE SAME CODES, ISSUED AND APPROVED CODE MODIFICATIONS AND/OR CITY CODE AUTHORITY CONSTRUCTION BOARDS OF APPEALS RULINGS AND WHENEVER REQUIRED SHALL PROVIDE SHOP DRAWINGS AND SUBMITTALS CLEARLY DESCRIBING COMPLIANCE TO THE REGISTERED DESIGN PROFESSIONAL IN RESPONSIBLE CHARGE FOR REVIEW AND APPROVAL.



ELEVATION RENDERING

SUED FOR

DARKENED ARROW INDICATES ELEVATED SECTION ACOUST. **ELEVATION NUMBER** SHEET NUMBER WHERE ELEVATION IS LOCATED - ELEVATION NUMBER A-X SHEET NUMBER WHERE ELEVATION IS LOCATED X A-X DETAIL REFERENCE NUMBER SHEET NUMBER WHERE DETAIL IS LOCATED DETAIL NUMBER X DETAIL — DETAIL NAME A-X SCALE: X/X" = 1'-0" --- DRAWING SCALE SHEET NUMBER WHERE DETAIL IS REFERENCED FIRST FLOOR - REFERENCE POINT OF ELEVATION
ELEV. 100'-0" - HEIGHT ABOVE FINISHED FLOOR NOTE: DATUM SYMBOL INDICATES A SPECIFIC REFERENCE HEIGHT OF MATERIAL INDICATED - ROOM NAME ROOM NUMBER XX-# FINISH TAG NUMBERS DESIGNATE VERTICAL COLUMN LINES LETTERS DESIGNATE HORIZONTAL COLUMN LINES CIRCLES REPRESENT NEW COLUMN LINES DASHED DIAMOND REPRESENT EXISTING EXISTING DOOR SYMBOL - NEW DOOR SYMBOL DOOR DESIGNATION WALL TYPE DESIGNATION NUMBER -COORDINATE WITH SCHEDULE EQUIPMENT DESIGNATION NUMBER -COORDINATE WITH PLAN NOTES KEY NOTE DESIGNATION NUMBER WINDOW DESIGNATION NUMBER -COORDINATE WITH PLAN NOTES ADDENDUM DESIGNATION NUMBER

PARTICLE BOARD

PLYWOOD

SYMBOL LEGEND

ANOD. ANODIZED BOARD BUILDING BLOCK BLOCKING CFM. CEMENT **CONTROL JOINT** CEILING **CENTER LINE CLEAN OUT** COLUMN CONCRETE CONC. **CORNER GUARD** CONST CONSTRUCTION CONT. CONTINUOUS CORRUGATED CARPET **CERAMIC TILE** DETAIL DIAMETER DIMENSION DOWN DOOR OPENING DOOR **DRAWING** EACH **ELEVATION EACH WAY EXISTING** EXIST. **EXISTING** EXPANSION, EXPOSED **EXTERIOR** FLOOR DRAIN **FOUNDATION** FIBER REINFORCED PANELS FINISH **FLOOR** FACE OF F.O.S. FACE OF STUD FOOTING FIELD VERIFY GALVANIZED GALV. GYPSUM HARDWARE **HOLLOW METAL** HORIZ. HORIZONTAL **INSIDE DIAMETER** INSUL. INSULATION INTERIOR LAVATORY LONG LEG OUTSTANDING LONG LEG VERTICAL MECH. **MECHANICAL** METAL MEZZ. MEZZANINE MISCELLANEOUS IRON MINIMUM MISC. **MISCELLANEOUS** MASONRY OPENING NOT IN CONTRACT N.T.S. NOT TO SCALE ON CENTER **OUTSIDE DIAMETER** OPNG. OPENING OPP. OPPOSITE PL.G. PLATE GLASS PLATE STEEL P.LAM PLASTIC LAMINATE PLAS. PLASTER PREFAB. PREFABRICATED PROJ. PROJECT, PROJECTION P.S.F. POUNDS PER SQUARE FOOT PAINT, POINT - BULLETIN DESIGNATION NUMBER RETURN AIR RUBBER BASE ROOF CONDUCTOR MATCH LINE REFLECTED CEILING PLAN **ROOF DRAIN** REF: A3 → —— SHEET REFERENCE FOR DRAWING CONTINUATION RUBBER FLOORING REINF. REINFORCED, REINFORCING REQ'D. REQUIRED ROOFING MATERIAL LEGEND ROOM R.S. **ROOF SUMP RUBBER TILE** SANITARY ACOUSTICAL CEILING SCHED. SCHEDULE SHEET SIMILAR SPEC. **SPECIFICATION** BATT/LOOSE INSULATION SERVICE SINK STEEL STANDARD BLOCKING/ROUGH LUMBER - CONTINUOUS STOR. STORAGE STRUCT. STRUCTURAL SUSP. SUSPENDED BLOCKING/ROUGH LUMBER SWITCH SYM. SYMMETRICAL ٩.۵. . ۵. . ۵. TOP AND BOTTOM CONCRETE TELEPHONE TERR. TERRAZZO T&G TONGUE AND GROOVE FINISHED WOOD THICK, THICKNESS THRES. THRESHOLD T.O.S. TOP OF STEEL GLASS TYP. TYPICAL UNDERCUT UNLESS NOTED OTHERWISE U.N.O. GYPSUM WALLBOARD V.B. VINYL BASE V.C.T. VINYL COMPOSITION TILE V.I.F. VERIFY IN FIELD MASONRY WIDE VERT. **VERTICAL**

WAINS. WAINSCOT WATER CLOSET WD.WIN. WOOD WINDOW WEIGHT W.W.F. WELDED WIRE FABRIC

ABBREVIATION

ACOUSTICAL

ADJACENT

ALUMINUM

ACOUSTIC CEILING TILE

ABOVE FINISH FLOOR

STUCKY VITALE ARCHITECTS 27172 WOODWARD AVENUE ROYAL OAK, MI 48067-0925 P. 248.546.6700 F. 248.546.8454 W W W . STUCKYVITALE.COM

Project :

ROCHESTER HILLS FACADE RENOVATION LIVERNOIS + W.WALTON RD. ROCHESTER HILLS. MI

Issued for: SITE PLAN 08.28.17 **APPROVAL** SITE PLAN APPROVAL COMMENTS SITE PLAN APPROVAL COMMENTS #2 03.14.18 SITE PLAN APPROVAL COMMENTS #3 04.17.18





Checked by

Sheet Title: TITLE SHEET. SHEET INDEX, -LOCATOR PLAN

Project No. : 2017.022

Sheet No. :

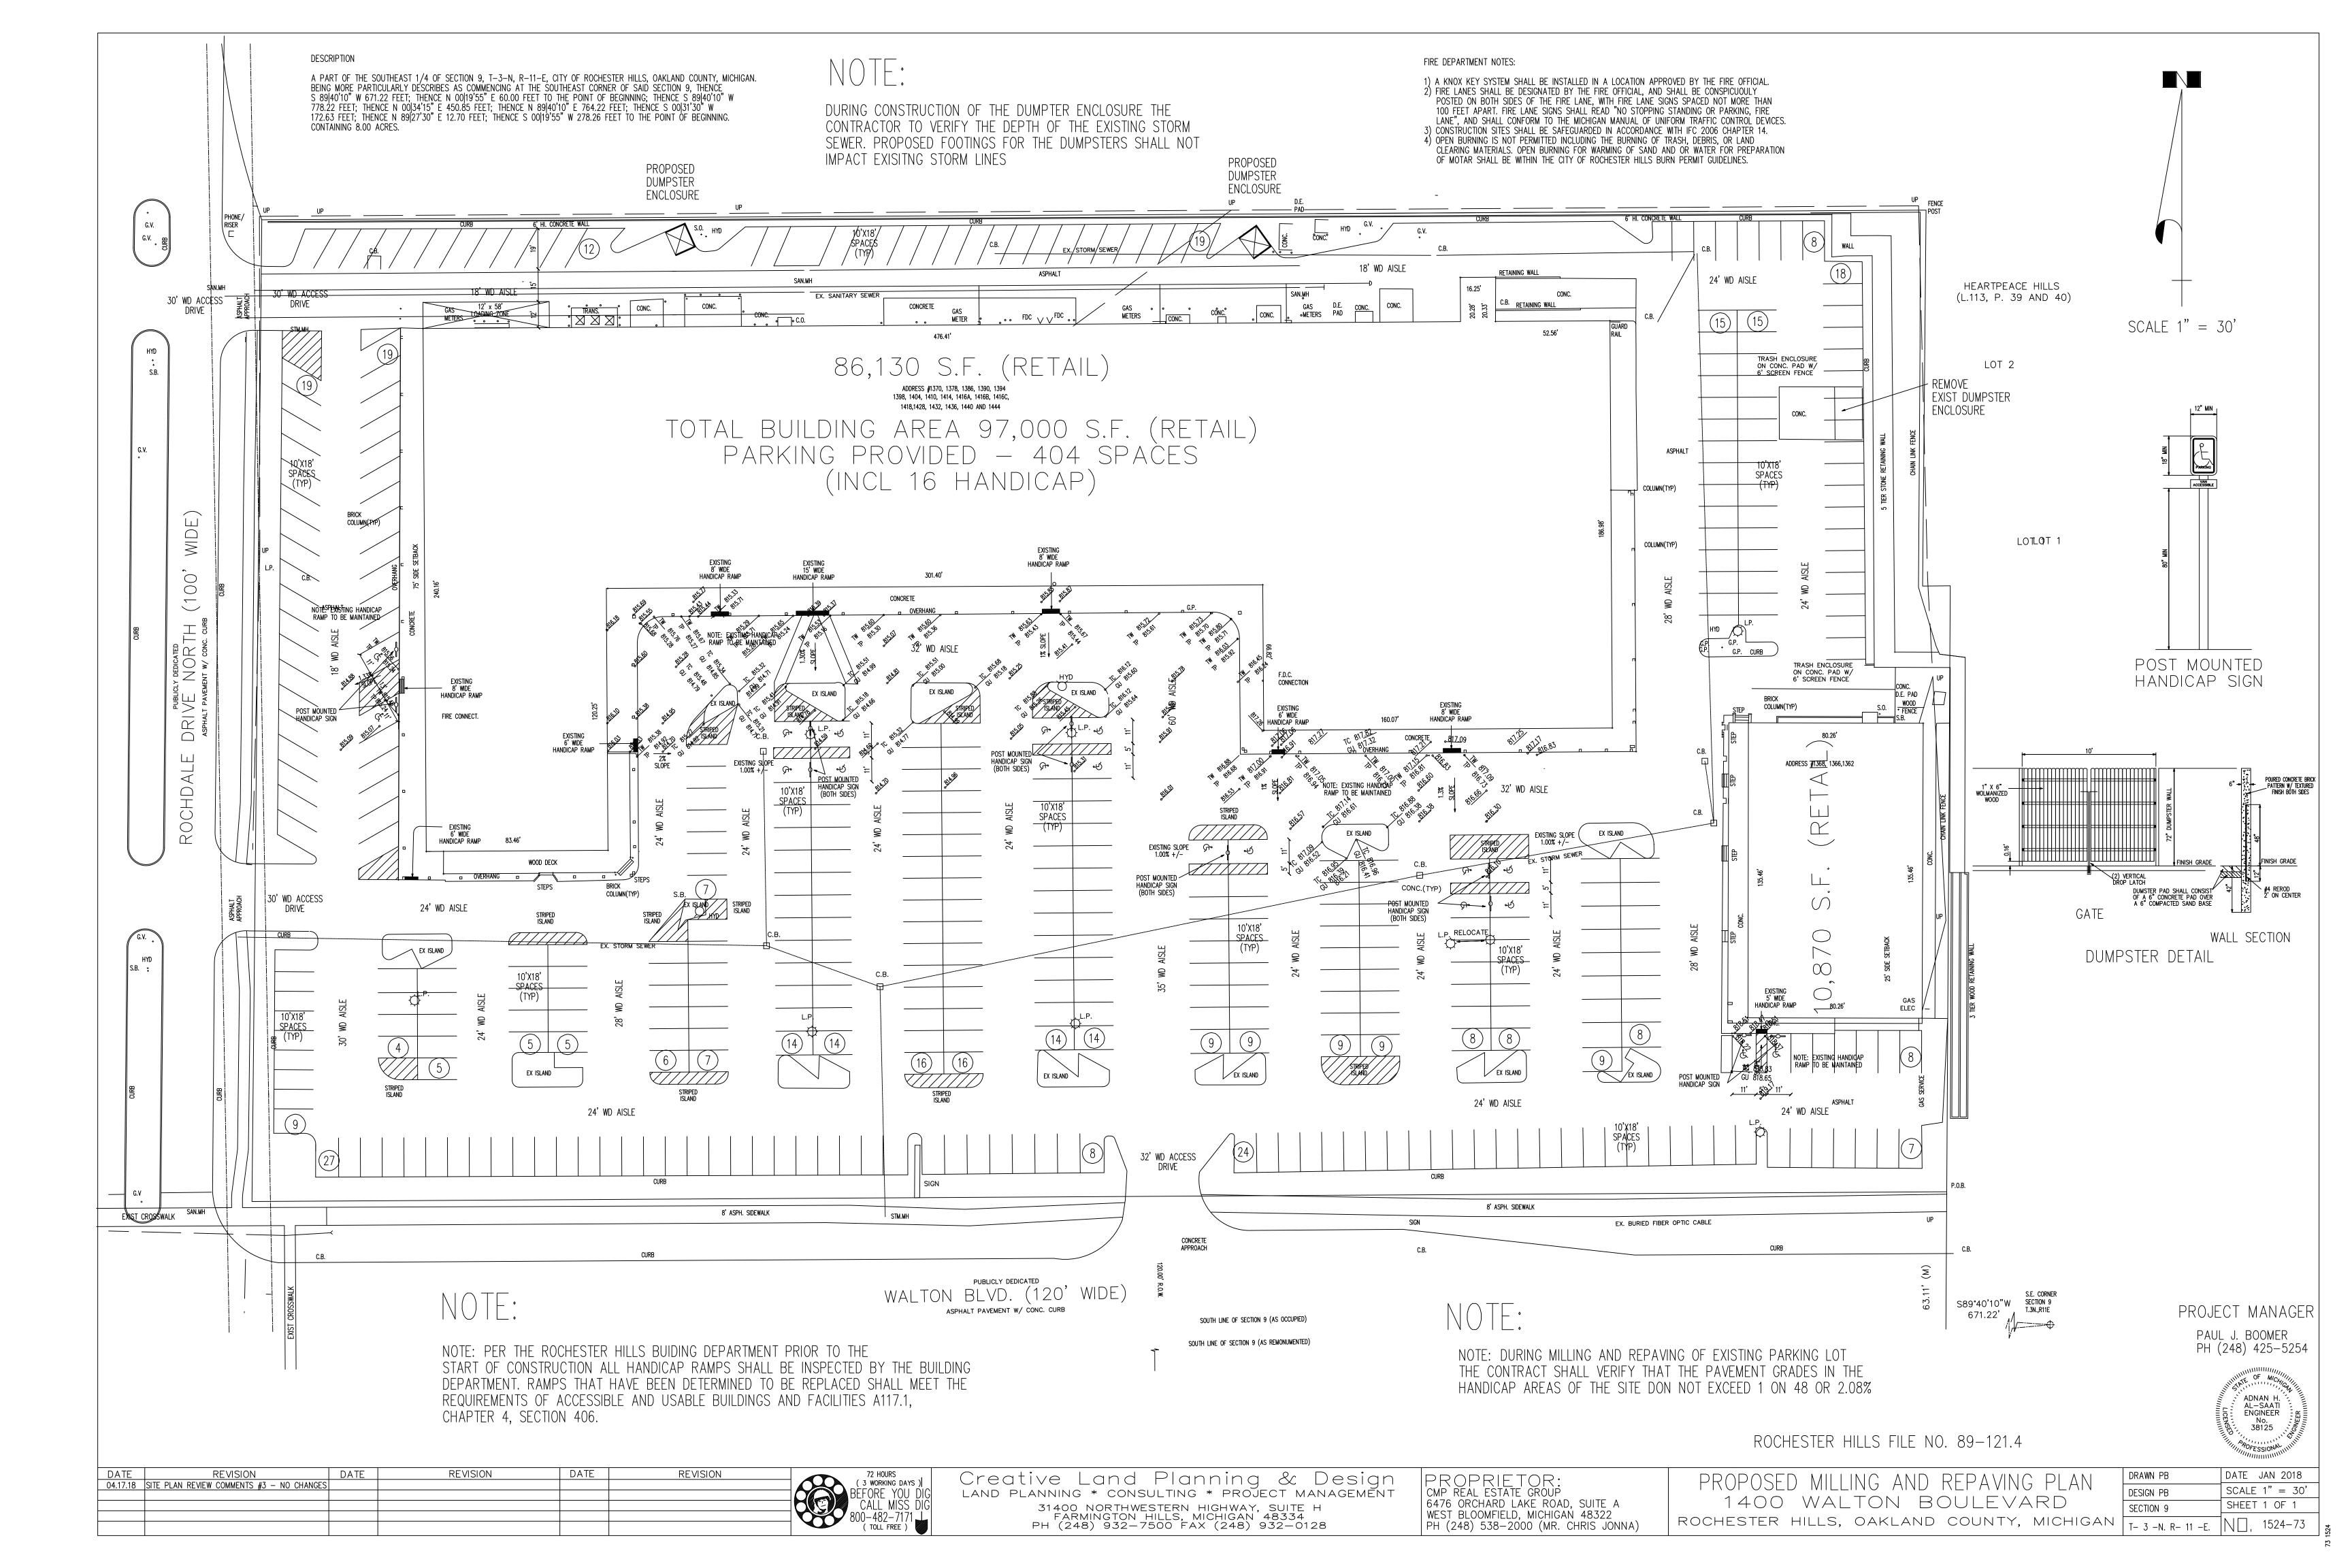

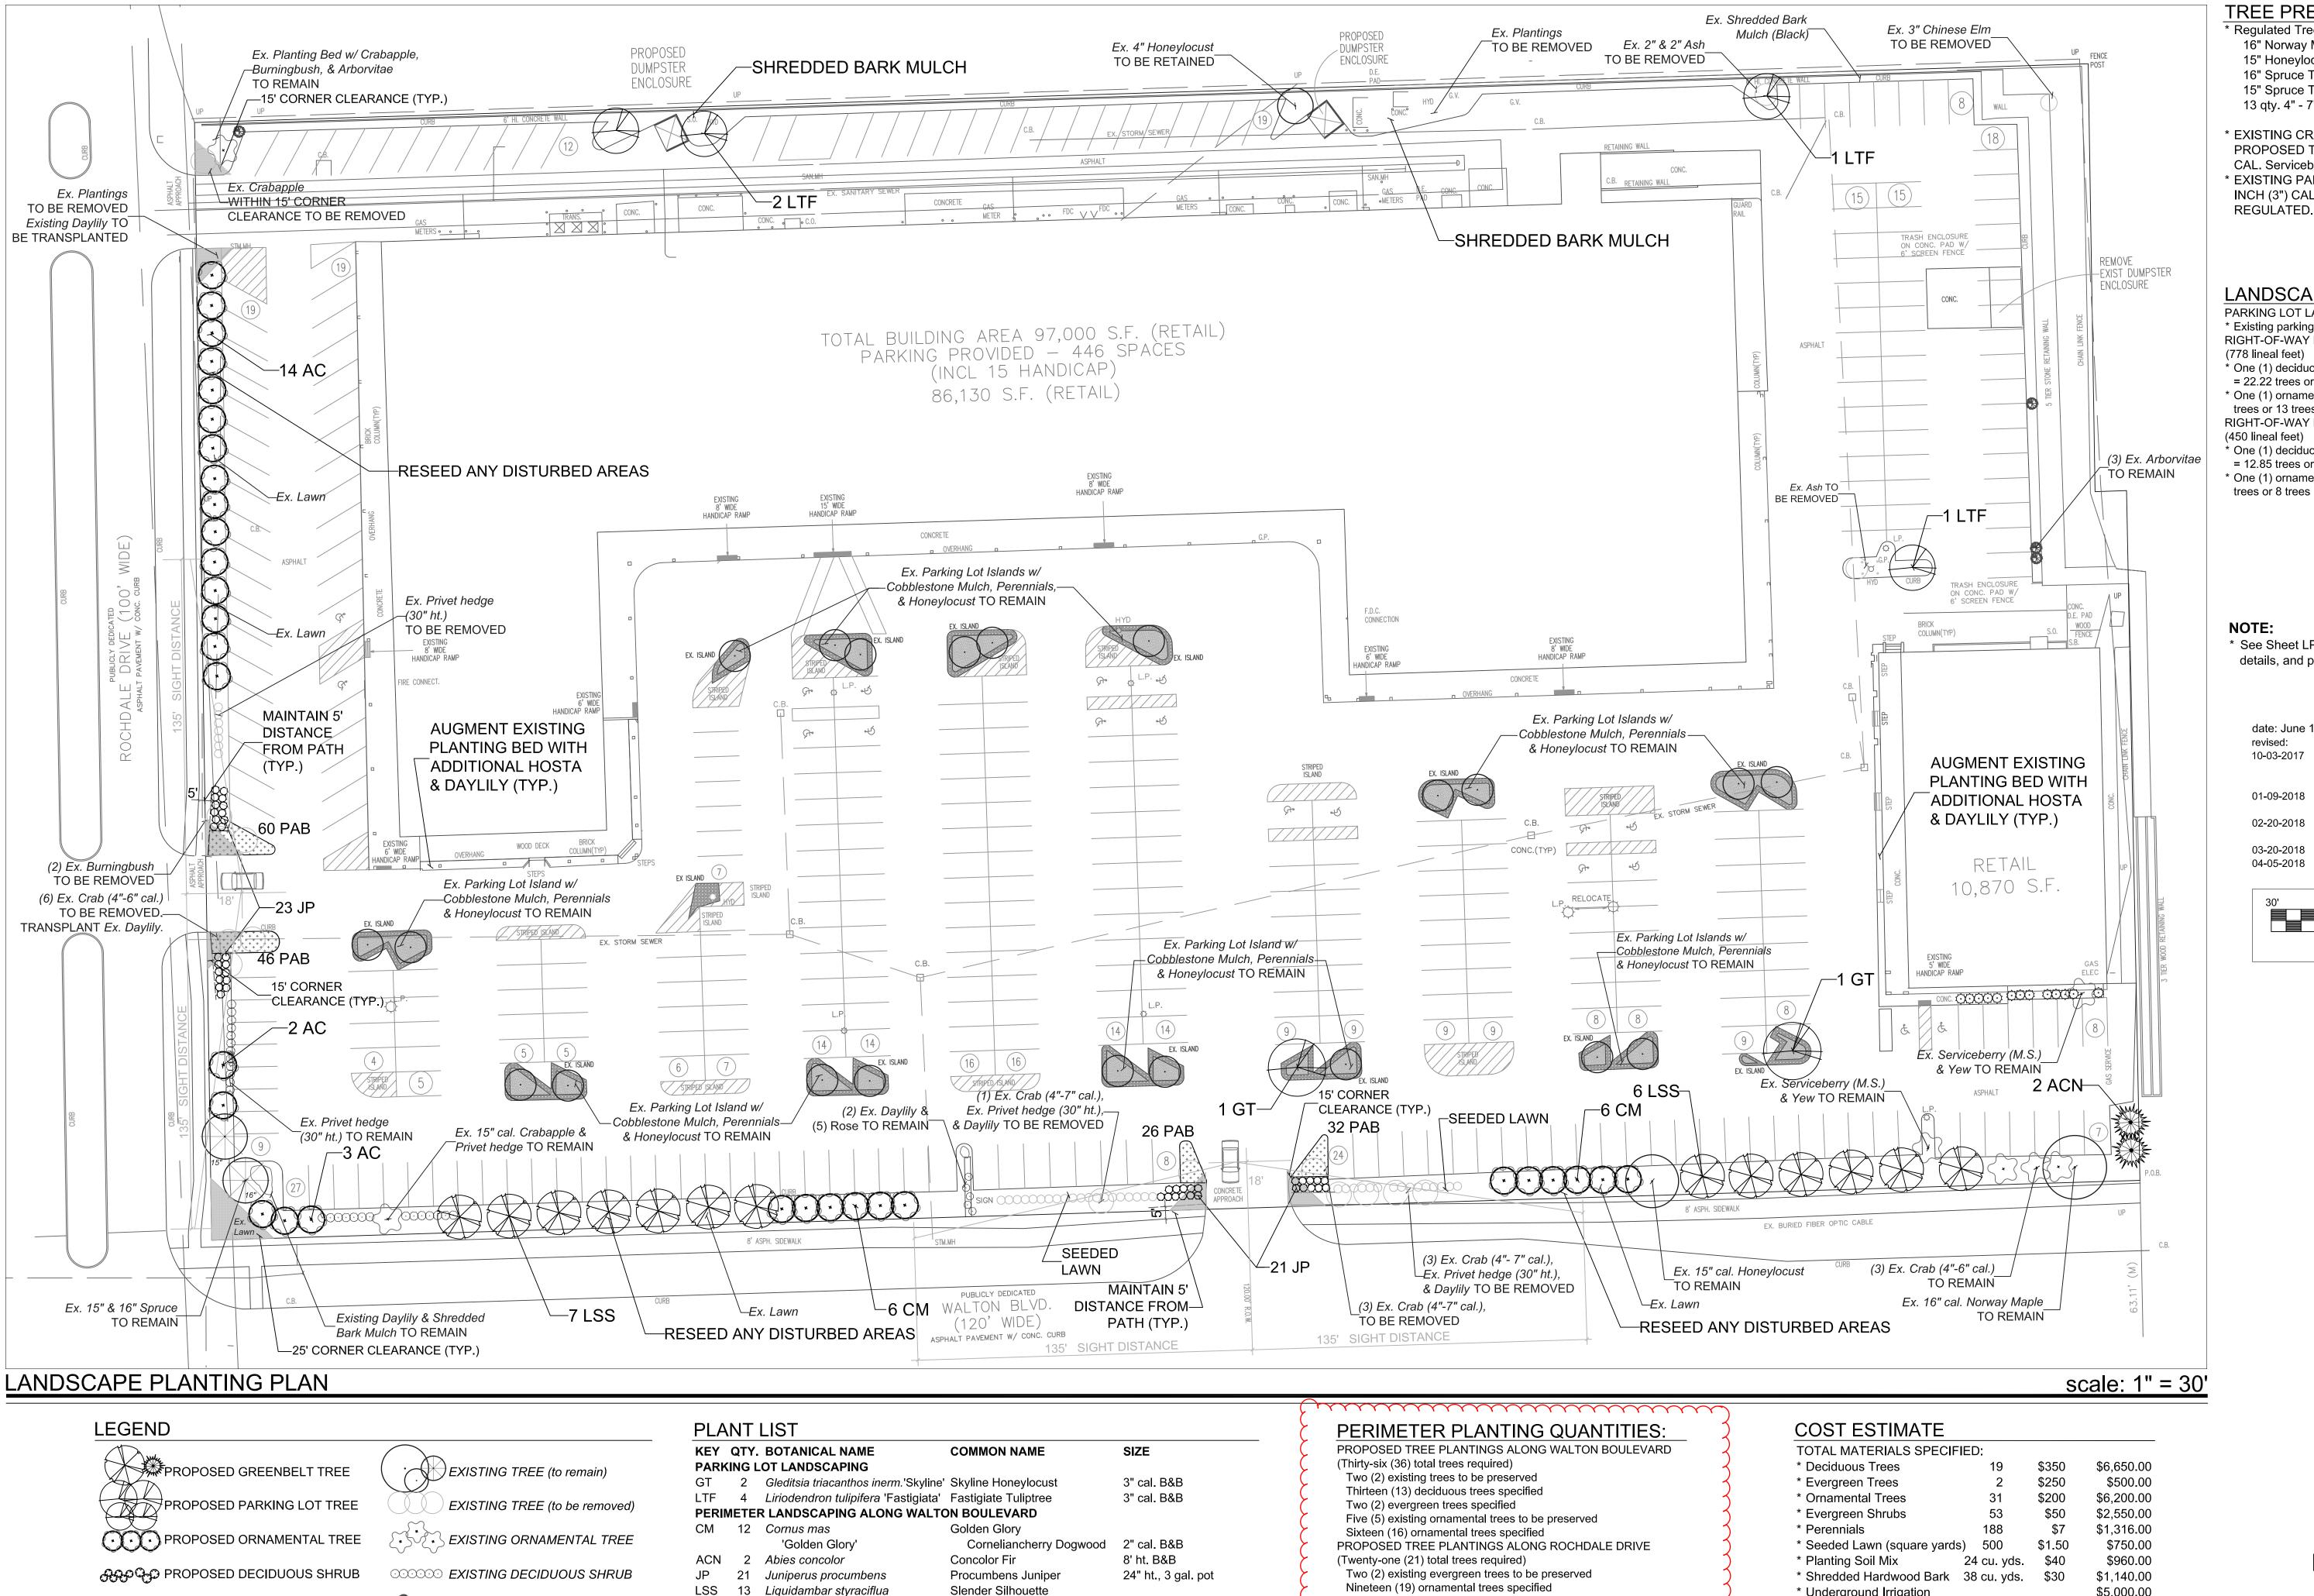

3" cal. B&B

1 gal. pot, 36" o.c.

24" ht., 3 gal. pot

1 gal. pot, 36" o.c.

2" cal. B&B (Single stem)

NOTES ON PLANT MATERIALS:

indicated on the drawing. Example: Privet.

ON THE DRAWING. EXAMPLE: 2 AC.

* Existing Plant Material is italicized and described by the

common name. An inventory of the existing plant material is

NEW PLANT MATERIAL IS DENOTED WITH A KEY THAT

CORRESPONDS TO THE LIST FOR NEW PLANT MATERIAL

American Sweetgum

Burgandy Bunny

Serviceberry

Fountain Grass

Procumbens Juniper

Fountain Grass

Burgandy Bunny

EXISTING EVERGREEN SHRUB

M.S.: Multiple Stems

'Slender Silhouette'

PERIMETER LANDSCAPING ALONG ROCHDALE DRIVE

'Burgandy Bunny'

'Burgandy Bunny'

19 Amelanchier canadensis

23 Juniperus procumbens

PAB 106 Pennisetum alopecuroides

PAB 58 Pennisetum alopecuroides

PROPOSED EVERGREEN SHRUB

PROPOSED PERENNIALS

PROPOSED SHREDDED BARK

PROPOSED COBBLESTONE

TREE PRESERVATION NOTES:

* Regulated Trees On Site Include the Following:

16" Norway Maple TO REMAIN

15" Honeylocust TO REMAIN 16" Spruce TO REMAIN

15" Spruce TO REMAIN 13 qty. 4" - 7" Crabapples TO BE REMOVED

* EXISTING CRABAPPLES TO BE REMOVED ARE PROPOSED TO BE REPLACED WITH TWO INCH (2") CAL. Serviceberry & Corneliancherry Dogwood. * EXISTING PARKING LOT TREES CONSIST OF THREE INCH (3") CAL. Honeylocusts, THEREFORE, ARE NOT

LANDSCAPE CALCULATIONS:

PARKING LOT LANDSCAPING

* Existing parking lot area and islands to remain RIGHT-OF-WAY LANDSCAPING ALONG WALTON BOULEVARD

* One (1) deciduous shade tree for each thirty-five lineal feet (35 l.f.)

= 22.22 trees or 23 trees * One (1) ornamental tree for each sixty lineal feet (60 l.f.) = 12.96

trees or 13 trees RIGHT-OF-WAY LANDSCAPING ALONG ROCHDALE DRIVE

(450 lineal feet) * One (1) deciduous shade tree for each thirty-five lineal feet (35 l.f.)

= 12.85 trees or 13 trees * One (1) ornamental tree for each sixty lineal feet (60 l.f.) = 7.5

trees or 8 trees


NOTE:

* See Sheet LP - 2 for landscape planting notes, planting details, and pruning detail for existing trees.

> date: June 13, 2017 10-03-2017 Revise acc. to site plan changes & City review ltr. dated September 14, 2017.

01-09-2018 Revise acc. to site plan 02-20-2018 Revise acc. to City review ltr.

dated February 13, 2018. 03-20-2018 Indicate relocation of light pole. 04-05-2018 Provide perimeter planting quantities.

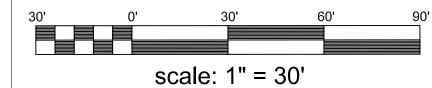

PROJECT LOCATION: Retail Redevelopment 1400 Walton Boulevard Rochester Hills, Michigan

LANDSCAPE PLAN FOR: Mr. Laith Jonna Jonna Properties 2360 Orchard Lake Road

Suite 110 Sylvan Lake, Michigan 48320 (248) 683-7355

> LANDSCAPE PLAN BY: Nagy Devlin Land Design 31736 West Chicago Ave. Livonia, Michigan 48150 (734) 634-9208



LP - 1: LANDSCAPE PLANTING PLAN & TREE PRESERVATION PLAN

> * Base data provided by Creative Land, L.L.C

City of Rochester Hills

* Underground Irrigation \$5,000.00 =======

NOTE: Maintain the following distances from the proposed plant to the

existing sidewalk and pathway: * Serviceberry (Single stem) - Seven feet (7')

* Corneliancherry Dogwood - Nine feet (9')

* Slender Silhouette Sweetgum - Five feet (5')

TOTAL

* Procumbens Juniper - Five feet (5')

File No. 89-121.4

\$25,046.00

LANDSCAPE PLANTING NOTES:

- 1. Installation of all plant material shall be in accordance with the latest edition of the American Association of Nurserymen Standards for Nursery Stock and with the specifications set forth by the City of Rochester Hills, Michigan.
- 2. The plant materials shall conform to the type stated on the plant list. Sizes shall be the minimum stated on the plant list or larger. All measurements shall be in accordance with the latest edition of the American Association of Nurserymen Standards for Nursery Stock.
- 3. The plant material shall be nursery grown and inspected by the Owner's representative before planting. The Owner's representative reserves the right to reject any plant material at any time.
- 4. Plants designated "B&B" shall be balled and burlapped with firm balls of
- 5. Dig shrub pits one foot (1') larger than the shrub rootball, tree pits three (3) times the width of the tree rootball and backfill with one (1) part topsoil and one (1) part soil from excavated pit. Plant trees and shrubs at the same grade level at which they were planted at the nursery. If wet, clay soils are evident, plant trees and shrubs slightly higher.
- 6. The Contractor is responsible for planting the materials at the correct grades and spacing. The plants shall be oriented to give the best appearance.
- 7. When the plant has been properly set, the pit shall be backfilled with the topsoil mixture, gradually filling, patting, and settling with water.
- 8. Trees in lawn areas to have a four foot (4') circle of mulch, four inches (4') deep, and three inches (3") away from the trunk. Shrub beds are to be mulched with shredded bark mulch to a minimum depth of three inches (3"). Perennial beds are to be mulched with shredded bark mulch to a minimum depth of three inches (3"). Only natural color, finely shredded hardwood bark mulch will be accepted.
- 9. Remove all twine, wire, and burlap from the top one third (1/3) of tree and shrub root balls and from tree trunks. Remove all non-biodegradable material such as plastic or nylon completely from branches and stems. All tree wrap, stakes, and guys are to be removed after one (1) winter season.
- 10. All plant materials shall be pruned and injuries repaired. The amount of pruning shall be limited to the removal of dead or injured limbs and to compensate for the loss of roots from transplanting. Cuts should be flush, leaving no stubs. Cuts over three quarters of an inch (3/4") shall be painted with tree paint. Shrubs along the site perimeter shall be allowed to grow together in a natural form.
- 11. Organic, friable topsoil shall be evenly distributed and fine graded over all areas to receive lawns at uniform depth of four inches (4") after settlement. 12. All lawn areas shall be seeded with the Grade A Kentucky Blue Grass blend as specified over the topsoil.
- 13. All plantings shall be completed no later than November 30 in the fall season. The date of intended installation for landscape plant materials is approximately Spring, 2017. Plantings shall thereafter be reasonably maintained, including permanence and health of plant materials to provide a
- screen to abutting properties and including the absence of weeds and refuse. 14. Backfill directly behind all curbs and along sidewalks and compact to the top of curbs or walk to support vehicle and pedestrian weight without settling. MATERIAL
- 1. Required landscape material shall satisfy the criteria of the *American* Association of Nurserymen Standards for Nursery Stock and be: a.) Northern nursery grown; b.) State Department of Agriculture inspected; c.) No. 1 grade material with a straight, unscarred trunk, and well-developed uniform crown (park grade trees will not be accepted); d.) Staked, wrapped, watered, and mulched according to the details provided; and e.) Guaranteed
- 2. Topsoil shall be friable, fertile soil of clay loam character containing at least five percent (5%) but not more than twenty percent (20%) by weight of organic matter with a pH range between 6.0 and 7.0. The topsoil shall be free from clay lumps, coarse sand, plant roots, sticks, and other foreign


- 3. The seed mixture shall consist of the following types and proportions: Kentucky Blue Grass blend "Baron/Sheri/Adelphi" @ sixty percent (60%), Chewing Fescue @ twenty-five percent (25%), Creeping Red Fescue @ ten percent (10%), and Perennial Rye Grass @ five percent (5%). Weed content shall not exceed one percent (1%). The mix shall be applied at a rate of 200 pounds per acre.
- 4. Sod shall be two (2) year old "Baron/Sheri/Adelphi" Kentucky Blue Grass blend grown in a sod nursery on loam soil.
- 5. Proposed perennials shall be full, well-rooted plants.

GENERAL

- 1. Do not plant deciduous or evergreen trees directly over utility lines or under overhead wires. Maintain a six foot (6') distance from the centerline of utilities and twenty feet (20') from the centerline of overhead wires for planting holes. Call MISS DIG forty-eight (48) hours prior to landscape construction for field location of utility lines.
- 2. The Contractor agrees to guarantee all plant material for a period of one (1) year. At that time, the Owner's representative reserves the right for a final inspection. Plant material with twenty-five percent (25%) die back, as determined by the Owner's representative shall be replaced. This guarantee includes the furnishing of new plants, labor, and materials. These new plants shall also be guaranteed for a period of one (1) year.
- 3. The work shall consist of providing all necessary materials, labor, equipment,
- tools, and supervision required for the completion as indicated on the drawings. 4. All landscape areas shall be irrigated by an automatic underground irrigation system. Lawns and shrub/landscape areas shall be watered by separate zones to
- minimize overwatering. 5. All written dimensions override scale dimensions on the plans.
- 6. All substitutions or deviations from the landscape plan must be approved by the City of Rochester Hills prior to installation.
- 7. All bidders must inspect the site and report any discrepancies to the Owner's
- representative. 8. All specifications are subject to change due to existing conditions.
- 9. The Owner's representative reserves the right to approve all plant material.
- MAINTENANCE
- 1. The Owner of the landscaping shall perpetually maintain such landscaping in good condition so as to present a healthy, neat, and orderly appearance, free from refuse and debris.
- 2. All unhealthy, damaged, diseased, and/or dead material shall be removed immediately and replaced within six (6) months after it dies or in the next growing season. The planting season for deciduous plants shall be between March 1 and June 1 and from October 1 until the prepared soil becomes frozen. The planting season for evergreen plants shall be between March 1 and June 1. Plant material installed to replace dead or diseased material shall be as close as practical to the size of the material it is intended to replace. The Cit may notify property owners of the need to replace dead, damaged, or diseased material.
- 3. The Owner shall conduct a seasonal landscape maintenance program including regular lawn cutting (at least once per week during the growing season), watering, and snow removal during winter. Pruning shall be minimal at the time of installation, only to remove dead or diseased branches. Subsequent pruning will assure proper maturation of plants to achieve their approved purpose.
- 4. The Contractor is responsible for watering and maintenance of all seed areas until a minimum of ninety percent (90%) coverage, as determined by the Owner's
- 5. Any debris such as lawn clippings, fallen leaves, fallen limbs, and litter shall be
- removed from the site on a weekly basis at the appropriate season. 6. All planting beds shall be maintained by removing weeds, fertilizing, and
- replenishing mulch as needed.
- 7. The approved landscape plan will be considered a permanent record and integral part of the Site Plan Approval. Unless otherwise approved in accordance with the aforementioned procedures, any revisions to or removal of plant materials, or non-compliance with the maintenance requirements in Section 138-12.109 of the City Ordinance will place the parcel in non-conformity with the approved landscape plan and be a violation of the ordinance.

CITY OF ROCHESTER HILLS NOTES:

- * All landscape areas must be irrigated. An irrigation plan must be submitted prior to Staff approval of the final site plan. Watering will occur only between the hours of 12 a.m. and 5 a.m.
- * Prior to the release of the performance bond, the City of Rochester Hills must inspect all landscape plantings.
- * Prior approval is required to plant any tree or shrub on the public right-of-way. All trees and shrubs must be planted at least 10' from the edge of the public road. (Trees must be planted at least 15' away from curb or road edge where the speed limit is more than 35mph). Shade trees and shrubs must be planted at least 5' from the edge of the public walkway. Evergreen and ornamental trees must be planted at least 10' from the edge of the public walkway. No tree or shrubs may be planted with the triangular area formed at the intersection of any street right-of-way lines at a distance along each line of 25' from their point of intersection. No trees or shrubs may be planted in the triangular area formed at the intersection of any driveway with a public walkway at a distance along each line of 15' from their midpoint of intersection. All trees and shrubs must be planted at least 10' from any fire hydrant. Shade and evergreen trees must be at least 15' away from the nearest overhead wire. Trees must be planted a minimum of 5' from an underground utility, unless the city's Landscape Architect requires a greater distance.
- Prior to the release of the performance bond, the City of Rochester Hills Forestry Division needs to inspect all trees, existing or planted, to identify any that pose a hazard to the safe use of the public right-of-way. Forestry may require the developer to remove, and possibly replace, any such trees.
- * These requirements are incorporated into this plan.

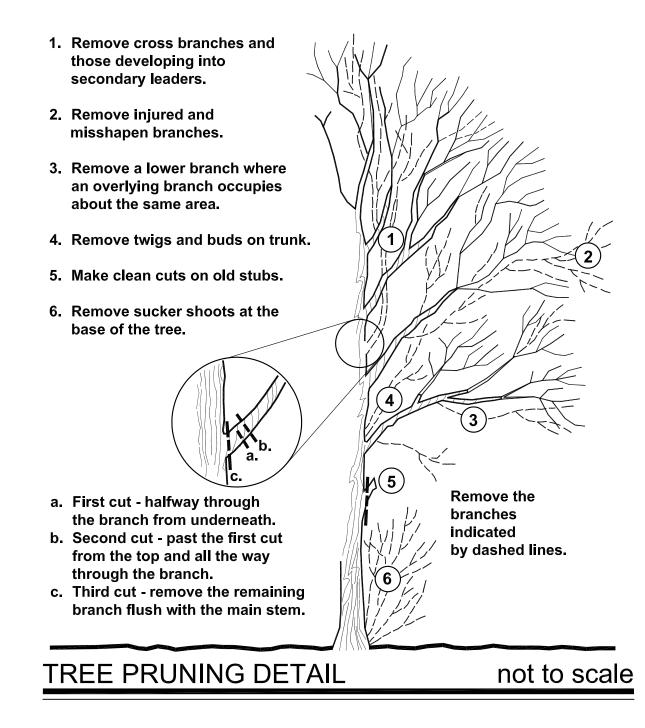

* See Sheet LP - 1 for overall landscape planting plan, plant list, legend for plant symbols, and tree preservation notes.

date: June 13, 2017

10-03-2017 Revise acc. to site plan changes & City review ltr. dated September 14, 2017

01-09-2018 Revise acc. to site plan 02-20-2018 Revise acc. to City review Itr

dated February 13, 2018. 03-20-2018 Indicate relocation of light pole 04-05-2018 Provide perimeter planting quantities.

scale: as indicated

LANDSCAPE PLAN FOR: Mr. Laith Jonna Jonna Properties 2360 Orchard Lake Road Suite 110 Sylvan Lake, Michigan 48320 (248) 683-7355

Retail Redevelopment 1400 Walton Boulevard Rochester Hills, Michigan

PROJECT LOCATION:


LANDSCAPE PLAN BY Nagy Devlin Land Design 31736 West Chicago Ave. Livonia, Michigan 48150 (734) 634-9208



LP - 2: LANDSCAPE NOTES & DETAILS

DEVLIN

City of Rochester Hills File No. 89-121.4

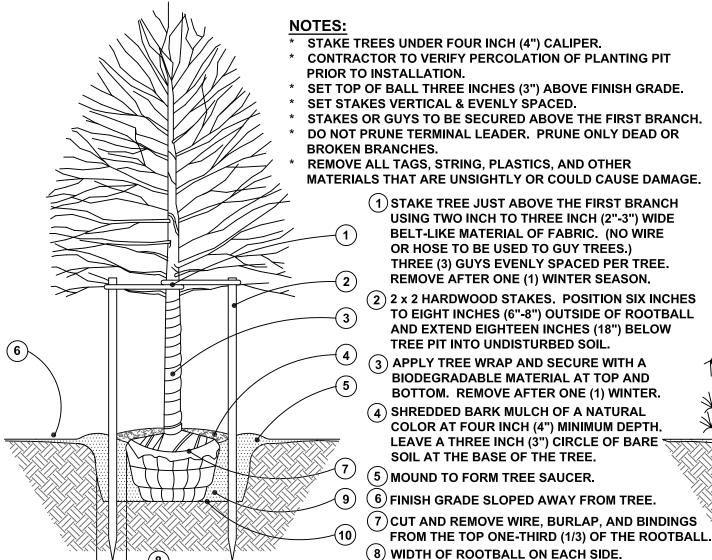

DECIDUOUS TREE


PLANTING DETAILS

(9) PLANTING MIXTURE SHALL CONSIST OF 50%

(10) SCARIFY BOTTOM AND SIDES OF PLANTING

TOSOIL AND 50% SAND.


PIT TO FOUR INCH (4") DEPTH.

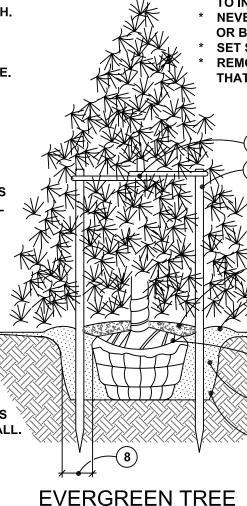

GUY ALL EVERGREEN TREES TWELVE FEET (12') HIGH AND OVER. * CONTRACTOR TO VERIFY PERCOLATION OF PLANTING PIT PRIOR TO INSTALLATION. NEVER CUT CENTRAL LEADER. PRUNE ONLY TO REMOVE DEAD OR BROKEN BRANCHES. SET STAKES VERTICAL AND EVENLY SPACED. REMOVE ALL TAGS, STRING, PLASTICS, AND OTHER MATERIALS THAT ARE UNSIGHTLY OR COULD CAUSE GIRDLING. (1) STAKE TREE AS INDICATED USING TWO INCH TO THREE INCH (2"-3") WIDE BELT-LIKE MATERIAL OF FABRIC. (NO WIRE OR HOSE TO

* STAKE ALL EVERGREEN TREES UNDER TWELVE FEET (12') HIGH.

- BE USED TO GUY TREES.) THREE (3) GUYS **EVENLY SPACED PER TREE. REMOVE AFTER** ONE (1) WINTER SEASON. (2) 2 x 2 HARDWOOD STAKES. POSITION SIX INCHES
- TO EIGHT INCHES (6"-8") OUTSIDE OF ROOTBALL AND EXTEND EIGHTEEN INCHES (18") BELOW TREE PIT INTO UNDISTURBED SOIL.
- SHREDDED BARK MULCH OF A NATURAL COLOR AT FOUR INCH (4") MINIMUM DEPTH. (4) LEAVE A THREE INCH (3") CIRCLE OF BARE SOIL AT THE BASE OF THE TREE. 4) MOUND TO FORM TREE SAUCER.
-) FINISH GRADE SLOPED AWAY FROM TREE.
- CUT AND REMOVE WIRE, BURLAP, AND BINDINGS FROM THE TOP ONE-THIRD (1/3) OF THE ROOTBALL. 7) PLANTING MIXTURE SHALL CONSIST OF 50%
- **TOSOIL AND 50% SAND.** (8) WIDTH OF ROOTBALL ON EACH SIDE.
- (9) SCARIFY BOTTOM AND SIDES OF PLANTING PIT TO FOUR INCH (4") DEPTH.

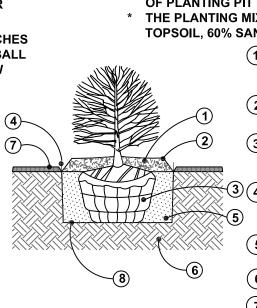

SHRUB

* CONTRACTOR TO VERIFY PERCOLATION OF PLANTING PIT PRIOR TO INSTALLATION. * THE PLANTING MIXTURE SHALL CONSIST OF 20% TOPSOIL, 60% SAND, AND 20% COMPOST. $oldsymbol{(1)}$ SHREDDED BARK MULCH AT THREE INCH (3") MINIMUM DEPTH. MULCH SHALL BE NATURAL IN COLOR. 2) FORM A SAUCER WITH MULCH AND SOIL AROUND SHRUB BED. CUT AND REMOVE BURLAP AND BINDINGS FROM THE TOP ONE-THIRD (1/3) OF THE ROOTBALL. (4) 3/16" x 4" ALUMINUM EDGING (OR APPROVED EQUIVALENT) OR SPADED EDGE. 5) EXCAVATE PLANTING BED AND BACK-FILL WITH PREPARED PLANTING MIX. (6) UNDISTURBED SUBGRADE. (7) LAWN.

(8) SCARIFY SUBGRADE.

GENERAL NOTES FOR ALL PLANTINGS:

EXISTING GRADE IF PLANTING IN CLAY SOILS.

THE TREE OR SHRUB. GENTLY TAMP IF NEEDED.

OR COULD CAUSE GIRDLING.

* DO NOT CUT CENTRAL LEADER. PRUNE ONLY TO REMOVE DEAD OR BROKEN BRANCHES.

• PLANTS SHALL BEAR THE SAME RELATIONSHIP TO FINISH GRADE AS IT BORE TO THE

REMOVE ALL TAGS, STRINGS, PLASTICS, AND ANY OTHER NON-BIODEGRADEABLE MATERIALS

(EXCEPT LABEL FOR PLANT NAME) FROM PLANT STEMS OR CROWN WHICH ARE UNSIGHTLY

PREVIOUS GRADE IN THE NURSERY. SET THE BASE OF THE PLANT SLIGHTLY HIGHER THAN

USE WATER TO SETTLE THE PLANTING MIX AND REMOVE ANY AIR POCKETS AND FIRMLY SET

* CENTER THE ROOTBALL IN THE PLANTING HOLE. LEAVE THE BOTTOM OF THE HOLE FIRM.

CONTRACTOR TO VERIFY PERCOLATION

OF PLANTING PIT PRIOR TO INSTALLATION. PERENNIALS TO BE PLANTED UP TO THE EDGE OF THE SAUCER AROUND A TREE OR SHRUB BED. * THE PLANTING MIXTUE SHALL CONSIST OF 20% TOPSOIL, 60% SAND, AND 20% COMPOST.

(1) SEE PLANT LIST FOR SPACING DISTANCE. SHREDDED HARDWOOD BARK OF A NATURAL COLOR MULCH AT TWO INCH (2") MINIMUM DEPTH. (3) 3/16" x 4" ALUMINUM EDGING (OR APPROVED **EQUIVALENT) OR SPADED EDGE.** INCH (10") DEPTH.

(4) EXCAVATE PLANTING BED AND BACKFILL WITH PREPARED PLANTING MIX AT A TEN (5) (5) UNDISTURBED SUBGRADE.

6 PLANTING MIX TO CONSIST OF EQUAL PARTS $^{\prime}$ OF SAND, LEAF COMPOST, AND NATIVE SOIL. 7 LAWN.

not to scale

PERENNIAL / GROUNDCOVER

Michigan Lighting Systems

0.1 0.1 0.2 0.3 0.4 0.3 0.3 0.4 0.3 0.2 0.1 0.1 0.0 0.0 0.0 0.0 0.0 0.0 0.0 0.0 0.0 0.0 0.0 0.1 0.3 0.6 0.7 0.9 0.9 0.9 0.9 0.7 0.5 0.3 0.1 0.0 0.0 0.0 0.0 0.0 0.0 0.0 0.0 0.0 0.0 0.0 0 2 0.6 1.4 1.7 2.0 2.1 2.1 2.0 1.7 1.4 0.6 0 2 0.0 0.0 0.0 0.0 0.0 0.0 0.0 0.0 0.0 0.0 0.0 0 1 0 0 0 2.4 3.2 3.9 4.4 4.4 3.9 3.2 2.4 0.9 0 1 0.0 0.0 0.0 0.0 0.0 0.0 0.0 0.0 0.0 0.0 0.0 0 1 0.8 2.7 3.6 4.2 5.0 5.0 4.2 3.5 2.7 0.7 0.1 0.0 0.0 0.0 0.0 0.0 0.0 0.0 0.0 0.0 0.0 0.0 0 1 0.7 2.5 3.4 4.8 6.5 6.4 4.7 3.4 2.4 0.7 0 1 0.0 0.0 0 0 0.0 0.0 0.0 0.0 0.0 0.0 0.0 0.0 0.2 1.0 3.3 4.3 5.0 7.5 7.4 4.9 4.3 3.3 0.9 0 1 0.0 0.0 0.0 0.0 0.0 0.0 0.0 0.0 0.0 0.0 0.0 0.1 0.5 2.4 3.9 5.4 10.310.15.4 3.9 2.4 0.5 0.1 0.0 0.0 0.0 0.0 0.0 0.0 0.0 0.0 0.0 0.0 0.0 0.1 0.9 3.4 4.7 5.8 8.5 8.5 5.7 4.7 3.3 0.9 0.1 0.0 0.0 0.0 0.0 0.0 0.0 0.0 0.0 0.0 0.0 0.2 0.9 2.5 3.5 5.0 7.3 7.3 5.0 3.4 2.2 5 0.8 0.2 0 0 0.0 0.0 0.0 0.0 0.0 0.0 0.0 0.0 0.0 0.1 0.7 2.6 3.6 4.1 5.2 5.2 4.1 3.5 2.6 0.7 0.1 0 0 0.0 0.0 0.0 0.0 0.0 0.0 0.0 0.0 0.0 0.1 0.9 2.7 3.4 4.3 5.1 5.1 4.3 3.4 2.6 0.9 0.1 0.0 0.0 0.0 0.0 0.0 0.0 0.0 0.0 0.0 0.0 0.0 0.0 0.0 0.0 0.0 0.0 0.0 0.0 ADDRESS #1368, 1366,1362 0.0

0.0 0.1 0.1 0.2 0.2 0.2 0.2 0.1 0.1 0.1 0.0 0.0 0.0

1400 WALTON BOULEVARD

ATE .	REVISION	DATE	REVISION	DATE	REVISION	7; (3 v
						BEFO CA
						800-

X-70-CRI DATA SHOWN

X-70-CRI DATA SHOWN

IS ABSOLUTE

IS ABSOLUTE

0.0 0.0 0.0 0.0 0.0 0.0

0.0 0.0 0.0 0.0 0.0 0.0 0.0

0.0 0.0 0.0 0.0 0.0 0.0

0.0 0.0 0.0 0.0 0.0 0.0 0.0

0.0 0.0 0.0 0.0 0.0 0.0 0.0

0.0 0.0 0.0 0.0 0.0 0.0

0.0 0.0 0.0 0.0 0.0 0.0 0.0

0.0 0.0 0.0 0.0 0.0 0.0

0.0 0.0 0.0 0.0 0.0 0.0

0.0 0.0 0.0 0.0 0.0 0.0

0.0 0.0 0.0 0.0 0.0 0.0

0.0 0.0 0.0 0.0 0.0 0.0

 $0.0 \ 0.0 \ 0.0 \ 0.0^{3} \ 0.0 \ 0.0^{3}$

0.0 0.0 0.0 0.0 0.0 0.0

0.0 0.0 0.0 0.0 0.0 0.0

0.0 0.0 0.0 0.0 0.0 0.0

0.0 0.0 0.0 0.0 0.0 0.0 0.0

0.0 0.0 0.0 0.0 0.0 0.0

0.0 0.0 0.0 0.0 0.0 0.0

0.0 0.0 0.0 0.0 0.0 0.0

0.0 0.0 0.0 0.0 0.0 0.0 0.0

0.0 0.0 0.0 0.0 0.0 0.0

0.0 0.0 0.0 0.0 0.0 0.0

0.0 0.0 0.0 0.0 0.0 0.1

0.0 0.0 0.0 0.0 0.1 0.1

0.0 0.0 0.0 0.0 0.1 0 1 0.2

0.0 0.0 0.0 0.0 0.1 0.7 0.2

0.0 80.0 0.0 0.1 0.1 0.2 0.3

0.0 0.0 0.0 0.1 0.1 0.2 0.4

0.0 0.0 0.0 0.1 0.1 0.2 0.4

0.0 0.0 0.0 0.1 0.1 0.2 0.3

0.0 0.0 0.0 0.1 0.1 0.2 0.3

0.0 0.0 0.0 0.1 0.1 0.1 0.3

0.0 0.0 0.0 0.0 0.1 0.1 0.2

0.0 0.0 0.0 0.0 0.1 0.1 0.2

0.0 0.0 0.0 0.0 0.0 0.1 0.1

0.0 0.0 0.0 0.0 0.0 0.1 0.1

Beacon Products

Products

Products

Beacon

Products

6 Beacon

VPL-80L-180-5K7-5W LARGE VIPER

LARGE VIPER

VPL-80L-180-5K7-4

В

0.0 0.0 0.0 0.0 0.0 0.0

0.0 0.0 0.0 0.1 0.1 0.0

0.0 0.0 0.1 0.1 0.1 0.1 0.1

0.0 0.0 0.1 0.2 0.2 0.1 0.1

0.0 0.1 0.2 0.3 0.2 0.2 0.2

0.0, 0.3 0.4 0.5 0.4 0.3 0.2

0.1 0.7 1.1 0.9 0.8 0.5 0.3

0.1 1.5 1.7 1.6 1.2 0.6 0.3

0.2 2.7 3.1 2.3 1.2 0.6 0.4

0.4 3.1 5.0 2.5 1.2 0.6 0.3

1.6 3.3 3.4 2.5 1.1 0.6 0.4

1.7 3.2 3.4 2.5 1.1 0.6 0.4

0.4 3.1014 9 12.5 NOTA 2 0.6 0.3

0.2 2.7 3.1 2.3 1.2 0.6 0.4

0.1 1.5 1.7 1.6 1.2 0.6 0.3

0.1 0.7 1.0 0.9 0.8 0.5 0.3

0.0 0.3 0.4 0.5 0.4 0.3 0.2

0.0 0 1 0.2 0.3 0.3 0.2 0.2

0.0 0.1 0.1 0.2 0.2 0.2 0.1

0.0 0.1 0.1 0.1 0.2 0.1 0.1

0.0 0.1 0.1 0.1 0.1 0.1 0.1

0.1 0.1 0.1 0.2 0.2 0.2 0.2

0.1 0.1 0.2 0.2 0.3 0.3 0.3

Creative Land Planning & Design | PROPRIETOR

0.3 0.4 0.7 1.1 1.6 2.4 3.3 4.7 5.7 5.7 4.7 3.5 2.6 2.0 1.8 1.8 2.0 2.5 3.3 4.5 5.4 5.4 4.4 3.2 2.3 1.6 1.1 0.7 0.4 0.3 0.2 0.1 0.1 0.1 0.2 0.2 0.3 0.4 0.4 0.5 0.5 0.4 0.4 0.3 0.3 0.2 0.2 0.3 0.4 0.4

0.2 0.4 0.6 1.0 1.4 1.9 2.6 3.2 3.8 3.8 3.8 3.3 2.7 2.1 1.7 1.5 1.5 1.7 2.1 2.5 3.1 3.6 3.6 3.1 2.5 1.9 1.4 0.9 0.6 0.4 0.3 0.2 0.2 0.2 0.2 0.2 0.3 0.4 0.5 0.6 0.7 0.7 0.8 0.7 0.7 0.8 0.7 0.7 0.8 0.7 0.7 0.8 0.7 0.7 0.8 0.7 0.7 0.8 0.2 0.2 0.2 0.3 0.4 0.5 0.6 0.7 0.7 0.8 0.7 0.7 0.7 0.8 0.7 0.7 0.7 0.8 0.7 0.7 0.7 0.8 0.7 0.7 0.7

0.2 0.3 0.5 0.8 1.1 1.5 1.9 2.3 2.5 2.6 2.3 2.0 1.7 1.4 1.3 1.3 1.4 1.6 1.9 2.2 2.4 2.4 2.2 1.9 1.5 1.1 0.8 0.5 0.3 0.2 0.2 0.2 0.2 0.2 0.3 0.4 0.6 0.7 0.9 1.1 1.2 1.2 1.1 1.0 0.9 0.7 0.5 0.3 0.3 0.2 0.2 0.2 0.2

0.2 0.3 0.4 0.7 0.9 1.2 1.5 1.7 1.8 1.8 1.7 1.5 1.3 1.1 1.0 1.0 1.1 1.3 1.5 1.7 1.8 1.8 1.6 1.4 1.2 0.9 0.6 0.4 0.3 0.2 0.2 0.2 0.2 0.2 0.4 0.6 0.8 1.1 1.4 1.6 1.8 1.8 1.7 1.5 1.2 1.0 0.7 0.5 0.3 0.2 0.2 0.1

01 0.1 0.2 03 0.5 0.6 0.7 0.8 0.9 0.9 0.9 0.8 0.7 0.6 0.6 0.6 0.6 0.7 0.8 0.9 1.0 0.9 0.9 0.8 0.6 0.5 0.3 0.2 0.1 0.1

0.1 0.2 0.3 0.5 0.7 0.9 1.1 1.3 1.4 1.4 1.3 1.2 1.0 0.9 0.8 0.8 0.9 1.1 1.2 1.4 1.5 1.5 1.4 1.2 1.0 0.7 0.5 0.3 0.2 0.1

0.2 0.3 0.4 0.7 1.0 1.3 1.6 1/9/2 2 2.1 1.9 1.7 1.4 1.2 1.1 1.2 1.5 1.8 2 1 2.3 2.2 2.0 1.7 1.4 1.0 0.7 0.5 0.3 0.2

0.2 0.3 0.5 0.9 1.3 1.7 2.2/2,8 3.2 3.2 2.8 2.3 1.9 1.6 1.4 1.4 1.6 2.0 2.4 3.0 3.5 3.4 3.0 2.4 1.8 1.3 0.9 0.6 0.3 0.2

0.2 0.4 0.7 1.0 1.5 2.2 3.0 41 5.0 5.0 4.2 3.1 2.4 1.9 1.7 1.7 1.9 2.4 3.3 4.4 5.3 5.4 4.4 3.2 2.3 1.6 1.1 0.7 0.4 0.2

0.3 0.5 0.7 1.2 1.8 2.6 3.9 5.6 6.6 6.6 5.6 4.0 2.8 2.2 1.9 1.9 2.2 2.9 4.1 5.8 6.7 6.7 5.8 4.1 2.7 1.8 1.2 0.8 0.5 0.3

0.2 0.3 0.5 0.6 0.7 0.8 0.9 0.8 0.8 0.7 0.6 0.4 0.3 0.2 0.2 0.2 0.2 0.2 0.2 0.2 0.3 0.4 0.6 0.8 1.0 1.2 1.4 1.4 1.4 1.4 1.3 1.1 1.0 0.9 0.9 1.0 1.1 1.3 1.4 1.5 1.4 1.4 1.4 1.2 1.0 0.8 0.6 0.4 0.3 0.2 0.2 0.3 0.5 0.7 1.1 1.5 1.9 2.3 2.7 2.8 2.6 2.2 1.7 1.3 0.9 0.6 0.4 0.2 0.2 0.1

 $[0.3] \ 0.5 \ 0.7 \ 0.9 \ 1.1 \ 1.2 \ 1.3 \ 1.3 \ 1.2 \ 1.3 \ 1.3 \ 1.2 \ 1.1 \ 0.9 \ 0.7 \ 0.5 \ 0.3 \ 0.2 \ 0.2 \ 0.3 \ 0.4 \ 0.5 \ 0.7 \ 0.9 \ 1.1 \ 1.3 \ 1.3 \ 1.3 \ 1.3 \ 1.3 \ 1.3 \ 1.2 \ 1.0 \ 0.9 \ 0.8 \ 0.8 \ 0.9 \ 1.1 \ 1.2 \ 1.4 \ 1.4 \ 1.3 \ 1.2 \ 0.0 \ 0.8 \ 0.6 \ 0.4 \ 0.3 \ 0.2 \ 0.2 \ 0.3 \ 0.4 \ 0.6 \ 0.9 \ 1.3 \ 1.9 \ 2.5 \ 3.4 \ 4.2 \ 4.5 \ 3.9 \ 3.0 \ 2.2 \ 1.6 \ 1.1 \ 0.7 \ 0.5 \ 0.3 \ 0.2 \ 0.2 \ 0.3 \ 0.4 \ 0.6 \ 0.9 \ 1.3 \ 0.4 \ 0.6 \ 0.9 \ 1.3 \ 0.4 \ 0.6 \ 0.9 \ 1.3 \ 0.2 \ 0.2 \ 0.8 \ 0.9 \ 0.9 \ 0.8 \ 0.8 \ 0.9 \ 0.9 \ 0.8 \ 0.8 \ 0.9 \ 0.8 \ 0.9 \ 0.8 \ 0.8 \ 0.9 \ 0.8 \ 0.8 \ 0.9 \ 0.8 \ 0.8 \ 0.9 \ 0.8 \ 0.8 \ 0.9 \ 0.8 \ 0.8 \ 0.9 \ 0.8 \ 0.8 \ 0.9 \ 0.8 \ 0.8 \ 0.9 \ 0.8 \ 0.8 \ 0.9 \ 0.8 \ 0.8 \ 0.9 \ 0.8 \ 0.8 \ 0.9 \ 0.8 \ 0.9 \ 0.8 \ 0.9 \ 0.8 \ 0.8 \ 0.9 \ 0.8 \ 0.8 \ 0.9 \ 0.8 \ 0.8 \ 0.9 \ 0.8 \ 0.8 \ 0.9 \ 0.8 \ 0.8 \ 0.9 \ 0.8 \ 0.8 \ 0.9 \ 0.8 \ 0.8 \ 0.9 \ 0.8 \ 0.9 \ 0.8 \ 0.8 \ 0.9 \ 0.8 \ 0.8 \ 0.9 \ 0.8 \ 0.8 \ 0.9 \ 0.8 \ 0.8 \ 0.9 \ 0.8 \ 0.8 \ 0.9 \ 0.8 \ 0.8 \ 0.9 \ 0.8 \ 0.8 \ 0.9 \ 0.8 \ 0.8 \ 0.9 \ 0.8 \ 0.8 \ 0.9 \ 0.8 \ 0.8 \ 0.9 \ 0.8 \ 0.9 \ 0.8 \ 0.8 \ 0.9 \ 0.8 \ 0.8 \ 0.9 \ 0.8 \ 0.8 \ 0.9 \ 0.8 \ 0.8 \ 0.9 \ 0.8 \ 0.8 \ 0.9 \ 0.8 \ 0.8 \ 0.9 \ 0.8 \ 0.8 \ 0.8 \ 0.8 \ 0.9 \ 0.8 \ 0.8 \ 0.8 \ 0.9 \ 0.8 \ 0.8 \ 0.9 \ 0.8 \ 0.$

0.5 0.8 1.2 1.7 2.2 2.7 3.1 3.1 2.7 2.2 1.7 1.2 0.8 0.6 0.4 0.3 0.3 0.5 0.7 1.0 1.3 15 1.8 1.9 1.9 1.8 1.6 1.4 1.2 1.1 1.1 1.2 1.5 1.7 2.0 2.1 2.2 2.0 1.7 1.4 1.1 0.8 0.5 0.3 0.3 0.5 0.7 1.1 1.6 2.5 3.8 5.7 6 7. 7.7 6.5 4.9 3.1 2.1 1.4 0.9 0.6 0.4 0.2 0.1

0.5 0.7 1.1 1.5 1.8 2.2 2.5 2.4 2.2 1.8 1.4 1.1 0.7 0.5 0.4 0.3 0.3 0.5 0.7 1.0 1.5 2.1 2.9 3.9 4.7 4.7 3.9 3.0 2.3 1.8 1.5 1.7 2.1 2.6 3.3 4.0 4.1 3.5 2.7 2.0 1.5 1.0 0.7 0.4 0.3 0.2 0.1 0.2 0.2 0.3 0.4 0.5 0.6 0.7 0.7 0.7 0.7 0.7 0.7 0.7 0.7 0.6 0.5 0.4 0.5 0.8 1.2 2.0 3.3 3.9 3.4 3.4 3.9 2.6 1.5 0.9 0.5 0.2 0.1

0.4 0.6 0.8 1.0 1.3 1.5 1.6 1.6 1.5 1.3 1.0 0.8 0.6 0.4 0.3 0.2 0.3 0.4 0.6 0.9 1.2 1.7 2.2 2.7 3.0 3.0 2.6 2.2 1.8 1.5 1.3 1.2 0.8 0.5 0.3 0.2 0.1 0.1 0.1 0.1 0.2 0.2 0.3 0.4 0.4 0.4 0.4 0.4 0.4 0.4 0.4 0.4 0.3 0.3 0.3 0.5 1.0 1.9 3.2 5.1 3.1 3.2 4.3 2.7 1.4 0.7 0.3 0.1 0.1

								Statistics					
Catalog Number	Description	Lamp	Number Lamps	Filename	Lumens Per Lamp	Light Loss Factor	Wattage	Description	Symbol	Avg	Max	Min	Ma
VPL-80L-180-5K7-4W-	LARGE VIPER	X-70-CRI	1	VPL-80L-180-	12176	0.95	137.6	Calc Zone #1	+	1.5 fc	10.3 fc	0.0 fc	
BC				5K7-4W-BC.ies				Calc Zone #2	+	0.0 fc	0.4 fc	0.0 fc	
[]	[]	[]	1	[]	[]	0.95	362.6						

VPL-80L-180-

5K7-5W.ies

VPL-80L-180-

5K7-4.ies

21503

0.95

362.6

					Sca	ale - 1"	= 35ft					
		Lur	ninair	e Loca	tions							
/lax/Min	Avg/Min			1	Location						Aim	
N/A N/A	N/A N/A	No.	Label	х	Υ	Z	МН	Orientation	Tilt	х	Υ	z
		1	Α	-340.83	-58.86	20.00	20.00	90.20	0.00	-339.46	-58.87	0.00
		2	Α	342.79	-318.85	20.00	20.00	0.00	0.00	342.79	-317.48	0.00
		4	С	25.04	-134.18	20.00	20.00	90.00	0.00			
		5	С	-95.27	-135.71	20.00	20.00	90.00	0.00			
		6	С	217.67	-228.83	20.00	20.00	90.00	0.00			
		7	С	-275.73	-256.40	20.00	20.00	270.00	0.00			
		8	С	-95.65	-270.96	20.00	20.00	90.00	0.00			
		9	С	26.19	-267.51	20.00	20.00	90.00	0.00			
		1	D	334.72	-86.47	20.00	20.00	0.00	0.00			

Brian Mendez Date 4/12/2018 Scale Not to Scale Drawing No. Summary

GENERAL FLOOR PLAN NOTES:

- 1. THIS DRAWING IS DIAGRAMMATIC AND SHOULD BE USED TO DETERMINE THE DESIGN INTENT. THE CONTRACTOR IS RESPONSIBLE FOR THE COMPLETE SET OF WORK AS INDICATED AND SHALL FIELD VERIFY ALL WORK, COORDINATE ALL DRAWINGS / NEW WORK AND SHALL NOTIFY ARCHITECT IMMEDIATELY OF ANY DISCREPANCIES IN THE DOCUMENTS BEFORE PROCEEDING. FAILURE TO DO SO WILL RESULT IN THE CONTRACTOR TAKING FULL RESPONSIBILITY AND LIABILITY FOR SAID DISCREPANCIES.
- 2. ALL DIMENSIONS ARE SHOWN FROM FINISH FACE TO FINISH FACE OF PARTITION UNLESS OTHERWISE NOTED.
- 3. WALL THICKNESS' ARE NOMINAL NOT ACTUAL DIMENSIONS. SEE WALL SCHEDULE FOR ACTUAL DIMENSIONS.
- 4. ALL WOOD, INCLUDING BLOCKING, USED ON THE PROJECT SHALL BE FIRE RETARDANT TREATED.
- 5. ALL WORK SHALL BE DONE IN ACCORDANCE WITH ALL LOCAL, STATE, COUNTY CODE REGULATIONS, O.S.H.A., AND THE AMERICAN WITH DISABILITIES ACT (ADA). REFER TO THE CODE PLAN FOR MORE INFORMATION.
- 6. IF ANY QUESTIONS ARISE AS TO THE ARCHITECTURAL INTENT OF THESE DOCUMENTS, IT IS THE GENERAL CONTRACTORS RESPONSIBILITY TO ASK SUCH QUESTIONS OF THE ARCHITECT, AS THE ARCHITECT IS THE SOLE INTERPRETER OF THESE DOCUMENTS. IF NO SUCH QUESTIONS ARE
- ASKED, IT IS ASSUMED THAT THE ARCHITECTURAL INTENT OF THE DOCUMENTS IS UNDERSTOOD.

 7. THE GENERAL CONTRACTOR SHALL COORDINATE ALL APPLICABLE TRADES TO ENSURE PROPER ROUTING, DROPS, ETC. FOR THE H.V.A.C., ELECTRICAL, PLUMBING, ETC. DURING THE ROUGH FRAMING.

GENERAL DEMOLITION PLAN NOTES:

- 1. ALL DEMOLITION WORK REQUIRED IS NOT NECESSARILY LIMITED TO WHAT IS SHOWN ON THE DEMOLITION PLANS. THE INTENT IS TO REMOVE ALL MECHANICAL, ELECTRICAL, AND ARCHITECTURAL ITEMS AS REQUIRED TO FACILITATE NEW CONSTRUCTION.
- 2. COORDINATE SCOPE AND EXTENT OF DEMOLITION WORK WITH NEW WORK PLANS AND DETAILS.
- 3. IN OCCUPIED BUILDINGS, ANY CONSTRUCTION BEYOND 48 HOURS MUST BE ISOLATED WITH HARD BARRIER WALL (1 HR. RATED), PER BUILDING CODE.1 HOUR FIRE RATED PLASTIC BARRIER MAY BE USED, VERIFY WITH LOCAL AHJ. PROVIDE ANY/ALL DUST CONTROL AND INFECTION CONTROL MEASURES TO ISOLATE ALL WORK TO PROJECT AREA.
- 4. PHASED CONSTRUCTION MAY BE REQUIRED, FINAL NUMBER OF PHASES TBD BY OWNER/ ARCHITECT/ GC PRIOR TO CONSTRUCTION. CONTRACTOR PROVIDE ANY/ALL TEMP. CONSTRUCTION MEASURES AS REQUIRED BY LOCAL AHJ (EXIT SIGNS, EMERGENCY LIGHTING, CONSTRUCTION LIGHTING, EGRESS SIGNAGE, ETC.)
- 5. ALL DEMOLITION WORK SHALL BE PERFORMED IN A NEAT AND WORKMANSHIP MANNER. ALL SURFACES ADJACENT TO AND ABUTTING TO THOSE DESIGNATED "TO BE REMOVED" SHALL BE LEFT WITH A SMOOTH AND FLUSH APPEARANCE.
- 6. THE CONTRACTOR SHALL EXERCISE ALL REQUISITE CARE NECESSARY TO ENSURE THAT ALL EQUIPMENT, MATERIALS, FINISHES AND ASSEMBLIES WHICH ARE NOT BEING REMOVED ARE PROTECTED FROM DAMAGE DURING DEMOLITION AND SUBSEQUENT CONSTRUCTION OPERATIONS.
- 7. GENERAL PRECAUTIONS SHALL BE TAKEN AS NECESSARY TO HOLD ALL DISRUPTION, DUST, DIRT, NOISE, AND DEBRIS TO A MINIMUM.
- 8. THE CONTRACTOR SHALL COORDINATE DEMOLITION WORK WITH OWNER TO ENSURE THAT IMPACTS ON THE BALANCE OF THE BUILDING ARE HELD TO A MINIMUM.
- 9. PREPARE ALL SURFACES TO RECEIVE THE NEW WORK AND FINISHES OF THE CONTRACT.
- 10. THE CONTRACTOR SHALL DESIGN, PROVIDE, INSTALL AND MAINTAIN ANY AND ALL TEMPORARY BRACING AS REQUIRED TO ENSURE THE STABILITY OF THE BUILDING ASSEMBLY AND/OR ANY SYSTEMS AND/OR SUB-ASSEMBLIES AND/OR SYSTEMS APPURTENANT THERETO UNTIL SAID ASSEMBLY AND/OR SUB-ASSSEMBLIES ARE COMPLETE, SELF-SUPPORTING AND/OR STABLE. THE DEMOLITION PLANS GENERALLY INDICATE AREAS OF EXTENSIVE REMOVAL AND MAY INDICATE ALL OF THE WORK. CONTRACTOR SHALL PERFORM ALL OF THE DEMOLITION THAT IS NECESSARY FOR THE PROPER EXECUTION OF THE PROJECT, WHETHER OR NOT THAT DEMOLITION IS SPECIFICALLY INDICATED WITHIN THESE DOCUMENTS.PHASING OF DEMO WORK MAY BE REQUIRED.
- 11. PRIOR TO DEMOLITION, CONTRACTOR IS TO PROVIDE TEMPORARY SHORING, BRACING AND/OR SUPPORTS AS NEEDED FOR ALL WALLS, ROOF, AND STRUCTURAL ELEMENTS TO REMAIN AT AREAS OF REMOVAL OR ALTERATION THAT MAY BE AFFECTED BY DEMOLITION.
- 12. DEMOLITION CONTRACTOR TO COORDINATE WITH OTHER TRADES AND MECHANICAL ELECTRICAL, PLUMBING DRAWINGS FOR AREAS OF ADDITIONAL DEMOLITION, AND EXTENT OF RESPONSIBILITY. CONTRACTOR TO COORDINATE ALL UTILITY SHUTOFFS NEEDED TO MAINTAIN SAFETY AND BUILDING USE AND CONTINUITY.
- 13. DEMOLITION CONTRACTOR IS TO TAKE PRECAUTIONS TO ENSURE COLLAPSE OF STRUCTURE AND PLACEMENT OF DEBRIS IS CONTROLLED, SO AS TO MINIMIZE CONTAMINATION OF THE SITE AND SURROUNDING PROPERTIES.
- 14. ALL DEMOLITION IS TO BE COMPLETED WITH THE UTMOST CARE SO AS TO NOT DAMAGE ADJACENT SURFACES TO REMAIN

RESULTING IN DISCREPANCIES WITH THE DRAWINGS, NOTIFY ARCHITECT IMMEDIATELY

- 15. CONTRACTOR IS RESPONSIBLE TO PROPERLY DISPOSE OF ALL DEMOLISHED ITEMS NOT INDICATED TO BE RESERVED, RELOCATED, OR TURNED OVER TO THE OWNER. VERIFY ALL ITEMS WITH OWNER.
- 16. PATCH AND REPAIR ADJACENT SURFACES AT AREAS OF REMOVAL AND/OR ALTERATION TO MATCH EXISTING. PROVIDE SOUND AND PROPER SUBSTRATE FOR NEW FINISH. COORDINATE W/ COLOR OR FINISH PLANS. WHERE A NEW FINISH IS NOT INDICATED, MATCH ADJACENT SURFACES.
- 17. CLEAN AND PREPARE ALL EXISTING AND NEW SURFACES WHICH ARE TO BE PAINTED/ PATCHED. PREPARATION IS TO INCLUDE SCRAPING TO LEVEL SUBSTRATE AND MINOR PATCHING.
- 18. MULTIPLE MOBILIZATIONS MAY BE NECESSARY TO COMPLETE DEMOLITION. SHOULD UNEXPECTED STRUCTURAL CONDITIONS BE DISCOVERED
- 19. SURVEY EXISTING CONDITIONS AND CORRELATE WITH DRAWINGS TO VERIFY EXTENT OF DEMOLITION REQUIRED.
- 20. VERIFY CONDITIONS AT SITE TO DETERMINE WHETHER DEMOLITION METHODS PROPOSED FOR USE WILL NOT ENDANGER EXISTING STRUCTURES BY OVERLOADING, FAILURE, OR UNPLANNED COLLAPSE.
- 21. PROVIDE SELECTIVE DEMOLITION OF EXISTING CONSTRUCTION ONLY TO THE EXTENT REQUIRED BY NEW CONSTRUCTION AND AS INDICATED
- ON THE PLANS.

 22. PROTECT PORTIONS OF BUILDING AFFECTED BY DEMOLITION OPERATIONS.
- 23. REMOVE ABANDONED UTILITIES AND WIRING SYSTEMS.
- 24. PROTECT EXISTING UTILITIES AND SERVICES TO REMAIN AGAINST DAMAGE DURING DEMOLITION OPERATIONS.
- 25. NOTIFY OWNER OF SCHEDULE OF SHUT OFF OF UTILITIES WHICH SERVE OCCUPIED SPACES.

ELECTRICAL:


- 26. REMOVE, RELOCATE, AND EXTEND EXISTING INSTALLATIONS TO ACCOMMODATE NEW CONSTRUCTION.
- 27. REMOVE ABANDONED WIRING TO SOURCE OF SUPPLY.
- 28. EXTEND EXISTING INSTALLATIONS USING MATERIALS AND METHODS COMPATIBLE WITH EXISTING ELECTRICAL INSTALLATIONS.


HVAC:

29. REMOVE, RELOCATE, EXTEND EXISTING INSTALLATIONS TO ACCOMMODATE NEW CONSTRUCTION.


REGULATORY 30 CONFOR

- 30. CONFORM TO APPLICABLE CODE FOR DEMOLITION WORK, SAFETY OF STRUCTURE, AND DUST CONTROL.
- 31. OBTAIN REQUIRED PERMITS FROM AUTHORITIES.
- 32. NOTIFY AFFECTED UTILITY COMPANIES BEFORE STARTING WORK AND COMPLY WITH THEIR REQUIREMENTS.
- 33. CONFORM TO APPLICABLE CODES WHEN HAZARDOUS OR CONTAMINATED MATERIALS ARE DISCOVERED.
- 34. DO NOT CLOSE OR OBSTRUCT EXITS.
- 35. DO NOT DISABLE OR DISRUPT BUILDING FIRE OR LIFE SAFETY SYSTEMS WITHOUT 13] DAYS PRIOR WRITTEN NOTICE TO OWNER.

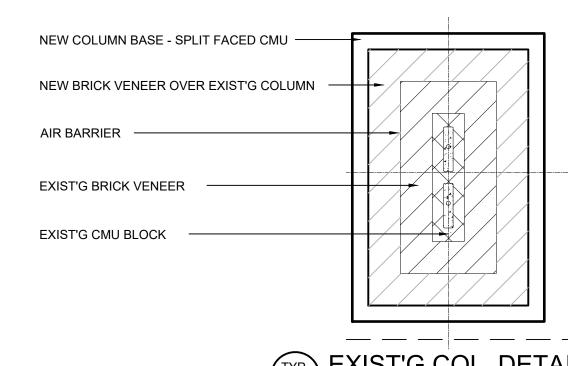


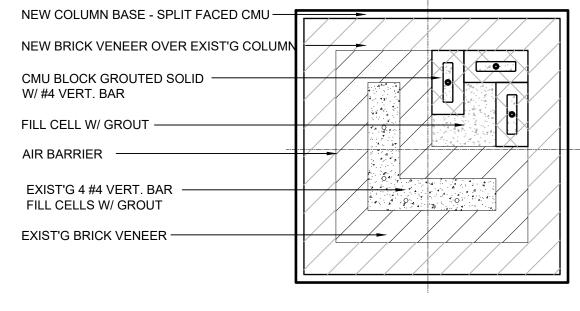



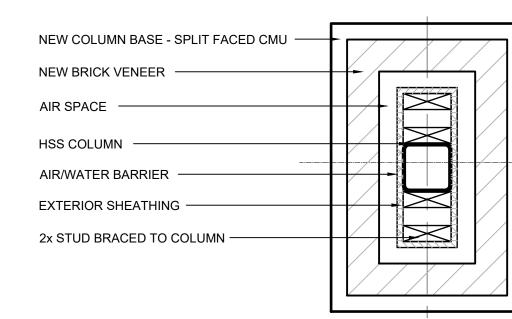

NEW COL. DETAIL
A1.0 SCALE: 1" = 1'-0"

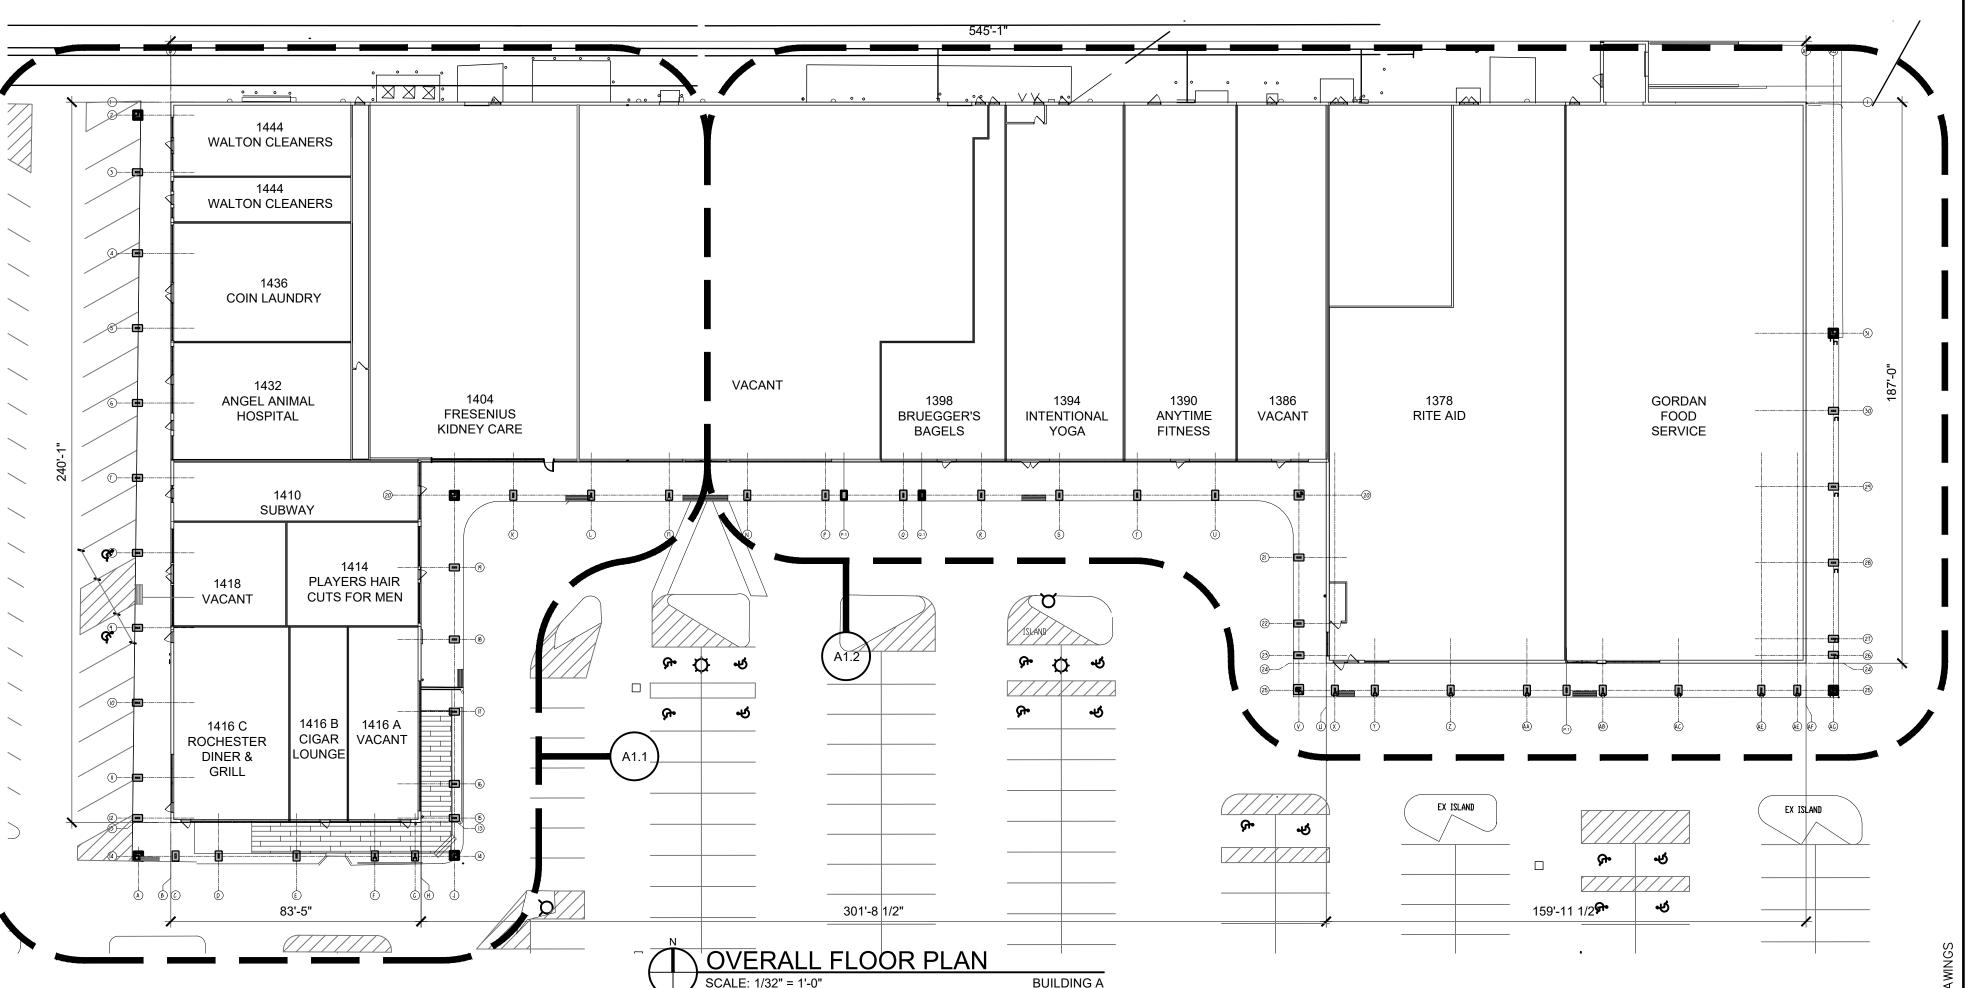

SVA

STUCKY VITALE ARCHITECTS
27172 WOODWARD AVENUE
ROYAL OAK, MI 48067-0925
P. 248.546.6700
F. 248.546.8454
WWW.STUCKYVITALE.COM

Project :

ROCHESTER HILLS
RETAIL
FACADE RENOVATION
LIVERNOIS + W.WALTON RD.
ROCHESTER HILLS, MI
48307

Issued for :

NO CHANGES

SITE PLAN
APPROVAL 08.28.17
SITE PLAN APPROVAL
COMMENTS 02.02.18
SITE PLAN APPROVAL
COMMENTS #2 03.14.18
NO CHANGES
SITE PLAN APPROVAL
COMMENTS #3 04.17.18




Drawn by: SVA Checked by: JAV, MJB

Sheet Title : OVERALL FLOOR PLAN BUILDING A

Project No. : 2017.02

Sheet No. :

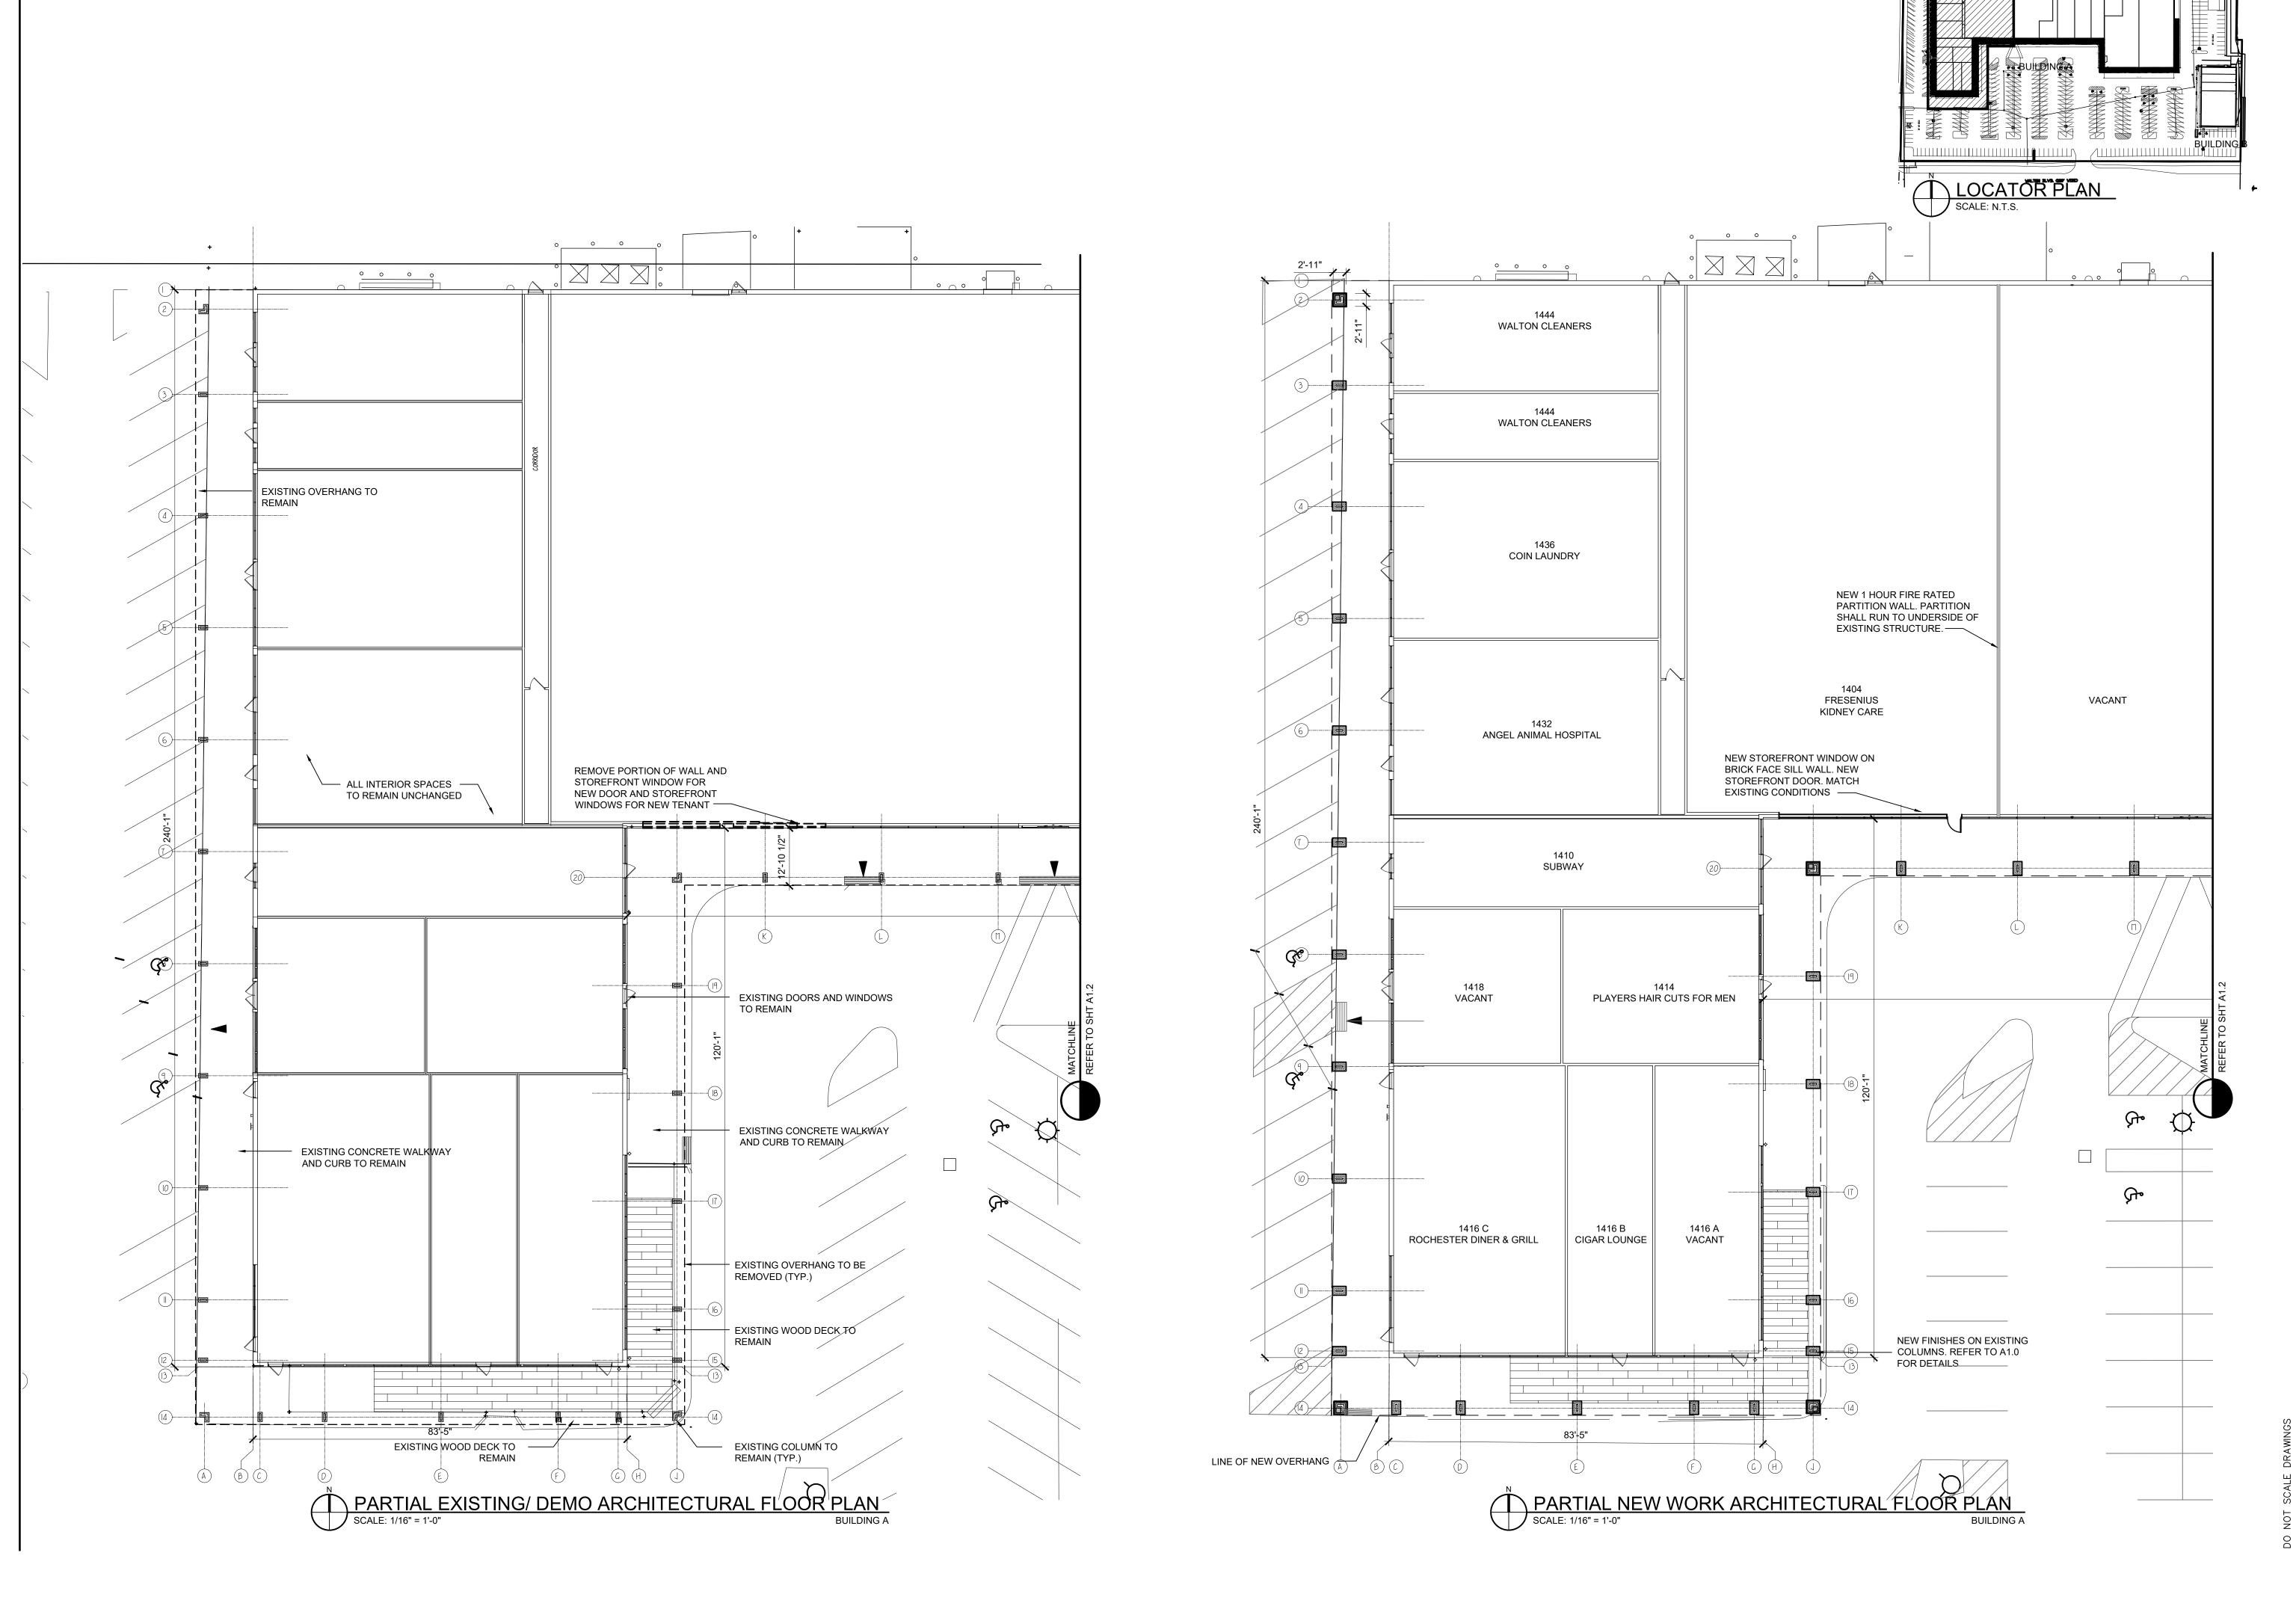



WWW.STUCKYVITALE.COM

P. 248.546.6700 F. 248.546.8454

PROJECT AREA

Project :

ROCHESTER HILLS
RETAIL
FACADE RENOVATION
LIVERNOIS + W.WALTON RD.
ROCHESTER HILLS, MI
48307

Issued for:

SITE PLAN
APPROVAL 08.28.17
SITE PLAN APPROVAL
COMMENTS 02.02.18
SITE PLAN APPROVAL
COMMENTS #2 03.14.18
NO CHANGES
SITE PLAN APPROVAL
COMMENTS #3 04.17.18
NO CHANGES




Drawn by : SVA Checked by : JAV, MJB

Sheet Title : PARTIAL FLOOR PLAN BUILDING A

Project No. : 2017.022

Sheet N

Sheet No.:

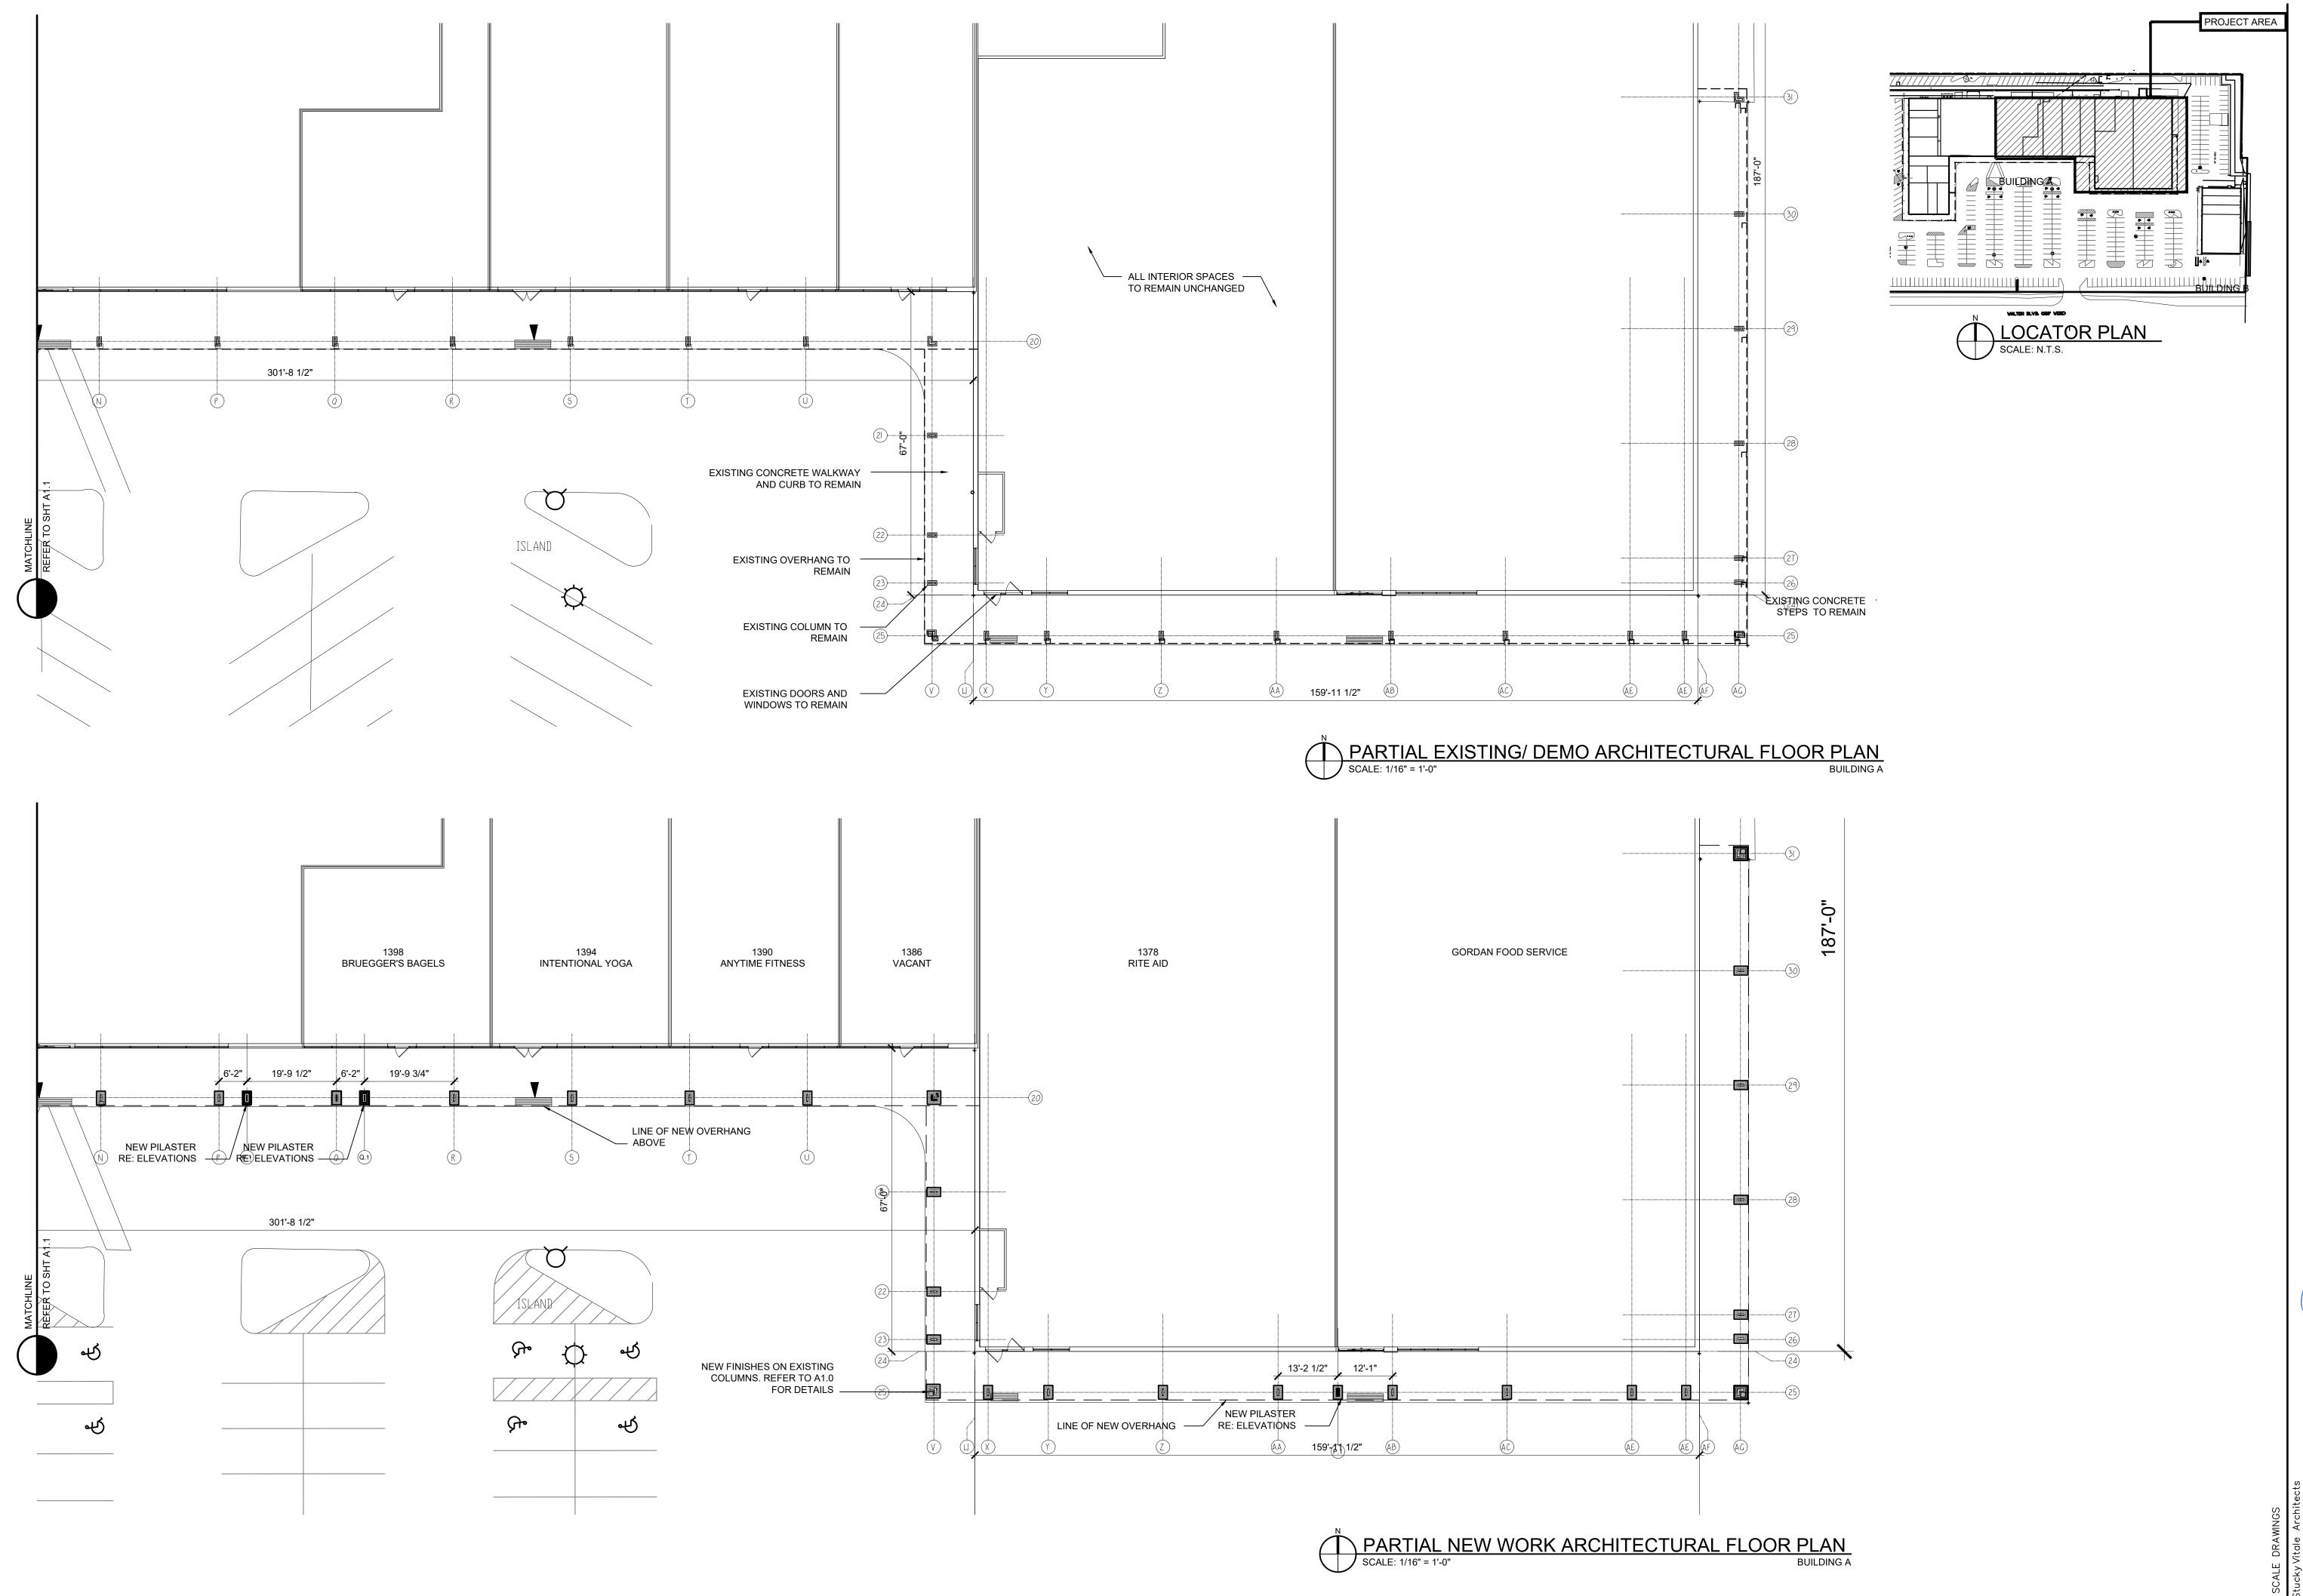

SVA


STUCKY VITALE ARCHITECTS
27172 WOODWARD AVENUE
ROYAL OAK, MI 48067-0925
P. 248.546.6700
F. 248.546.8454
WWW.STUCKYVITALE.COM

Project :

ROCHESTER HILLS
RETAIL
FACADE RENOVATION
LIVERNOIS + W.WALTON RD.
ROCHESTER HILLS, MI
48307

Issued for:

SITE PLAN
APPROVAL
O8.28.17
SITE PLAN APPROVAL
COMMENTS
O2.02.18
SITE PLAN APPROVAL
COMMENTS #2
O3.14.18
NO CHANGES
SITE PLAN APPROVAL
COMMENTS #3
NO CHANGES

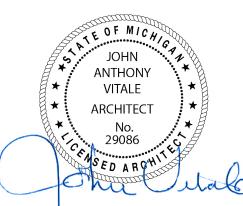


Drawn by : SVA Checked by : JAV, MJB


Sheet Title : PARTIAL FLOOR PLAN BUILDING A

Project No.: 2017.022

Sheet No. :


A1.2

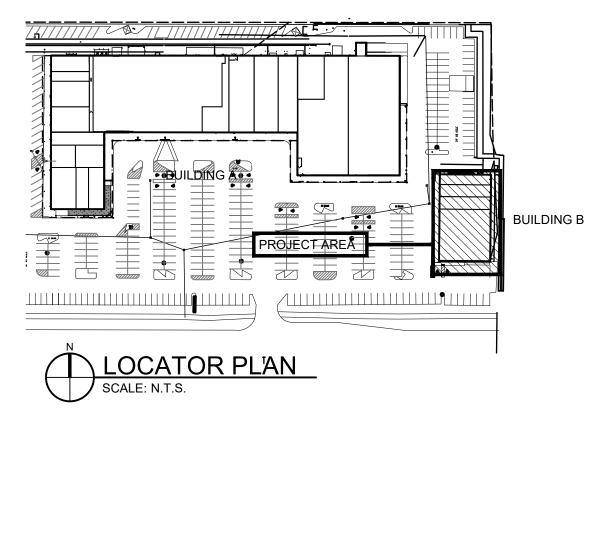

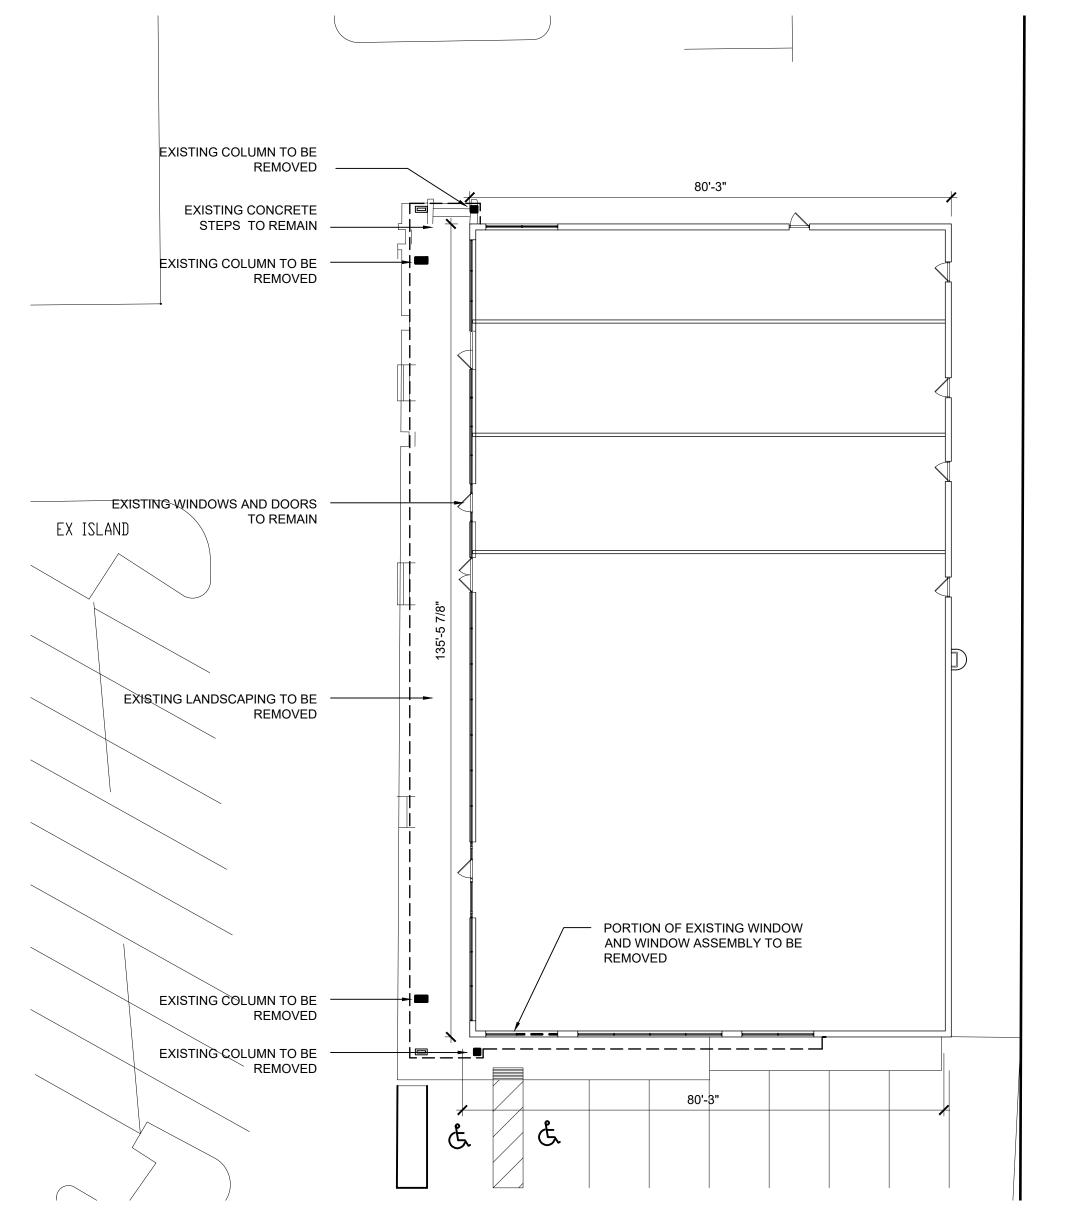

OVERALL EXISTING/ DEMO ARCHITECTURAL FLOOR PLAN

SCALE: 1/16" = 1'-0"

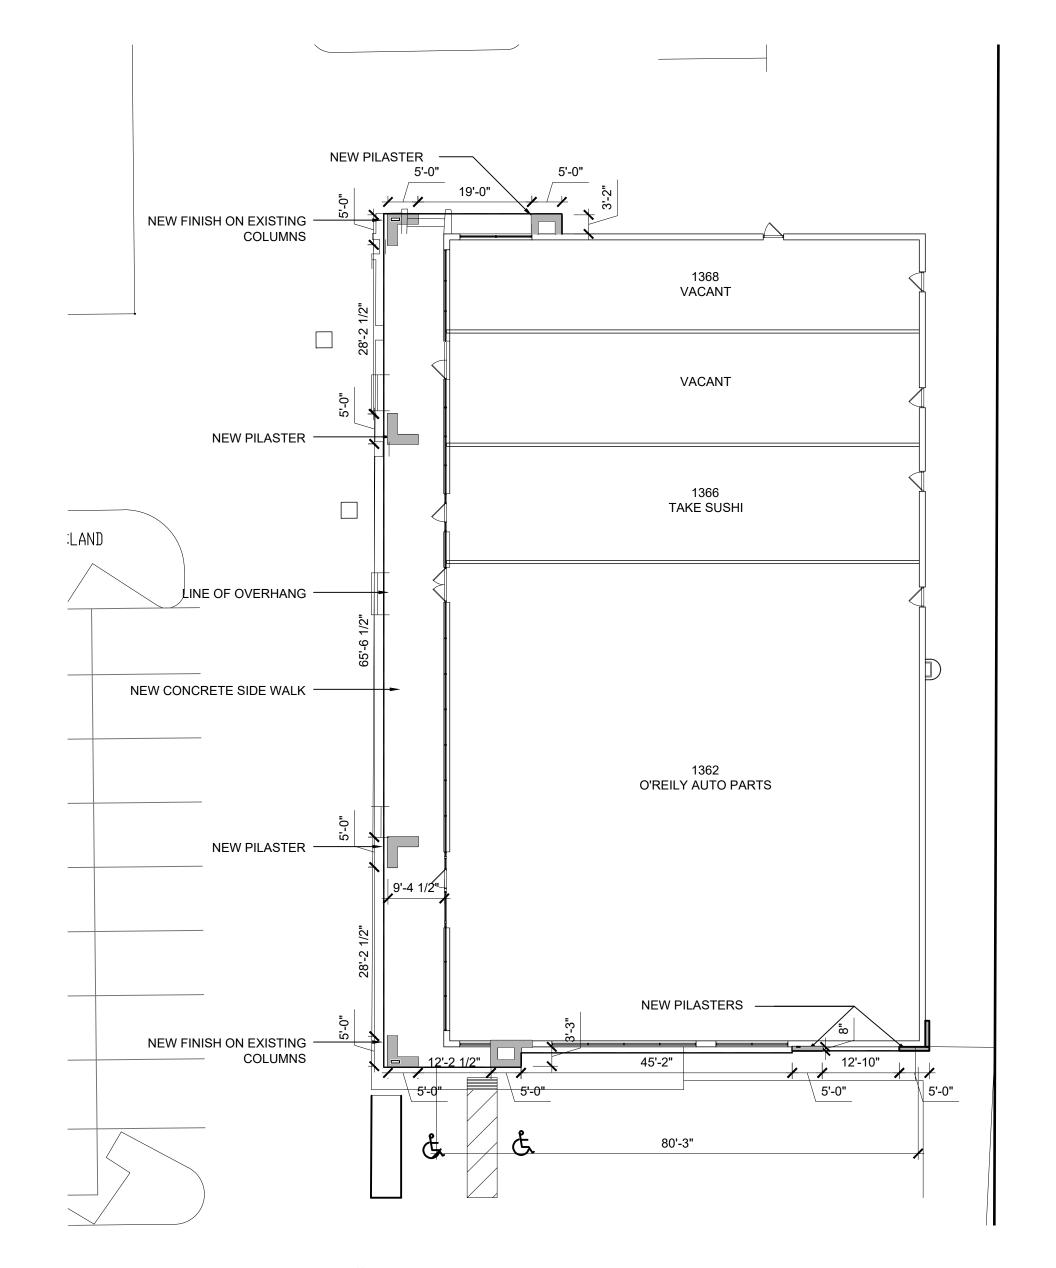

OVERALL NEW WORK ARCHITECTURAL FLOOR PLAN

SCALE: 1/16" = 1'-0"

Project :

ROCHESTER HILLS RETAIL FACADE RENOVATION LIVERNOIS + W.WALTON RD. ROCHESTER HILLS, MI

STUCKY VITALE ARCHITECTS 27172 WOODWARD AVENUE ROYAL OAK, MI 48067-0925

W W W . STUCKYVITALE.COM

P. 248.546.6700 F. 248.546.8454

Issued for:

SITE PLAN APPROVAL 08.28.17 SITE PLAN APPROVAL COMMENTS SITE PLAN APPROVAL COMMENTS #2 03.14.18 NO CHANGES SITE PLAN APPROVAL COMMENTS #3 04.17.18 NO CHANGES




Drawn by: SVA Checked by : JAV, MJB


Sheet Title :OVERALL FLOOR PLAN BUILDING B


Project No. : 2017.022

Sheet No. :

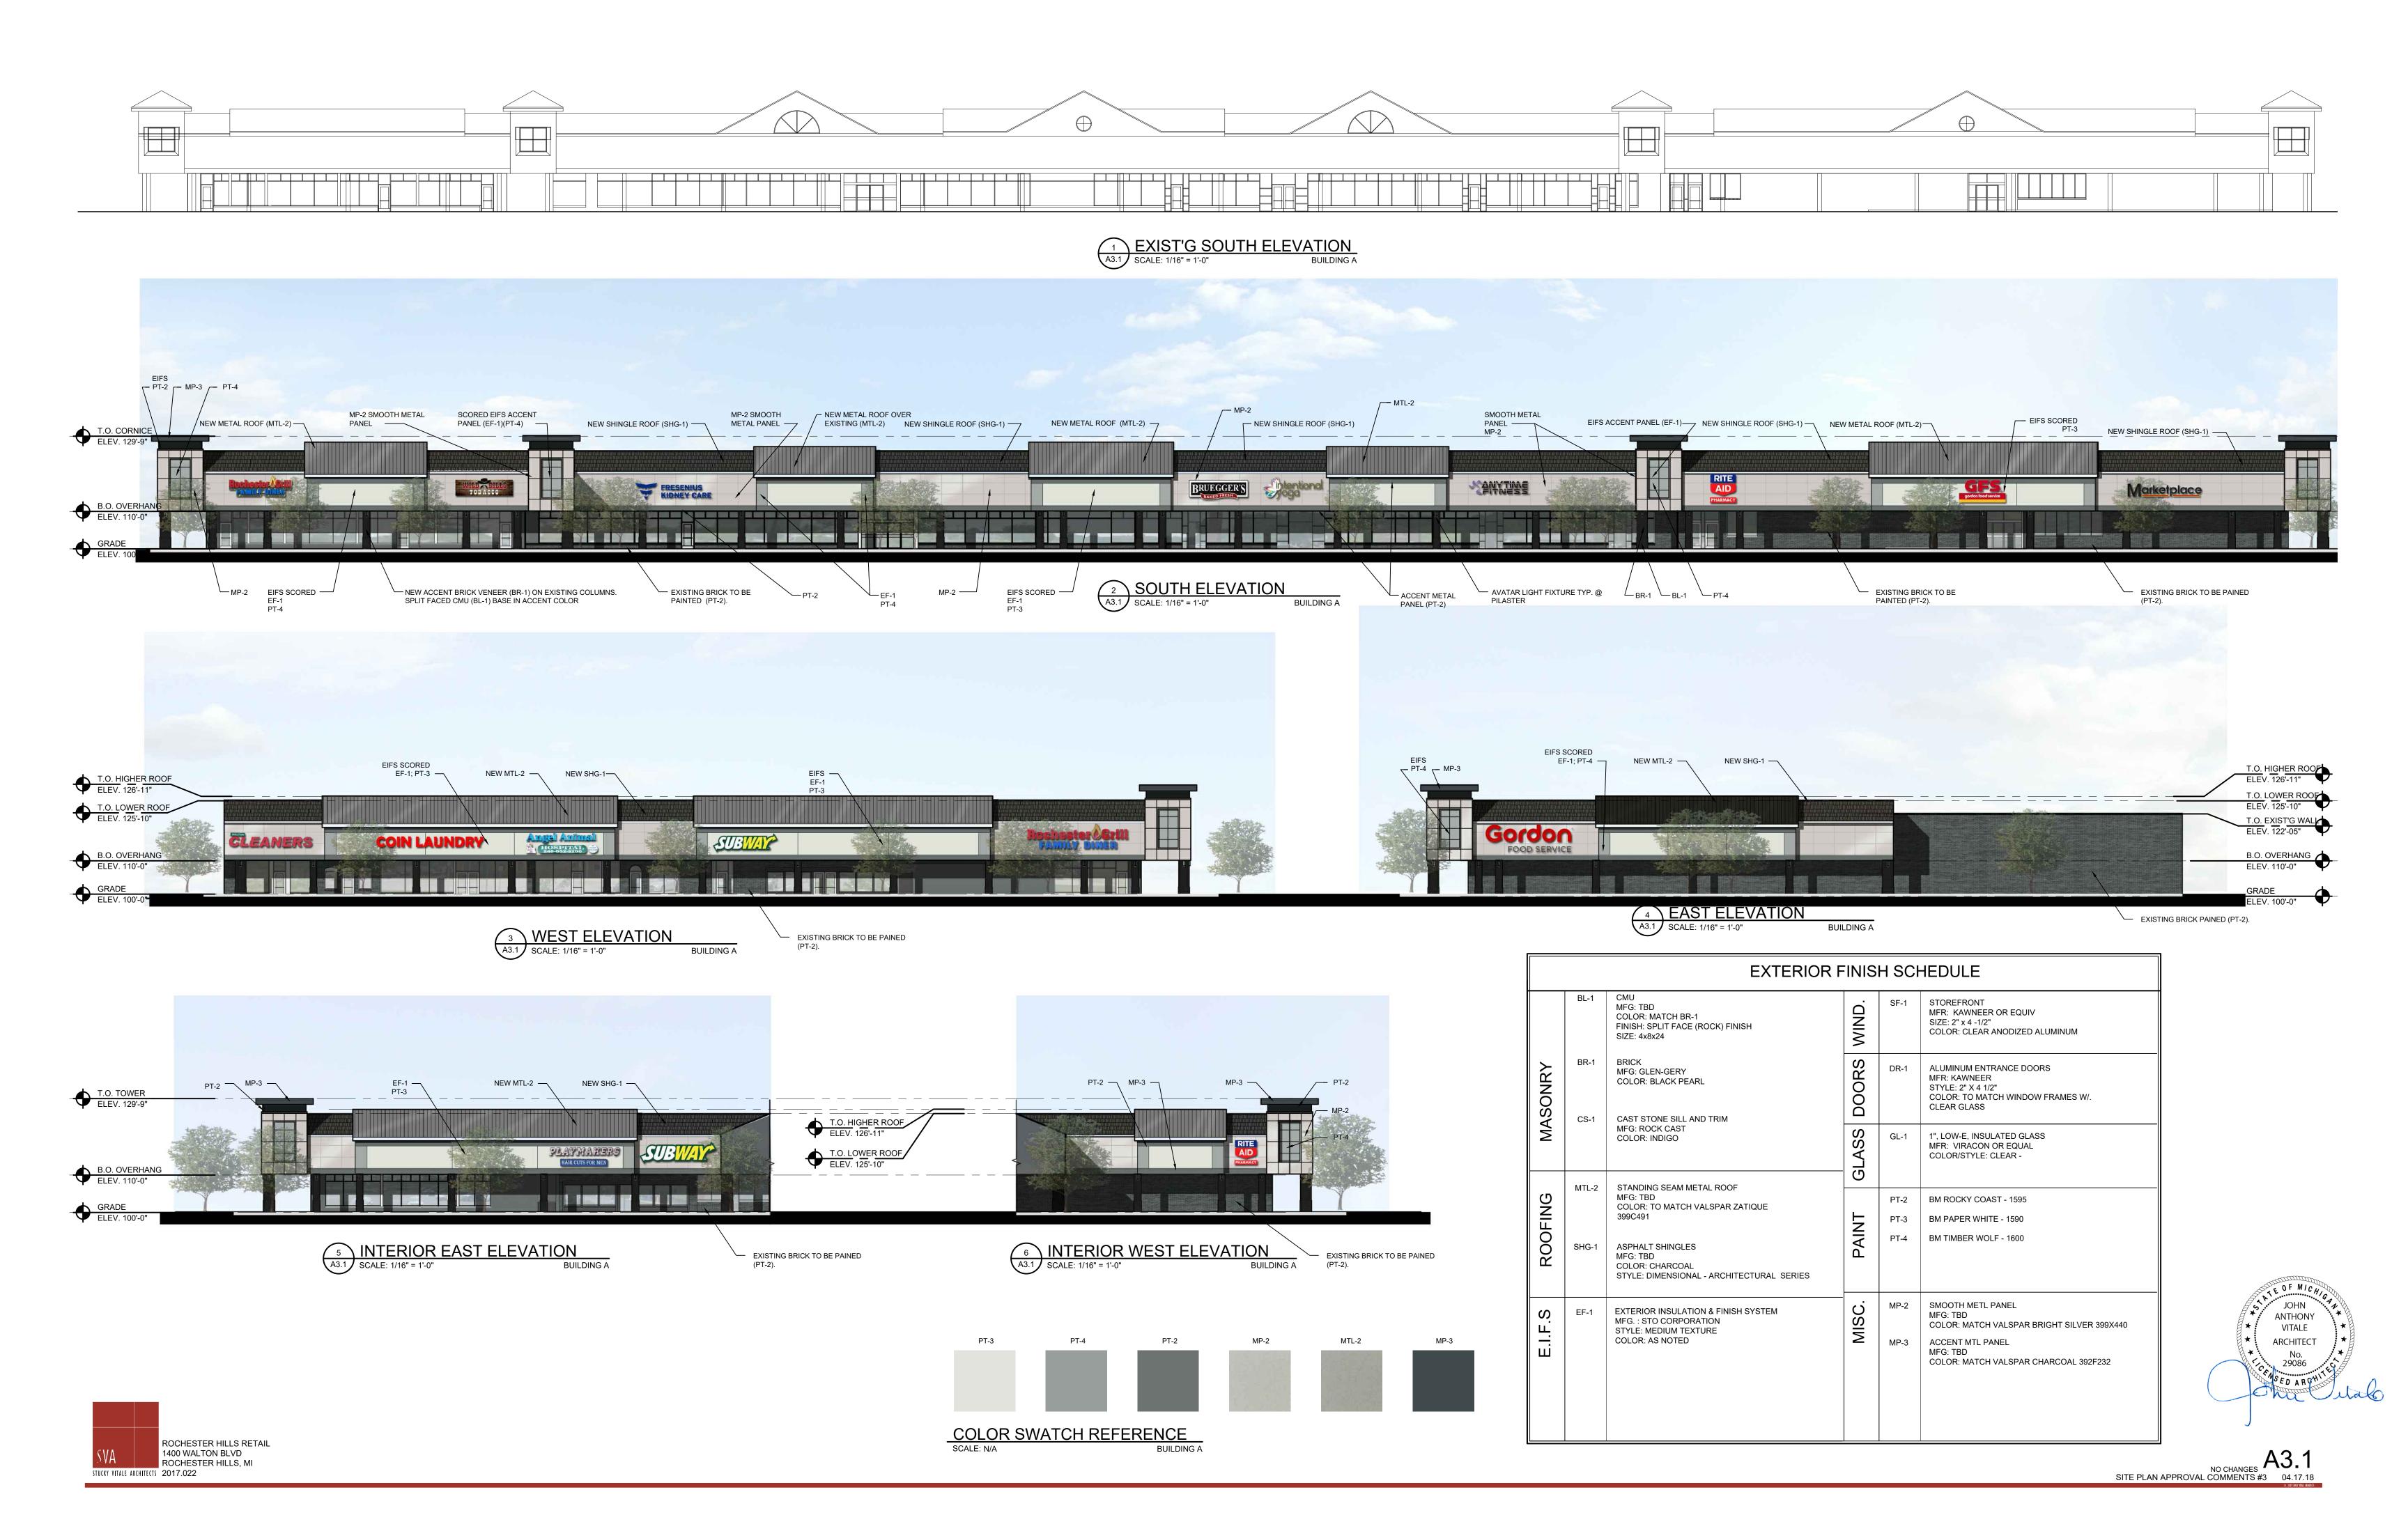



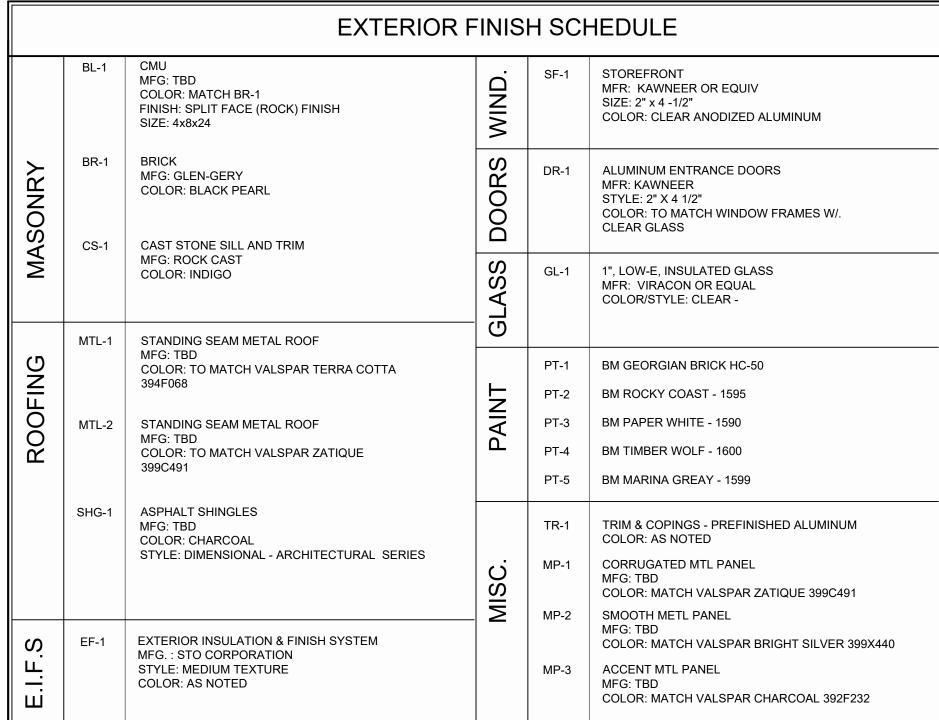

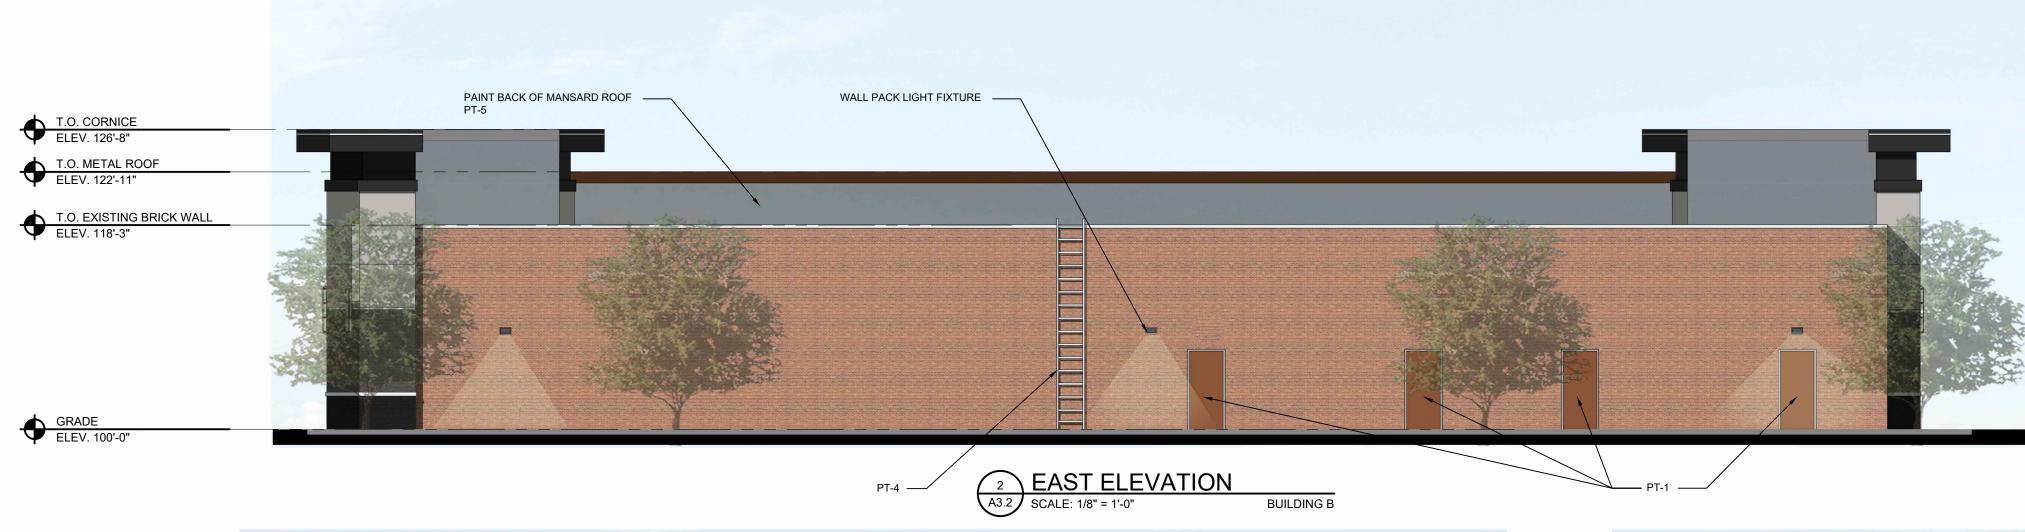

PAINT EXISTING CMU TO MATCH BRICK ——

NORTH ELEVATION

A3.2 SCALE: 1/8" = 1'-0"

B



T.O. CORNICE ELEV. 126'-8"

B.O. OVERHANG ELEV. 110'-0"

GRADE

ELEV. 100'-0"

T.O. EXISTING BRICK WALL ELEV. 118'-3"