## **GRADING AND DRAINAGE NOTES**

1. ALL EXISTING STRUCTURES, UNLESS OTHERWISE NOTED TO REMAIN, FENCING, TREES, & ETC., WITHIN CONSTRUCTION AREA SHALL BE REMOVED & DISPOSED OF OFF SITE. ANY BURNING ON SITE SHALL BE SUBJECT TO LOCAL ORDINANCES &

LOWE'S SPECIFICATIONS.
2. ALL DRAINAGE STRUCTURES SHALL BE PRE-CAST.

3. ALL DRAINAGE STRUCTURES AND STORM SEWER PIPES SHALL MEET HEAVY

DUTY TRAFFIC (H20) LOADING AND BE INSTALLED ACCORDINGLY.

4. CONTRACTOR SHALL NOTIFY ALL UTILITY COMPANIES HAVING UNDERGROUND UTILITIES ON SITE OR IN RIGHT-OF-WAY PRIOR TO EXCAVATION. CONTRACTOR SHALL CONTACT UTILITY LOCATING COMPANY AND LOCATE ALL UTILITIES PRIOR

TO GRADING START.
5. SITE GRADING SHALL NOT PROCEED UNTIL EROSION CONTROL MEASURES HAVE BEEN INSTALLED.

6. AFTER PERMITS HAVE BEEN OBTAINED & EROSION CONTROL MEASURES INSTALLED, THE CONTRACTOR SHALL GRADE BUILDING PAD, GARDEN CENTER & APRONS TO 1/2"± FT. OF SUBGRADE AS PER SECTION 02300, DIVISION 2 OF LOWE'S STANDARD SITE SPECIFICATIONS

STANDARD SITE SPECIFICATIONS.
7. IMMEDIATELY APPLY & COMPACT STONE BASE FOR BUILDING PAD TO +/- 1/2"

BEFORE EXCAVATING INTERIOR & PERIMETER FOOTINGS.

8. FRENCH DRAIN SHALL BE INSTALLED IF DIRECTED BY THE GEOTECHNICAL ENGINEER OR AS SHOWN ON PLANS.

9. CONTRACTOR SHALL PROVIDE 2' x 2' x 6" THICK CONCRETE APRON AT ALL

CLEANOUTS OUTSIDE OF BUILDING.
10. ALL WORK SHALL BE DONE IN STRICT ACCORDANCE WITH DIVISION 2 OF LOWE'S

STANDARD SITE SPECIFICATIONS.

11. ALL ROOF DRAINS TO BUILDING SHALL END 5' OUTSIDE THE BUILDING LIMITS AS SHOWN ON PLAN AND SHALL BE PROVIDED WITH A TEMPORARY PLUG AT THE END.

12. PROPOSED RETENTION POND SHALL HAVE MAXIMUM SIDE SLOPES OF 1 FOOT

VERTICAL AND 6 FOOT HORIZONTAL.

13. PROPOSED CATCH BASINS ARE BASED ON THE CENTER OF THE BACK OF CASTING WHICH IS LOCATED ON THE BACK OF CURB. ACTUAL GUTTER LINE OF

STRUCTURE SHALL BE CALCULATED PRIOR CONSTRUCTION. REFER TO CITY OF ROCHESTER HILLS TOWNSHIP STORM STANDARDS FOR RIM TYPES.

14. TOP OF CURB GRADE FOR PITCH-OUT CURB WILL BE 0.50' ABOVE TOP OF ASPHALT AND FOR PITCH-IN CURB TOP OF CURB WILL BE 0.42' ABOVE TOP OF

ASPHALT.

15. ALL CURB NOT LABELED AS 24" CONCRETE PITCH-IN CURB SHALL BE 24"

CONCRETE PITCH-OUT CURB.

16. A PERMIT FROM MDOT SHALL BE REQUIRED FRO ALL WORK WITHIN ROCHESTER ROAD RIGHT-OF-WAY.

17. ALL GRADING MUST BE DESIGNED IN ACCORDANCE WITH CITY OF ROCHESTER

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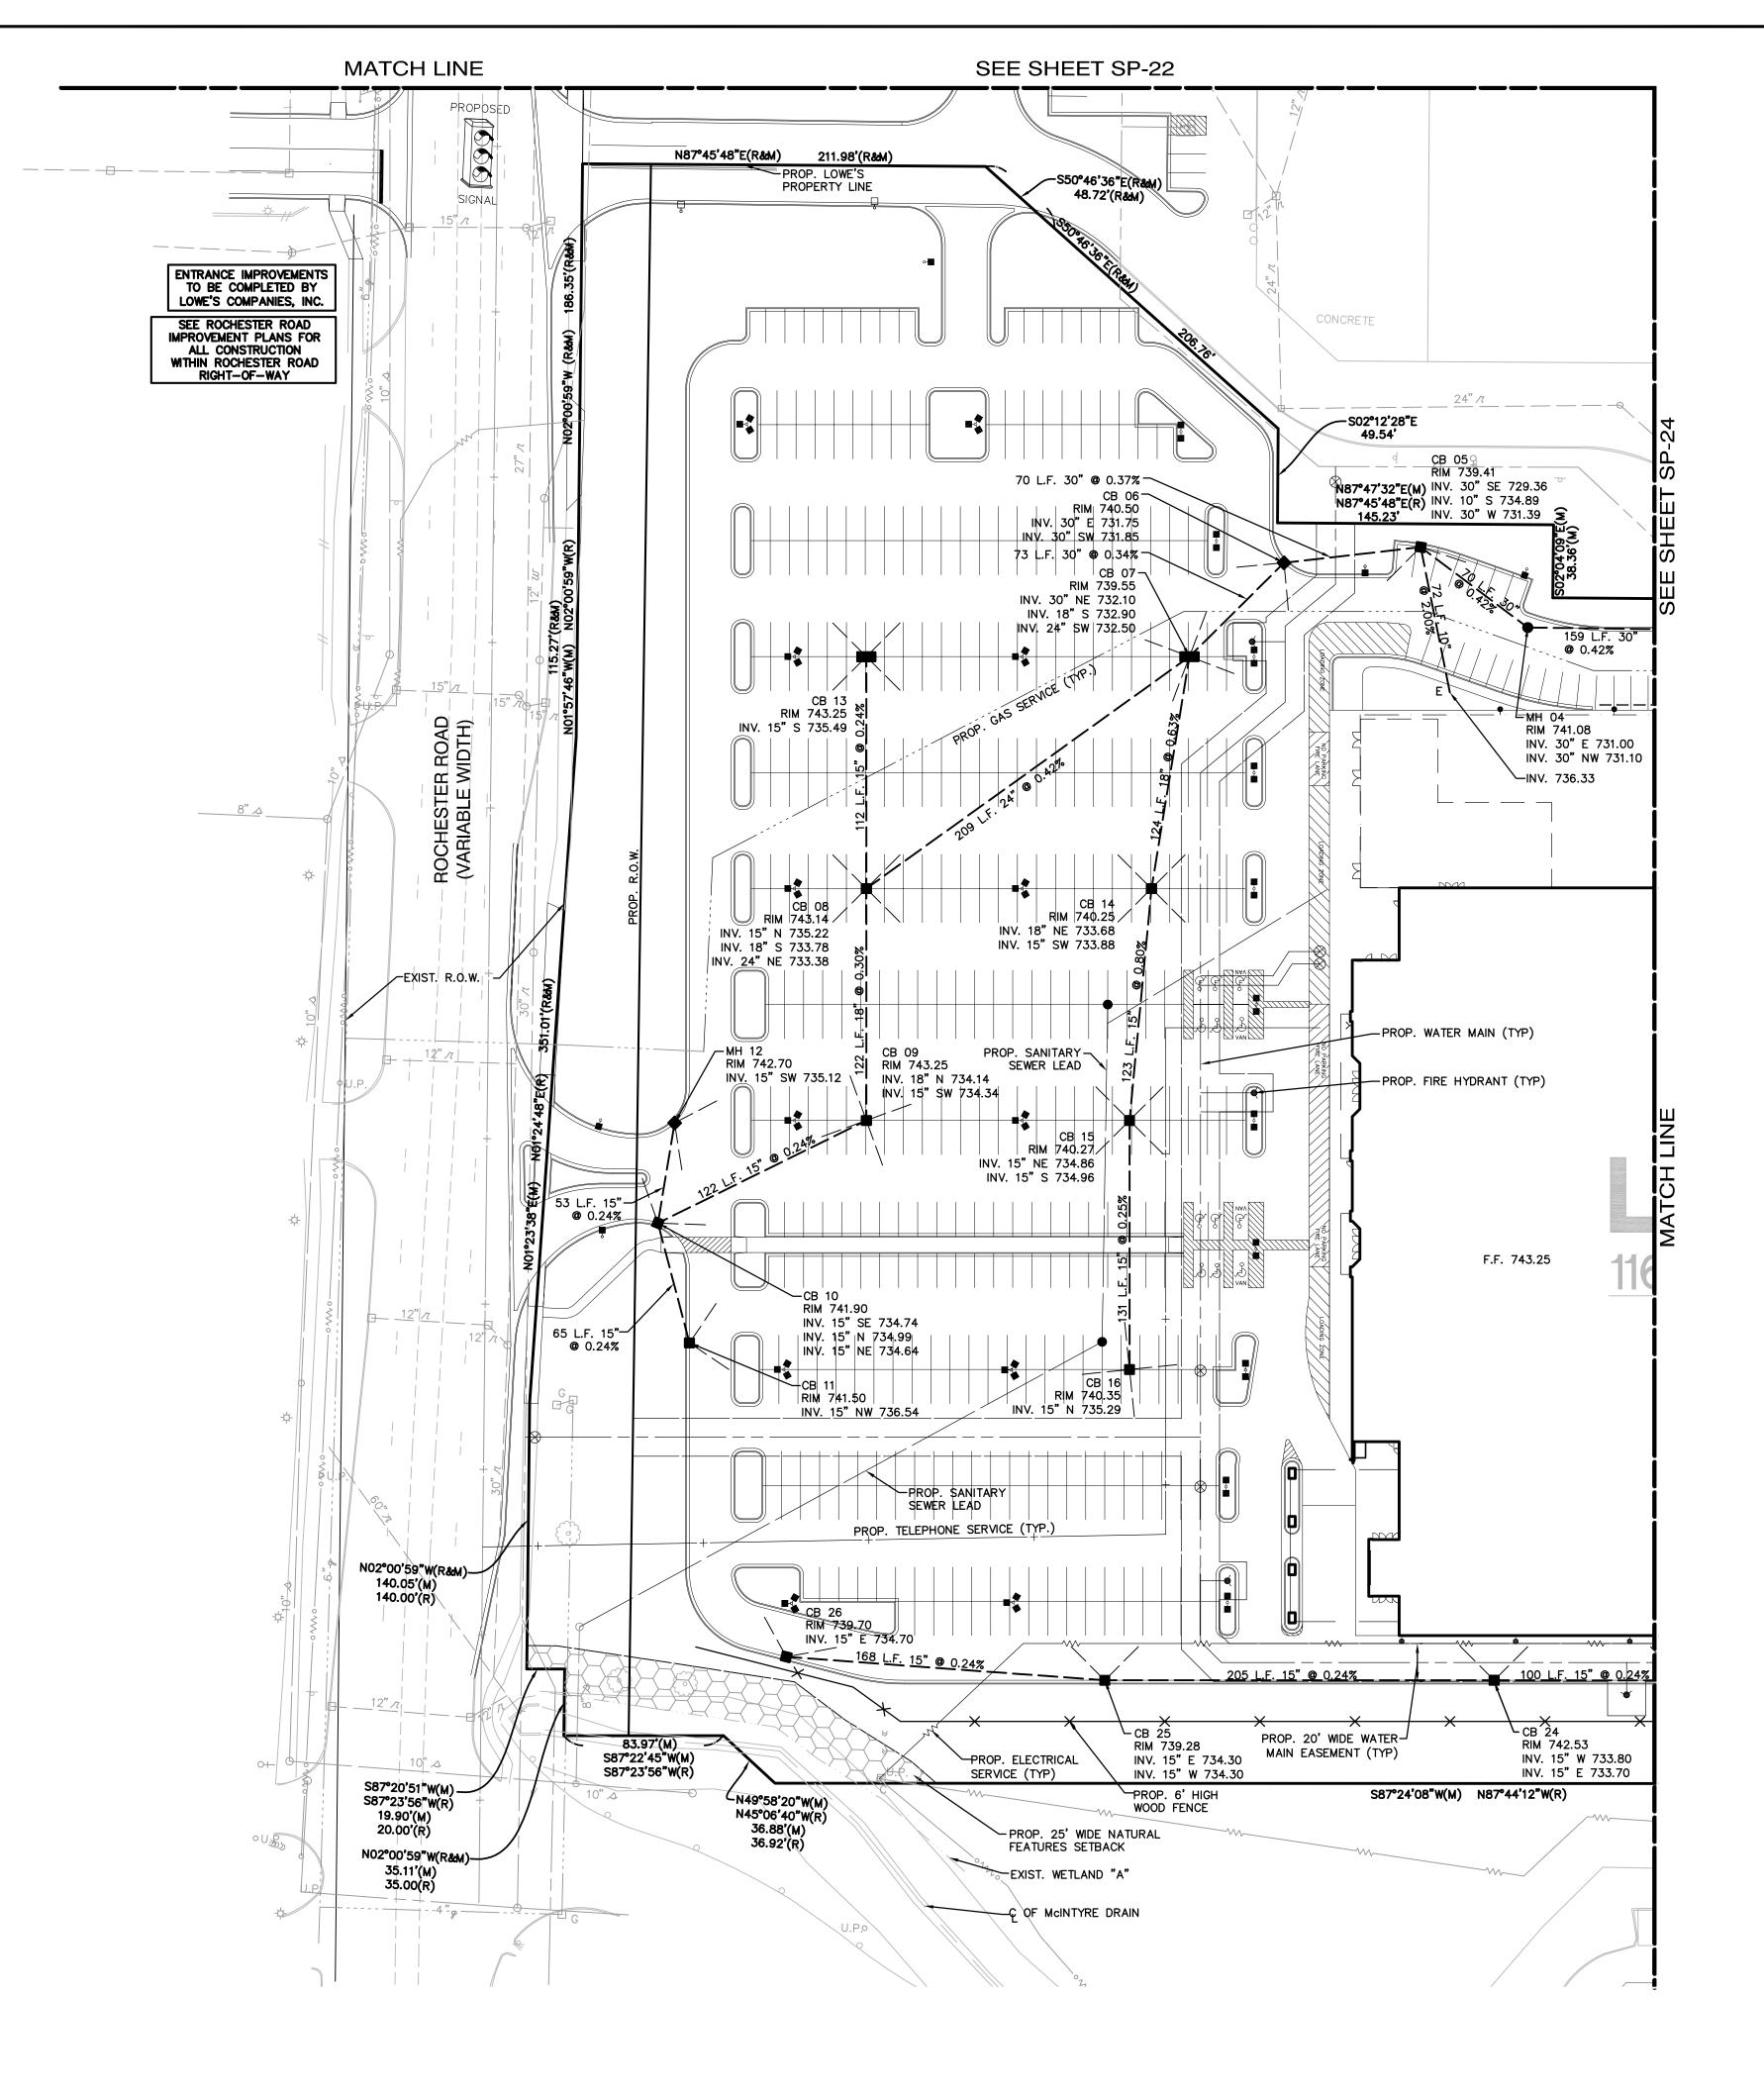
3 WORKING DAYS
BEFORE YOU DIG
CALL MISS DIG
1-800-482-7171
FOR THE LOCATION OF
UNDERGROUND FACILITIES

THE LOCATIONS OF EXISTING UNDERGROUND UTILITIES ARE SHOWN IN AN APPROXIMATE WAY ONLY AND HAVE NOT BEEN INDEPENDENTLY VERIFIED BY THE OWNER OR ITS REPRESENTATIVE. THE CONTRACTOR SHALL DETERMINE THE EXACT LOCATION OF ALL EXISTING UTILITIES BEFORE COMMENCING WORK, AND AGREES TO BE FULLY RESPONSIBLE FOR ANY AND ALL DAMAGES WHICH MIGHT BE OCCASIONED BY THE CONTRACTOR'S FAILURE TO EXACTLY LOCATE AND PRESERVE ANY AND ALL UNDERGROUND UTILITIES.

# NOTIC

CONSTRUCTION SITE SAFETY IS THE SOLE RESPONSIBILITY OF THE <u>CONTRACTOR</u>; NEITHER THE OWNER NOR THE ENGINEER SHALL BE EXPECTED TO ASSUME ANY RESPONSIBILITY FOR SAFETY OF THE WORK, OF PERSONS ENGAGED IN THE WORK, OF ANY NEARBY STRUCTURES, OR OF ANY OTHER PERSONS.

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Engineering · Sur Environmental · '

LOWE'S HOME CENTERS, INC.

1605 CURTIS BRIDGE ROAD
REEC DOCK
WILKESBORO, NC 28697
336.658.4000 (V) 336.658.3257 (F

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SEWER PLAN
S OF
HESTER HILLS

ORIGINAL
ISSUE DATE: 10/18/2005
PERMIT SET
ISSUE DATE:
CONSTRUCTION SET
ISSUE DATE:
DRAWING NUMBER:

SP-23 4102-50-23

CITY FILE: 05-037

NOT TO BE USED FOR CONSTRUCTION

## **GRADING AND DRAINAGE NOTES**

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BEFORE YOU DIG CALL MISS DIG FOR THE LOCATION OF


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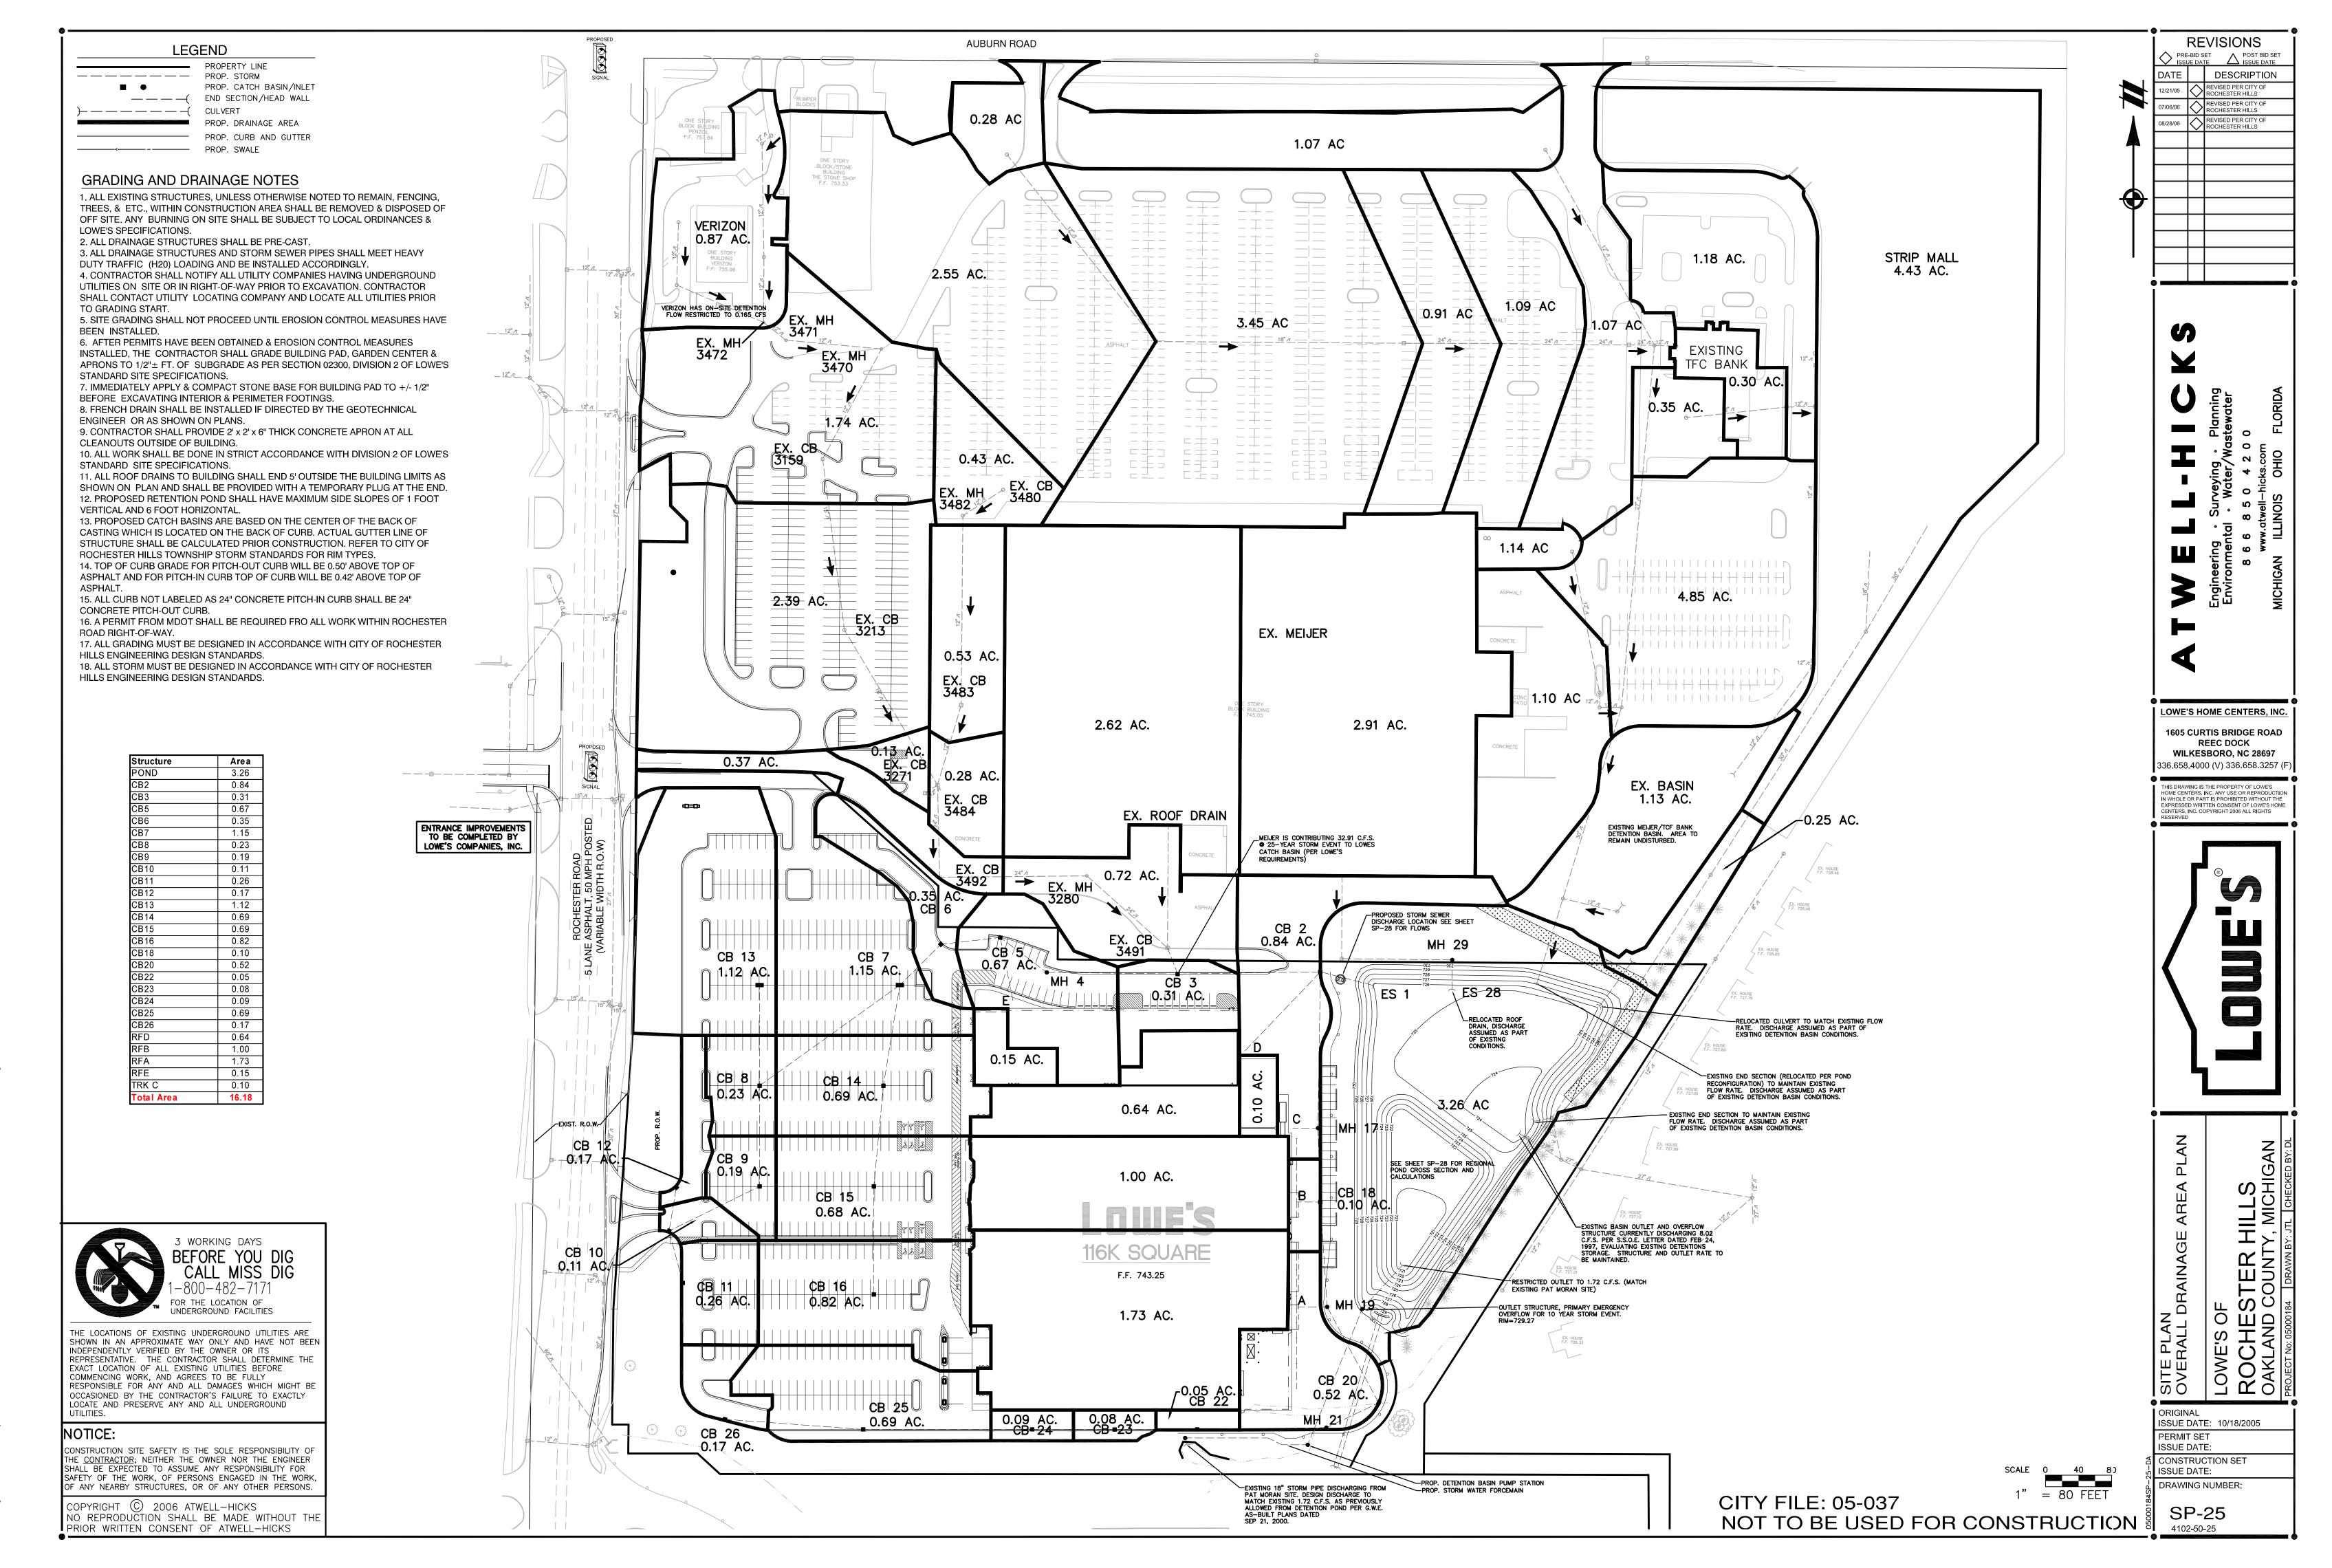
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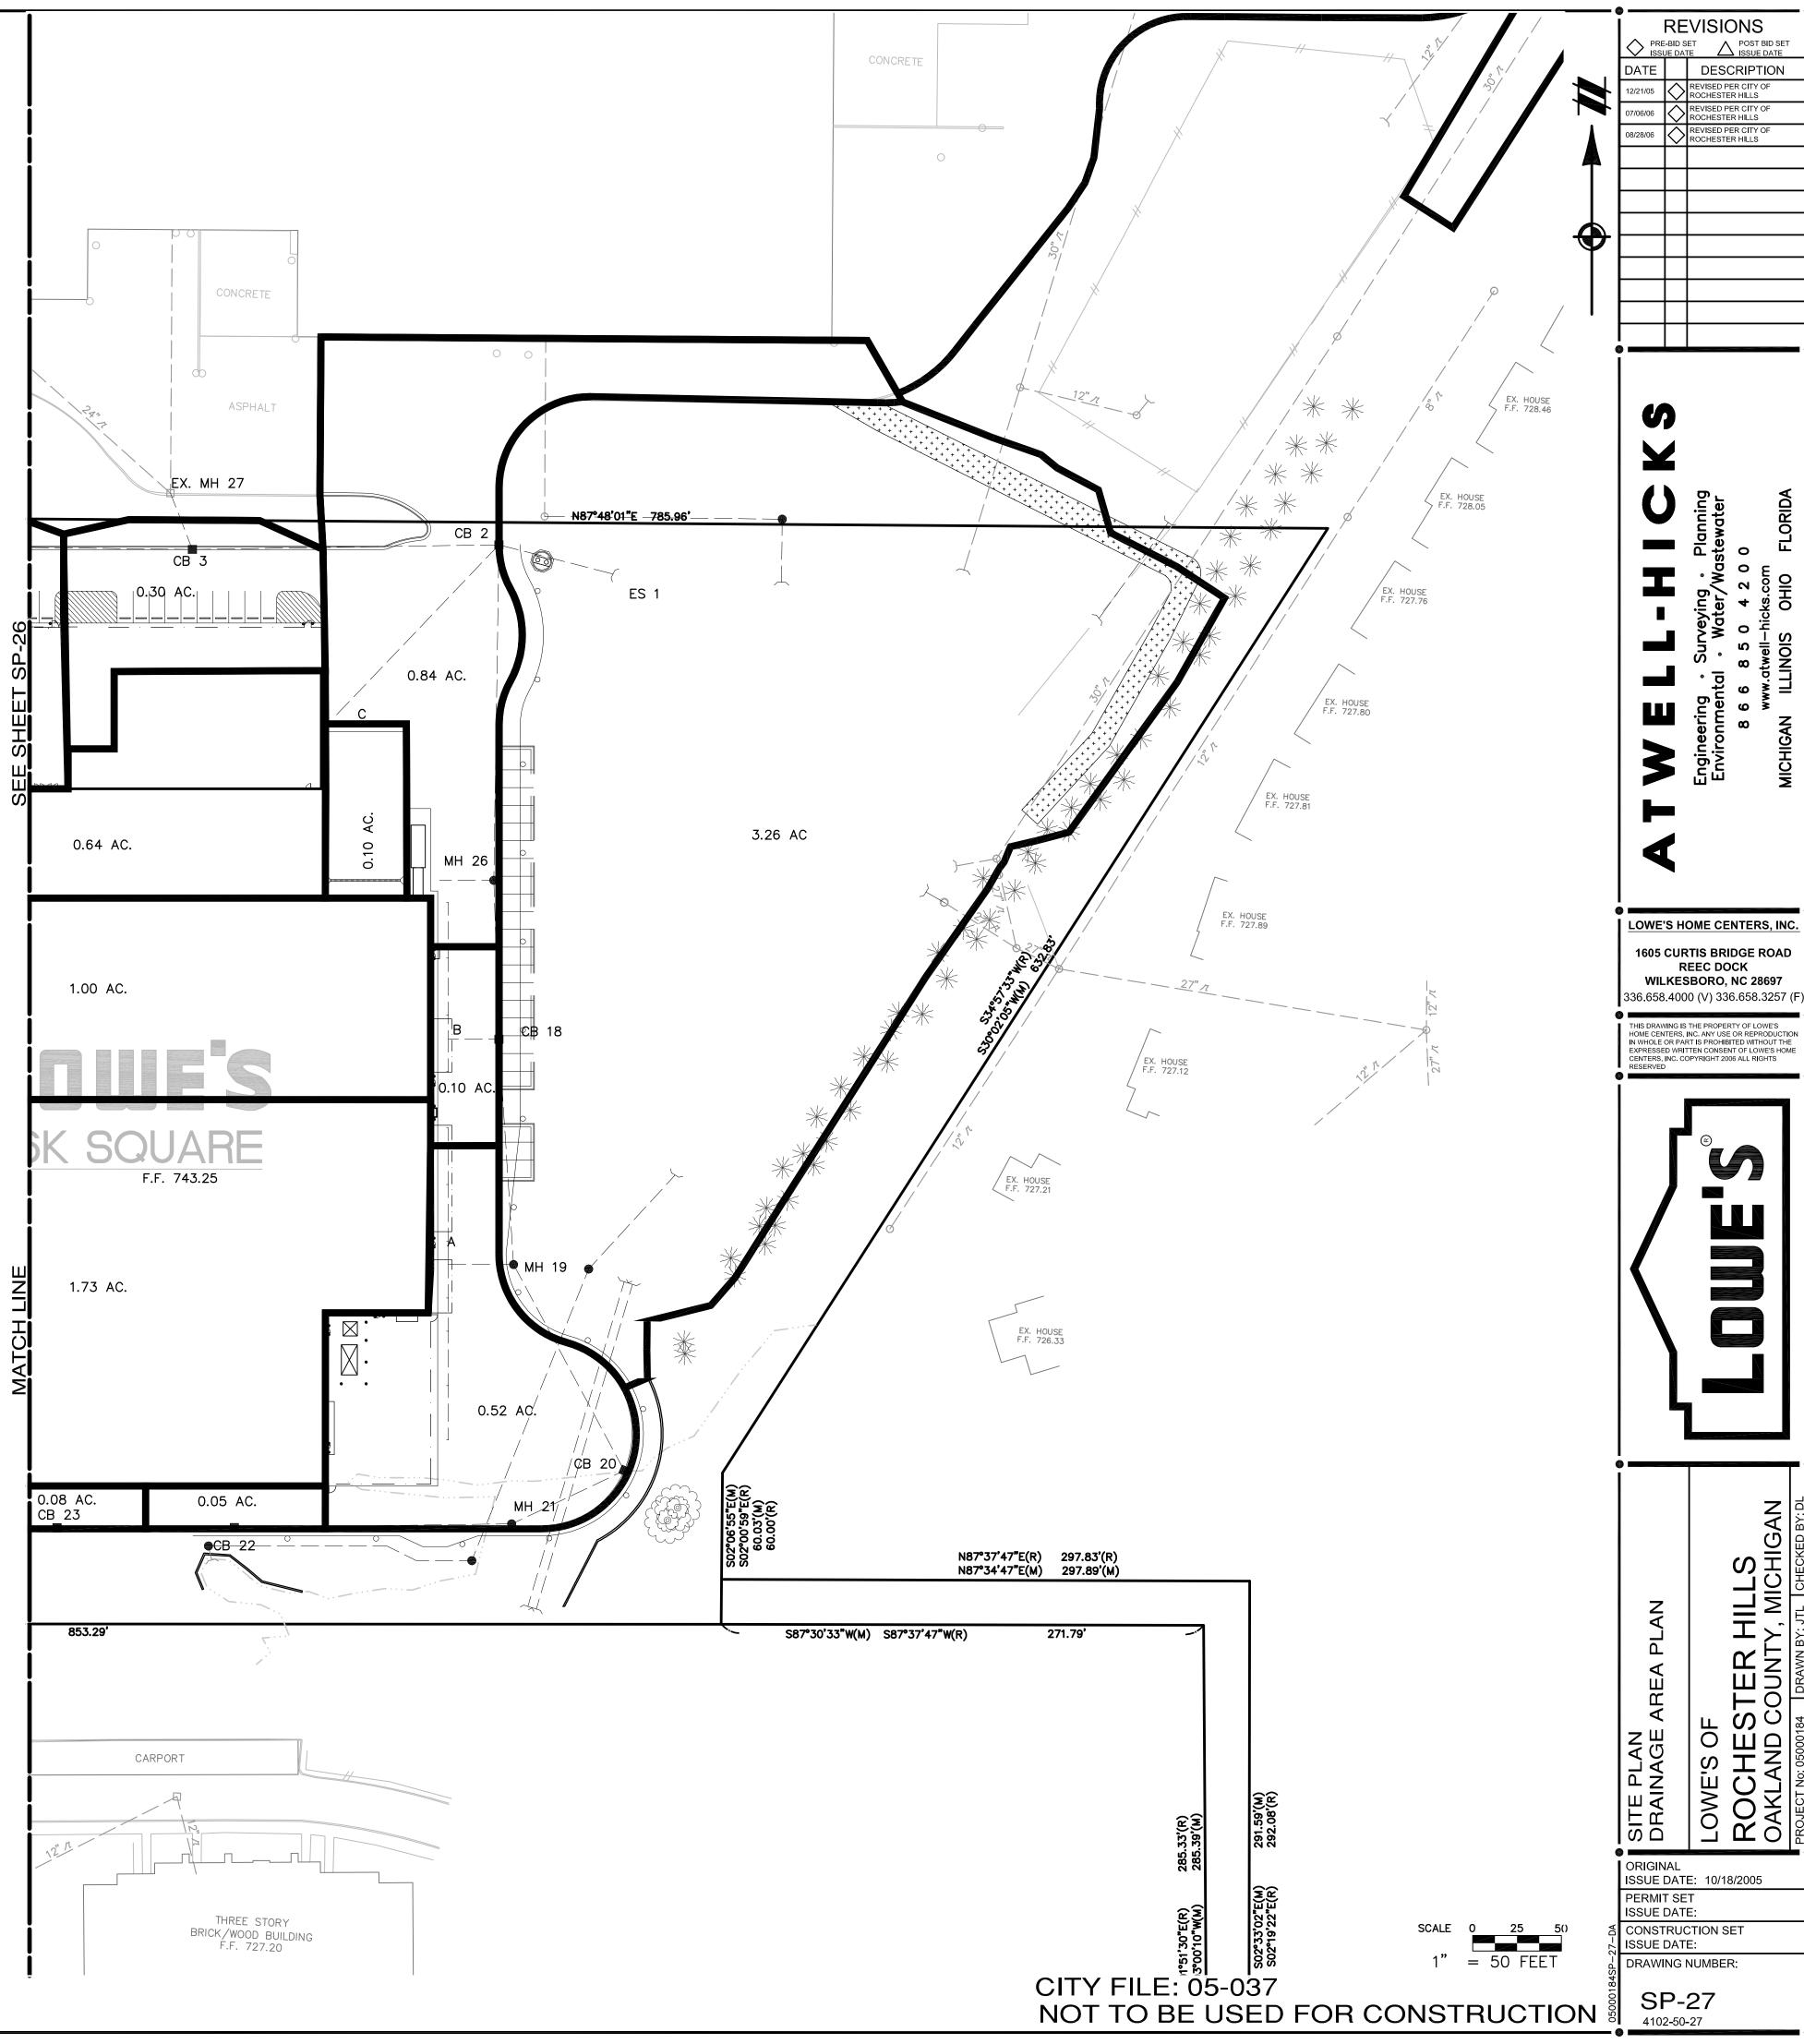
ROCHESTER HILLS TOWNSHIP STORM STANDARDS FOR RIM TYPES.




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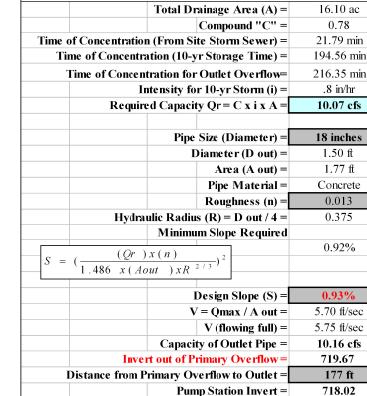


			OAK	LAND COUN	TY STANDARD	S			
				ATWELL-HI	CKS, INC.				
				50182 Scho					
				Shelby Townsh					
		Phone: 586.	786.9800	511010 10 1111011	p, 111 100 10	Fax 586.	786.5588		
Pro	iect Name:	Lowe's of Roche	ster Hills						
110,	Client:		3001 111113						
		Rochester Hills							
Io	b Number:	5000184			Prepared by:		DL		
30	Date:	March 7, 2006			r repared by:		DL		
	Date:	Waten 7, 2000							
		Contributing Area	a (Acres)=	16.10			Weighte	d Runoff C	oefficie
	Ti	me of Concentrati	ion (min) =	15			(C)=	0.78	
			I		T			Vs	
1-Ye	ar Storm		72/(Tc+25)	-25+(27	00/Qo)^0.5		[(4320*T)/(T-	+25)]-40QoT	
	ar Storm		145/(Tc+25)	-25+(54	37/Qo)^0.5		[(8700*T)/(T-	+25)]-40QoT	
	ar Storm		175/(Tc+25)		(2.5/Qo)^0.5		[(10500*T)/(T	7.0	
	ear Storm ear Storm		215/(Tc+25)		62/Qo)^0.5 87/Qo)^0.5		[(12900*T)/(T		
	ear Storm ear Storm		245/(Tc+25) 275/(Tc+25)		812/Qo)^0.5		[(14700*T)/(T [(16500*T)/(T		
100 1	cui stomi		275/(10-25)	23 (100	12 (0) 0.5		[(10500 1)/(1	123)] 1000	
	Allow	able Outflow Oa = (0	Contributing 2	Acres]*0.2 cft/Acre=	3.22	cfs	1.72	*cfs per G	WE
	Qo = Qa/C(				GWE Plans 9-21-2000			as-built pl	
	Tc = Time c	of Concentration (10	- 20 Minutes	)				-	
	T = Storage			,					
				Calculation Res	ults				
			I	T			Vs		
1	Year		1.80	115.8310	min.		2,922.381	cf/acre	
5	Year		3.63	174.8463	min.		6,659.562	cf/acre	
10	Year		4.38	194.5590	min.		8,244.977	cf/acre	
25	Year		5.38	218.3537	min.		10,385.753		
50	Year		6.13	234.7786	min.		12,006.879		
100	Year		6.88	250.2251	min.		13,638.660		
		torm Water Stor	rage Requi	red: Vt = Vs*C			Restrictor		•
1-Year Sto		olume required:	<i>3</i> 1	36,923.12		Top of Sto	rage Elevation		729.
		olume required:		84,140.90			Elevation (Inv		720.
		volume required:		104,171.99			tion: Ap=(Qa/		
		volume required:		131,219.83		rinace Equa	Area Outlet=	0.11	1
		volume required:				D:			1
		-		151,702.11			pe Diameter =	4.5 /	inche
100-Year S	norm: storage	volume required:		172,319.01	cn.				

A PUMP STATION INTO EXISTING 18" PIPE FROM PAT MORAN'S DETENTION POND INTO THE EXISTING WETLANDS AS PREVIOUSLY DESIGNED. SEE UTILITY PLANS FOR

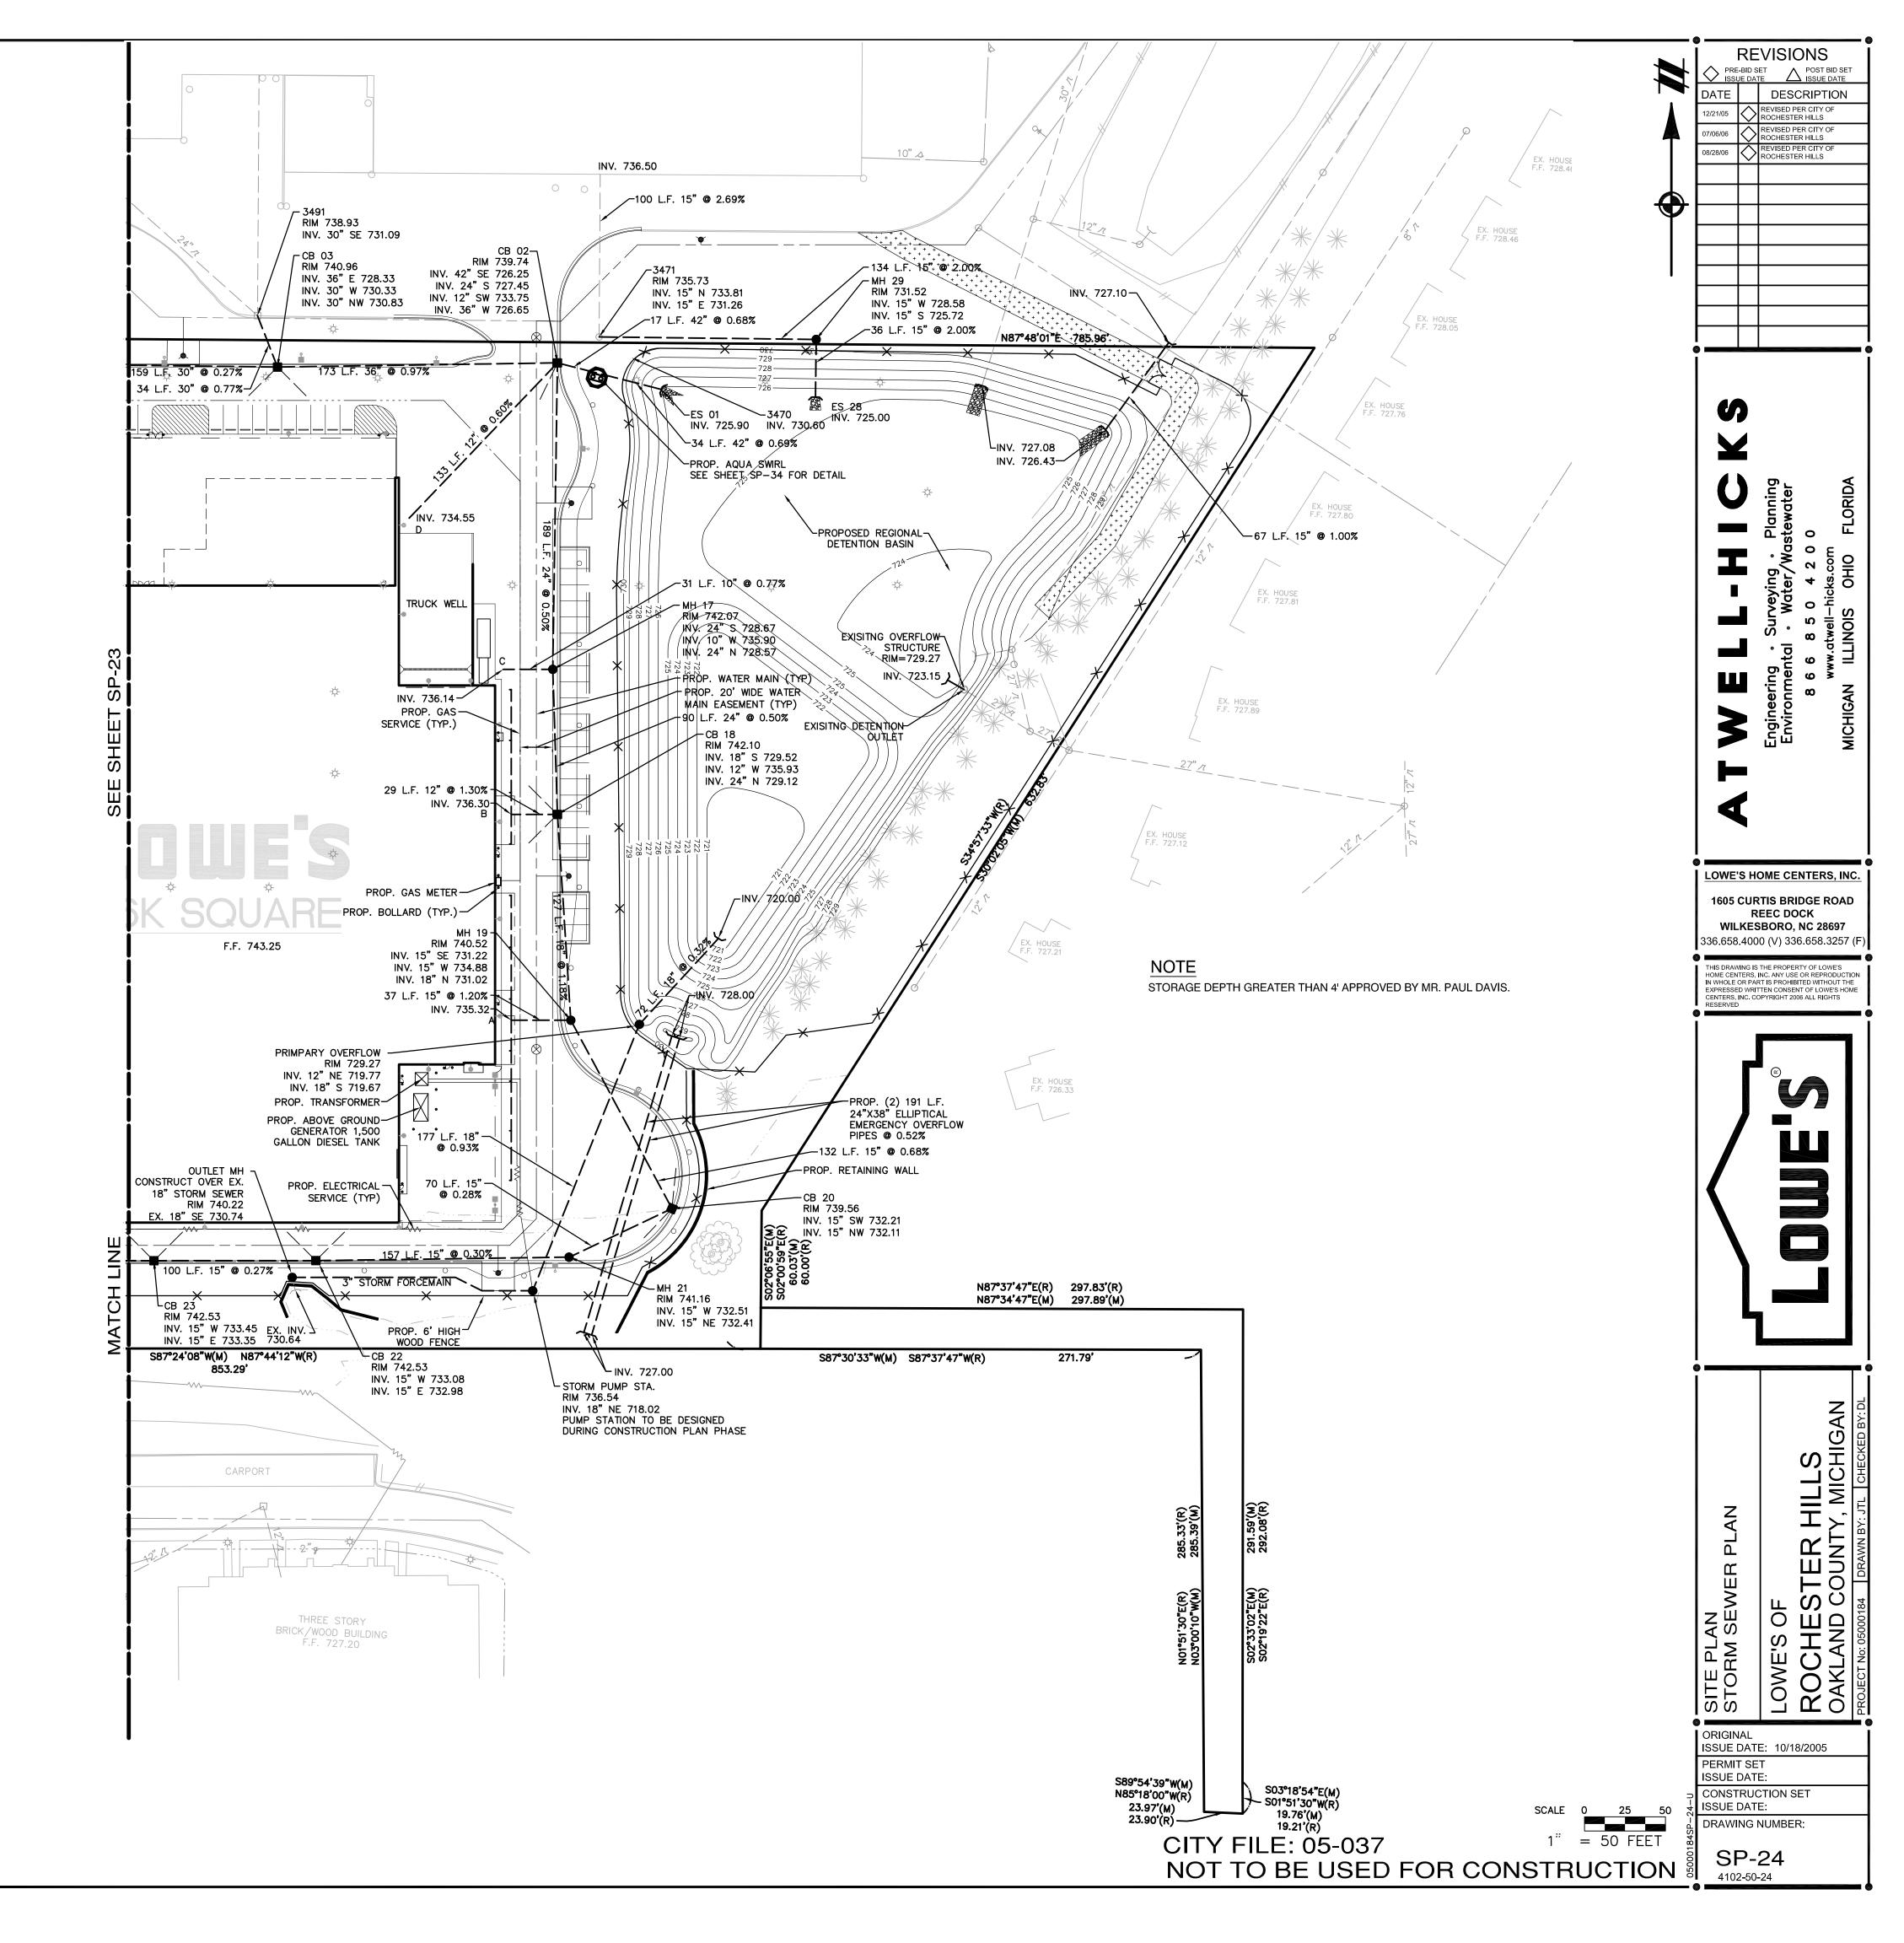RESTRICTED OUTLET CALCULATIONS Restrictor and Outlet Pipe to Overflow Restrictor to be placed in the upsteam bulkhead of the permanent outlet pipe. Allowable Outflow From Basin (Qa) = |1.720 cfs|Assumed Diameter of Outlet Pipe = 12 inches Ao =  $Qa/(.62x(2xgxH)^{1/2})$  = 0.11 sf Maximum Allowable Diameter of Restrictor = 4.57 inches Design Diameter of Restrictor = 4 1/2 inches Diameter (D out) = **Area (A out) =** 0.79 ft Pipe Material = Concrete Roughness (n) = 0.013 Hydraulic Radius (R) = D out / 4 = Minimum Slope Required (Qr)x(n)1.486  $x(Aout) xR^{2}$ **Design Slope (S) = 0.32%** V = Qmax / A out = 1.72 ft/secV (flowing full) = 2.57 ft/sec Outlet Invert = 720.00 Distance from Outlet to Primary Overflow= 72 ft Invert into Primary Overflow = Percentage of Allowable Outlet Capacity = 98.39%

Tour outlier bip	n Primary Overflow to	Fump Station
	Total Drainage Area	
	Compound	'C'' = 0.78
Time of Concentration	on (From Site Storm Se	wer) = 21.79 min
Time of Concent	ration (10-yr Storage Ti	<b>me)</b> = 194.56 mi
Time of Concer	ntration for Outlet Ove	<b>rflow=</b> 216.35 min
]	Intensity for 10-yr Stori	n (i) = .8 in/hr
Requi	red Capacity Qr = C x i	x A = 10.07 cfs
	Pipe Size (Diame	ter) = 18 inches
	Diameter (D	<b>out)</b> = 1.50 ft
	Area (A	<b>out)</b> = 1.77 ft
	Pipe Mate	erial = Concrete
	Roughness	s(n) = 0.013
Hydra	aulic Radius (R) = D ou	t/4 = 0.375
	Minimum Slope Red	quired
(Or	(x)	0.92%
$S = \left(\frac{Qr}{1.486 \times (A)}\right)$	$\frac{\sqrt{out}(xR^{-2/3})^2}{\sqrt{2}}$	
	Design Slope	
	V = Qmax / A	out = 5.70 ft/sec
	V (flowing	<b>full)</b> = 5.75 ft/sec
	Capacity of Outlet	Pipe = 10.16 cfs
	ert out of Primary Over	
Distance from	Primary Overflow to Oi	ıtlet = 177 ft
Distance from	Pump Station In	

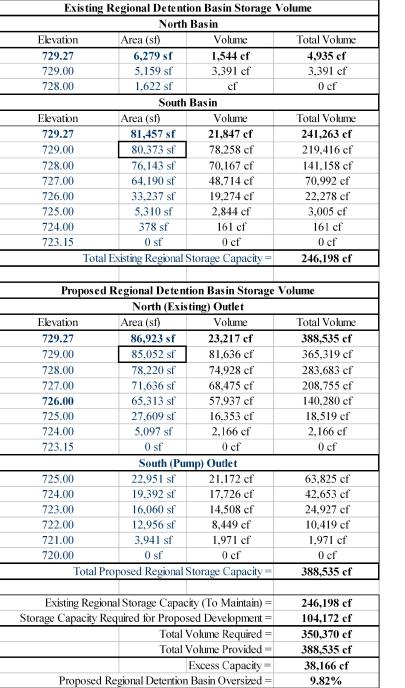

		Pun	np Station Invert =	/18.02
rgen	cy Overflow Ou	tlet		
		Require	ed Capacity (Qr) =	48.15 cfs
		As	sume Dual Pipe =	<b>24.07</b> cfs (per pipe)
		A	ssume Pipe Size =	30 inches
		Elli	otical Equivalent =	24" x 38"
		I	Diameter (D out) =	2.50 ft
			Area (A out) =	4.91 ft
			Pipe Material =	Concrete
			Roughness (n) =	0.013
	Hydra	ulic Radiu	s(R) = D out / 4 =	0.625
			pe Required (S) =	
				0.34%
	$S = \left(\frac{1}{1 + 10c}\right)$	(Qr)x(.	$\frac{n}{(xR^{-2/3})^2}$	
	1.486	x ( Aout	) xR	
		1	Design Slope (S) =	0.52%
			' = Qmax / A out =	4.90 ft/sec
		•	V (flowing full) =	6.05 ft/sec
			· (nowing run)	0.03 10300


Distance from Outlet to Primary Overflow=




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EMERGENCY OVERFLOW N.T.S.

> **CITY FILE: 05-037** NOT TO BE USED FOR CONSTRUCTION

STIE PLAN STORM SEWER CALCULATIONS	LOWE'S OF	ROCHESTER HILLS	OAKLAND COUNTY, MICHIGAN	
STOF	LOW	ROG	OAKI	

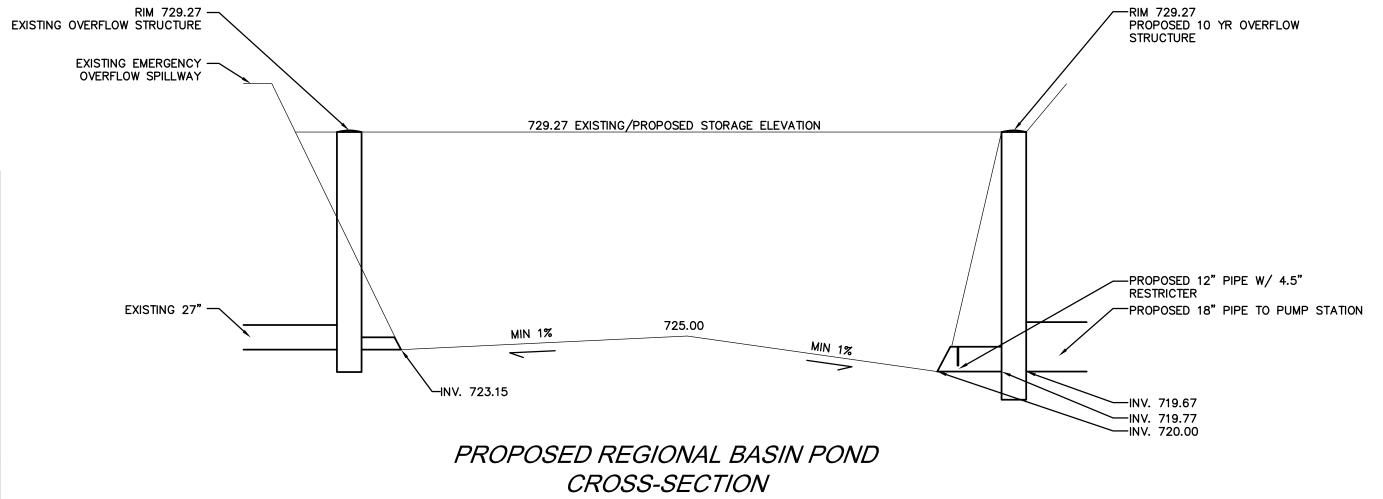ISSUE DATE: 10/18/2005

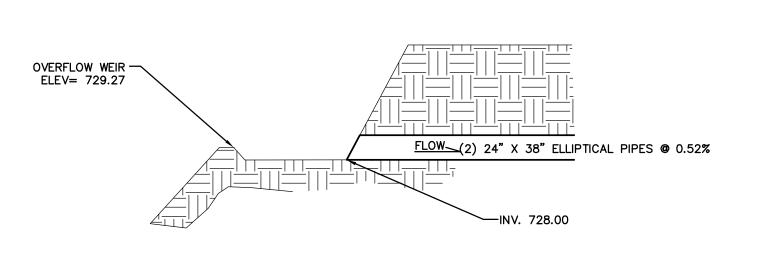CONSTRUCTION SET

DRAWING NUMBER:

4102-50-28

PERMIT SET ISSUE DATE:

ISSUE DATE:

LOWE'S HOME CENTERS, INC.

1605 CURTIS BRIDGE ROAD REEC DOCK WILKESBORO, NC 28697 336.658.4000 (V) 336.658.3257 (F

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REVISIONS

DATE DESCRIPTION

12/21/05 REVISED PER CITY OF ROCHESTER HILLS

07/06/06 REVISED PER CITY OF ROCHESTER HILLS 08/28/06 REVISED PER CITY OF ROCHESTER HILLS

- 2. SIZES SPECIFIED IN THE PLANT LIST ARE MINIMUM SIZES TO WHICH THE PLANTS ARE TO BE INSTALLED.
- 3. ALL LANDSCAPING SHALL BE INSTALLED AND MAINTAINED IN ACCORDANCE WITH THE CITY OF ROCHESTER HILLS STANDARDS AND IN ACCORDANCE WITH CURRENT INDUSTRY STANDARDS IN A NEAT, HEALTHY AND WEED FREE CONDITION.
- 4. THE LANDSCAPE CONTRACTOR SHALL BE RESPONSIBLE FOR VERIFICATION OF ALL UNDERGROUND AND OVERHEAD UTILITIES. PLANT MATERIAL IS TO BE LOCATED SUCH THAT IT WILL NOT INTERFERE WITH
- ANY UNDERGROUND OR OVERHEAD UTILITIES. 5. PRIOR TO ANY LAND CLEARING OR CONSTRUCTION, TREE PROTECTION FENCING IS TO BE INSTALLED BY THE CONTRACTOR. THIS FENCING SHALL BE INSTALLED AT THE DRIP LINE OF ALL TREES AND SHRUBS
- AND MUST BE MAINTAINED AS APPROVED FOR THE DURATION OF THE PROJECT. NO CUTTING, FILLING OR TRESPASSING SHALL OCCUR INSIDE THE FENCED AREAS. 6. DIG SHRUB PITS 1' LARGER THAN SHRUB ROOT BALLS AND TREE PITS 2' LARGER THAN ROOT BALLS. BACKFILL WITH ONE PART TOP SOIL AND ONE PART SOIL FROM THE EXCAVATED PLANTING HOLE, AND A FERTILIZER MIX. PLANT TREES AND SHRUBS AT THE SAME GRADE LEVEL AT WHICH THEY WERE PLANTED AT THE NURSERY. IF WET, CLAY SOILS ARE EVIDENT, PLANT TREES AND SHRUBS HIGHER.
- 7. REMOVE ALL TWINE, WIRE AND BURLAP FROM THE TOP 1/3 OF TREE AND SHRUB EARTH BALLS AND FROM TREE TRUNKS. 8. LAWN TREES ARE TO BE MULCHED WITH A MINIMUM OF 4' WIDE BY 6" DEEP NATURAL-COLORED SHREDDED HARDWOOD BARK MULCH RINGS.
- 9. SHRUB BEDS ARE TO BE MULCHED WITH SHREDDED BARK MULCH TO A MINIMUM DEPTH OF 3".
- 10. SHRUB BED EDGING SHALL BE 1/8" X 4" INTERLOCKING ALUMINUM EDGE, STAKED WITH METAL STAKES SUFFICIENTLY TO HOLD IN PLACE.
- 11. BACKFILL DIRECTLY BEHIND ALL CURBS AND ALONG SIDEWALKS AND COMPACT TO THE TOP OF CURB OR WALK TO SUPPORT VEHICLE AND PEDESTRIAN WEIGHT WITHOUT SETTLING.
- 12. ALL LANDSCAPE AREAS, ESPECIALLY PARKING LOT ISLANDS AND LANDSCAPE BEDS NEXT TO BUILDINGS SHALL BE EXCAVATED OF ALL BUILDING MATERIALS AND POOR SOILS TO A DEPTH OF 12-18" AND BACKFILLED WITH GOOD, MEDIUM TEXTURED PLANTING SOIL (LOAM OR LIGHT YELLOW CLAY). ADD 4-6" OF TOPSOIL OVER FILL MATERIAL AND CROWN A MINIMUM OF 6" ABOVE TOP OF CURBS AND/OR WALKS AFTER EARTH SETTLING UNLESS OTHERWISE NOTED ON THE LANDSCAPE PLAN
- 13. ALL DISTURBED UNPAVED AREAS ARE TO BE SODDED OR SEEDED OVER A MINIMUM OF 4-INCH DEPTH OF TOPSOIL. REFER TO PLAN FOR LOCATIONS.

SITE PLANT SCHEDULE

- 14. CONTRACTOR SHALL BE RESPONSIBLE TO REGRADE, HYDRO-SEED, STRAW, MULCH, AND TACK ALL LAWN AREAS DISTURBED AS THE RESULT OF HIS WORK.
- 15. ANY GROUND MOUNTED MECHANICAL EQUIPMENT SHALL BE SCREENED ON THREE SIDES WITH LIVING PLANT MATERIAL. 16. LANDSCAPE BERMS ARE TO BE CONSTRUCTED OF LIGHT YELLOW CLAY OR LOAM SOILS AND ARE TO BE FREE OF CONSTRUCTION MATERIALS AND DEBRIS. USE OF HEAVY CLAYS FOR BERM CONSTRUCTION
- MUST BE APPROVED BY THE LANDSCAPE ARCHITECT PRIOR TO INSTALLATION. SLOPES ARE TO BE NO STEEPER THAN 1:3 UNLESS OTHERWISE SPECIFIED ON THE GRADING PLAN.
- 17. EXISTING LAWN FOUND TO BE GENERALLY IN GOOD CONDITION BUT WITH BARE, SPARSE OR WEEDY AREAS MUST BE RENOVATED BY FILLING IN LOW AREAS, RAKING, OVERSEEDING AND TOP DRESSING ALL SPARSE AND BARE SPOTS AND BY INITIATING A WEED AND FEED PROGRAM.
- 18. ALL LANDSCAPE AREAS SHALL BE IRRIGATED BY AN AUTOMATIC UNDERGROUND IRRIGATION SYSTEM. LAWNS AND SHRUB/LANDSCAPE AREAS SHALL BE WATERED BY SEPARATE ZONES TO MINIMIZE OVERWATERING.
- 19. SEE SHEET SP-31 FOR PLANTING DETAILS.
- 20. ALL LANDSCAPING MUST BE WARRANTED BY THE DEVELOPER FOR A PERIOD OF TWO YEARS FROM THE DATE OF APPROVAL BY THE CITY OF ROCHESTER HILLS LANDSCAPE ARCHITECT.
- 21. ALL DEAD ASH TREES AFFECTED BY THE EMERALD ASH BORER AS WELL AS VIABLE ASH TREES THAT CERTAINLY WILL BE AFFECTED BY THE EMERALD ASH BORER, AND THAT ARE WITHIN ALL NATURAL
- FEATURES SETBACK AREAS MUST BE CUT DOWN FLUSH TO GRADE (NO STUMP REMOVAL). DISPOSAL PER CITY REQUIREMENTS. 22. ANY TEMPORARY IMPACTED NATURAL FEATURE SETBACK AREAS MUST BE RESTORED TO ORIGINAL GRADE WITH ORIGINAL SOILS OR EQUIVALENT SOILS & SEEDED WITH CITY APPROVED SEED MIX WHERE POSSIBLE.

	PROPERTY LINE EXIST. STORM SEWER PROP. STORM SEWER
O •	EXIST. MANHOLE PROP. MANHOLE PROP. EDGE DRAIN
	EXIST. CATCH BASIN/INLET PROP. CATCH BASIN/INLET END SECTION/HEAD WALL
) – – – (	CULVERT  EXIST. SANITARY SEWER  PROP. SANITARY SEWER
∘ C.O. • C.O.	EXIST. CLEAN OUT PROP. CLEAN OUT EXIST. WATER MAIN
	PROP. WATER MAIN EXIST. HYDRANT PROP. HYDRANT
	EXIST. GATE VALVE IN MANHOLE PROP. GATE VALVE IN MANHOLE EXIST. OVERHEAD ELECTRIC EXIST. UNDERGROUND ELECTRIC
	PROP. UNDERGROUND ELECTRIC EXIST. LIGHT POLE EXIST. UTILITY POLE
e 	GUY WRE EXIST. ELECTRIC TRANSFORMER EXIST. OVERHEAD TELEPHONE EXIST. UNDERGROUND TELEPHONE PROP. UNDERGROUND TELEPHONE
	EXIST. GAS PROP. GAS EXIST. GAS RISER EXIST. TELEPHONE RISER
	FENCE EXIST. SIGN

AREA TO BE MULCHED WITH SHREDDED HARDWOOD BARK

REPLA	ACEMEN	IT TREES (R)					TOTAL REPLACEMENT
KEY.	QTY.	BOTANICAL/COMMON NAME	SIZE		UNIT COST	TOTAL COST	CREDITS
PP	12	<i>Picea pungens 'Colorado'</i> Colorado Blue Spruce	14' Ht.		\$650.00	\$7,800.00	24
BUFFI	ER TREE	S, SHRUBS AND GROUND COVER (B)			Total Cost	\$7,800.00	24 TOTAL TREE CREDITS
KEY.	QTY.	BOTANICAL/COMMON NAME	SIZE	ROOT	UNIT COST	TOTAL COST	
AF	21	Abies fraseri Fraser Fir	14' Ht.	B&B	\$650.00	\$13,650.00	
AP	18	<i>Acer platanoides 'Columnar'</i> Columnar Norway Maple	3 1/2" Cal.	B&B	\$450.00	\$8,100.00	
ВТ	51	<i>Berberis thunbergi 'Rose Glow'</i> Rose Glow Barberry	24" Ht.	B&B	\$40.00	\$2,040.00	
СВ	9	<i>Carpinus betulus 'Fastigiata'</i> European Hornbeam	3 1/2 " Cal.	B&B	\$450.00	\$4,050.00	
EA	31	Euonymus alatus 'Compactus' Dwarf Burning Bush	30 " Ht.	B&B	\$50.00	\$1,550.00	
GT	27	Gleditsia triacanthos inermis 'Skyline' Thornless Honeylocust	3 1/2" Cal.	B&B	\$450.00	\$12,150.00	
HR	89	<i>Hosta 'Royal Standard'</i> Royal Standard Hosta	3 Gal.	Cont.	\$15.00	\$1,335.00	
HS	64	<i>Hemerocallis 'Stella D'oro'</i> Stella D'oro Daylily	3 Gal.	Cont.	\$15.00	\$960.00	
JC	60	<i>Juniperus chinensis 'Sea Green'</i> Sea Green Juniper	36" Ht.	Cont.	\$40.00	\$2,400.00	
JS	56	<i>Juniperus sabina 'Broadmoor'</i> Broadmoor Juniper	24 " Ht.	Cont.	\$40.00	\$2,240.00	
РО	42	<i>Picea omorika</i> Serbian Spruce	14' Ht.	B&B	\$650.00	\$27,300.00	
PP	16	Picea pungens "Colorado" Colorado Blue Spruce	14' Ht.	B&B	\$650.00	\$10,400.00	
SP	34	<i>Syringa patula 'Miss Kim'</i> Miss Kim Lilac	30" Ht.	B&B	\$50.00	\$1,700.00	
TA	60	<i>Tilia cordata 'Greenspire'</i> Greenspire Linden	3 1/2" Cal.	B&B	\$450.00	\$27,000.00	
TM	150	<i>Taxus x media 'Densiformis'</i> Dense Yew	30" Ht.	B&B	\$75.00	\$11,250.00	
VC	63	<i>Viburnum carlesi</i> Koreanspice Viburnum	36 " Ht.	B&B	\$65.00	\$4,095.00	
		·			Total Cost	\$130,220.00	
PARK	ING LOT	ISLAND TREES (I)					
KEY.	QTY.	BOTANICAL/COMMON NAME	SIZE	ROOT	UNIT COST	TOTAL COST	
GT	41	Gleditsia triacanthos inermis 'Skyline' Thornless Honeylocust	3" Cal.	B&B	\$425.00	\$17,425.00	
. <del></del>	-10	·			Total Cost	\$17,425.00	
	FIONAL I	LANDSCAPING					
QTY.	) CV	ITEM CLASSIALSOD			UNIT COST	TOTAL COST	
12,880 108 C		CLASS 'A' SOD SHREDDED BARK MULCH			\$4.00 SY \$44.00 CY	\$51,520.00 \$4,752.00	
					·	•	
610 LF		RYERSON STEEL EDGING			\$7.00 LF	\$4,270.00	
15,49	101	HYDROMULCH			\$1.50 SY	\$23,236.50	



BEFORE YOU DIG CALL MISS DIG FOR THE LOCATION OF UNDERGROUND FACILITIES

THE LOCATIONS OF EXISTING UNDERGROUND UTILITIES ARE SHOWN IN AN APPROXIMATE WAY ONLY AND HAVE NOT BEEN INDEPENDENTLY VERIFIED BY THE OWNER OR ITS REPRESENTATIVE. THE CONTRACTOR SHALL DETERMINE THE EXACT LOCATION OF ALL EXISTING UTILITIES BEFORE COMMENCING WORK, AND AGREES TO BE FULLY RESPONSIBLE FOR ANY AND ALL DAMAGES WHICH MIGHT BE OCCASIONED BY THE CONTRACTOR'S FAILURE TO EXACTLY LOCATE AND PRESERVE ANY AND ALL UNDERGROUND

UTILITIES.

CONSTRUCTION SITE SAFETY IS THE SOLE RESPONSIBILITY OF THE CONTRACTOR; NEITHER THE OWNER NOR THE ENGINEER SHALL BE EXPECTED TO ASSUME ANY RESPONSIBILITY FOR SAFETY OF THE WORK, OF PERSONS ENGAGED IN THE WORK, OF ANY NEARBY STRUCTURES, OR OF ANY OTHER PERSONS.

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# GRAND TOTAL OF ALL LANDSCAPING COSTS

LAWN SEED MIX

REPLACEMENT TREES	\$7,800.00
BUFFER TREES, SHRUBS	
AND GROUND COVER	\$130,220.00
PARKING LOT ISLAND TREES	\$17,425.00
ADDITIONAL LANDSCAPING	\$101,166.50
Grand Total	\$256,611.50

# SITE LANDSCAPE REQUIREMENTS

# PARKING LOT LANDSCAPING

\$1.50 SY

Total Cost

LANDSCAPE ISLANDS SHALL BE PROVIDED AT A RATIO OF AT LEAST 150 SQUARE FEET OF ISLAND FOR EVERY TEN PARKING SPACES.


\$17,388.00 \$101,166.50

588 PARKING SPACES PROVIDED. 588/10 = 59 59 X 150 = 8,850 S.F. REQUIRED 8,850 S.F. / 300 S.F. = 30 ISLAND TREES REQUIRED

> LANDSCAPE ISLAND AREA REQUIRED: 8,850 SF LANDSCAPE ISLAND AREA PROVIDED: 8,901.65 SF

ONE TREE IS REQUIRED PER PARKING ISLAND.

PARKING ISLAND TREES REQUIRED: 30 PARKING ISLAND TREES PROVIDED: 41

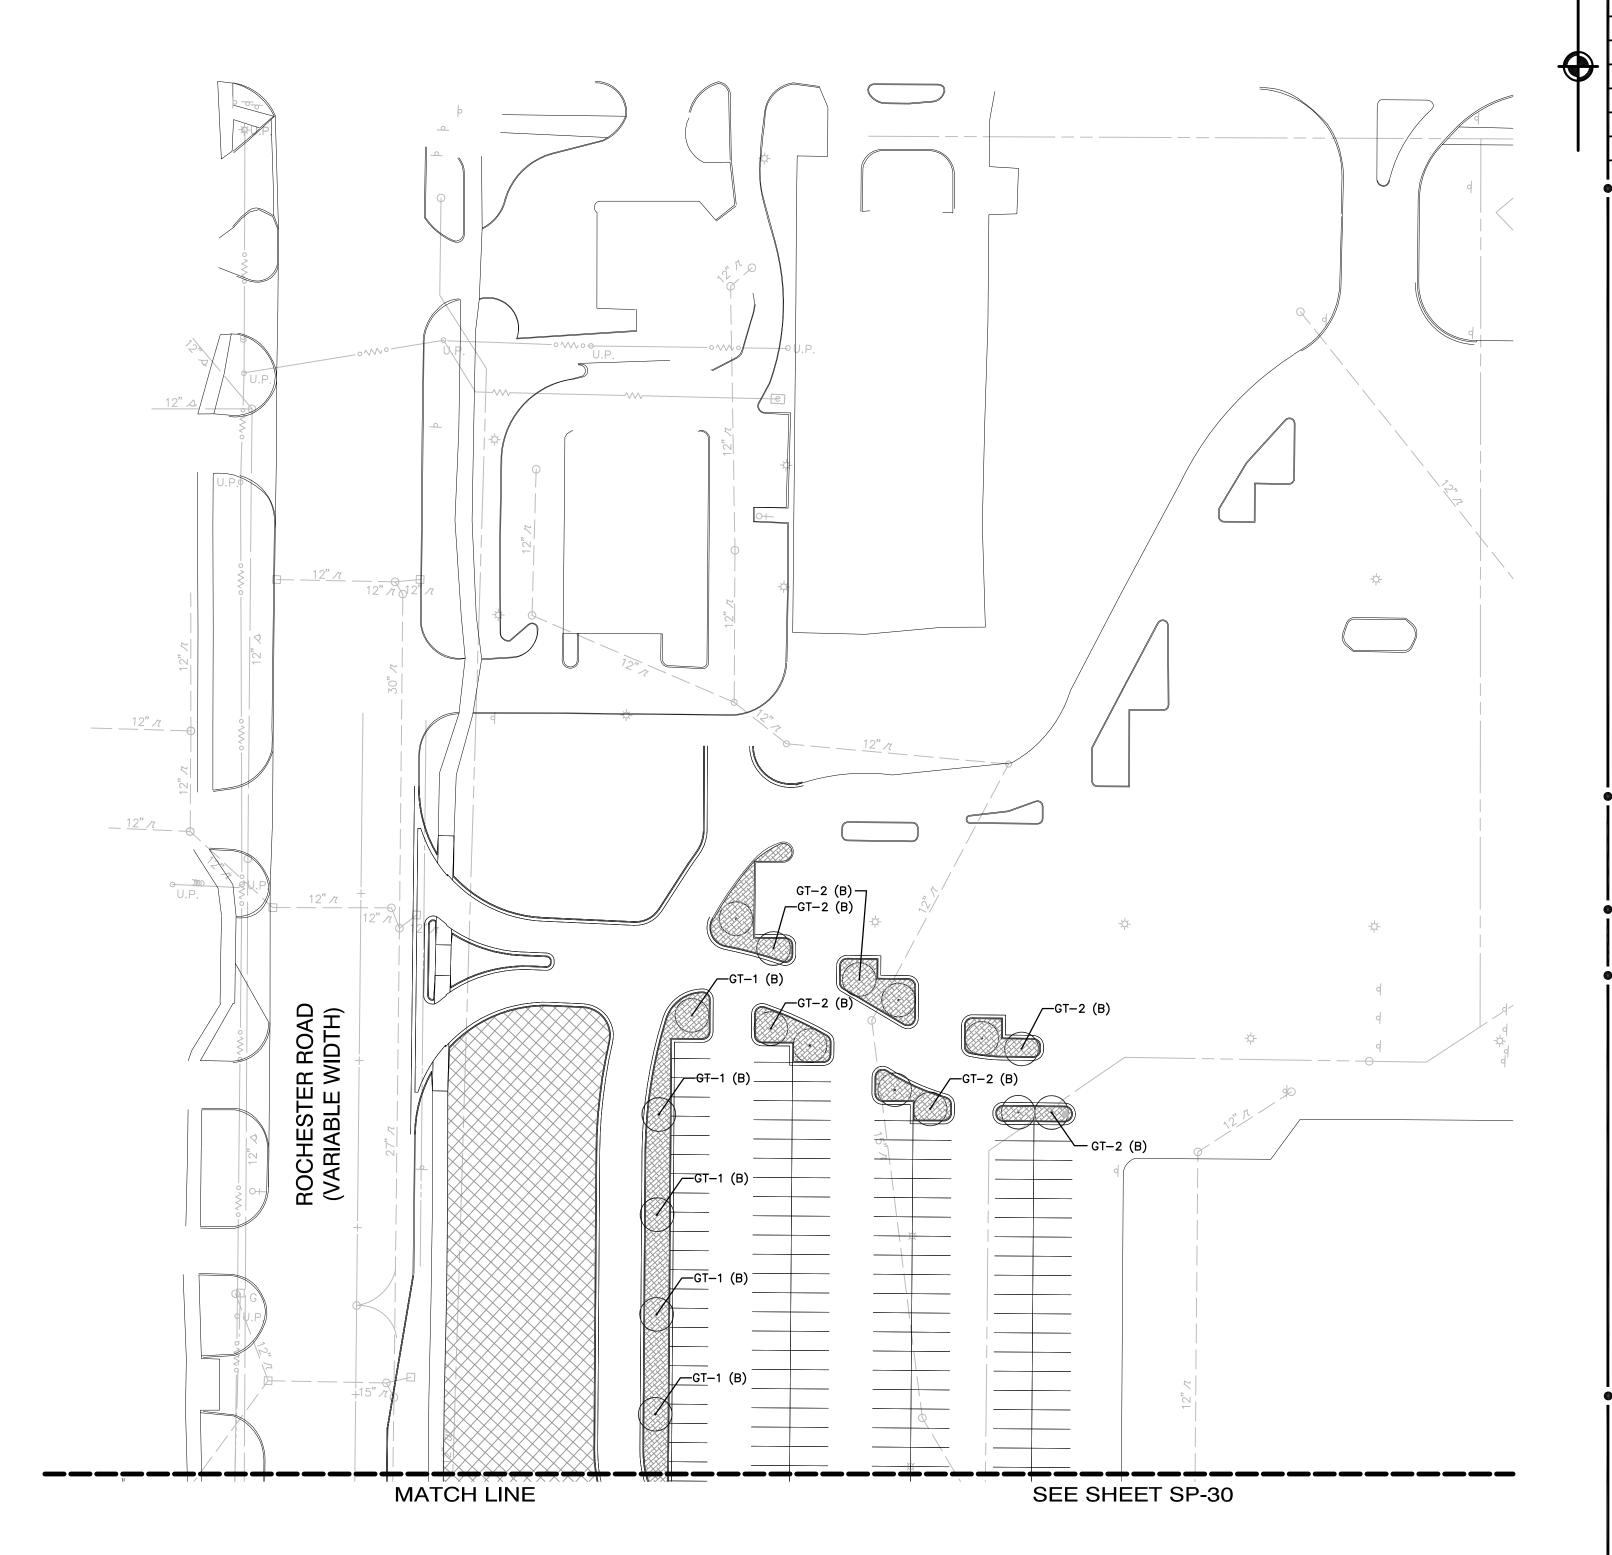

1" = 50 FEETNOT TO BE USED FOR CONSTRUCTION

CITY FILE: 05-037

ISSUE DATE:

REVISIONS

DATE DESCRIPTION


REVISED PER CITY OF ROCHESTER HILLS

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ISSUE DATE: 10/18/2005

PERMIT SET ISSUE DATE: CONSTRUCTION SET DRAWING NUMBER:

SP-29 4102-50-29

PROVED BY CITY OF ROCHESTER HILLS PLANNING COMMISION/05000184SP-30-LS.dwg, 9/6/2006 2:36.40 P

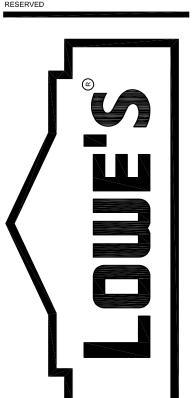
# CITY OF ROCHESTER HILLS LANDSCAPE NOTES


### Landscape Notes

- Prior to the release of the Performance Bond, the City of Rochester Hills Landscape Architect must inspect all landscape plantings including but not limited to existing trees, replacement trees, buffer plantings, and parking lot islands. The right-of-way will be inspected by the Forestry Division to identify any plantings new or existing that pose a hazard to the safe use of the right-of-way. Forestry may require the developer to remove and possibly replace any such trees.
- All trees and shrubs must be planted at least 10' from the edge of a public roadway. Shade trees and shrubs must be planted at least 5' from the edge of a public walkway. Evergreen and ornamental trees must be planted at least 10' from the edge of a public walkway. All trees and shrubs must be planted at least 10' from any fire hydrant. Shade and evergreen trees must be planted at least 15' from the nearest overhead wire and at least 10' from the nearest underground utility.
- No tree or shrub may be planted within the triangular area formed at the intersection of any street right-a-way at a distance of 25' from their point of intersection. No tree or shrub may be planted in the triangular area formed at the intersection of any driveway with a public sidewalk at a distance along each line of 15' from their point of intersection.
- Prior approval is required to plant any tree or shrub in the public right-a-
- No substitutions or changes of location or plant types shall be made without the approval of the developer and the City of Rochester Hills Landscape Architect.
- The developer and/or the City of Rochester Hills Landscape Architect shall have the right, at any stage of the installation, to reject any work or material that does not meet the requirements of the plans or specifications.
- Replacement trees may not be planted within the drip line of existing
- No substitutions or changes of location or plant type shall be made without the approval of the developer and the City of Rochester Hills Landscape Architect.
- Trees must be at least 10' from underground utilities and 15' from overhead utilities.

# TREE PROTECTION NOTES


- 1. The tree protection fencing (TPF) shall be erected per the plans approved by the City of Rochester Hills Planning Department. The TPF must be in place and be inspected by the City of Rochester Hills' Landscape Architect prior to the start of any earthwork or construction operations. It is the developer's responsibility to contact the City Planning Department at 1-248-656-4660 to schedule a TPF inspection. The TPF shall remain in place throughout the entire construction process or until the City authorizes the removal or issues a final Certificate of Occupancy, whichever occurs first.
- 2. Upon completion of grading and the installation of the infrastructure a second inspection of the TPF and the trees designated for preservation is required by the City of Rochester Hills' Landscape Architect prior to the start of any additional construction. It is the developer's responsibility to contact the City Planning Department at 1-248-656-4660 to schedule this TPF inspection.
- 3. Upon completion of all construction and prior to the removal of the TPF the City of Rochester Hills' Landscape Architect must inspect all trees designated to be preserved. The landscape Performance Bond will not be released until this inspection is complete and all related issues are resolved. It is the developer's responsibility to contact the City Planning Department at 1-248-656-4660 to schedule this inspection.
- 4. A final inspection by the City of Rochester Hills' Landscape Architect is required at the end of the warranty and maintenance period. The landscape Maintenance Bond will not be released until this inspection is complete and all related issues are resolved. It is the developer's responsibility to contact the City Planning Department at 1-248-656-4660 to schedule this inspection.
- 5. The Tree Conservation Ordinance prohibits any construction or development activities within the drip line of and regulated trees not approved for removal, including but not limited to land clearing, grubbing, trenching, grading or filling, no person shall place any solvents, building material, construction equipment, soil deposits, or harmful materials within the drip line limit of trees designated for preservation.
- 6. Proposed grades are to match the existing elevations outside the limits of the TPF. No grading either cut or fill is permitted within the drip line of any tree designated for preservation.
- 7. During the construction process no person shall attach any device or wire/cable/cord/rope to an existing tree designated to be preserved.
- 8. All utility service requests must included notification to the installer that protected trees must be avoided. All trenching shall occur outside the TPF.
- 9. Swales shall be routed to avoid the area within the drip line of the any tree designated for preservation. Swales shall be constructed so as not to direct any additional flow into the drip line a tree designated for preservation.
- 10. If tree protection cannot be maintained for a tree throughout entire period required. The replacement of that tree will be required on and inch for inch basis prior to the issuance of the Certificate of Occupancy.
- 11. Regulated trees located off-site on adjacent properties that may be affected by construction operations must be protected as defined here in.
- 12. The TPF shall consist of 4 foot high orange snow fencing to be installed around the drip line of all tree designated to be saved. This fencing shall be supported by 6 foot metal Tbar posts 5 feet on center and driven a minimum of 24" into ground. The TPF fencing shall

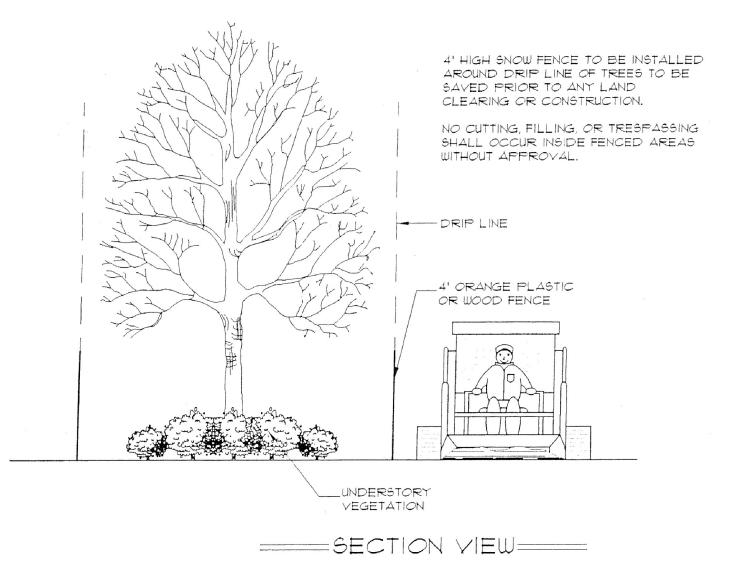

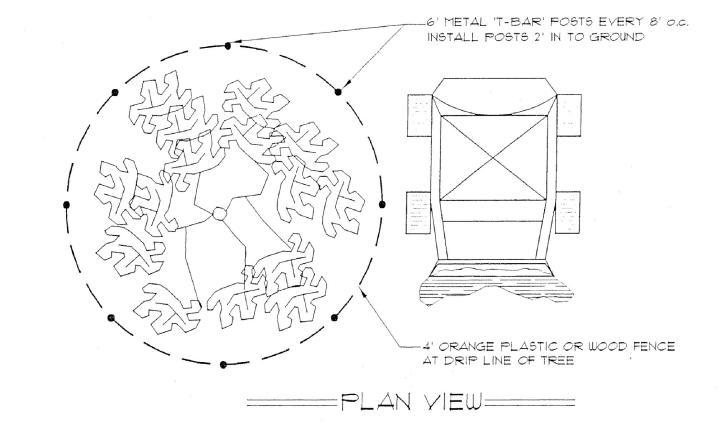


remain upright and securely in place for the required time as specified above.



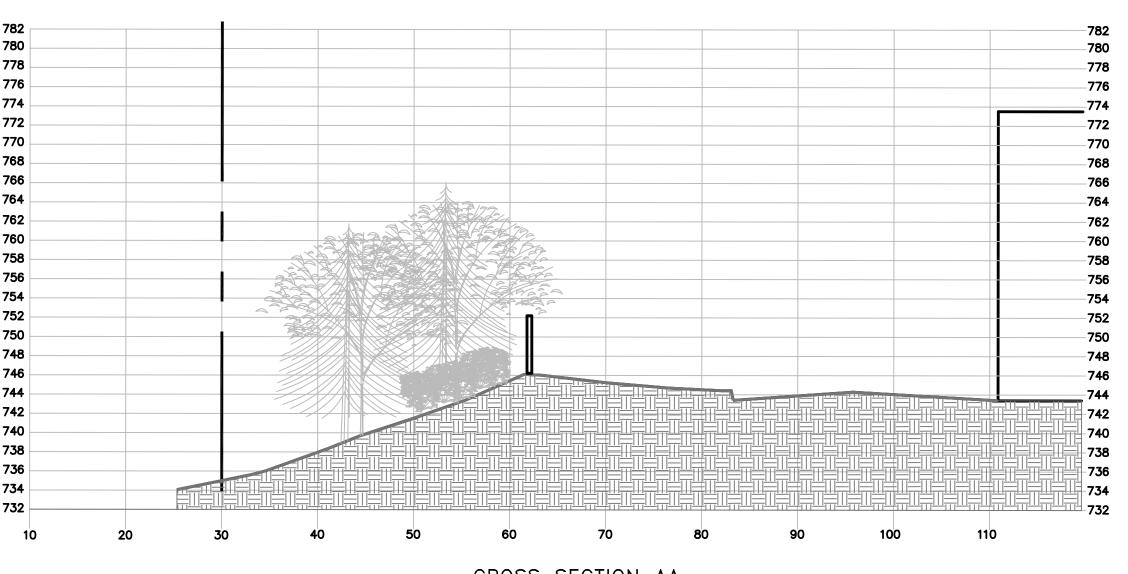


CROSS SECTION AA

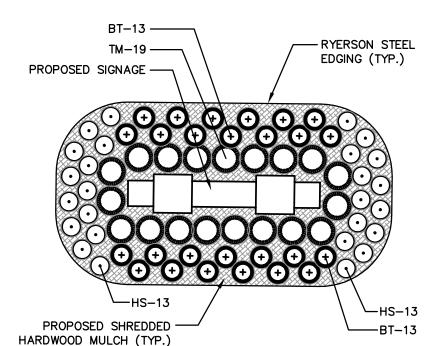


8' MAX. SPACING BETWEEN POSTS WOOD POST x 6" CEDAR 2 x4 FRAME-STOCKADE FENCE DETAIL


NOT TO SCALE

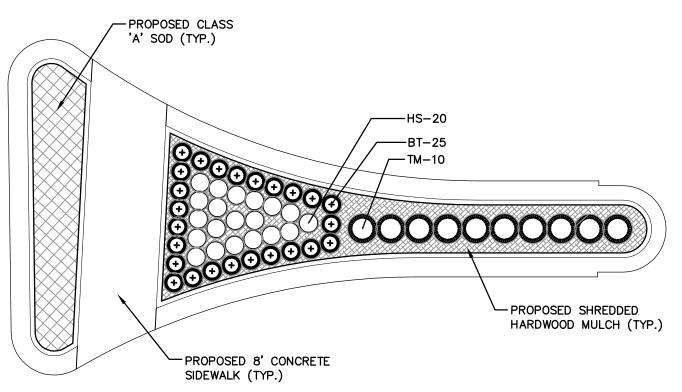

MEDIAN PLANTING DETAIL 1" = 10'

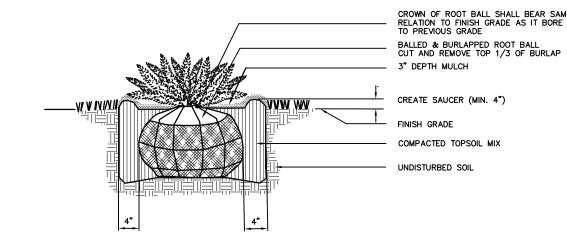


1. DO NOT ALLOW AIR POCKETS TO FORM WHEN BACKFILLING 2. WATER SHRUB THOROUGHLY SUBSEQUENT TO INSTALLATION CONIFEROUS SHRUB PLANTING DETAIL BALLED & BURLAPPED NOT TO SCALE

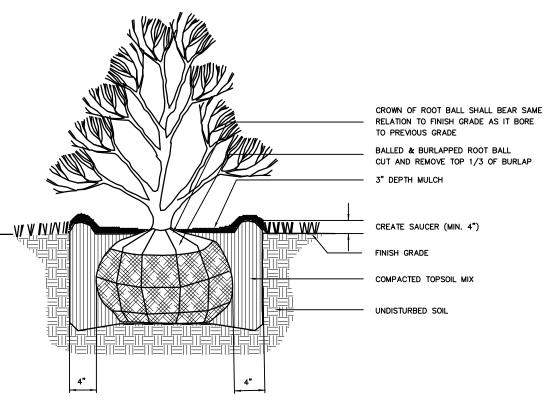


DECIDUOUS SHRUB PLANTING DETAIL BALLED AND BURLAPPED NOT TO SCALE

DO NOT ALLOW AIR POCKETS TO FORM WHEN BACKFILLING
 WATER SHRUB IMMEDIATELY AFTER INSTALLATION

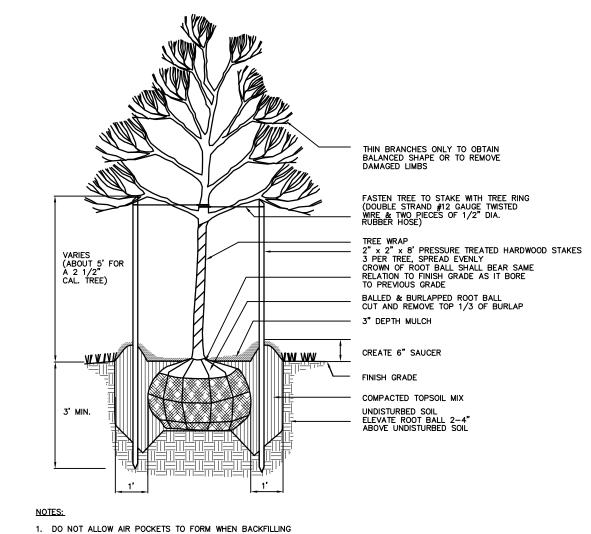

DECIDUOUS TREE PLANTING DETAIL BALLED AND BURLAPPED NOT TO SCALE

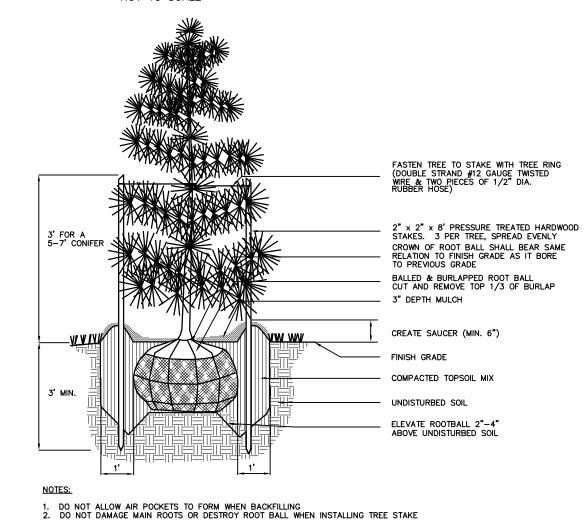


CONIFEROUS TREE PLANTING DETAIL BALLED & BURLAPPED NOT TO SCALE

**CITY FILE: 05-037** NOT TO BE USED FOR CONSTRUCTION

REVISIONS PRE-BID SET POST BID SET ISSUE DATE DATE DESCRIPTION 2/21/05 REVISED PER CITY OF ROCHESTER HILLS 07/06/06 REVISED PER CITY OF ROCHESTER HILLS 08/28/06 REVISED PER CITY OF ROCHESTER HILLS

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ORIGINAL ISSUE DATE: 10/18/2005 PERMIT SET ISSUE DATE: CONSTRUCTION SET ISSUE DATE: DRAWING NUMBER:

4102-50-32

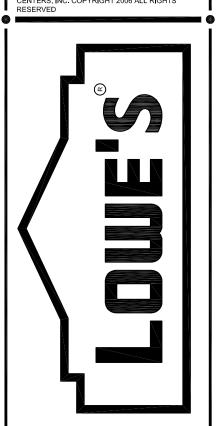
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OCCASIONED BY THE CONTRACTOR'S FAILURE TO EXACTLY LOCATE AND PRESERVE ANY AND ALL UNDERGROUND


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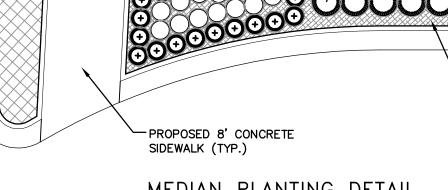
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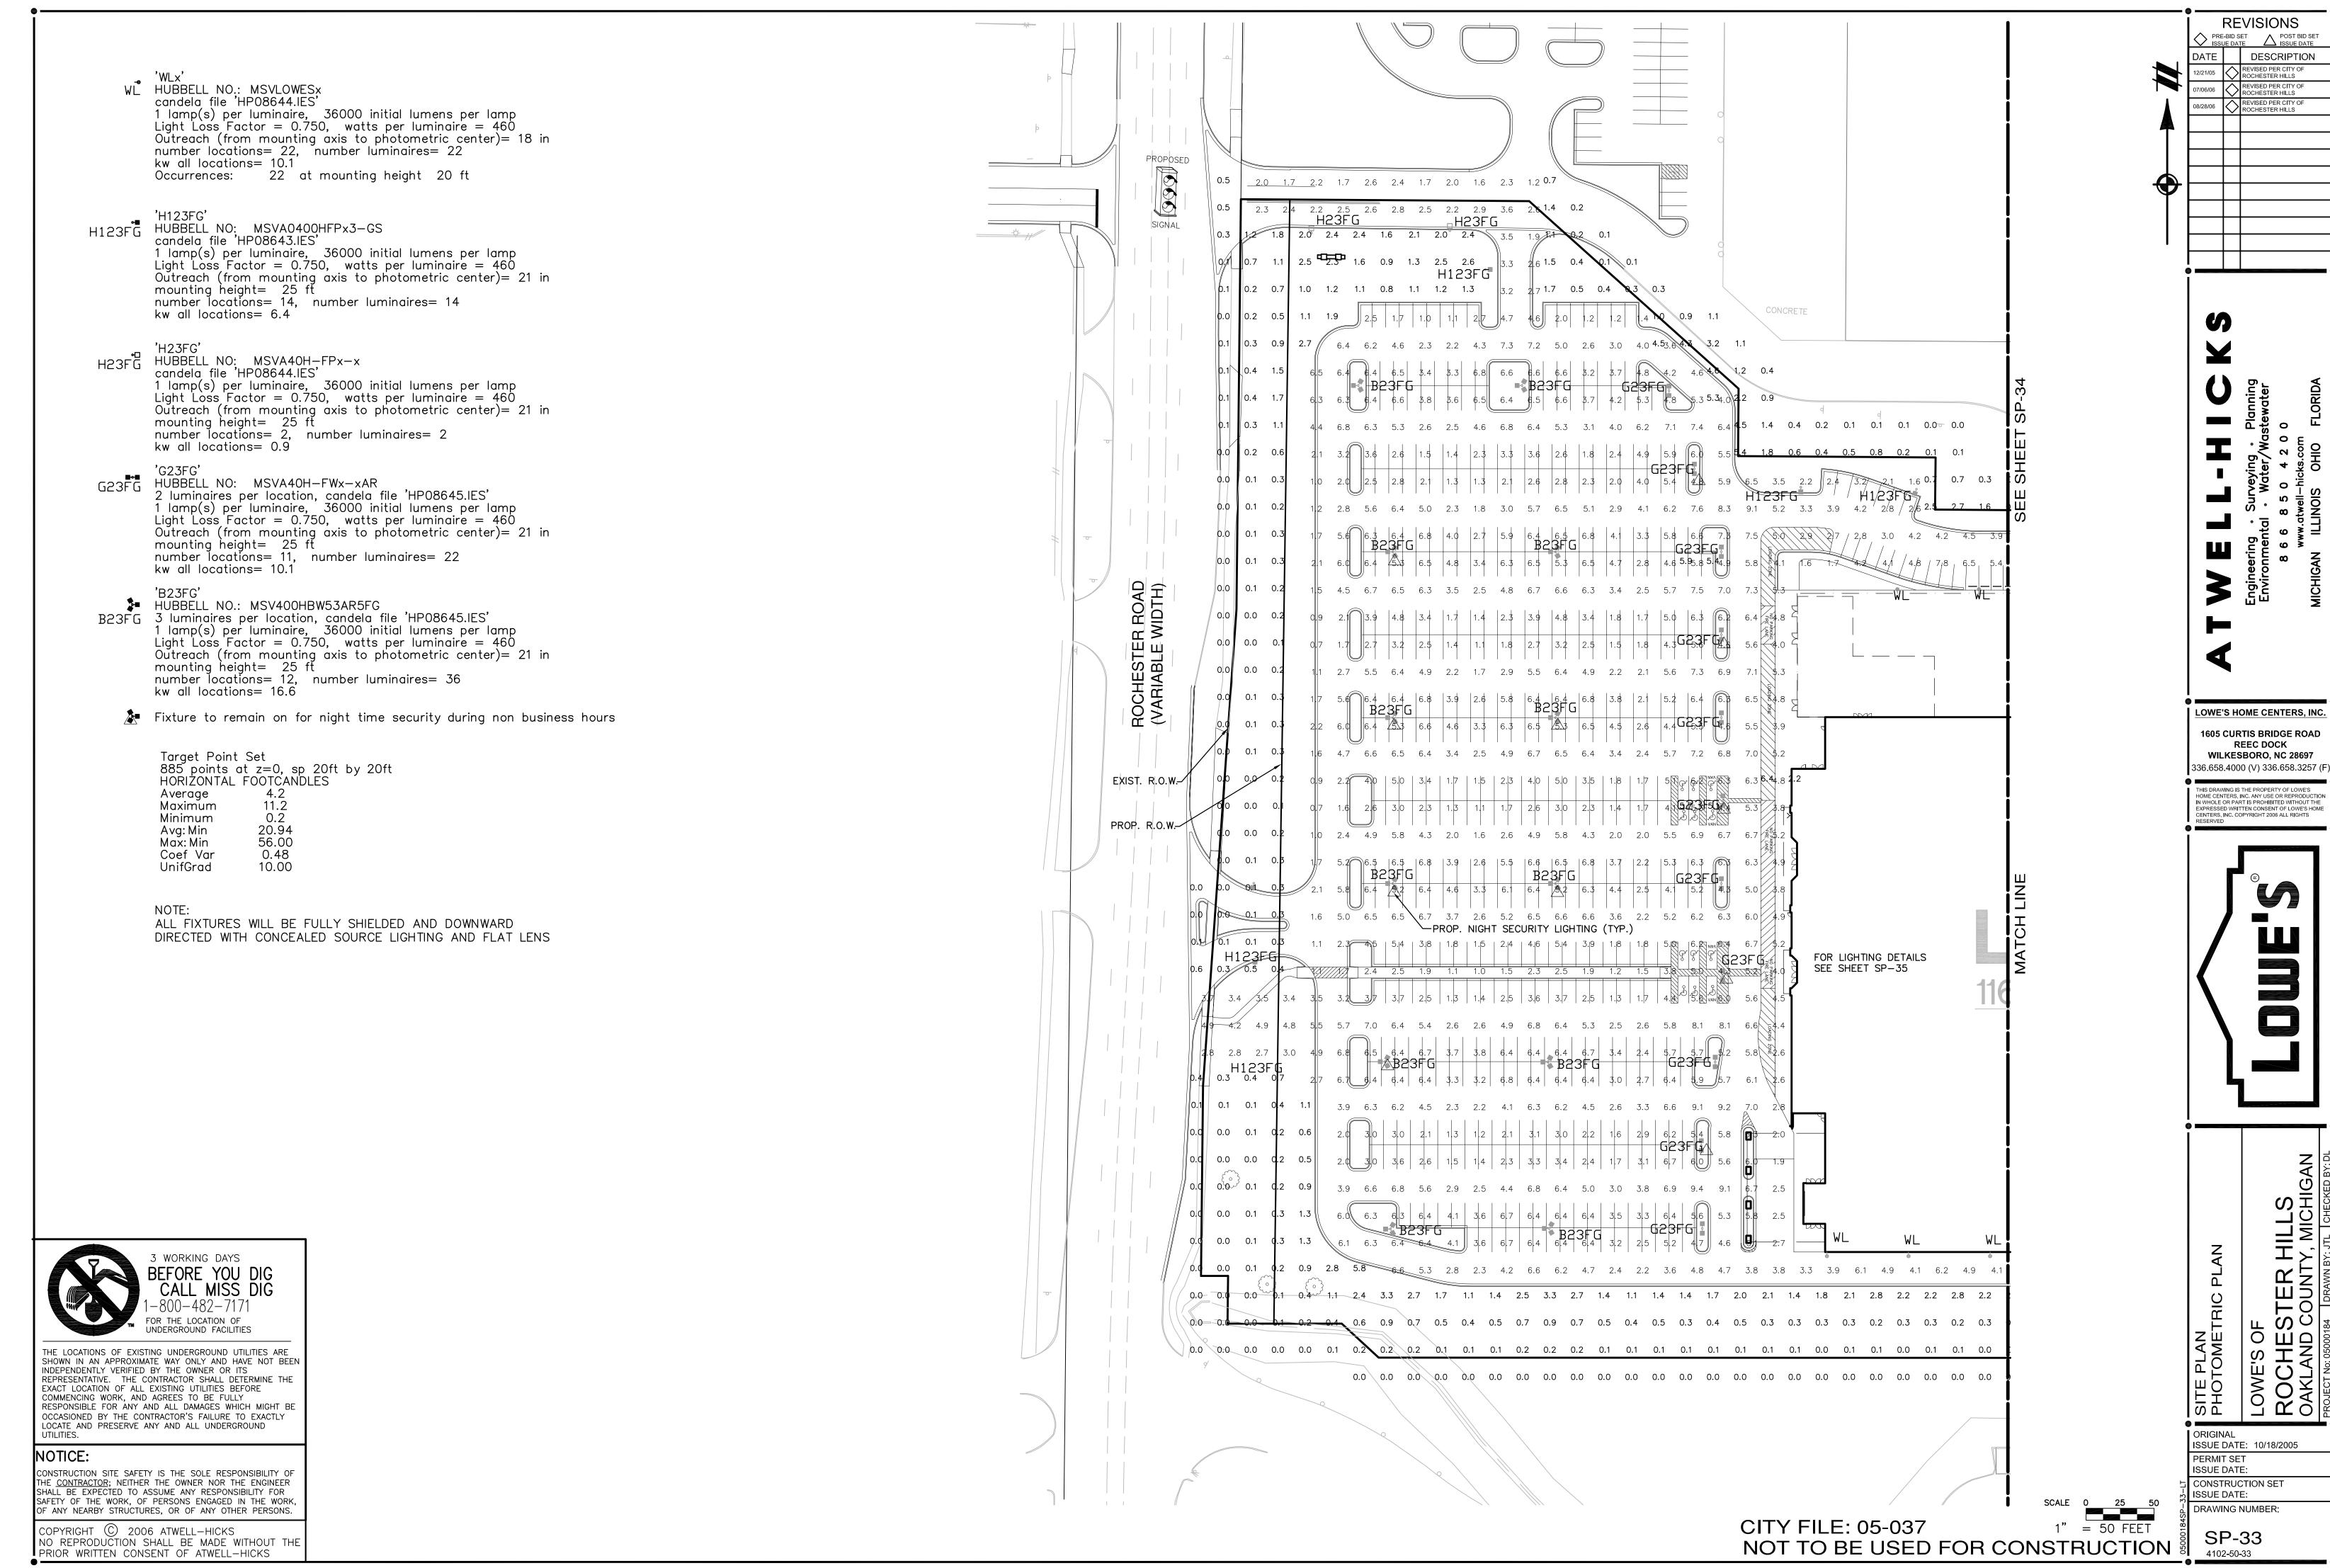
FOR THE LOCATION OF


UNDERGROUND FACILITIES





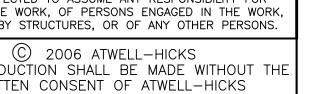

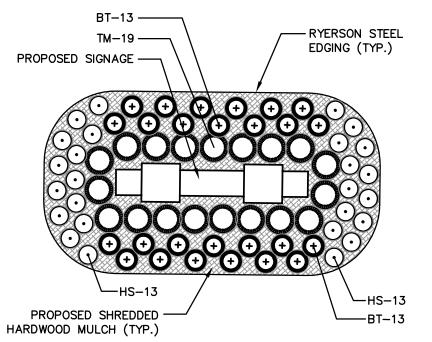

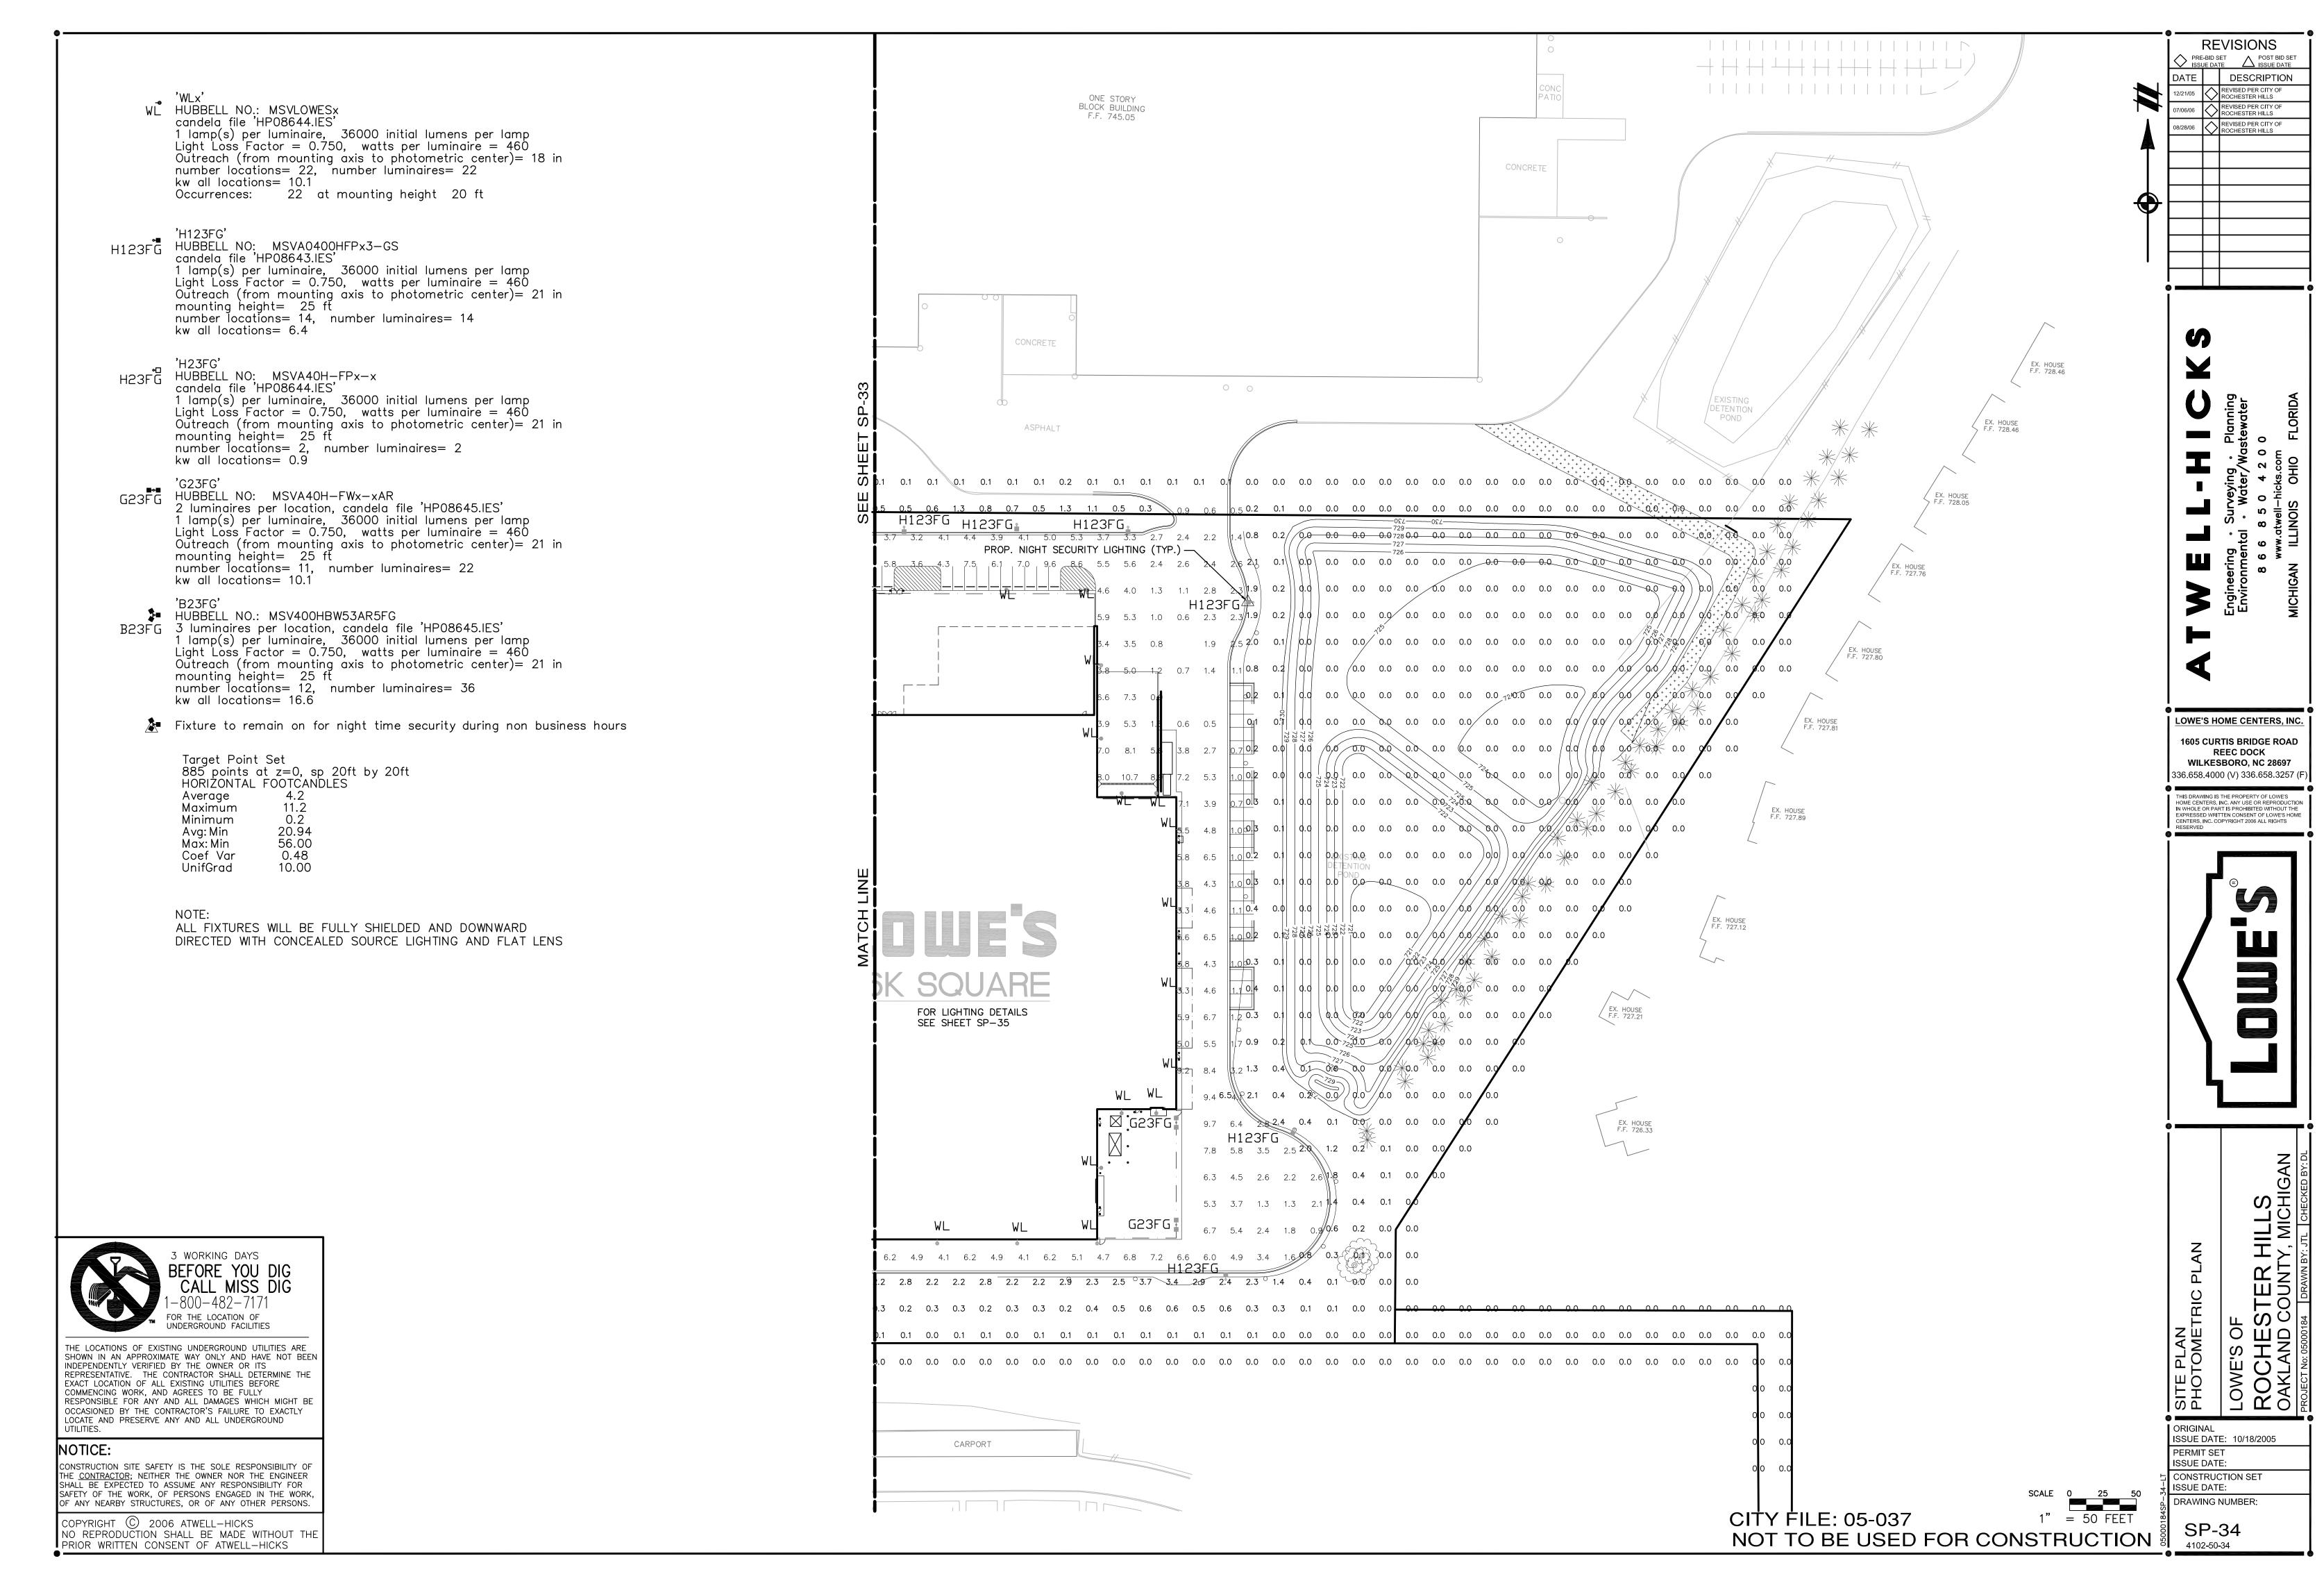

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