
PRIMROSE SCHOOL

VACANT LOT - ROCHESTER ROAD CITY OF ROCHESTER HILLS, OAKLAND COUNTY, MICHIGAN

PERMIT / APPROVAL SUMMARY DATE SUBMITTED DATE APPROVED PERMIT / APPROVAL 2/10/2023 SITE PLAN APPROVAL

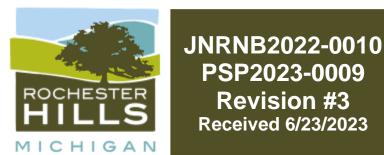

City of Rochester Hills Planning & Economic Development

For all conditional uses, a "Conditional Use

Such sign shall be compliant with Section

138-1.203 of City Ordinances.

otherwise noted."

thoroughfare.

features shall be reviewed:

4.Entrance features.

5. Heating exhaust devices.

1.Roof pitch, overhang, and drainage. 2. Window sills and other window features.

3. Facade treatment (both material and appearance).

Proposed Sign" shall be placed onsite no less than

"All plan review comments must be addressed prior

SECTION 138-4.424 - Nursery Schools, Day Nurseries and Child Care Centers

zoning on at least one side, and such zoning shall be on the same side of the major

A.Such facilities shall be located on major thoroughfares with an existing or proposed right-of-way of 120 feet. Additionally, the facility shall be on a corner lot or shall directly abut nonresidential

B.Hours of operation shall not exceed 15 hours a day with closing time of not later than 9:00 p.m. C.All parking and child dropoff areas shall be in the side or rear yard only. This requirement may be waived when an existing building that has front yard parking or circulation is being occupied by

D.Outdoor play areas shall be in the side or rear yard in the amount required by the Licensing

6.Penthouses or similar mechanical rooftop features shall be prohibited unless completely

I.Signs shall meet the requirements of Chapter 134 of the City's Code of Ordinances.

eened from adjacent properties and the adjacent public right-of-way.

E.Parking, dropoff, and play areas shall be screened in a manner deemed sufficient by the Planning Commission to achieve the objective of screening and controlling noise levels. F.Any trash receptacle shall be screened with a six-foot-high obscuring fence or wall, with evergreen screening provided on the three sides of the enclosure without access gates. G.Lighting shall be shielded downward so as not to become a nuisance to abutting property. H.Front, side and rear elevations of the building shall be provided to ensure that the use will have the appearance and character of residences in the vicinity. If there are no residences within 200 feet, in making a determination on the compatibility of such uses, the following architectural

to scheduling for the Planning Commission, unless

a nursery school, day nursery, or child care center.

Rules for Child Care Centers as set forth by the State of Michigan.

fifteen (15) days prior to the public hearing date.

Site Plan Review Reviewed for compliance with City Ordinance, Building and Fire Codes Conditions and mark-ups noted throughout plan set must be addressed prior to fina

	approval	
Department	Reviewer	Approved
Assessing	Assessing	Yes
Building	Mark Artinian 248-841-2446 ArtinianM@RochesterHills.org	Yes
Engineering - Utilities	Jason Boughton 248-841-2490 BoughtonJ@RochesterHills.org	Yes
Engineering Legal	Jenny McGuckin 248-841-2494 mcguckinj@rochesterhills.org	YES
Fire	Lt. Jon Mills 248-841-2708 MillsJ@RochesterHills.org	No
Natural Resources	Matt Einheuser 248-841-2551 EinheuserM@RochesterHills.org	Yes
Planning	Chris McLeod 248-841-2572 mcleodc@RochesterHills.org	Yes
Traffic		
To be prov	vided at	

DESIGN TEAM

a later date

EIG14T 1695 TWELVE MILE ROAD, STE 100 BERKLEY, MI 48072 CONTACT: DANIEL HARRIS PHONE: 248.514.9120 EMAIL: DAN@814CRE.COM

OWNER/APPLICANT/DEVELOPER CIVIL ENGINEER


PEA GROUP 58105 VAN DYKE RD. PHONE: 844.813.2949

J.The facility shall comply with applicable state licensing requirements and regulations. K.Any other conditions which the Planning Commission and City Council deem necessary to ensure that the residential character of the neighborhood shall be maintained. WASHINGTON TWP., MI 48094


CONTACT: BECKY KLEIN, PE, LEED AP BD+C EMAIL: BKLEIN@PEAGROUP.COM

LANDSCAPE ARCHITECT

PEA GROUP 7927 NEMCO WAY, STE. 115 BRIGHTON, MI 48116 CONTACT: JANET EVANS, PLA PHONE: 844.813.2949 EMAIL: JEVANS@PEAGROUP.COM

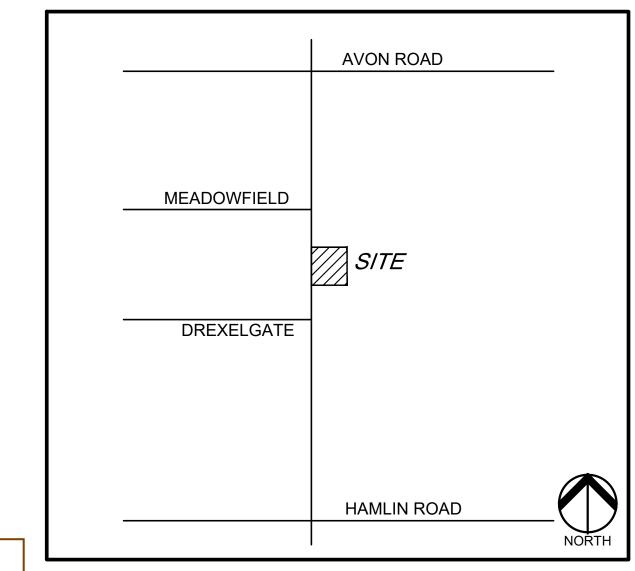

LOCATION MAP

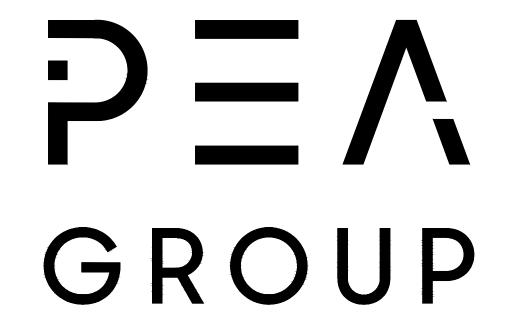


	INDEX OF DRAWINGS
NUMBER	TITLE
	COVER SHEET
C-1.0	TOPOGRAPHIC SURVEY
C-3.0	PRELIMINARY SITE PLAN
C-3.1	FIRE PROTECTION PLAN
C-4.0	PRELIMINARY GRADING PLAN
C-6.0	PRELIMINARY UTILITY PLAN
C-9.1	DETAILS
C-9.2	DETAILS
L-1.0	LANDSCAPE PLAN
L-2.1	LANDSCAPE SPECIFICATIONS
T-1.0	TREE PRESERVATION PLAN
	PHOTOMETRIC PLANS
23-12467	PHOTOMETRIC SITE PLAN (2 SHEETS)
	ARCHITECTURAL PLANS
A1.0	PRIMROSE SCHOOL FLOOR PLAN
A4.0	PRIMROSE SCHOOL EXTERIOR ELEVATIONS
	PRIMROSE SCHOOL - MATERIAL BOARD AND COLORED ELEVATIONS

PRIMROSE SCHOOL - COLORED ELEVATIONS

REVISIONS	
DESCRIPTION	DATE
ORIGINAL ISSUE DATE	2/10/2023
SITE PLAN APPROVAL RESUBMITTAL	4/19/2023
SITE PLAN APPROVAL RESUBMITTAL	5/25/2023
SITE PLAN APPROVAL RESUBMITTAL	6/23/2023



NOT FOR CONSTRUCTION CITY FILE No. 22-041 SECTION 23

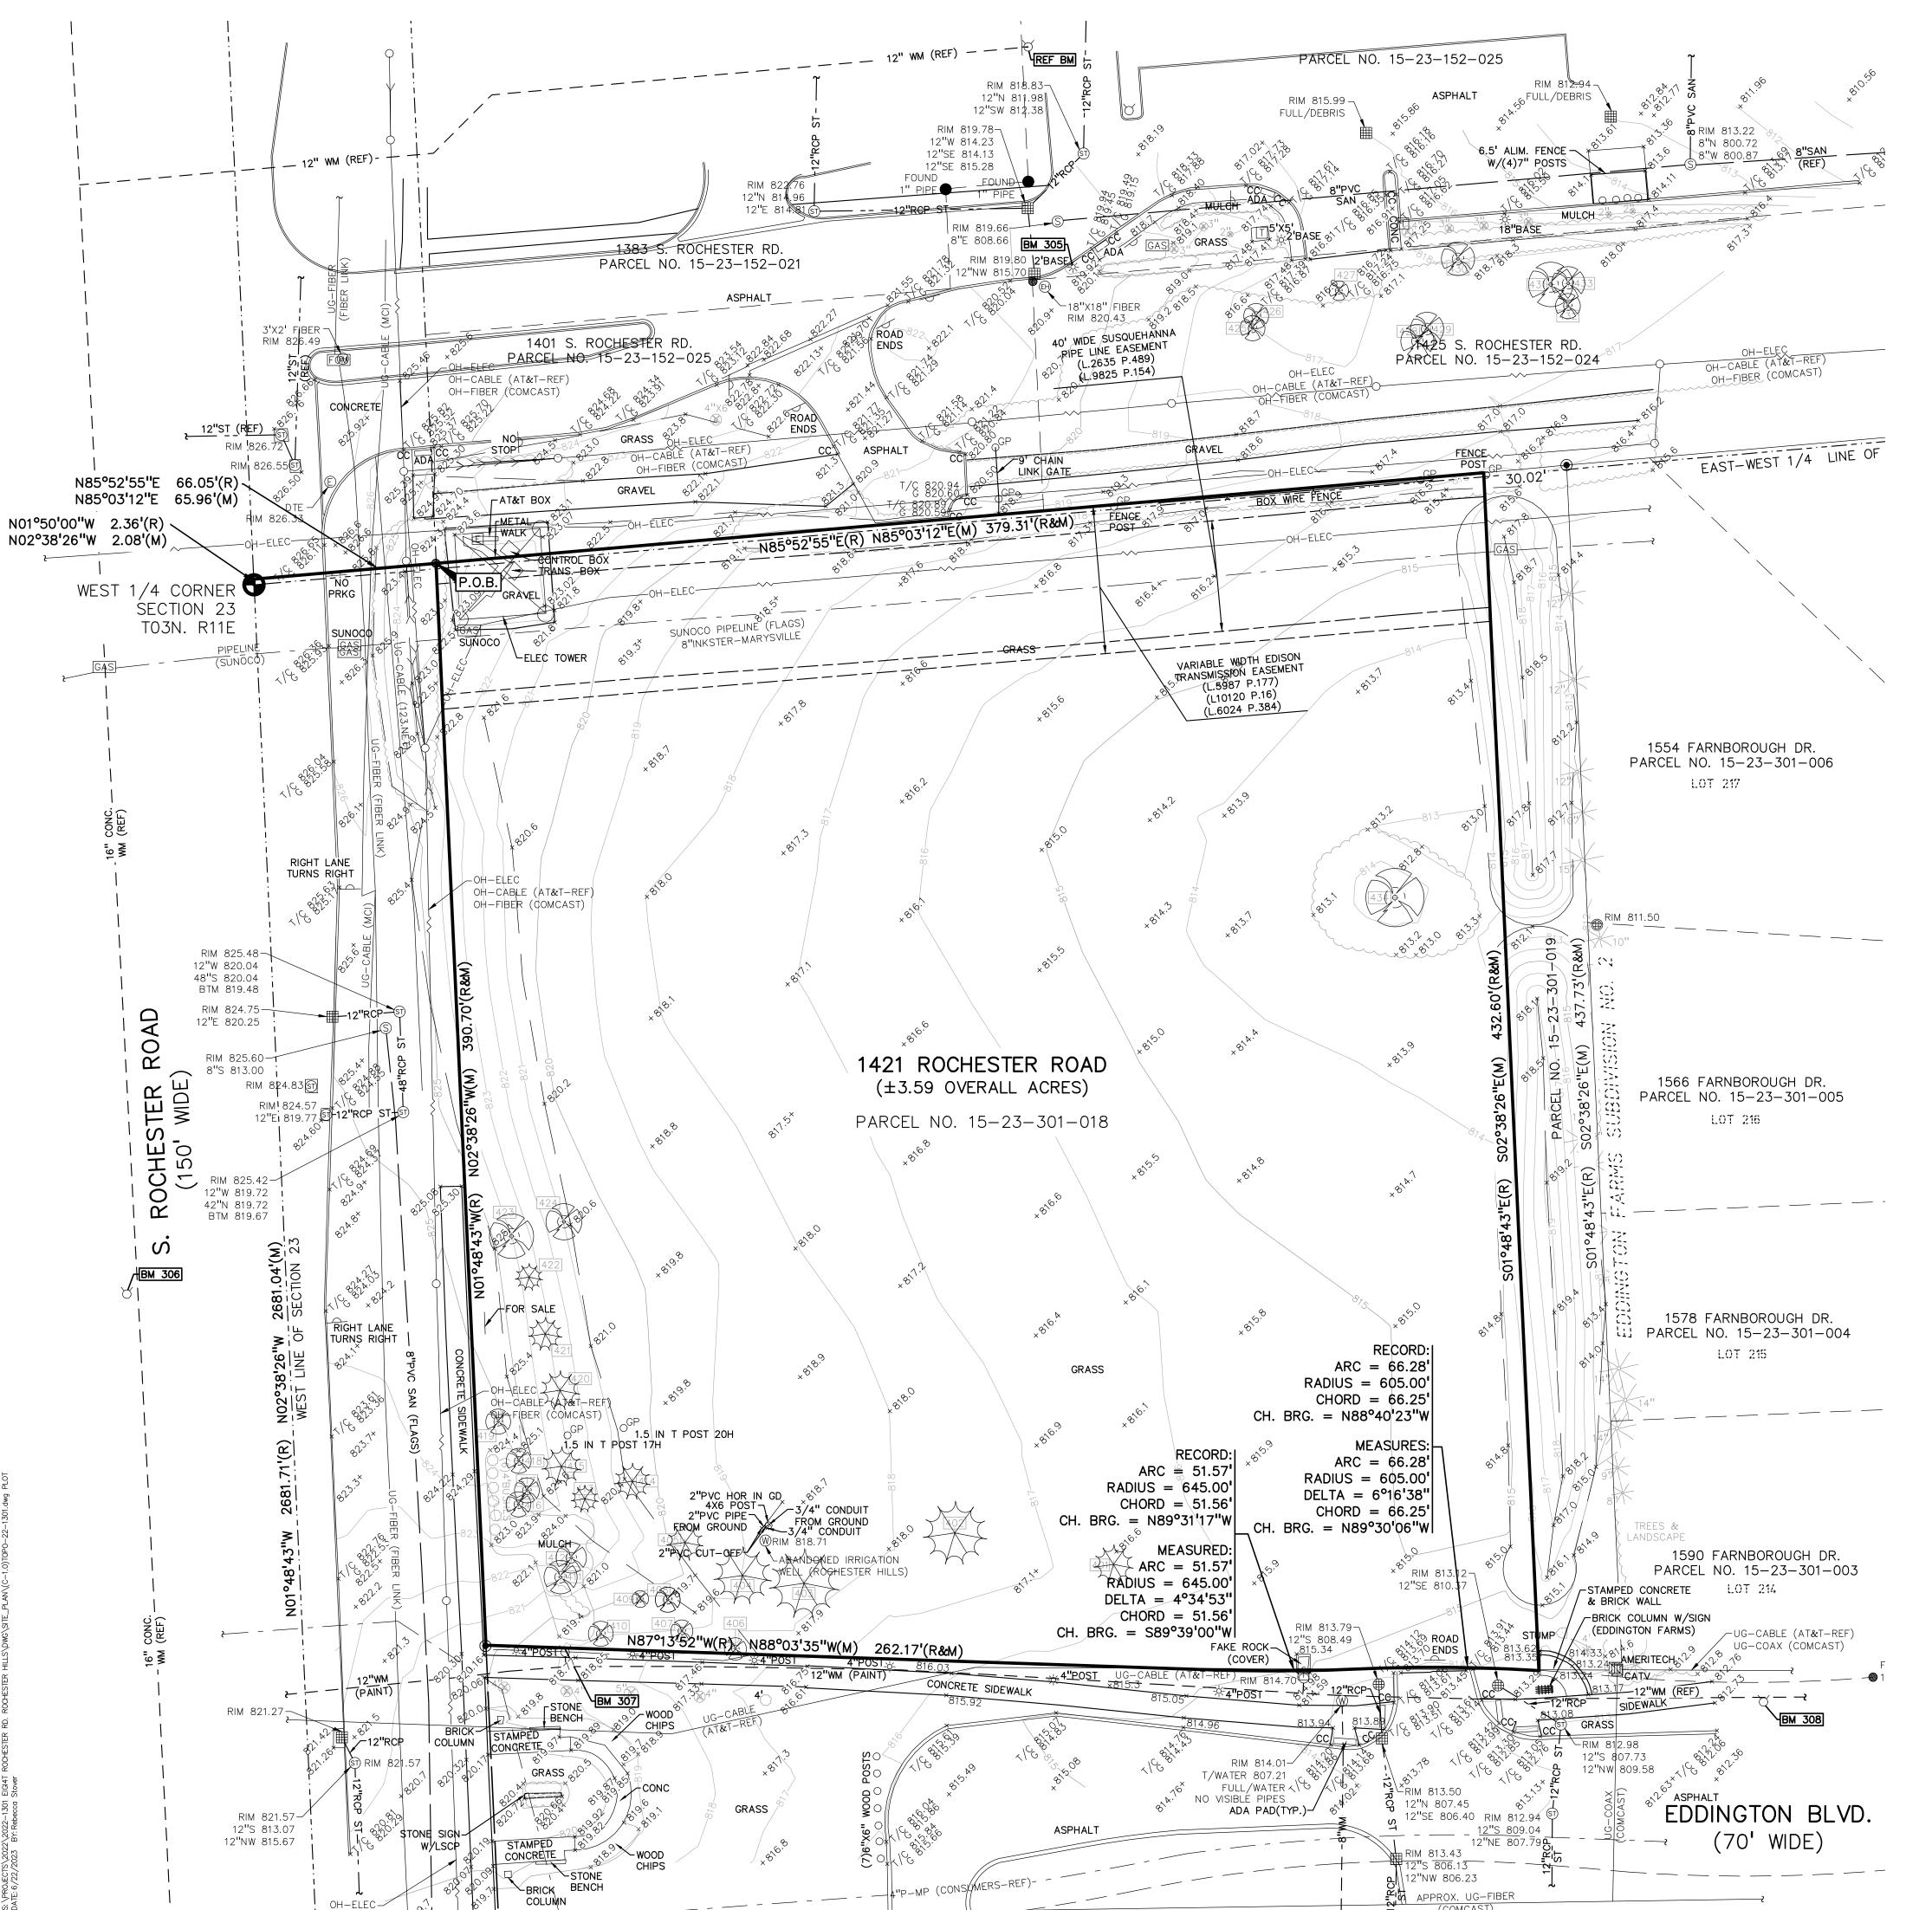

LEGAL DESCRIPTION:

(Per First American Title Insurance Company, Commitment No. 956940,

dated September 07, 2022)

Land in the City of Rochester Hills, Oakland County, MI, described as follows. Part of the West 1/2 of Section 23, Town 3 North, Range 11 East, City of Rochester Hills, Oakland County, Michigan, being more particularly described as follows: Beginning at a point which is North 01 degree 50 minutes 00 seconds West 2.36 feet along the West line of Section 23 and North 85 degrees 52 minutes 54 seconds East 66.05 feet from the West 1/4 corner of Section 23, Town 3 North, Range 11 East; thence North 85 degrees 52 minutes 55 seconds East 409.33 feet; thence South 01 degree 48 minutes 43 seconds East 437.73 feet; thence Westerly 8.72 feet along the arc of a curve to the right (Radius of 535.00 feet, central angle of 00 degrees 56 minutes 01 second, long chord bears North 83 degrees 57 minutes 43 seconds West 8.72 feet); thence Westerly 87.82 feet along the arc of a curve to the left (Radius of 605.00 feet, central angle of 08 degrees 19 minutes 02 seconds, long chord bears North 87 degrees 39 minutes 12 seconds West 87.74 feet); thence Westerly 51.57 feet along the arc of curve to the right (Radius of 645.00 feet, central angle of 04 degrees 34 minutes 52 seconds, long chord bears North 89 degrees 31 minutes 17 seconds West 51.56 feet); thence North 87 degrees 13 minutes 52 seconds West 262.17 feet; thence North 01 degree 48 minutes 43 seconds West 390.70 feet along a line parallel with and 66 feet East to the West line of Section 23 to the point of beginning.

Part of the Southwest 1/4 of Section 23, Town 3 North, Range 11 East, City of Rochester Hills, Oakland County, Michigan described as: Beginning at a point distant North 01 degrees 50 minutes 00 seconds West 2.36 feet and North 85 degrees 52 minutes 55 seconds East 66.05 feet and North 85 degrees 52 minutes 55 seconds East 379.31 feet from the West 1/4 corner of said Section 23; thence continuing North 85 degrees 52 minutes 55 seconds East 30.02 feet; thence along the West lines of Lots 214 mu 217 of "EDDINGTON FARMS SUB NO. 2" (as recorded in Liber 219, Page 14 Oakland County Records) South 01 degrees 48 minutes 43 seconds East 437.72 feet; thence Westerly 8.72 feet along the arc of a curve to the right, having a radius of 535.00 feet and a long chord which bears North 83 degrees 57 minutes 44 seconds West 8.72 feet; thence Westerly 21.54 feet along the arc of a curve to the left, having a radius of 605.00 feet and a long chord which bears North 84 degrees 30 minutes 53 seconds West 21.54 feet; thence North 01 degrees 48 minutes 43 seconds West 432.60 feet to the point of beginning.

LEGEND:

-OH-ELEC-W-O- EX. OH. ELEC, POLE & GUY WIRE

-UG-COMM----⊠-①- EX. U.G. COMMUNICATION LINE, PEDESTAL & MANHOL UG-ELEC-®-EKE- EX. U.G. ELEC,MANHOLE, METER & HANDHOLE — – — – EX. GAS LINE

© GAS EX. GAS VALVE & GAS LINE MARKER — — — EX WATER MAIN ∀ - W EX. HYDRANT, GATE VALVE & POST INDICATOR VALVE

EX. SANITARY SEWER EX. COMBINED SEWER MANHOLE — -- EX. STORM SEWER EX. CLEANOUT & MANHOLE EX. SQUARE, ROUND, & BEEHIVE CATCH BASIN EX. YARD DRAIN & ROOF DRAIN EX. UNIDENTIFIED STRUCTURE X EX. FENCE EX. GUARD RAIL

EX. SPOT ELEVATION EX. CONTOUR 👱 🎍 🎍 EX. WETLAND IRON FOUND / SET NAIL FOUND / NAIL & CAP SET

BRASS PLUG SET MONUMENT FOUND / SET SECTION CORNER FOUND R M C RECORDED / MEASURED / CALCULATED

REFERENCE DRAWINGS:

AT&T MAP A1, DATED 10/25/2022 COMCAST MAP, EMAIL DATED 10/25/2022 ROCHESTER COMMUNITY SCHOOLS NETWORK

MAP, FIBER LINK EMAIL DATED 10/13/2022 COMCAST MAP, EMAIL DATED 10/25/2022 CONSUMERS MAP 03-61-23-3, DATED 04/05/2022 SUNOCO PIPELINE MAP, EMAIL DATED 10/18/2022

UTILITY MAP, CITY OF ROCHESTER HILLS EMAIL STORM SEWER DATED 10/19/2022 FIFTH THIRD BANK STORM AND PAVING DETAILS JJ ASSOCIATES DWG. NO. M-06-5437, SHEET 4, DATED 08/14/2006, AS-BUILT DATE 08/07/2006, RE 09/11/2006

SANITARY SEWER UTILITY MAP, CITY OF ROCHESTER HILLS EMAIL DATED 10/19/2022

WATER MAIN UTILITY MAP, CITY OF ROCHESTER HILLS EMAIL DATED 10/19/2022

BENCHMARKS: (GPS DERIVED - NAVD88)

ELEV. - 820.48

FIBER

BM #305 NAIL IN THE TOP OF A LIGHT POLE BASE LOCATED APPROX. 140' SOUTHEAST FROM THE SOUTHEAST BUILDING CORNER OF FIFTH-THIRD BANK (1383 ROCHESTER RD). ELEV. - 822.13

ARROW W/DIMPLE ON A HYDRANT LOCATED ON THE WEST SIDE OF ROCHESTER ROAD, ACROSS FROM SITE. ELEV. - 827.23

ARROW ON A HYDRANT LOCATED ON THE EASTSIDE OF ROCHESTER

ROAD, AT THE SOUTHWEST AREA OF THE SITE. ELEV. - 820.86

ARROW W/DIMPLE ON A HYDRANT LOCATED ON THE NORTH SIDE OF EDDINGTON BLVD. WEST OF FARNBOROUGH DRIVE. ELEV. - 814.85

REF. BM (NOWAK & FRAUS) ARROW ON A HYDRANT LOCATED AT THE SOUTHEAST SIDE OF THE DRIVE-THRU OF FIFTH-THIRD BANK (1383 ROCHESTER RD).

PRIMROSE SCHOOL VACANT LOT - ROCHESTER ROAD

TAG	CODE	DBH	COMMON NAME	LATIN NAME	COND	NOTES
401	ws	13				HOILS
	NS	21	White Spruce	Picea glauca	Fair	
402		_ :	Norway Spruce	Picea Abies	Good	
403	NS	23	Norway Spruce	Picea Abies	Good	
404	NS	19	Norway Spruce	Picea Abies	Good	
405	NS	12	Norway Spruce	Picea Abies	Fair	
406	CA	8	Crab Apple	Malus caronaria	Fair	x1
407	CA	8	Crab Apple	Malus caronaria	Fair	x1
408	CA	9	Crab Apple	Malus caronaria	Fair	x1
409	CA	6	Crab Apple	Malus caronaria	Fair	
410	CA	11	Crab Apple	Malus caronaria	Good	
411	CA	12	Crab Apple	Malus caronaria	Fair	
412	CA	11	Crab Apple	Malus caronaria	Good	
413	NS	9	Norway Spruce	Picea Abies	Fair	
414	NS	12	Norway Spruce	Picea Abies	Fair	
415	NS	13	Norway Spruce	Picea Abies	Fair	
416	CA	12	Crab Apple	Malus caronaria	Good	x1
417	CA	10	Crab Apple	Malus caronaria	Fair	
418	CA	8	Crab Apple	Malus caronaria	Good	
419	CA	8	Crab Apple	Malus caronaria	Good	
420	NS	13	Norway Spruce	Picea Abies	Good	
421	WS	11	White Spruce	Picea glauca	Fair	1
422	ws	9	White Spruce	Picea glauca	Fair	
423	MW	16	White Mulberry	Morus alba	Fair	
424	MW	13	White Mulberry	Morus alba	Fair	
425	СТ	9	Cottonwood	Populus deltoides	Fair	
426	СТ	9	Cottonwood	Populus deltoides	Fair	
427	TH	7	Thornapple/Hawthorne	Cragaegus spp.	Fair	
428	NM	12	Norway Maple	Acer platanoides	Poor	
429	NM	12	Norway Maple	Acer platanoides	Fair	
430	NM	12	Norway Maple	Acer platanoides	Poor	1
431	NM	16	Norway Maple	Acer platanoides	Fair	x1
432	ВС	9	Wild Black Cherry	Prunus serotina	Poor	1
						

433 BC 12 Wild Black Cherry Prunus serotina Very Poor

FLOODPLAIN NOTE:

434 BX 21 Box elder


BY GRAPHICAL PLOTTING, SITE IS WITHIN ZONE 'X', AN AREA DETERMINED TO BE OUTSIDE OF THE 0.2% ANNUAL CHANCE FLOODPLAIN, PER FLOOD INSURANCE RATE MAP NUMBER 26125C0392F, DATED SEPTEMBER 29, 2006

Acer negundo Fair x4

t: 844.813.2949 www.peagroup.com






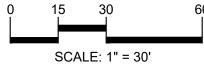



CAUTION!!

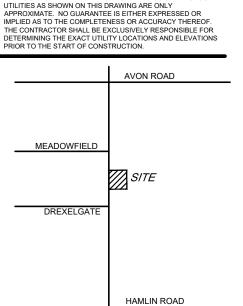

CLIENT

3221 W. BIG BEAVER ROAD, SUITE 111 TROY, MICHIGAN 48084

PROJECT TITLE


ROCHESTER HILLS, OAKLAND COUNTY, MICHIGAN


REVISIONS
SITE PLAN APPROVAL RESUBMITTAL 04-19-23
SITE PLAN APPROVAL RESUBMITTAL 05-25-23
SITE PLAN APPROVAL RESUBMITTAL 06-23-23
ORIGINAL ISSUE DATE:
FEBRUARY 10, 2023
DRAWING TITLE
TOPOGRAPHIC

	PEA JOB NO.	2022-1301
_	P.M.	BK
,	DN.	BLA
6.	DES.	BLA
<u> </u>	DRAWING NUMBER	R·

SURVEY



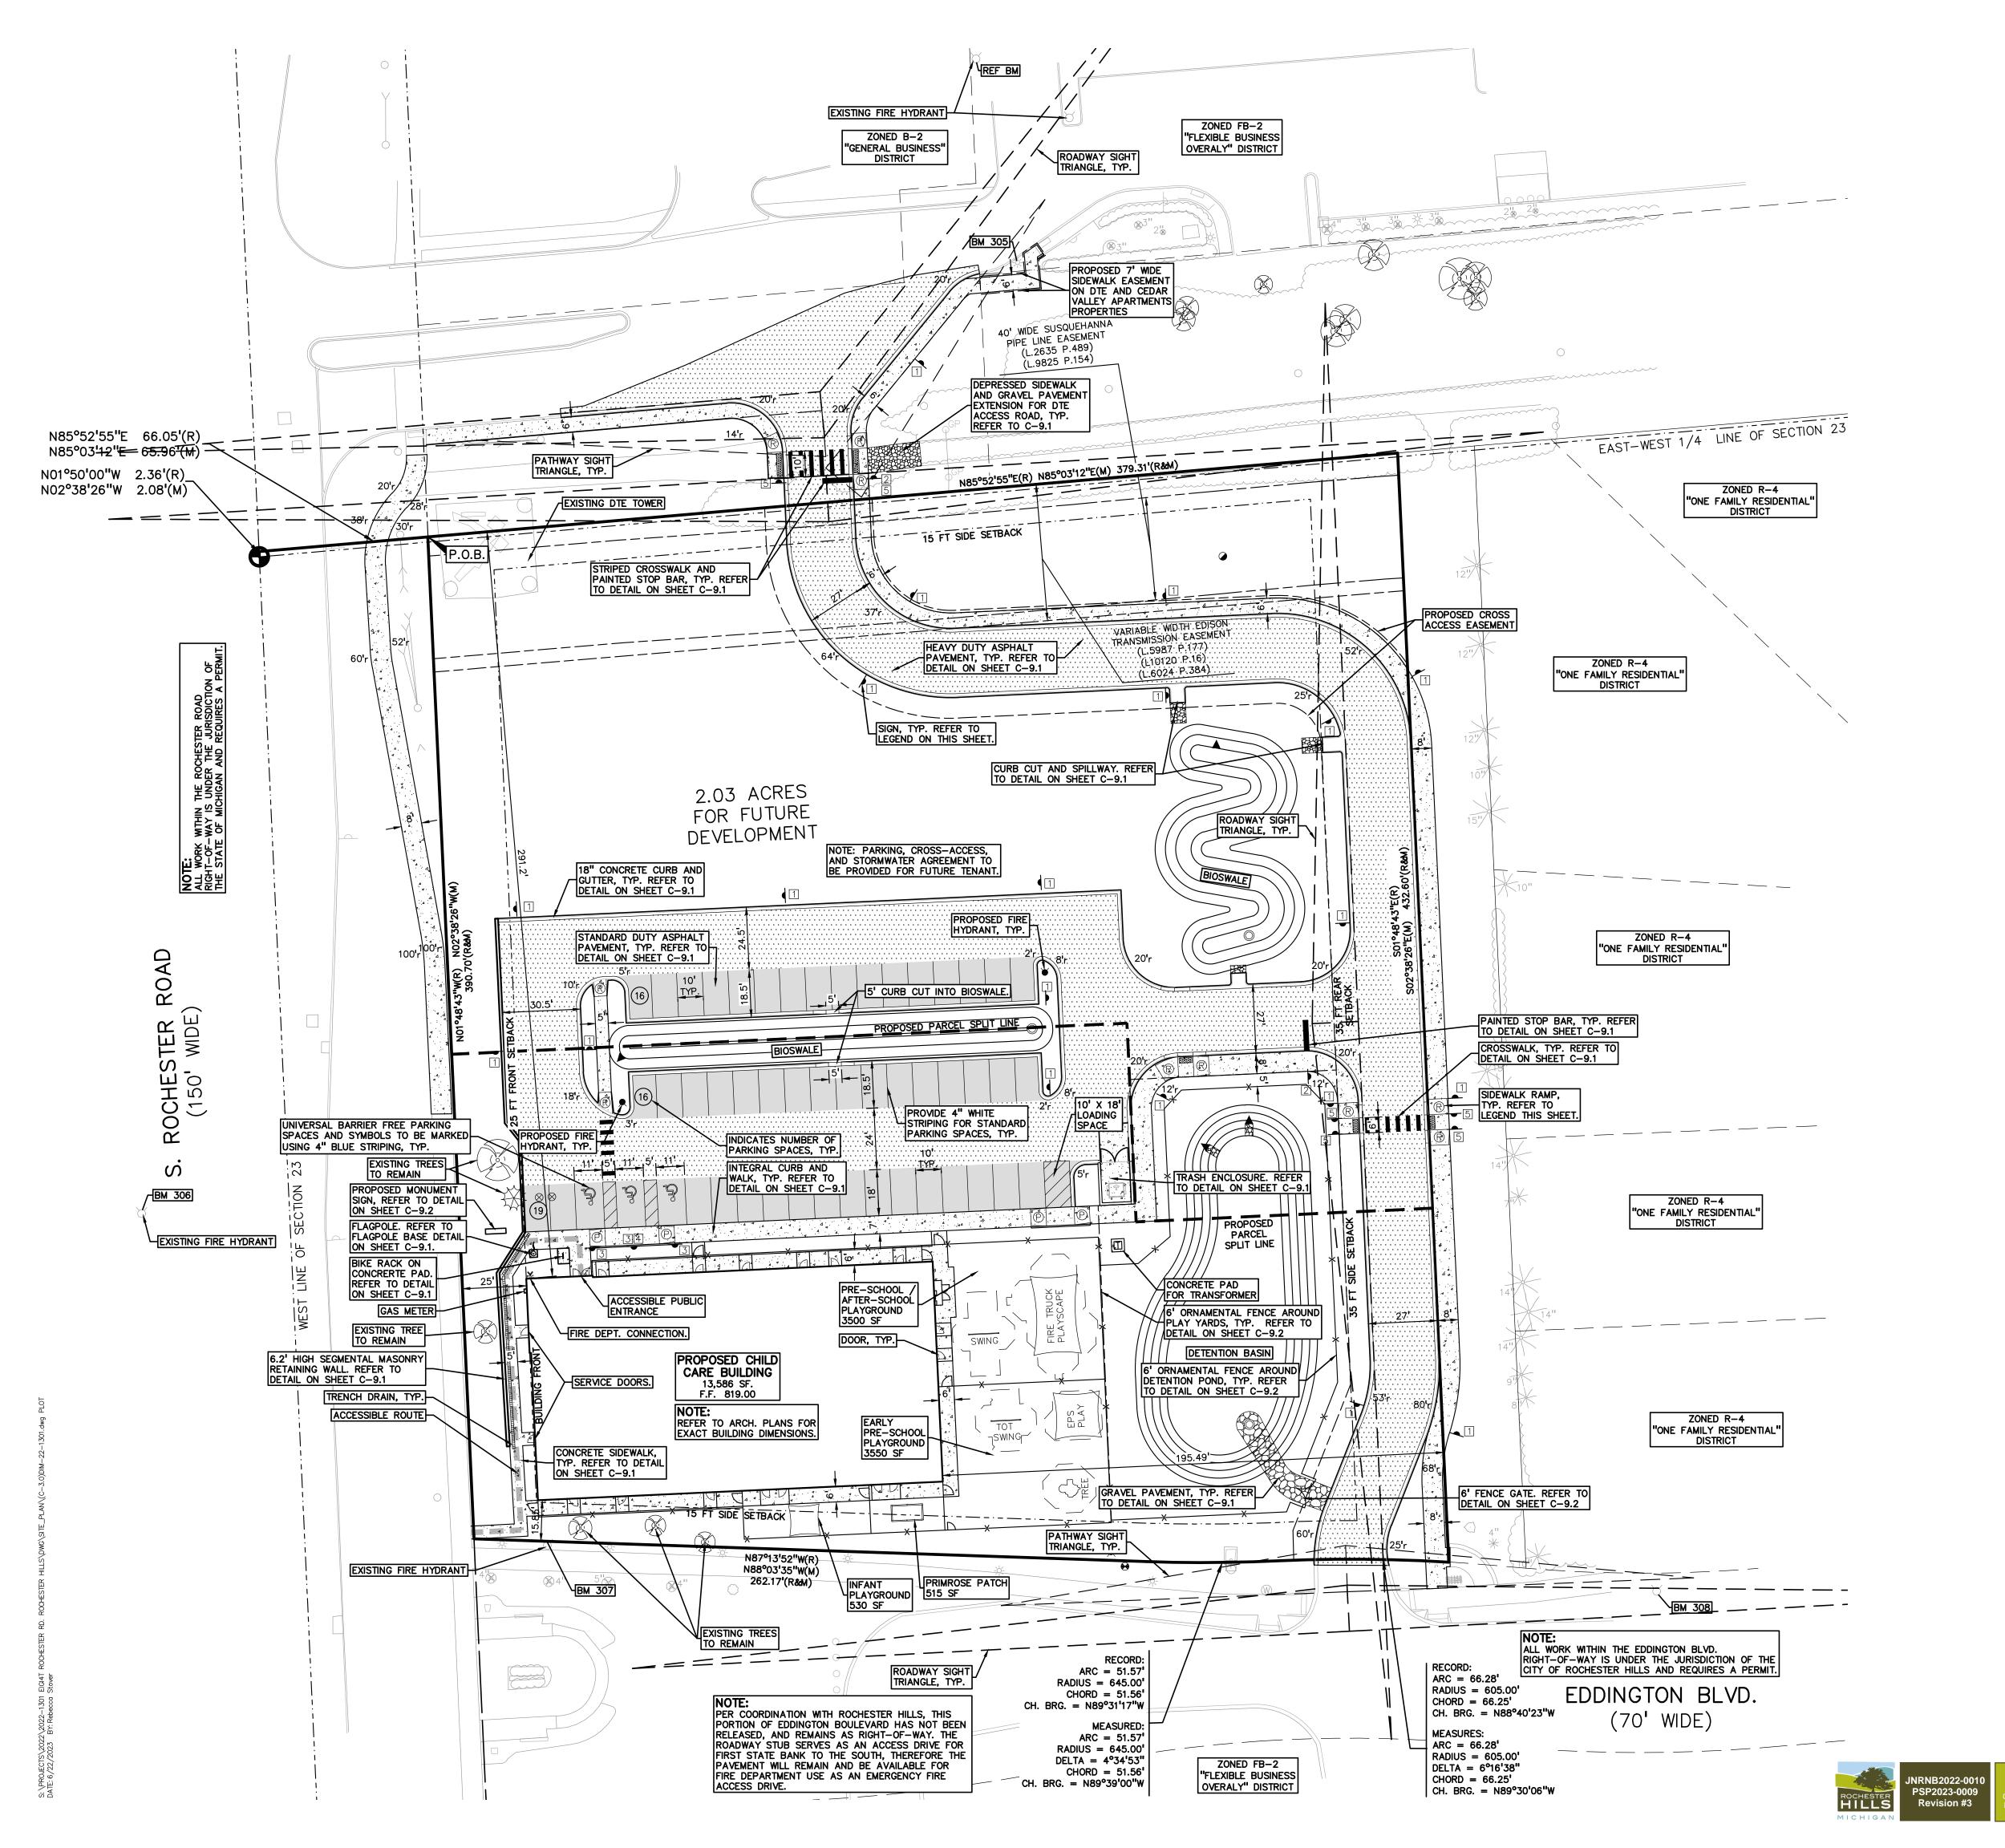

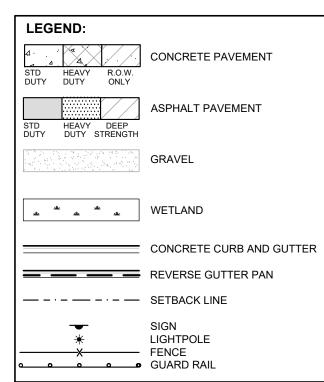

GROUP t: 844.813.2949 www.peagroup.com



GENERAL NOTES:

SITE DATA TABLE:

NORTHWEST

NORTHEAST

SIDE (SOUTH)

SIDE (NORTH)

REAR (EAST)

SOUTH

EAST

WEST

THESE NOTES APPLY TO ALL CONSTRUCTION ACTIVITIES ON THIS PROJECT.

ALL DIMENSIONS SHOWN ARE TO BACK OF CURB, FACE OF SIDEWALK, OUTSIDE FACE OF BUILDING, PROPERTY LINE, CENTER OF MANHOLE/CATCH BASIN OR CENTERLINE OF PIPE UNLESS OTHERWISE NOTED.

B-2 WITH PUD OVERLAY

R-4 WITH FB OVERLAY

R-4 WITH FB OVERLAY

INCREASED TO 35 FEET WITH BOTH SIDE YARD SETBACKS INCREASED BY 5 FEET

- 'NO PARKING-FIRE LANE' SIGNS SHALL BE POSTED ALONG ALL FIRE LANES AT 100 FOOT INTERVALS OR AS DIRECTED BY THE FIRE OFFICIAL.
- REFER TO SHEET C-9.1 FOR ON-SITE PAVING DETAILS.

SITE AREA: 3.59 ACRES (156,459 SF.) NET AND GROSS

ZONING: R-4: ONE FAMILY RESIDENTIAL

PROPOSED USE: CHILD CARE CENTER

BUILDING FOOTPRINT AREA = 13,586 SF

MAXIMUM PERCENT COVERAGE = 30% PROPOSED BUILDING LOT COVERAGE = 8.7%

PROPOSED BUILDING HEIGHT = 1 STORY (34'-7")

1 SPACE PER 10 PUPILS + 1 SPACE PER EMPLOYEE

DROP-OFF / PICK-UP SPACES REQUIRED = 5 SPACES

DROP-OFF / PICK-UP SPACES PROVIDED = 51 SPACES

LOADING SPACE PROVIDED = 1 SPACE (10' X18')

REFER TO SHEET C-9.2 FOR ON-SITE SIDEWALK RAMP DETAILS

<u>BUILDING INFORMATION:</u> MAXIMUM ALLOWABLE BUILDING HEIGHT = 35 FT. (2 STORIES) *

EACH, AND BUILDING FOOTPRINT LARGER THAN 13,500 S.F.

TOTAL PARKING REQUIRED = 202 PUPILS/10 + 30 EMPLOYEES = 51 SPACES

SITE SOILS INFORMATION:
ACCORDING TO THE USDA NATURAL RESOURCES CONSERVATION SERVICE
WEB SOIL SURVEY FOR OAKLAND COUNTY, THE SITE CONSISTS OF THE

TOTAL PROPOSED PARKING SPACES = 51 SPACES INC. 3 H/C SPACES









CAUTION!! I'HE LOCATIONS AND ELEVATIONS OF EXISTING UNDERGROUN JTILITIES AS SHOWN ON THIS DRAWING ARE ONLY APPROXIMATE. NO GUARANTEE IS EITHER EXPRESSED OR MPLIED AS TO THE COMPLETENESS OR ACCURACY THEREC

	CLUSIVELY RESPONSIBLE FOR TY LOCATIONS AND ELEVATIONS
	AVON ROAD
MEADOWFIELD DREXELGATE	SITE
	HAMI IN ROAD

CLIENT

EIG14T

PROJECT TITLE

SCHOOL

PRIMROSE

3221 W. BIG BEAVER ROAD, SUITE 111 TROY, MICHIGAN 48084

MARLETTE SANDY LOAM, 1 TO 6 PERCENT SLOPES **SIDEWALK RAMP LEGEND: SIGN LEGEND:**

'STOP' SIGN REFER TO LATEST MDOT R-28 STANDARD RAMP AND DETECTABLE

'CROSSWALK' SIGN

REFER TO DETAIL SHEET FOR SIGN DETAILS

15.85'

291.20'

195.49'

PRIMROSE OPERATIONAL NOTES:

FOLLOWING SOIL TYPES:

SIDEWALK RAMP 'TYPE R'

SIDEWALK RAMP 'TYPE P

WARNING DETAILS

1. OPERATIONAL REGULATIONS REQUIRE THAT ALL CHILDREN BE SIGNED IN AND OUT OF THE FACILITY BY AN AUTHORIZED ADULT NO DROP-OFF OR PICK-UP LANE WILL BE UTILIZED. ALL SPACES ON SITE WILL BE JTILIZED DROP-OFF AND PICK UP SPACES.

ROCHESTER HILLS NOTES: 1. ALL SIGNS MUST MEET THE REQUIREMENTS OF ROCHESTER HILLS AND BE APPROVED UNDER SEPARATE PERMITS ISSUED BY THE BUILDING

2. INSURANCE REQUIREMENTS MANDATE THAT A FENCE BE PROVIDED AROUND THE DETENTION POND FOR THE SAFETY OF THE CHILDREN USING THE FACILITY.

'NO PARKING FIRE LANE' SIGN 'BARRIER FREE PARKING' SIGN 'VAN ACCESSIBLE' SIGN

VACANT LOT - ROCHESTER ROAD ROCHESTER HILLS, OAKLAND COUNTY, MICHIGAN

REVISIONS SITE PLAN APPROVAL RESUBMITTAL 04-19-23

SITE PLAN APPROVAL RESUBMITTAL 05-25-23 SITE PLAN APPROVAL RESUBMITTAL 06-23-23

PROVIDED DURING ENGINEERING 3. LOT SPLIT APPLICATION WILL BE SUBMITTED DURING ENGINEERING REVIEW PHASE.


2. DRAFT EASEMENTS WILL BE


ORIGINAL ISSUE DATE FEBRUARY 10, 2023

DRAWING TITLE **PRELIMINARY SITE PLAN**

PEA JOB NO.	2022-1301
P.M.	ВК
DN.	BLA
DES.	BLA
DRAWING NUMBER	Σ·

NOT FOR CONSTRUCTION C-3.0

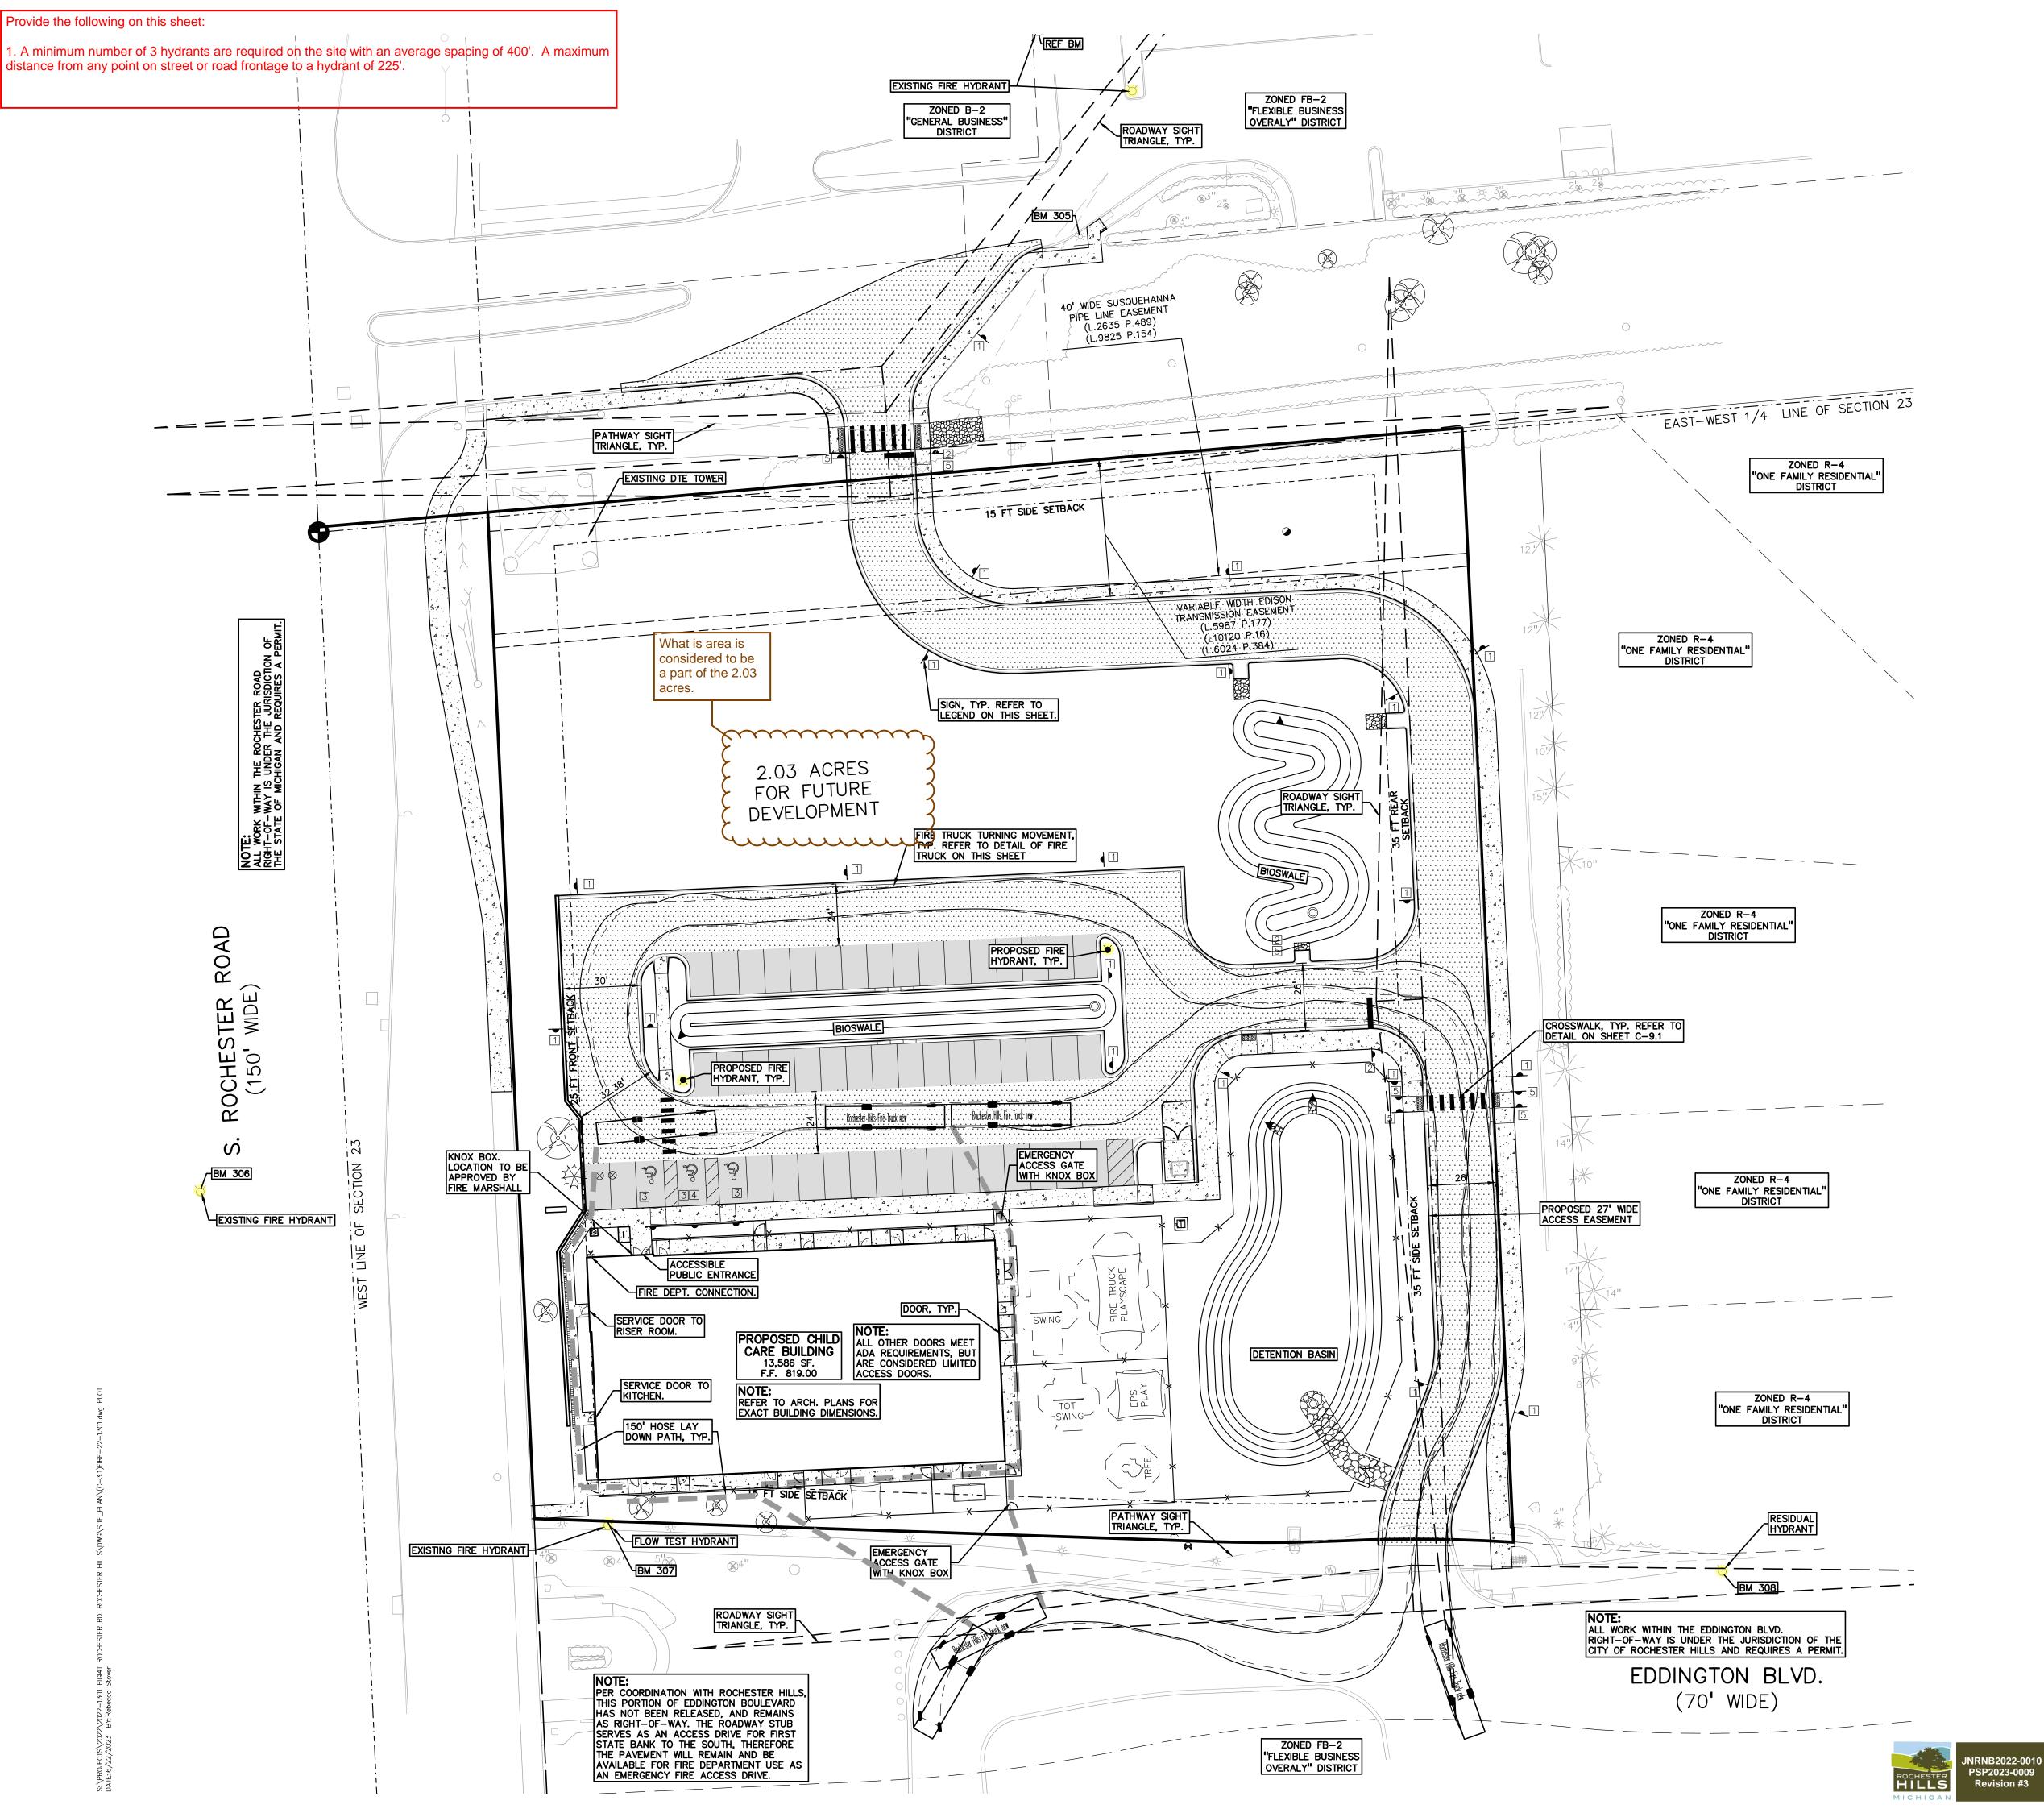

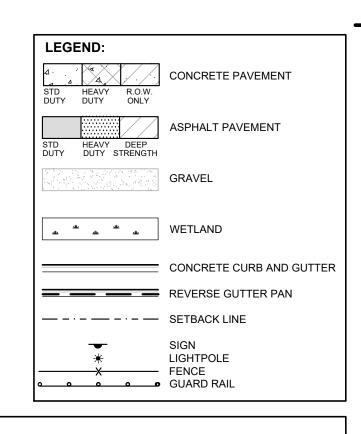

SITE DATA TABLE:

SITE AREA: 3.59 ACRES (156,459 SF.) NET AND GROSS

PROPOSED USE: CHILD CARE CENTER (13,666 SF)


MAXIMUM ALLOWABLE BUILDING HEIGHT = 30 FT. (2 STORIES) PROPOSED BUILDING HEIGHT = 1 STORY

BUILDING FOOTPRINT AREA = 13,666 SF

BUILDING LOT COVERAGE = 8.7%


BUILDING CONSTRUCTION TYPE: VB OCCUPANCY TYPE: 'E', B, AND S-1'

HYDRANT TEST PERFORMED BY ROCHESTER HILLS, DATED 6/8/23 FIRE FLOW AVAILABLE TO SITE: 5226 GPM AT 20 PSI

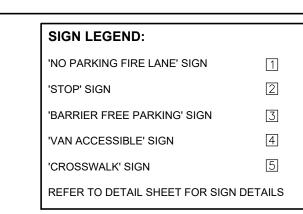

FIRE DEPARTMENT NOTES:

- FIRE LANES SHALL BE CONSPICUOUSLY POSTED ON BOTH SIDES OF THE FIRE LANE. WITH FIRE LANE SIGNS SPACED NOTMORE THAT 100 FEET APART, FIRE LANE SIGNS SHALL READ "NO STOPPING, STANDING, PARKING, FIRE LANE"; AND IN CONFORMANCE WITH THE MICHIGAN MANUAL OF UNIFORM TRAFFIC CONTROL DEVICES. FIRE PREVENTION ORDINANCE CHAPTER 58, SECTION 503
- CONSTRUCTION SITES SHALL BE SAFEGUARDED IN ACCORDANCE WITH IFC CHAPTER
- . OPEN BURNING IS NOT PERMITTED, INCLUDING THE BURNING OF TRASH, DEBRIS, OR LAND CLEARING MATERIALS. OPEN BURNING FOR WARMING OF SAND AND /OR WATER FOR THE PREPARATION OF MORTAR SHALL BE WITHIN CITY OF ROCHESTER HILLS BURN PERMIT GUIDELINES. CONTACT ROCHESTER HILLS FIRE DEPARTMENT FOR PERMIT INFORMATION. FIRE PREVENTION ORDINANCE CHAPTER 58, SECTION 307.6.2 & 307.6.2.3
- 4. A KNOX KEY SYSTEM SHALL BE INSTALLED AT EACH BUILDING IN A LOCATION APPROVED BY THE FIRE CODE OFFICIAL. ORDERING INFORMATION IS AVAILABLE
- ALL ROADWAY AND DRIVE AISLE WIDTHS ON THIS SHEET ARE MEASURED TO THE FACE OF CURB.
- 6. NO OVERHANGS INTO THE FIRE ACCESS ROAD WILL BE CREATED.
- THE FIRE DEPARTMENT CONNECTION SHALL NOT BE OBSTRUCTED BY LANDSCAPING, PARKING, OR ANY OTHER PERMANENT OR TEMPORARY MATERIALS OR DEVICES.
- ALL GATES SHALL BE PROVIDED WITH A KNOX BOX AS DIRECTED BY THE FIRE
- ROCHESTER ROAD WILL NOT BE ALLOWED TO BE USED AS A FIRE LANE DUE TO
- SAFETY AND TRAFFIC CONCERNS 10. EDDINGTON BOULEVARD CAN BE USED AS A FIRE LANE DUE TO AN EXISTING AGREEMENT BETWEEN ROCHESTER HILLS AND THE PARCEL TO THE SOUTH, THAT THIS PORTION OF EDDINGTON WILL REMAIN AS A PUBLIC RIGHT-OF-WAY

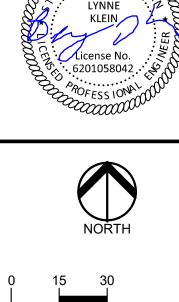

GROUP

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www.peagroup.com

CAUTION!! HE LOCATIONS AND ELEVATIONS OF EXISTING UNI TILITIES AS SHOWN ON THIS DRAWING ARE ONLY

APPROXIMATE. NO GUARANTEE IS EITHER EXPRESSED OR MPLIED AS TO THE COMPLETENESS OR ACCURACY THEREOF

THE CONTRACTOR SHALL BE EXCLUSIVELY RESPONSIBLE FOR DETERMINING THE EXACT UTILITY LOCATIONS AND ELEVATIONS PRIOR TO THE START OF CONSTRUCTION.

SCALE: 1" = 30'

AVON ROAD MEADOWFIELD DREXELGATE


CLIENT

EIG14T 3221 W. BIG BEAVER ROAD, SUITE 111 TROY, MICHIGAN 48084

PROJECT TITLE

PRIMROSE SCHOOL VACANT LOT - ROCHESTER ROAD

FIRE TRUCK DIAGRAM:

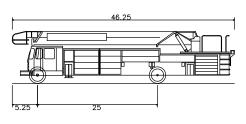

Rochester Hills Fire Truck

REVISIONS SITE PLAN APPROVAL RESUBMITTAL 04-19-23 SITE PLAN APPROVAL RESUBMITTAL 05-25-23 SITE PLAN APPROVAL RESUBMITTAL 06-23-23

ROCHESTER HILLS, OAKLAND COUNTY, MICHIGAN


ORIGINAL ISSUE DATE:

FEBRUARY 10, 2023 DRAWING TITLE **FIRE**


PROTECTION PLAN

PEA JOB NO. 2022-1301 BLA BLA DRAWING NUMBER:



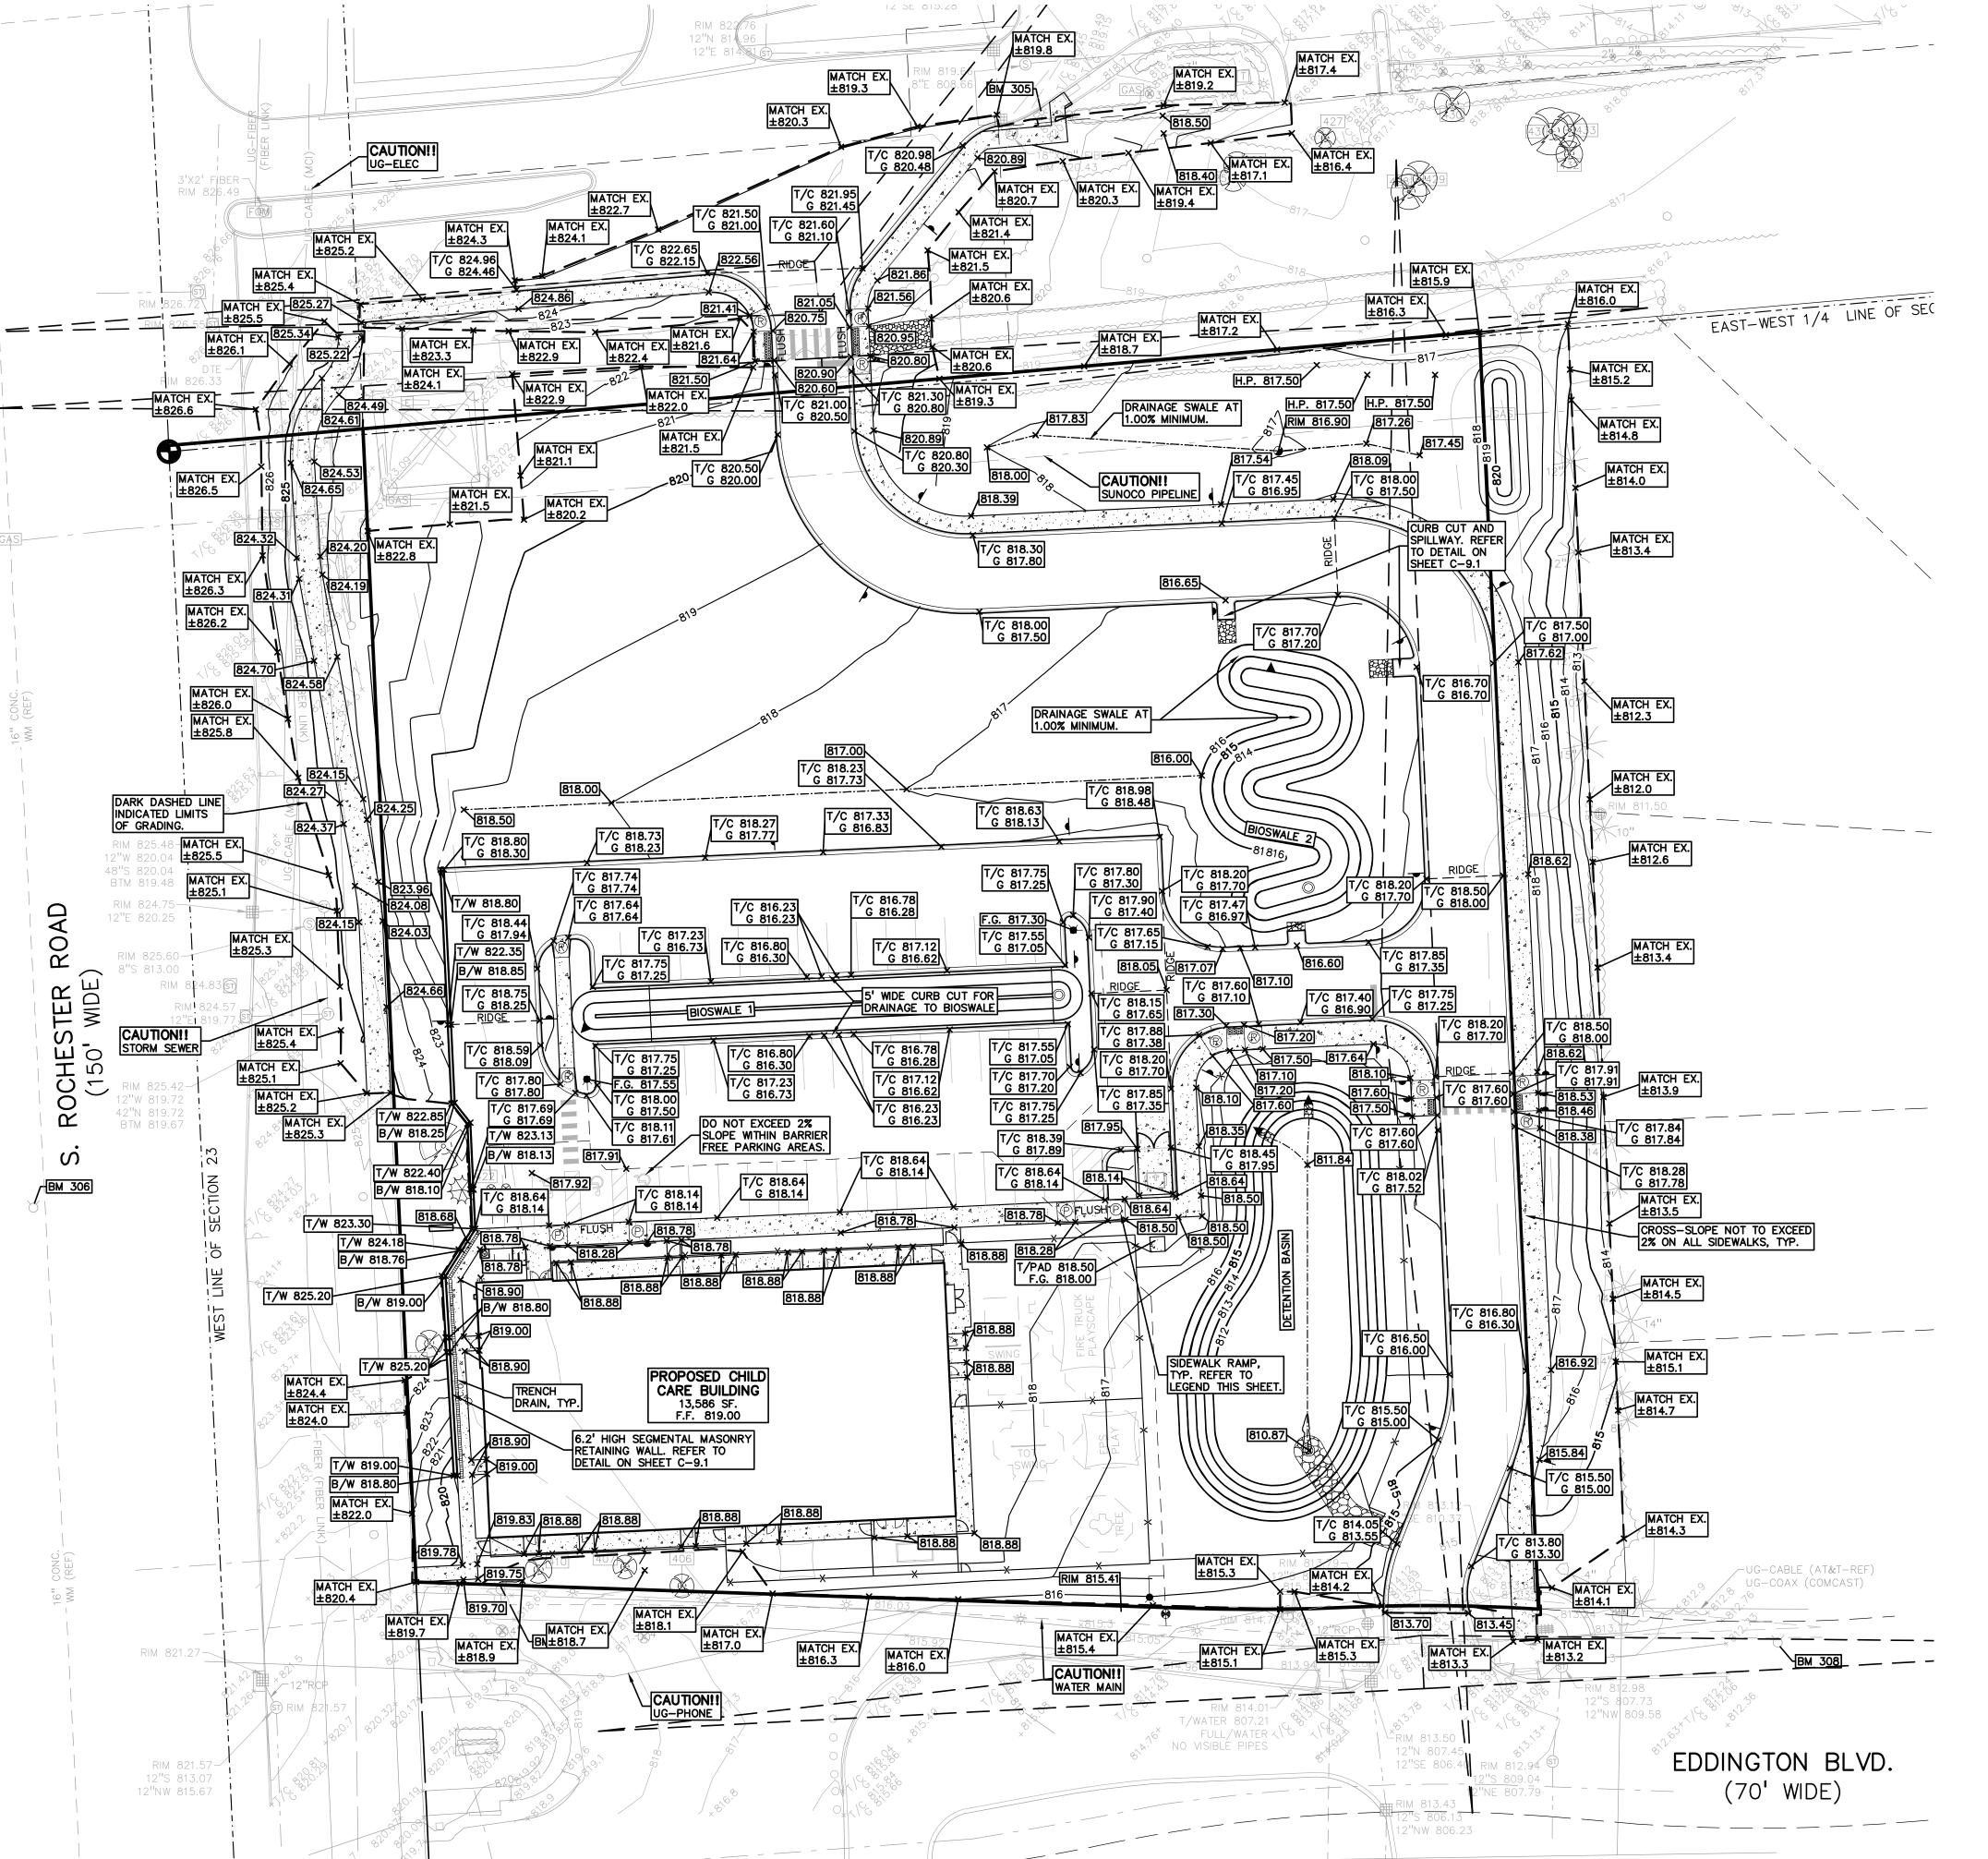



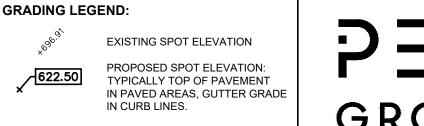

EXISTING CONTOUR ——922—— PROPOSED CONTOUR

PROPOSED REVERSE GUTTER PAI - - - - PROPOSED RIDGE LINE

----- PROPOSED SWALE/DITCH

T/C = TOP OF CURB G = GUTTER GRADE T/P = TOP OF PAVEMENT F.G. = FINISH GRADE T/S = TOP OF SIDEWALK RIM = RIM ELEVATION T/W = TOP OF WALL B/W = BOTTOM OF WALL

REFER TO GRADING NOTES ON SHEET C-X.

RETAINING WALL NOTE:

TOP OF WALL (T/W) AND BOTTOM OF WALL (B/W) GRADES ARE THE FINISH GRADE AT THE TOP AND BOTTOM OF THE RETAINING WALL, NOT ACTUAL TOP AND BOTTOM OF THE WALL STRUCTURE

EARTHWORK BALANCING NOTE:

ABBREVIATIONS

THE CONTRACTOR SHALL BE RESPONSIBLE FOR IMPORTING OR EXPORTING ALL MATERIALS AS REQUIRED TO PROPERLY GRADE THIS PROJECT TO THE FINISHED ELEVATIONS SHOWN ON THE APPROVED PLANS. THE CONTRACTOR SHALL MAKE THEIR OWN DETERMINATION OF CUT AND FILL QUANTITIES AND ALLOW FOR REMOVAL OF EXCESS OR IMPORTATION OF ADDITIONAL MATERIAL AT NO ADDITIONAL COST TO THE OWNER.

BENCHMARKS: (GPS DERIVED - NAVD88)

NAIL IN THE TOP OF A LIGHT POLE BASE LOCATED APPROX. 140' SOUTHEAST FROM THE SOUTHEAST BUILDING CORNER OF FIFTH-THIRD BANK (1383 ROCHESTER RD). ELEV. - 822.13

ARROW W/DIMPLE ON A HYDRANT LOCATED ON THE WEST SIDE OF ROCHESTER ROAD, ACROSS FROM SITE. ELEV. - 827.23

ARROW ON A HYDRANT LOCATED ON THE EASTSIDE OF ROCHESTER

ROAD, AT THE SOUTHWEST AREA OF THE SITE. ELEV. - 820.86

ARROW W/DIMPLE ON A HYDRANT LOCATED ON THE NORTH SIDE OF EDDINGTON BLVD. WEST OF FARNBOROUGH DRIVE. ELEV. - 814.85


REF. BM (NOWAK & FRAUS) ARROW ON A HYDRANT LOCATED AT THE SOUTHEAST SIDE OF THE DRIVE-THRU OF FIFTH-THIRD BANK (1383 ROCHESTER RD). ELEV. - 820.48

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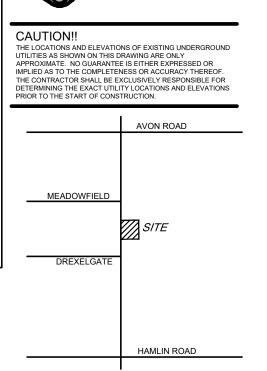








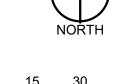



EIG14T

CLIENT

3221 W. BIG BEAVER ROAD, SUITE 111 TROY, MICHIGAN 48084

PROJECT TITLE


PRIMROSE SCHOOL VACANT LOT - ROCHESTER ROAD ROCHESTER HILLS, OAKLAND COUNTY, MICHIGAN


REVISIONS SITE PLAN APPROVAL RESUBMITTAL 04-19-23 SITE PLAN APPROVAL RESUBMITTAL 05-25-23 SITE PLAN APPROVAL RESUBMITTAL 06-23-2 ORIGINAL ISSUE DATE: FEBRUARY 10, 2023

DRAWING TITLE **PRELIMINARY GRADING PLAN**

PEA JOB NO. 2022-1301 BLA DRAWING NUMBER:

NOT FOR CONSTRUCTION CITY FILE NO. 22-041 SECTION 23

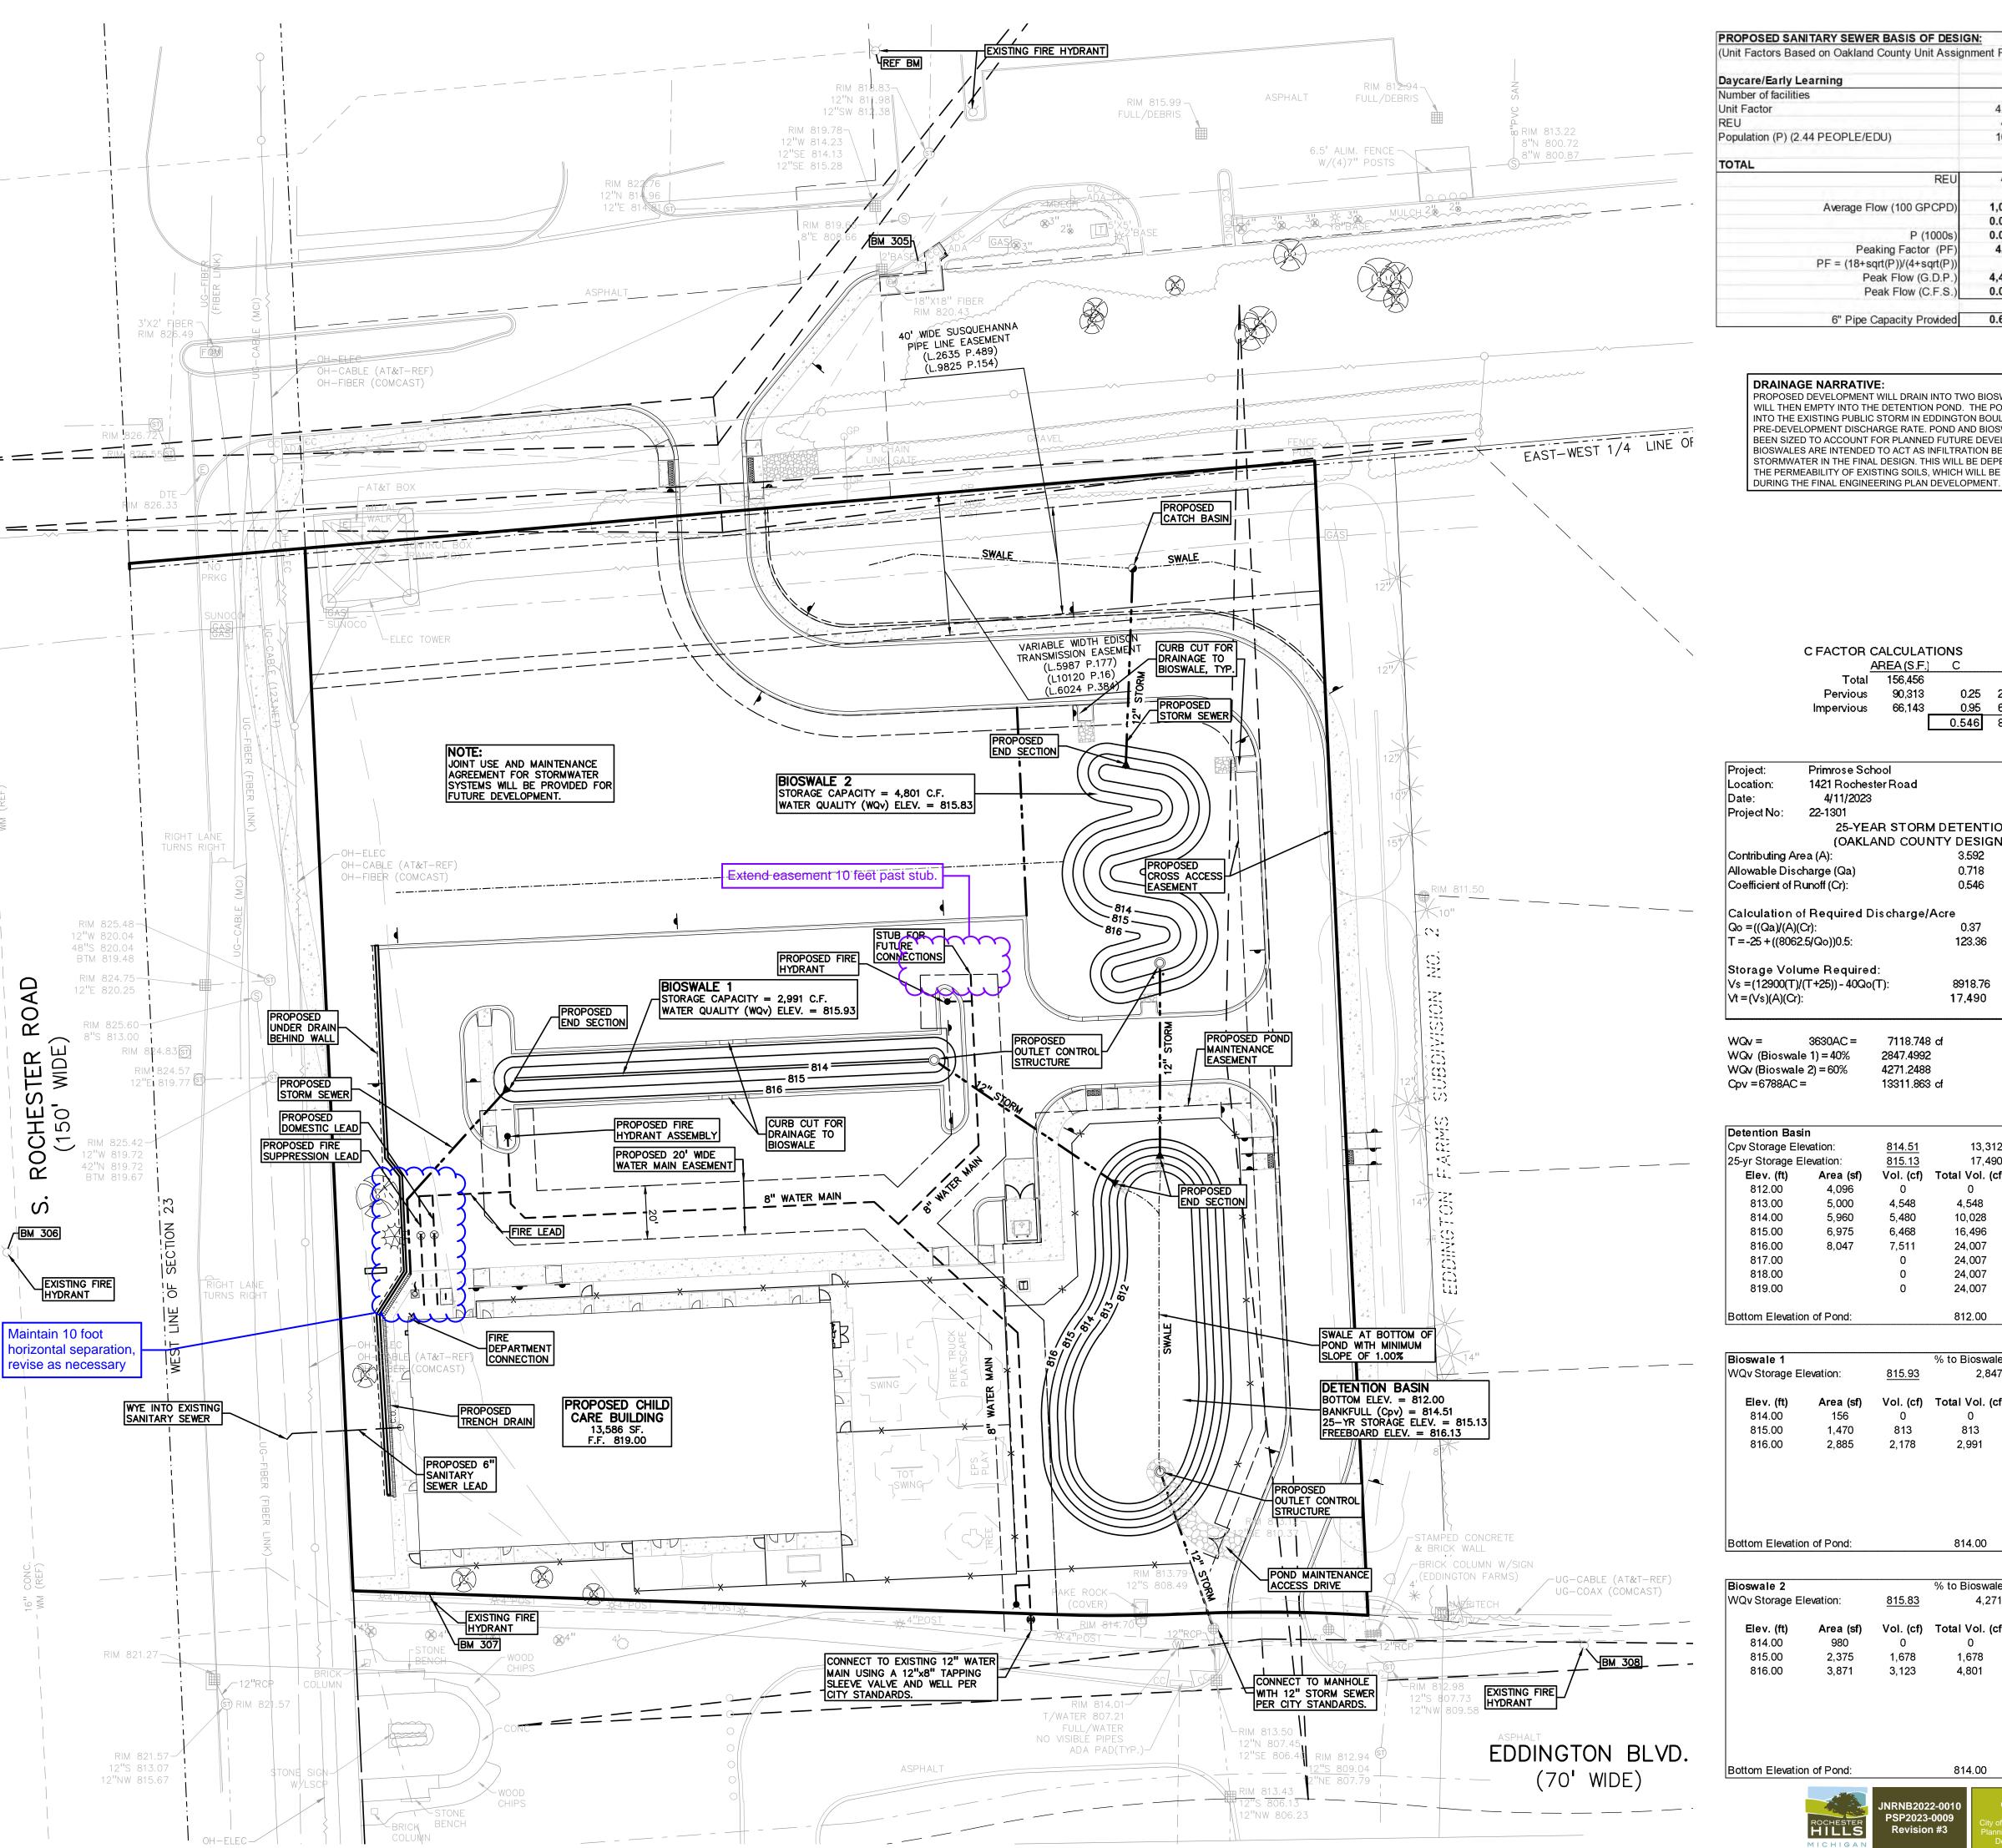

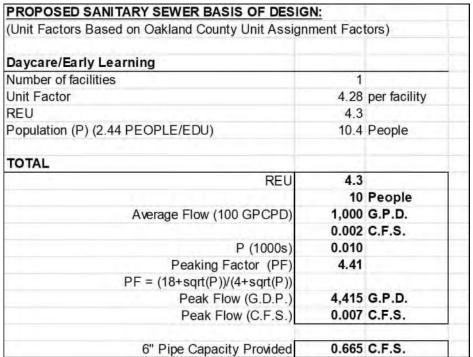

DRAINAGE NARRATIVE: PROPOSED DEVELOPMENT WILL DRAIN INTO TWO BIOSWALES THAT WILL THEN EMPTY INTO THE DETENTION POND. THE POND WILL DRAIN INTO THE EXISTING PUBLIC STORM IN EDDINGTON BOULEVARD AT THE PRE-DEVELOPMENT DISCHARGE RATE POND AND BIOSWALES HAVE BEEN SIZED TO ACCOUNT FOR PLANNED FUTURE DEVELOPMENT. THE BIOSWALES ARE INTENDED TO ACT AS INFILTRATION BEDS FOR STORMWATER IN THE FINAL DESIGN. THIS WILL BE DEPENDENT UPON THE PERMEABILITY OF EXISTING SOILS, WHICH WILL BE TESTED

C FACTOR CALCULATIONS AREA (S.F.) C

0.25 22,578.25

0.95 62,835.85

0.546 85,414.10

Primrose School 1421 Rochester Road 4/11/2023 22-1301 25-YEAR STORM DETENTION DESIGN (OAKLAND COUNTY DESIGN METHOD) 3.592 acres 0.718 CFS (0.2 CFS/acre) Allowable Discharge (Qa) 0.546 Coefficient of Runoff (Cr):

Calculation of Required Discharge/Acre 0.37 T = -25 + ((8062.5/Qo))0.5: 123.36 Storage Volume Required: 8918.76


3630AC = 7118.748 df Total Between Two Bioswales WQv (Bioswale 1) = 40% 2847.4992 Bioswale 1 WQv (Bioswale 2) = 60% 4271.2488 Bioswale 2 13311.863 cf bankfull

17,490

PMS 4 43 PMS	1			
Detention Basi	ın			
Cpv Storage Ele	evation:	<u>814.51</u>	13,312	cf
25-yr Storage E	levation:	<u>815.13</u>	17,490	cf
Elev. (ft)	Area (sf)	Vol. (cf)	Total Vol. (cf)	
812.00	4,096	0	0	
813.00	5,000	4,548	4,548	
814.00	5,960	5,480	10,028	
815.00	6,975	6,468	16,496	
816.00	8,047	7,511	24,007	
817.00		0	24,007	
818.00		0	24,007	
819.00		0	24,007	
Bottom Elevation	n of Pond:		812.00	

Bioswale 1			% to Bioswale	1 = 3559.374 cf * 0.40
WQv Storage El	levation:	<u>815.93</u>	2,847	cf
Elev. (ft)	Area (sf)	Vol. (cf)	Total Vol. (cf)	
814.00	156	0	0	
815.00	1,470	813	813	
816.00	2,885	2,178	2,991	
Bottom Elevatio			814.00	

oswale 2			% to Bioswale 2 = 3559.374 cf * 0	0.60
Qv Storage Elevation:		<u>815.83</u>	4,271 cf	
Elev. (ft)	Area (sf)	Vol. (cf)	Total Vol. (cf)	
814.00	980	0	0	
815.00	2,375	1,678	1,678	
816.00	3,871	3,123	4,801	
ottom Elevatio	n of Pond:		814.00	

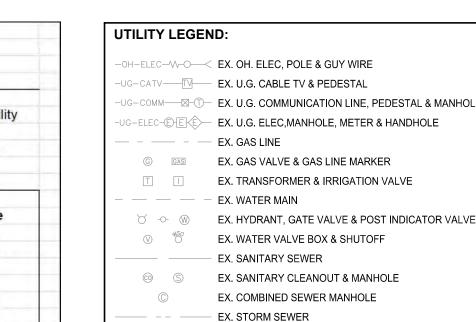

LYNNE KLEIN

t: 844.813.2949

www.peagroup.com

THE LOCATIONS AND ELEVATIONS OF EXISTING UNI UTILITIES AS SHOWN ON THIS DRAWING ARE ONLY

APPROXIMATE. NO GUARANTEE IS EITHER EXPRESSED OR IMPLIED AS TO THE COMPLETENESS OR ACCURACY THEREOF

THE CONTRACTOR SHALL BE EXCLUSIVELY RESPONSIBLE FOR

DETERMINING THE EXACT UTILITY LOCATIONS AND ELEVATIONS PRIOR TO THE START OF CONSTRUCTION.

CAUTION!!

SCALE: 1" = 30'

CONTRACTOR TO VERIFY ALL QUANTITIES. ANY DEVIATIONS TO THE PLAN QUANTITIES SHALL BE BROUGHT TO THE ATTENTION OF PEA GROUP FOR VERIFICATION, PRIOR TO BIDDING.

PREMIUM TRENCH BACKFILL NOTE: ALL UTILITIES UNDER PAVEMENT OR WITHIN 3' OF THE EDGE OF PAVEMENT (OR WITHIN THE 45° LINE OF INFLUENCE OF PAVEMENT) SHALL HAVE M.D.O. CLASS II GRANULAR BACKFILL COMPACTED TO 95% MAX. DRY DENSITY (ASTM D-1557).

PUBLIC UTILITY EASEMENTS: ALL WATER MAIN SHALL BE LOCATED IN A 20' WIDE EASEMENT.

EJ 1040 TYPE N

EX. CLEANOUT & MANHOLE

EX. YARD DRAIN & ROOF DRAIN

EX. UNIDENTIFIED STRUCTURE

PROPOSED WATER MAIN

PROPOSED STORM SEWER

EX. SQUARE, ROUND, & BEEHIVE CATCH BASIN

PROPOSED HYDRANT AND GATE VALVE

PROPOSED POST INDICATOR VALVE

○ C.O. ■ PROPOSED STORM SEWER CLEANOUT & MANHOLE

PROPOSED CATCH BASIN, INLET & YARD DRAIN

PROPOSED SANITARY SEWER

PROPOSED TAPPING SLEEVE, VALVE & WELL

PROPOSED SANITARY CLEANOUT & MANHOLE

CITY OF ROCHESTER HILLS STORM SEWER FRAME & COVER NOTES MEADOWFIELD EJ 1040 TYPE "A" COVER CATCH BASIN IN CURB
EJ 7045 WITH TYPE M1 GRATE AND 7050 T1 DREXELGATE BACK OR EQUIVALENT CATCH BASIN IN PAVED AREA EJ FRAME 5105 WITH TYPE M1 SINUSOIDAL GRATE OR EQUIVALENT CATCH BASIN IN GRASS AREA

AVON ROAD CLIENT

EIG14T 3221 W. BIG BEAVER ROAD, SUITE 111 TROY, MICHIGAN 48084

PROJECT TITLE


PRIMROSE SCHOOL VACANT LOT - ROCHESTER ROAD ROCHESTER HILLS, OAKLAND COUNTY, MICHIGAN


REVISIONS SITE PLAN APPROVAL RESUBMITTAL 04-19-23 SITE PLAN APPROVAL RESUBMITTAL 05-25-23 SITE PLAN APPROVAL RESUBMITTAL 06-23-23 ORIGINAL ISSUE DATE: FEBRUARY 10, 2023 DRAWING TITLE

PRELIMINARY UTILITY PLAN

PEA JOB NO. 2022-1301 BLA BLA DRAWING NUMBER:


NOT FOR CONSTRUCTION CITY FILE NO. 22-041 SECTION 23

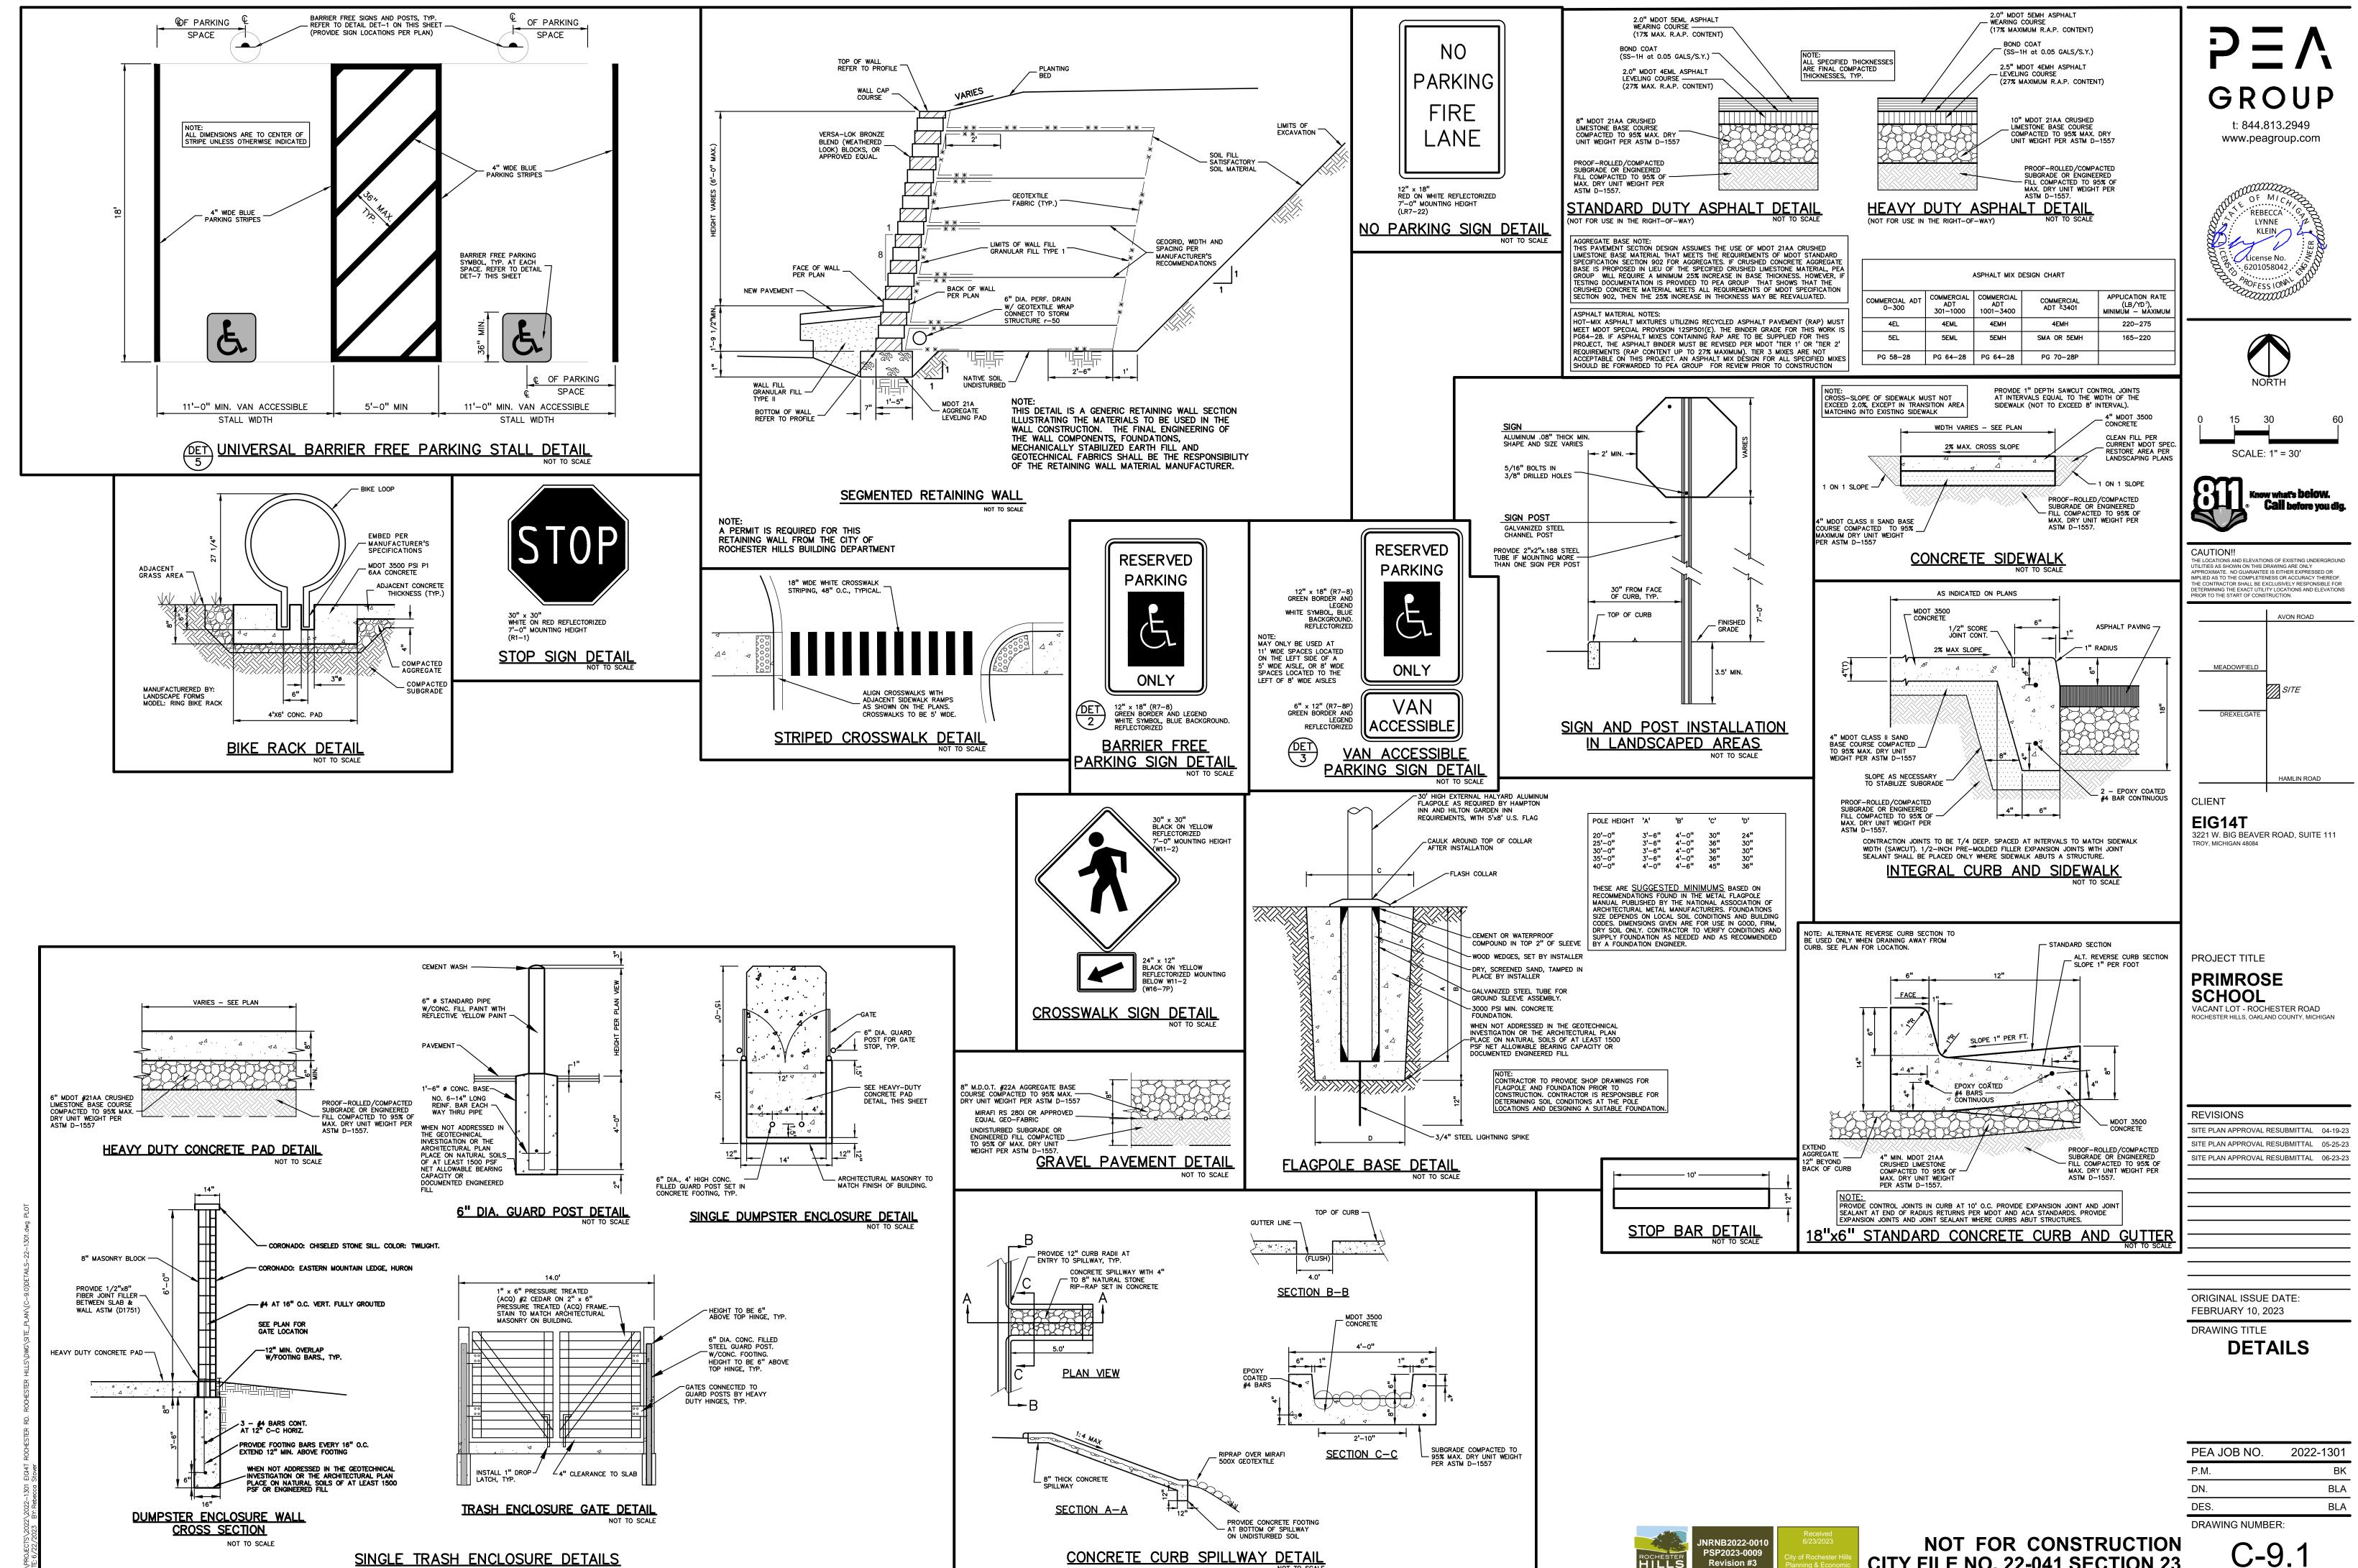


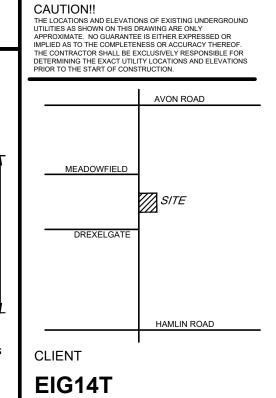




C-9.1

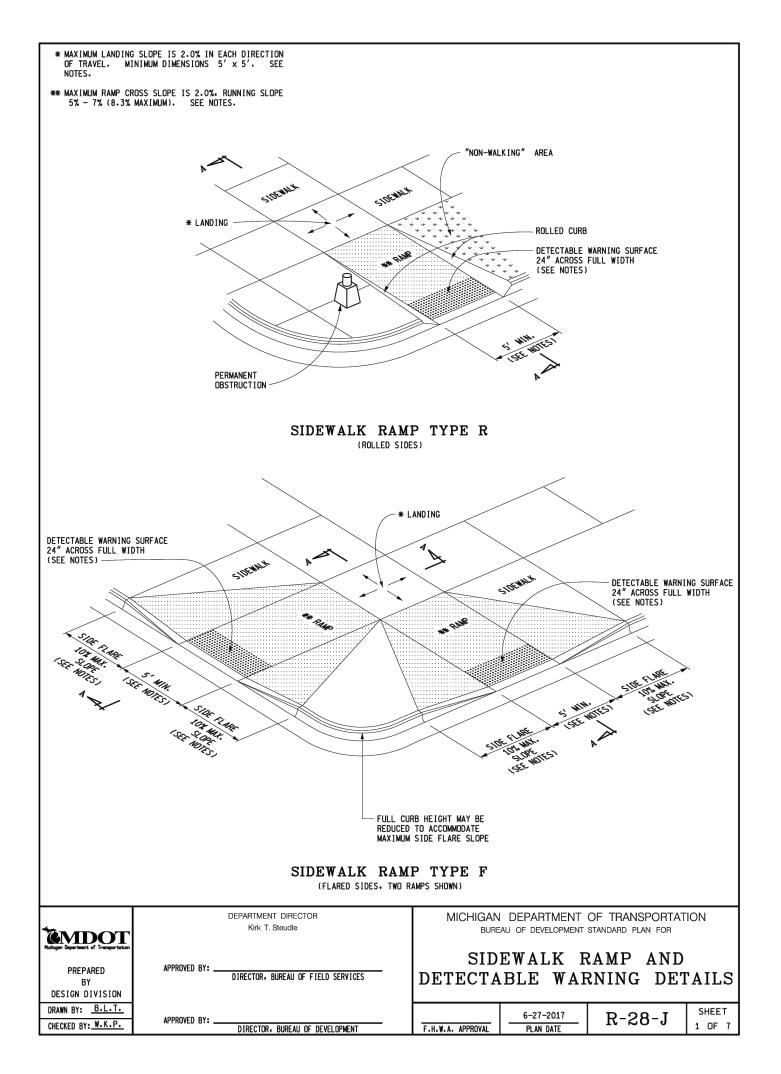

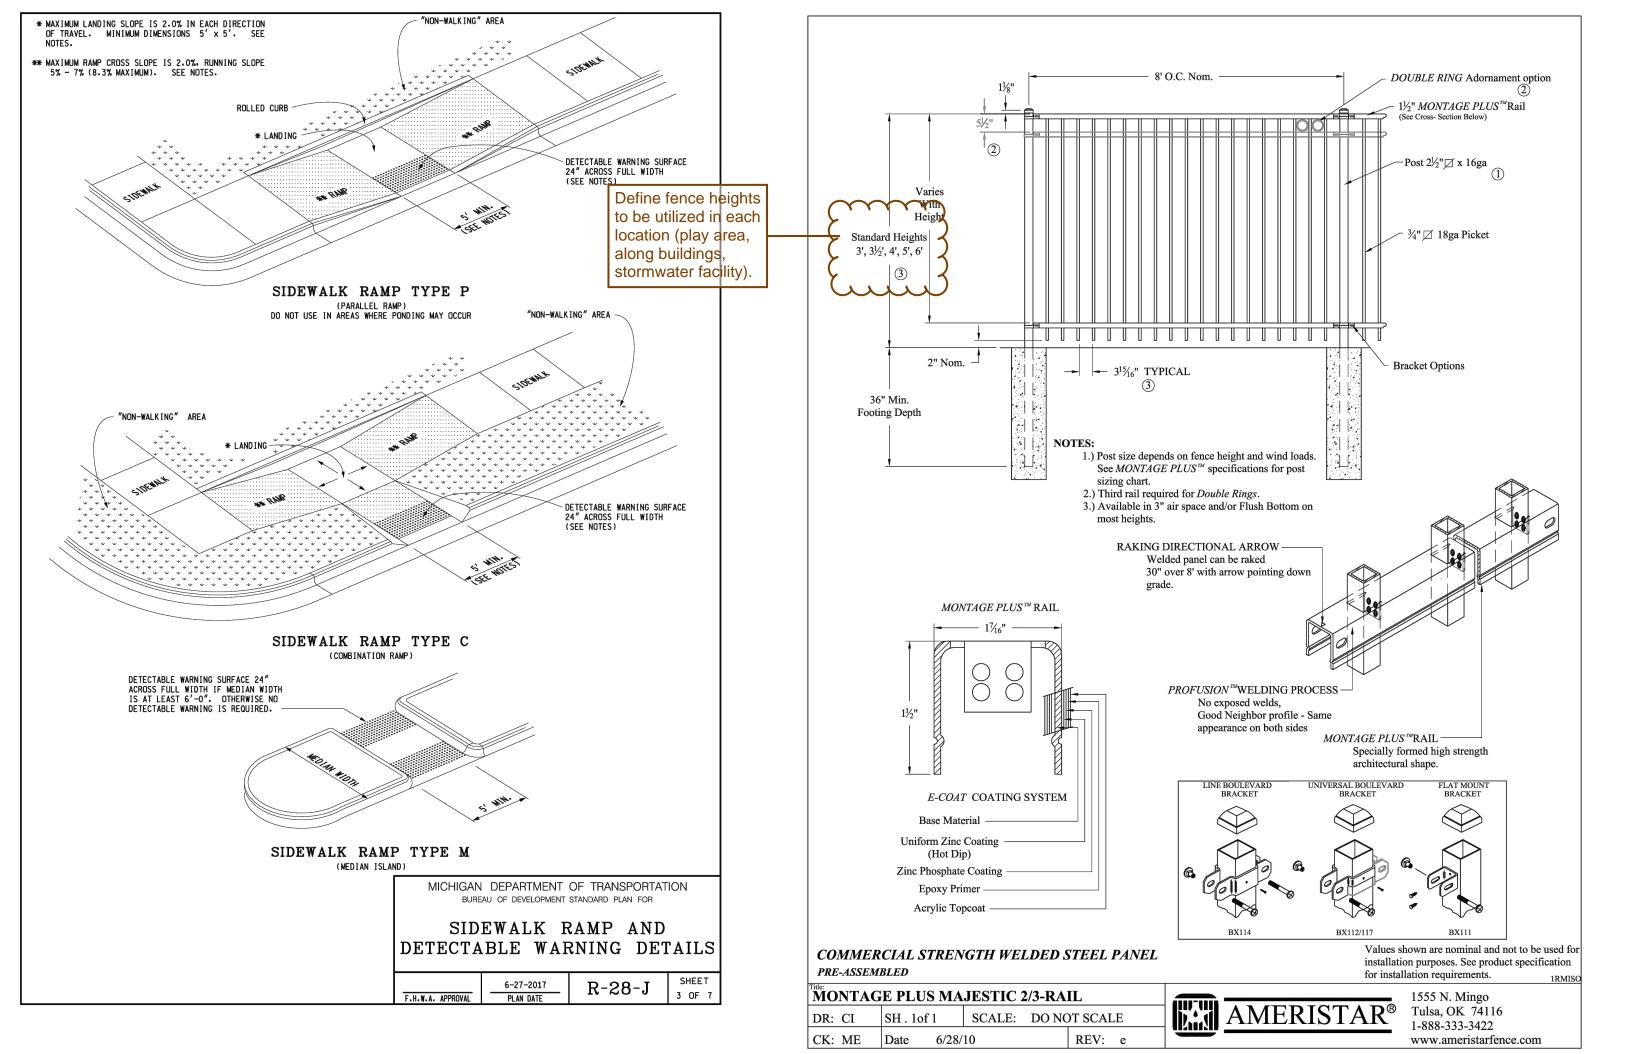

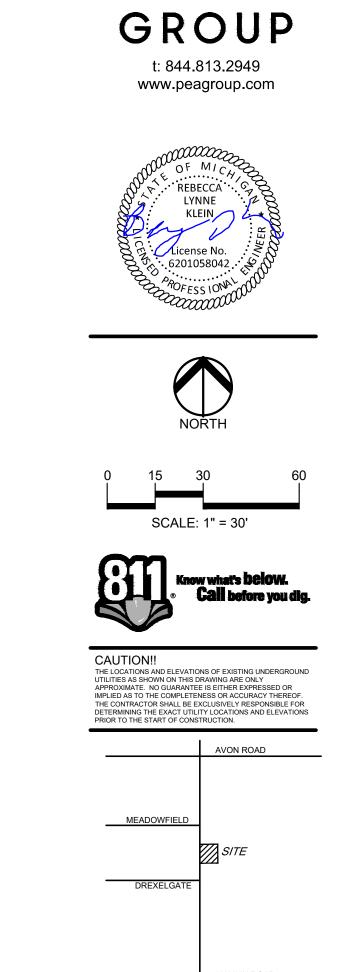


DETAILS


CITY FILE NO. 22-041 SECTION 23


2022-1301

BLA

BLA

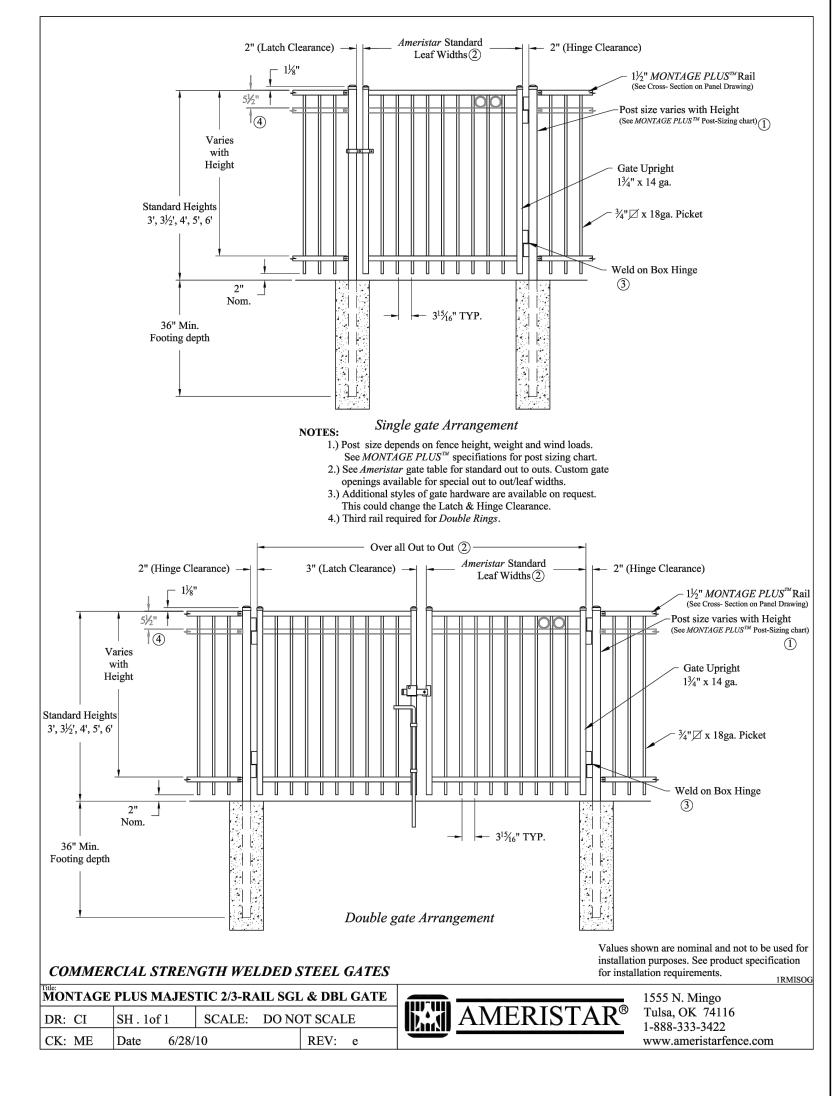

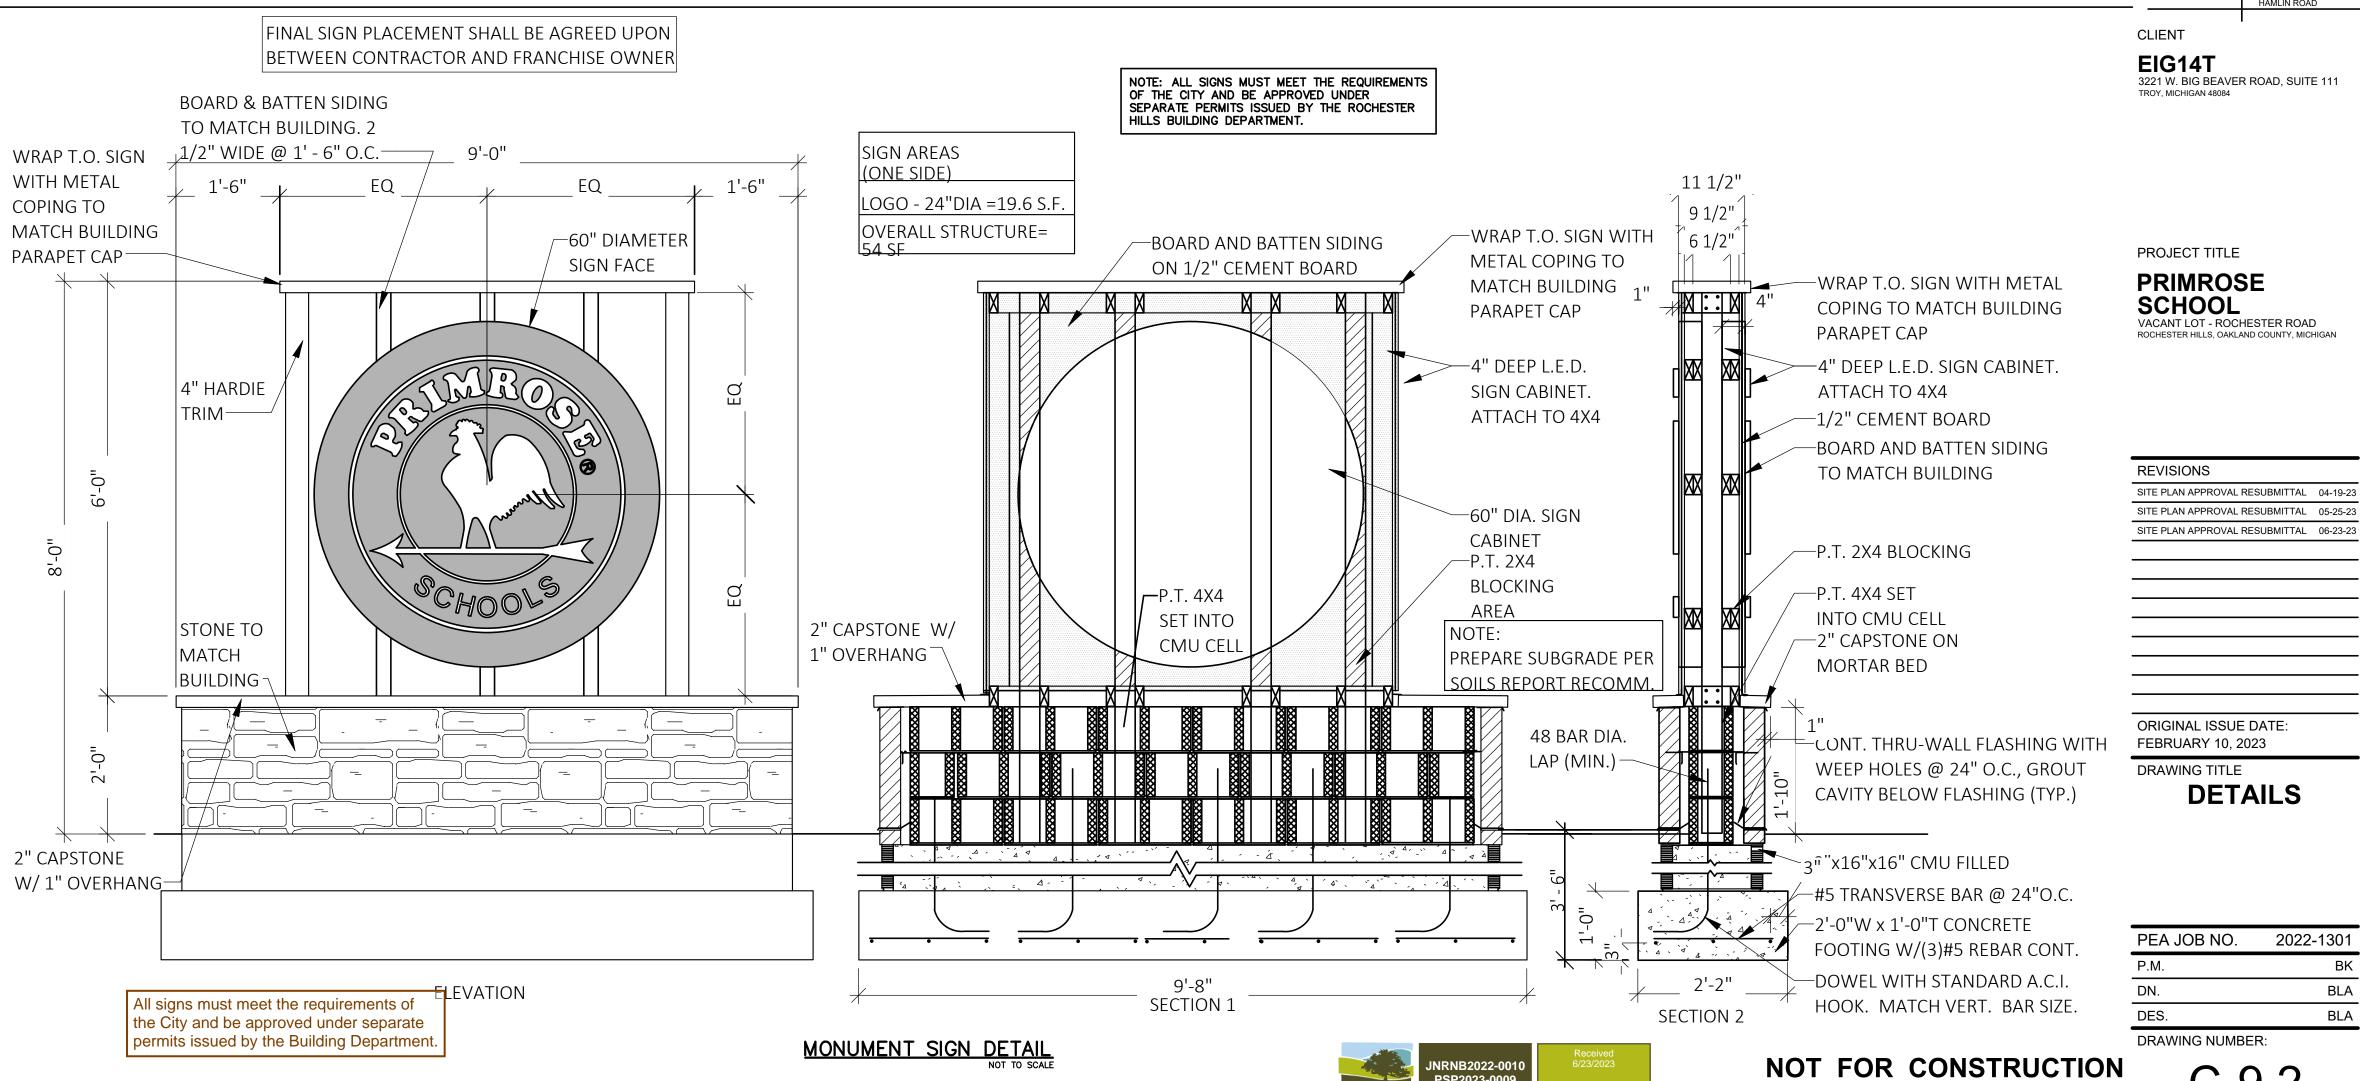

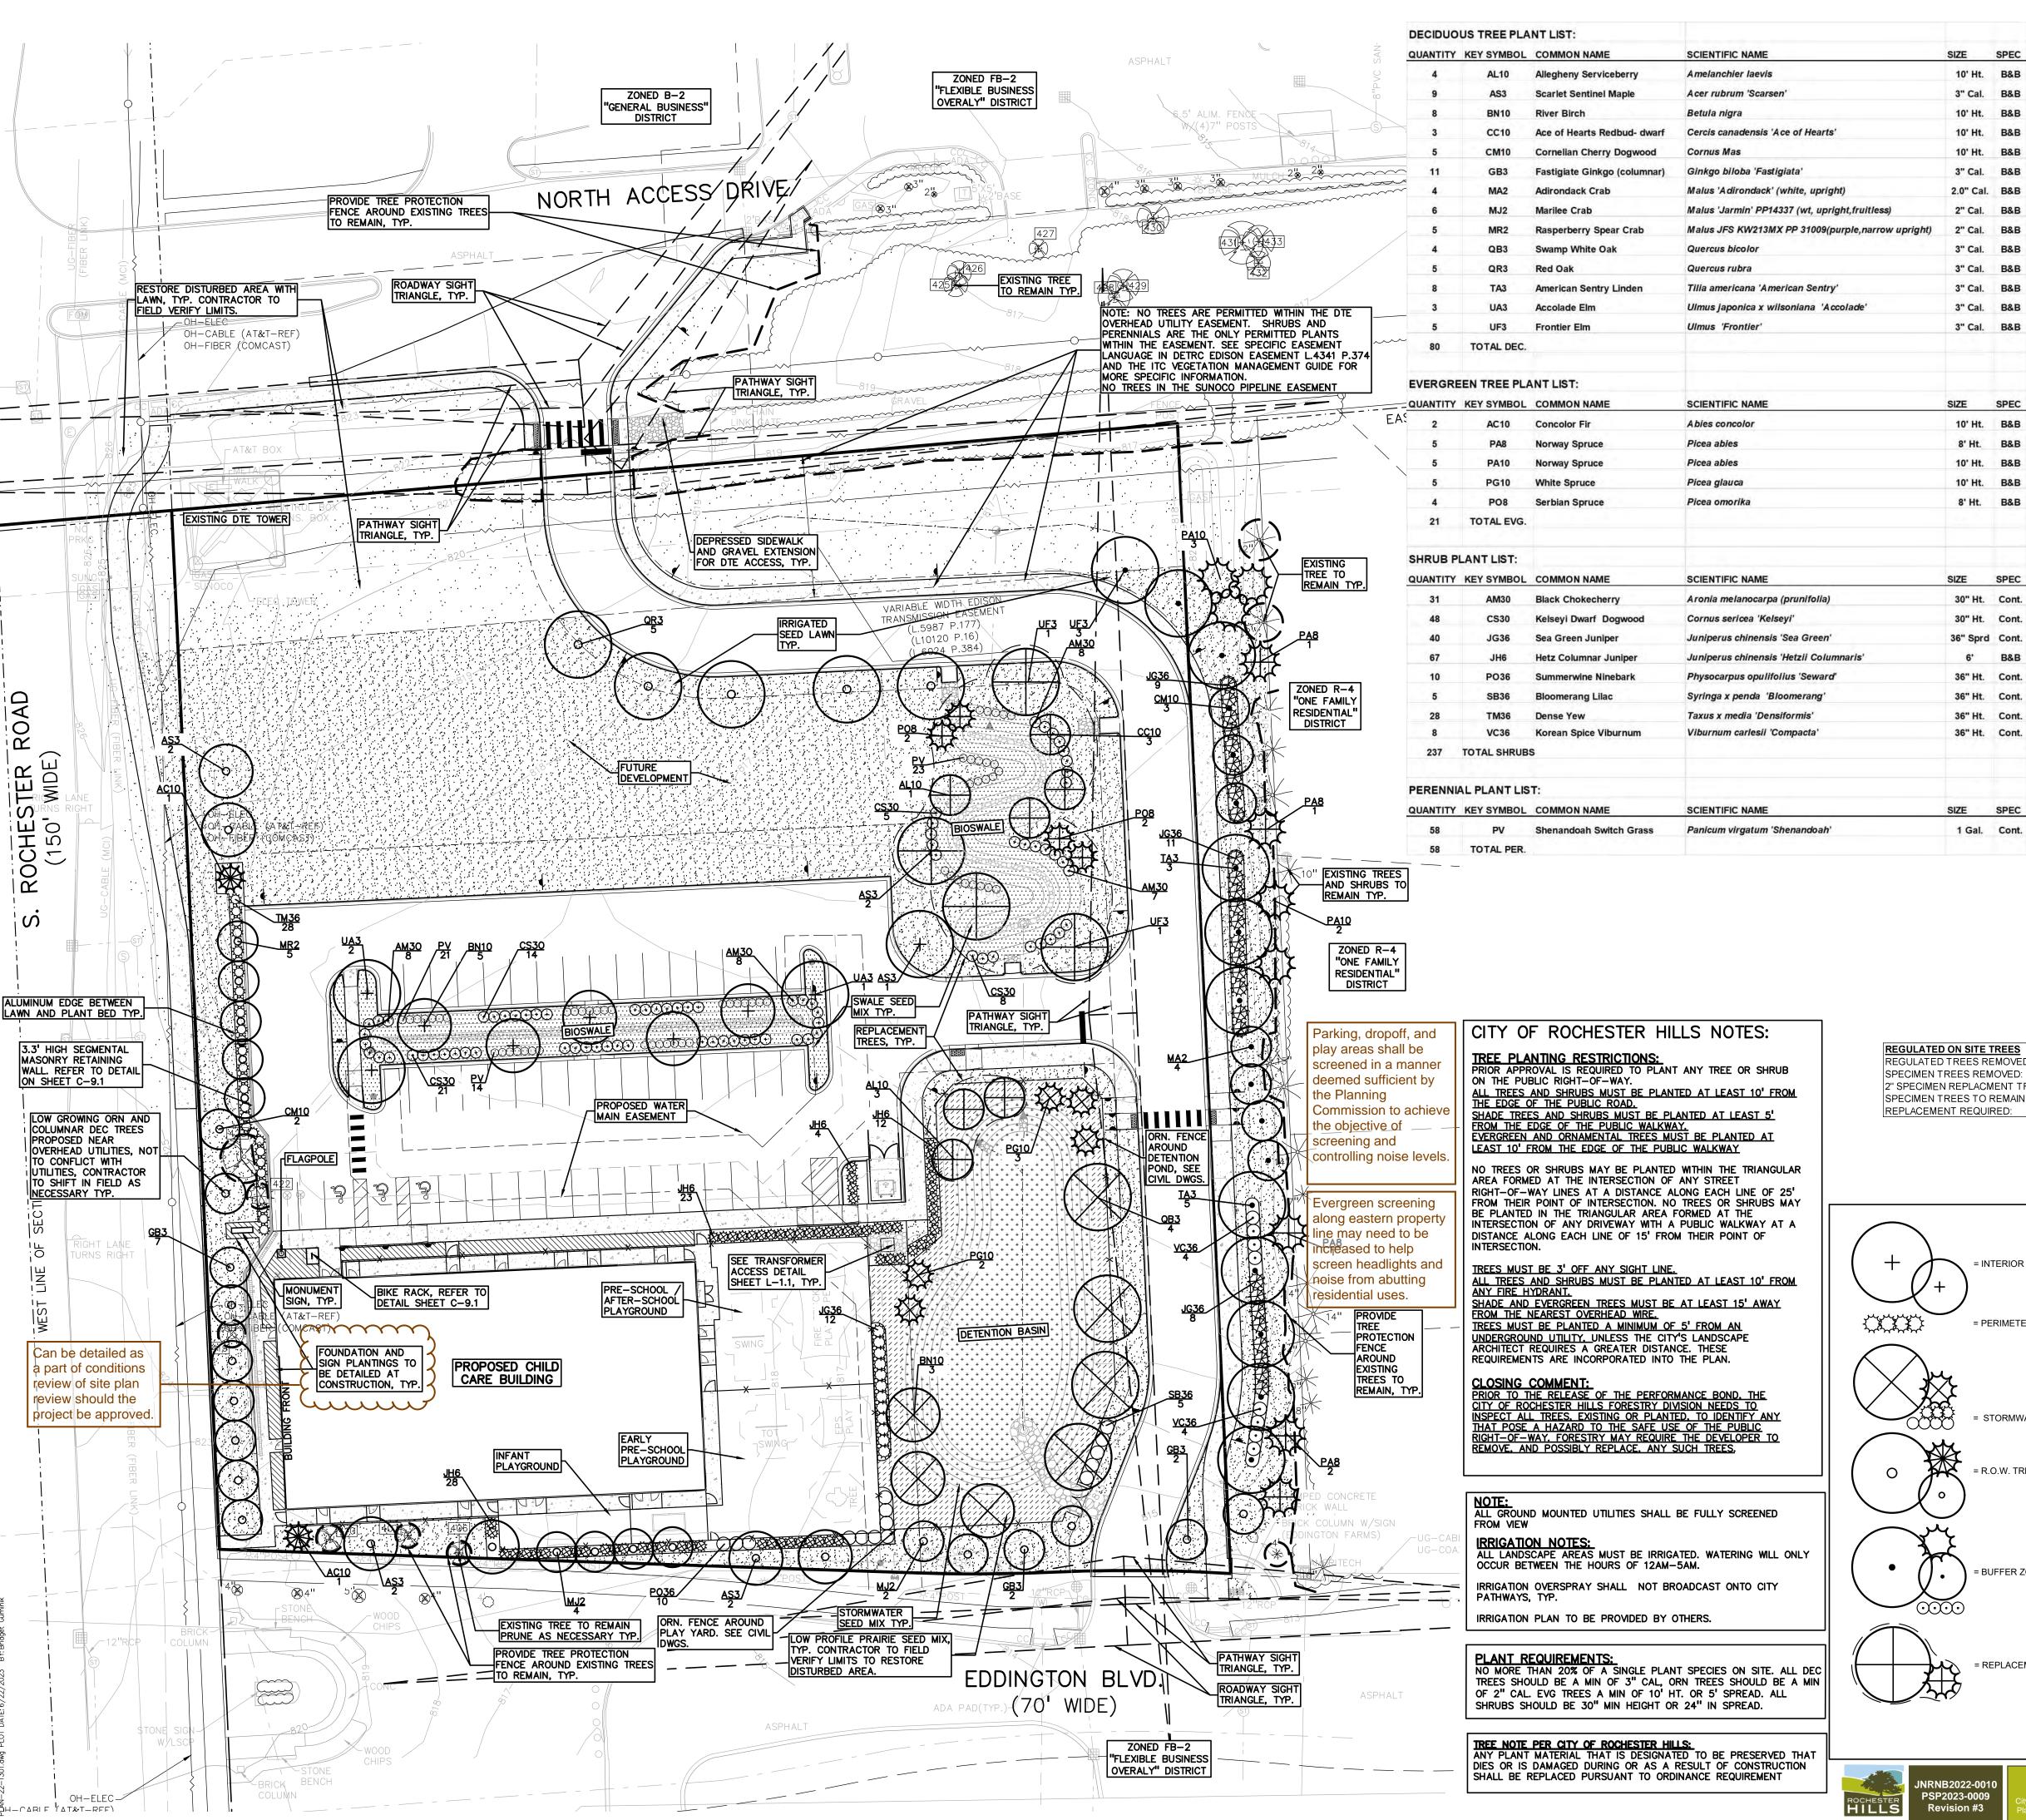

ROAD

ANDSCAPE CALCULATIONS: R-4 (ONE FAMILY RESIDENTIAL) PER CITY OF ROCHESTER HILLS ZONING ORDINANCE

INTERIOR PARKING LOT LANDSCAPE (FOR 20 CARS OR MORE)
REQUIRED: 5% OF VEHICLE USE AREA SHALL BE LANDSCAPED

TREE PER 150 SF REQUIRED 24,390.5 * 5% = 1,219.5 SQ FT, 1,219.5 SQ FT / 150 SF = 8.1 TREES EACH LANDSCAPE ISLAND SHOULD HAVE 1 DEC TREE

PROVIDED: 9 DEC TREES AND 4,012 SF LANDSCAPE ISLAND AREA

REQUIRED: 1 DEC TREE/ 25LF AND 1 ORN TREE/ 35LF, ALONG EDGE OF PARKING LOT FACING AND WITHIN 100' OF PUBLIC ROW. ANY PARKING WITHIN 30' OF PUBLIC STREET OR ROW REQUIRES A VEGETATIVE HEDGE FOR SCREENING.

PROVIDED: PARKING IS NOT WITHIN 100' OF PUBLIC ROW WHERE FACING PUBLIC ROAD - NO TREES REQUIRED OR PROVIDED PARKING LOT IS LOCATED WITHIN 30' OF ROW ALONG S. ROCHESTER RD. 28 EVG SHRUBS PROVIDED IN HEDGE ROW.

STORMWATER MANAGEMENT POND LANDSCAPING

REQUIRED: TYPE A BUFFER: 1.5 DEC. 1 EVG TREE AND 4 SHRUBS / 100 LF WITH DEC TREES CLUSTERED AROUND THE S AND W SIDE OF THE BASIN. PLANTINGS / SEED NATIVE TO MICHIGAN 422.7 LF PER / 100 = 4.2

PROVIDED: 7 DEC, 5 EVG AND 17 SHRUBS AND SPECIAL SEED MIXES PROPOSED BY STANTEC, SEE SHEET L-1.1 FOR DETAILS

REQUIRED: 1 DEC OR EVG TREE / 35 LF AND 1 ORN TREE / 60 LF OF ROW. NORTH ACCESS DR: 450'/35 = 13 DEC. OR EVG. TREES 450'/60 = 8 ORN TREES.

S. ROCHESTER RD: 433'/35 = 13 DEC. OR EVG. TREES 433'/60 = 8 ORN. TREES. EDDINGTON BLVD: 380'/35 = 11 DEC. OR EVG. TREES 380'/60 = 6 ORN. TREES.

NORTH ACCESS DR: 18 EXISTING TREES TO REMAIN WITHIN ROW - NO ADDITIONAL TREES TO BE PROVIDED IN OR ADJACENT TO THE ROW DUE TO EXISTING UTILITIES AND EASEMENTS. 5 TREES PROVIDED SOUTH OF N ACCESS DR PER CITY REQUEST

S. ROCHESTER RD: NO ADDITIONAL TREES TO BE PROVIDED IN THE ROW DUE TO EXISTING UTILITIES AND EASEMENTS. TREES ARE LOCATED ADJACENT TO ROW. 1 EXISTING DEC TO REMAIN AND 9 PROPOSED DEC, 1 EXISTING EVG TO REMAIN AND 2 PROPOSED EVG, AND 1 EXISTING ORN TO REMAIN AND 7 PROPOSED ORN PROPOSED.

EDDINGTON BLVD: 3 EXISTING TREES TO REMAIN, 8 DEC TREES AND 6 ORN. TREES PROPOSED

BUFFER ZONE TYPE D. WHEN MAJORITY OF PROPERTY IS DEVELOPED FOR COMMERCIAL USE, PER SECTION 138-8.602 AND ARTICLE 12 (EAST PROP. LINE) REQUIRED: WHERE ABUTS ONE FAMILY DWELLINGS 2.5 DEC, 1.5 ORN, 5 EVG AND 8 SHRUBS PER EVERY 100 LF 437.6 LF / 100 = 4.4 (* 2.5, 1.5, 5, AND 8 =)= 11 DEC, 7 ORN, 22 EVG AND 36 SHRUBS

PROVIDED: 17 EXISTING EVG, 5 PROPOSED EVG, 11 PROPOSED DEC, 7 ORN, AND 36 SHRUBS LANDSCAPE BERM PROVIDED WHERE TREES CANNOT BE PROVIDED DUE TO EXISTING UTILITIES AND EASEMENTS.

SCREENING AT PLAYGROUND FENCE AND DUMPSTER:
REQUIRED: PER CITY COMMENT, SCREEN WITH 80 % OPACITY WITH EVERGREEN UPRIGHT PLANTINGS AND SHRUBS PROVIDED: UPRIGHT EVERGREEN SHRUBS ADJ TO FENCE AND DUMPSTER

REPLACEMENT TREES REQUIRED: 1 TREE REPLACED PER 1 TREE REMOVED (NOT INCLUDING SPECIMEN) (REPLACEMENT TREES CANNOT GO TOWARDS OTHER REQUIRED TREES) 29 REPLACEMENT TREES REQUIRED -SEE TREE SHEET T-1.0 OR THIS SHEET FOR CALC DETAILS

PROVIDED: 11, 3" DEC. AND 9, 8' HT. EVG. TREES 16 TREES PAID INTO TREE FUND IN LIEU OF PROPOSED PLANTING

REGULATED ON SITE TREES REGULATED TREES REMOVED:


SPECIMEN TREES REMOVED: 2" SPECIMEN REPLACMENT TREES: SPECIMEN TREES TO REMAIN ON-SITE: REPLACEMENT REQUIRED:

TREES (3" DECIDUOUS OR 8' EVERGREEN) TREES (3" DECIDUOUS OR 8' EVERGREEN)

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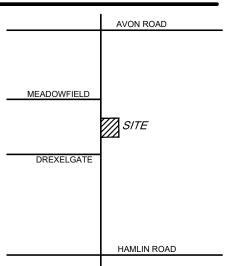






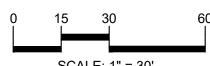

CAUTION ILITIES AS SHOWN ON THIS DRAWING ARE ONLY MPLIED AS TO THE COMPLETENESS OR ACCURACY THEREO IE CONTRACTOR SHALL BE EXCLUSIVELY RESPONSIBLE FOR DETERMINING THE EXACT UTILITY LOCATIONS AND ELEVATIONS PRIOR TO THE START OF CONSTRUCTION.




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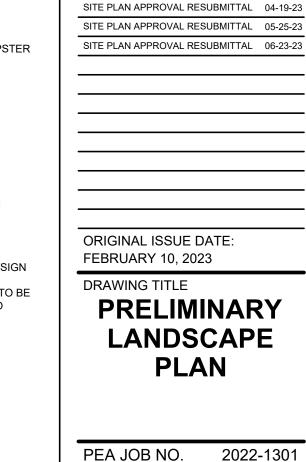
3221 W. BIG BEAVER ROAD, SUITE 111 TROY, MICHIGAN 48084

PROJECT TITLE

REVISIONS

PRIMROSE SCHOOL VACANT LOT - ROCHESTER ROAD ROCHESTER HILLS, OAKLAND COUNTY, MICHIGAN



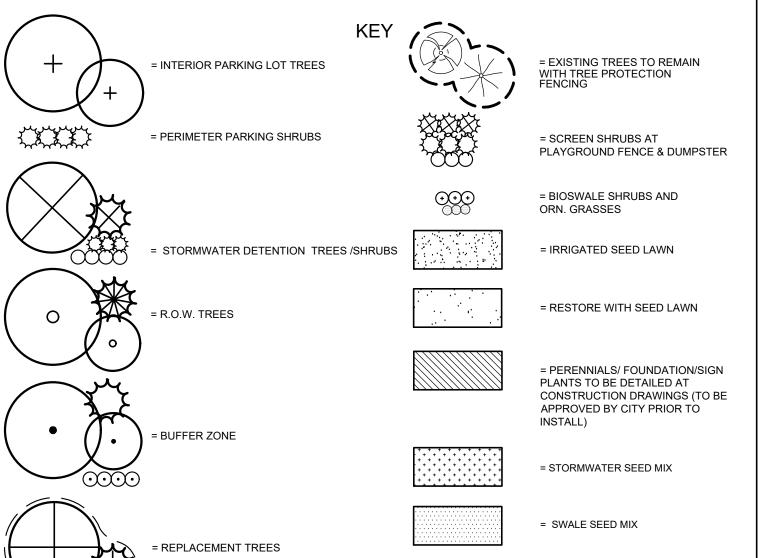

CITY FILE NO. 22-041 SECTION 23

= LOW PROFILE PRAIRIE SEED MIX

SEE L-1.1 FOR PLANTINGS NOTES AND DETAILS DRAWING NUMBER: NOT FOR CONSTRUCTION

BGG

JLE

PER CITY OF ROCHESTER HILLS MAINTENANCE AGREEMENT:

Section 138-12.109 Maintenance

- The owner of the property shall be responsible for all maintenance of site landscaping, as follows:
- Landscaping shall be kept in a neat, orderly and healthy growing condition, free from debris and refuse. B. Pruning shall be minimal at the time of installation, only to remove dead or diseased branches. Subsequent pruning shall assure proper maturation of plants to achieve their approved purpose.
- C. All dead, damaged, or diseased plant material shall be removed immediately and replaced within six (6) months after it dies or in the next planting season, whichever occurs first. For purposes of this Section, the planting season for deciduous plants shall be between March 1 and June 1 and from October 1 until the prepared soil becomes frozen. The planting season for evergreen plants shall be between March 1 and June 1. Plant material installed to replace dead or diseased material shall be as close as practical to the size of the material it is intended to replace. The City may notify property owners of the need to replace dead, damaged, or diseased material.
- D. The approved landscape plan shall be considered a permanent record and integral part of the Site Plan Approval. Unless otherwise approved in accordance with the aforementioned procedures, any revisions to or removal of plant materials, or non-compliance with the maintenance requirements of this Section 138-12.109 will place the parcel in non-conformity with the approved landscape plan and be a violation of this
- E. If protected trees are damaged, a fine shall be issued on an inch-by-inch basis at a monetary rate as defined by the Forestry Department.

LANDSCAPE COST OPINION:

LANDSCAPING

PLAN									
QUANTITY	UNIT	DESCRIPTION	UNIT PRICE	ITEM PRICE					
5,930	S.Y.	SEED LAWN	\$2.50	\$14,825.00					
27	EA.	SUB CANOPY ORNAMENTAL TREES AT 2" CAL.	\$350.00	\$9,450.00					
51	EA.	DECIDUOUS TREES AT 3" CAL.	\$550.00	\$28,050.00					
23	EA.	EVERGREEN TREES AT 8' HT.	\$450.00	\$10,350.00					
49	C.Y.	MULCH 3"	\$50.00	\$2,450.00					
97	C.Y.	PLANT MIX FOR BEDS (6" DEPTH)	\$55.00	\$5,335.00					
1,051	L.F.	ALUMINUM EDGING	\$5.00	\$5,255.00					
2	C.Y.	RIVER ROCK	\$85.00	\$170.00					
58	EA.	PERENNIALS	\$20.00	\$1,160.00					
237	EA.	SHRUBS	\$55.00	\$13,035.00					
9	EA.	TREES TO BE PAID INTO THE TREE FUND	\$304.00	\$2,736.00					
1	AC.	IRRIGATION (COMMERCIAL BUILDING)	\$21,000.00	\$21,000.00					
1,940	S.Y.	SPECIALTY SEED MIXES	\$3.00	\$5,820					
1	25%	CONTINGENCY	\$24,511.25	\$24,511.25					
		TOTAL LANDSCAPING		\$144,147.25					
LAWN RESTORATION NIC									

GENERAL PLANTING NOTES:

- LANDSCAPE CONTRACTOR SHALL VISIT SITE, INSPECT EXISTING SITE CONDITIONS AND REVIEW PROPOSED PLANTING AND RELATED WORK. IN CASE OF DISCREPANCY BETWEEN PLAN AND PLANT LIST, PLAN SHALL GOVERN QUANTITIES. CONTACT LANDSCAPE ARCHITECT WITH ANY CONCERNS.
- 2. CONTRACTOR SHALL VERIFY LOCATIONS OF ALL ON SITE UTILITIES PRIOR TO BEGINNING CONSTRUCTION ON HIS/HER PHASE OF WORK. ELECTRIC, GAS, TELEPHONE, CABLE TELEVISION MAY BE LOCATED BY CALLING MISS DIG 1-800-482-7171. ANY DAMAGE OR INTERRUPTION OF SERVICES SHALL BE THE RESPONSIBILITY OF CONTRACTOR. CONTRACTOR SHALL COORDINATE ALL RELATED ACTIVITIES WITH OTHER TRADES ON THE JOB AND SHALL REPORT ANY UNACCEPTABLE JOB CONDITIONS TO OWNER'S REPRESENTATIVE PRIOR TO COMMENCING.
- . ALL PLANT MATERIAL TO BE PREMIUM GRADE NURSERY STOCK AND SHALL SATISFY AMERICAN ASSOCIATION OF NURSERYMEN STANDARD FOR NURSERY STOCK. ALL LANDSCAPE MATERIAL SHALL BE NORTHERN GROWN, NO. 1. GRADE.
- 4. CONTRACTOR IS RESPONSIBLE FOR VERIFYING ALL QUANTITIES SHOWN ON LANDSCAPE PLAN PRIOR TO PRICING THE WORK.
- 5. THE OWNER'S REPRESENTATIVE RESERVES THE RIGHT TO REJECT ANY PLANT MATERIAL NOT MEETING SPECIFICATIONS.
- 6. ALL SINGLE STEM SHADE TREES TO HAVE STRAIGHT TRUNKS AND SYMMETRICAL CROWNS.
- 7. ALL SINGLE TRUNK SHADE TREES TO HAVE A CENTRAL LEADER; TREES WITH FORKED OR IRREGULAR TRUNKS WILL NOT BE ACCEPTED.
- 8. ALL MULTI STEM TREES SHALL BE HEAVILY BRANCHED AND HAVE SYMMETRICAL CROWNS. ONE SIDED TREES OR THOSE WITH THIN OR OPEN CROWNS SHALL NOT BE ACCEPTED. 9. ALL EVERGREEN TREES SHALL BE HEAVILY BRANCHED AND FULL TO THE GROUND, SYMMETRICAL
- IN SHAPE AND NOT SHEARED FOR THE LAST FIVE GROWING SEASONS. 10. ALL TREES TO HAVE CLAY OR CLAY LOAM BALLS, TREES WITH SAND BALLS WILL BE REJECTED.
- 11. NO MACHINERY IS TO BE USED WITHIN THE DRIP LINE OF EXISTING TREES; HAND GRADE ALL
- LAWN AREAS WITHIN THE DRIP LINE OF EXISTING TREES.
- 12. ALL TREE LOCATIONS SHALL BE STAKED BY LANDSCAPE CONTRACTOR AND ARE SUBJECT TO THE APPROVAL OF THE LANDSCAPE ARCHITECT PRIOR TO INSTALLATION OF THE PLANT MATERIAL.
- 13. IT IS MANDATORY THAT POSITIVE DRAINAGE IS PROVIDED AWAY FROM ALL BUILDINGS. 14. ALL PLANTING BEDS SHALL RECEIVE 4" SHREDDED HARDWOOD BARK MULCH WITH PRE EMERGENT,
- SEE SPECIFICATIONS. SHREDDED PALETTE AND DYED MULCH WILL NOT BE ACCEPTED. 15. ALL LANDSCAPED AREAS SHALL RECEIVE 4" COMPACTED TOPSOIL.
- 16. SEE SPECIFICATIONS FOR ADDITIONAL COMMENTS, REQUIREMENTS, PLANTING PROCEDURES AND WARRANTY STANDARDS.
- 17. FOR NON-LAWN SEED MIX AREAS, AS NOTED ON PLAN, BRUSH MOW ONCE SEASONALLY FOR INVASIVE SPECIES CONTROL.
- 18. CONTRACTOR SHALL NOT INSTALL PLANTS UNDER BUILDING OVERHANG AND SHALL NOTIFY LANDSCAPE ARCHITECT IF DRAWINGS CONFLICT WITH BUILDING OVERHANGS.
- 19. TREES SHALL NOT CONFLICT/ BLOCK PROPOSED REGULATORY/ DIRECTION SIGNAGE, MONUMENT SIGNS, ADDRESS OR LIGHT POLES. SHIFT TREES AS NECESSARY TYP.

FOR ALL SEED MIXES, PROVIDE EROSION MAT ON SLOPES AND AREAS OF WASH OUT TYP. INSTALL AND PREP PER MANUFACTURES SPECIFICATIONS. SEED MIX TO BE NATIVE PER COUNTY, NO INVASIVE SPECIES PERMITTED

Low-profile Prairie Seed Mix

Botanical Name

Carex spp.

Permanent Grasses

Elymus canadensis

Panicum virgatum

Temporary Cover:

Lolium multiflorum

Amorpha canescens

Anemone cylindrica

Asclepias syriaca

Asclepias tuberosa

Coreopsis palmata

Echinacea purpurea

Lespedeza capitata

Liatris aspera

Lupinus perennis

Monarda fistulosa

Oligoneuron rigidum

Penstemon digitalis

Penstemon hirsutus

Ratibida pinnata

Rudbeckia hirta

Solidago speciosa

Verbena stricta

Vernonia spp.

Pycnanthemum virginianum

Rudbeckia subtomentosa

Silphium terebinthinaceun

Symphyotrichum ericoides

Symphyotrichum laeve

Tradescantia ohiensis

Veronicastrum virginicum

Dalea candida

Dalea purpurea

Baptisia alba

Avena sativa

Koeleria pyramidata

Schizachyrium scoparium

Bouteloua curtipendula

stantec.com/native-plant-nursery

Stantec Native Plant Nursery 574-586-2412

Swale Seed Mix Stantec Native Plant Nursery 574-586-2412 stantec.com/native-plant-nursery Botanical Name Common Name

Andropogon gerardii Carex comosa Bristly Sedge Carex cristatella Crested Oval Sedge Carex lurida Bottlebrush Sedge Carex spp. Prairie Sedge Mix Carex vulpinoidea Brown Fox Sedge Elymus virginicus Virginia Wild Rye Glyceria striata Fowl Manna Grass Panicum virgatum Switch Grass Scirpus atrovirens Dark Green Rush Scirpus cyperinus Wool Grass Spartina pectinata Prairie Cord Grass

Temporary Cover: Avena sativa Common Oat Lolium multiflorum Annual Rve

Alisma spp.

Iris virginica

Sagittaria latifolia

Senna hebecarpa

Verbena hastata

Zizia aurea

Asclepias incarnata Swamp Milkweed Coreopsis tripteris Tall Coreopsis Eutrochium maculatun Spotted Joe-Pve Weed Liatris spicata Marsh Blazing Star Lobelia cardinalis Cardinal Flower Lobelia siphilitica Great Blue Lobelia Lycopus americanus Common Water Horehound Pycnanthemum virginianum Common Mountian Mint Rudbeckia triloba

Brown-Eved Susan Common Arrowhead Wild Senna Silphium terebinthinaceum Prairie Dock Symphyotrichum novae-angli: New England Aster Blue Vervain Golden Alexanders

Butterfly MilkWeed White Wild Indiao Chamaecrista fasciculata Partridge Pea Coreopsis lanceolata Sand Coreopsis Prairie Coreopsis White Prairie Clover Purple Prairie Clove Desmanthus illinoensis Illinois Sensitive Plan Broad-Leaved Purple Coneflower Eryngium yuccifolium Rattlesnake Master Round-Head Bush Clover Rough Blazing Star Wild Lupine Wild Bergamot Stiff Goldenrod Parthenium integrifolium Wild Quinine Foxglove Beard Tongue

Hairy Beard Tongue

Yellow Coneflower

Black-Eyed Susan

Showy Goldenrod

Smooth Blue Aster

Common Spiderwort

Ironweed (Various Mix

Hoary Vervain

Culvers Root

Prairie Dock

Heath Aster

Symphyotrichum novae-angliae New England Aster

Common Mountain Mint

Sweet Black-Eyed Susan

Common Name

Side Oats Grama

Prairie Carex Mix

Canada Wild Rye

June Grass

Switch Grass

Little Bluestem

Common Oat

ThimbleWeed

Common Milkweed

Annual Rye

<u> Botanical Name</u> Permanent Grasses/Sedges/Rushes Bolboschoenus fluviatilis Carex cristatella Carex lurida

River Bulrush Crested Oval Sedge Bottlebrush Sedge Brown Fox Sedge Virginia Wild Rye Fowl Manna Grass Common Rush Rice Cut Grass Panicum virgatum Switch Grass Schoenoplectus tabernaemontani Softstem Bulrush Dark Green Rush Scirpus atrovirens Scirpus cyperinus Wool Grass

Temporary Cover: Avena sativa Lolium multiflorum

Forbs & Shrubs Alisma spp. Asclepias incarnata Bidens spp. Helenium autumnale Lycopus americanus Oligoneuron riddellii Penthorum sedoides Polygonum spp. Rudbeckia subtomentosa Rudbeckia triloba Sagittaria latifolia Senna hebecarpa Wild Senna

Symphyotrichum novae-angliae

Thalictrum dasycarpum

Stormwater Seed Mix Stantec Native Plant Nursery 574-586-2412 stantec.com/native-plant-nursery

Common Name Carex vulpinoidea Elymus virginicus Glyceria striata Juncus effusus Leersia oryzoides

Common Oat

Annual Rye Water Plantain (Various Mix) Swamp Milkweed Bidens (Various Mix) Common Water Horehound Riddell's Goldenrod Ditch Stonecrop Pinkweed (Various Mix) Sweet Black-Eved Susan Brown-Eved Susan Common Arrowhead

New England Aster

Purple Meadow Rue

PERMALOC ALUMINUM EDGING OR APPROVED EQUAL WITH BLACK FINISH - BED MEDIA - COMPACTED SUBGRADE SPECIFICATIONS FOR LANDSCAPE BED EDGING: LANDSCAPE BED EDGING SHALL BE ALUMINUM AS MANUFACTURED BY PERMALOC 1.800.356.9660 8' OR 16' SECTIONS SHALL BE USED WITH ONE STAKE PER 38" OF

VARIES PER

SPECIES SEE

PLAN FOR

PLANT PERENNIALS EQUAL DISTANCE IN

UNLESS NOTED OR GRAPHICALLY SHOWN

4" SHREDDED BARK MULCH. DO NOT

PILE MULCH AGAINST PLANT STEMS

SHOVEL CUT EDGE OR ALUMINUM

EDGING AS INDICATED ON PLAN

— SPECIFIED PLANTING MIX

NOTE: REMOVE ALL CONTAINERS PRIOR

PLANT SO THAT TOP OF ROOT BALL IS

FLUSH TO GRADE OR 1-2" HIGHER IF

DO NOT COVER TOP OF ROOTBALL

IN POORLY DRAINED SOILS

FORM SAUCER WITH 4" HIGH

WITH SOIL

ALL SPACING IS TO BE TRIANGULAR

OTHERWISE

TO PLANTING

EDGING SHALL BE 3" THICK X 4" DEPTH WHEN ADJ. TO MULCH AND 경" THICK X 5 ½" DEPTH WHEN ADJ. TO ROCK, FINISH: BLACK DURAFLEX MEETING AAMA 2603

STAKE SHALL SECURELY ENGAGE EDGING AND SHALL BE ENTIRELY BELOW TOP SURFACE OF EDGING

EDGING SHALL HAVE A MINIMUM OF 2" OF INTERLOCKING OVERLAP BETWEEN SECTIONS

INSTALL AS PER MANUFACTURER'S SPECIFICATIONS WITH TOP OF EDGING $\frac{1}{4}$ " - $\frac{1}{2}$ " ABOVE COMPACTED FINISH GRADE. FINISH GRADE TO BE COMPACTED ON BOTH SIDES OF EDGING TO MAINTAIN STABILITY

ALUMINUM EDGE DETAIL

SPECIES SE

PLAN FOR

QUANTITY


PLAN VIEW

SECTION VIEW

SCALE: 1'' = 2'-0''

PERENNIAL PLANTING DETAIL

SCALE: 1/2'' = 1'-0''

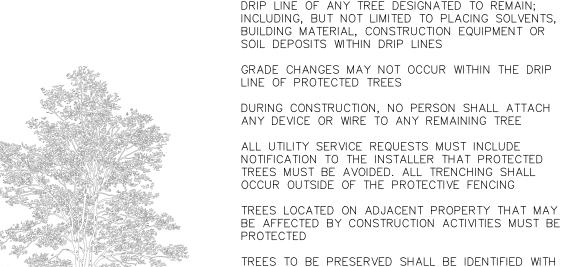

TREE PROTECTION DETAIL

SCALE: 1'' = 3' - 0''

MIN. TYP.

SCALE: 1'' = 3'-0''

START OF CONSTRUCTION ACTIVITIES AND SHALL REMAIN IN PLACE UNTIL CONSTRUCTION IS COMPLETE NO PERSON MAY CONDUCT ANY ACTIVITY WITHIN THE DRIP LINE OF ANY TREE DESIGNATED TO REMAIN; INCLUDING, BUT NOT LIMITED TO PLACING SOLVENTS, BUILDING MATERIAL, CONSTRUCTION EQUIPMENT OR SOIL DEPOSITS WITHIN DRIP LINES

TREE PROTECTION WILL BE ERECTED PRIOR TO

GRADE CHANGES MAY NOT OCCUR WITHIN THE DRIP

DURING CONSTRUCTION, NO PERSON SHALL ATTACH ANY DEVICE OR WIRE TO ANY REMAINING TREE

NOTIFICATION TO THE INSTALLER THAT PROTECTED TREES MUST BE AVOIDED. ALL TRENCHING SHALL OCCUR OUTSIDE OF THE PROTECTIVE FENCING TREES LOCATED ON ADJACENT PROPERTY THAT MAY

BE AFFECTED BY CONSTRUCTION ACTIVITIES MUST BE

OPERATIONS PROVIDE FENCE AROUND CRITICAL ROOT ZONE OF

FLAGGING PRIOR TO THE TREE CLEARING

FENCE SHALL BE PLACED IN A CIRCLE WITH A MINIMUM RADIUS OF 1' PER 1" DIAMETER OF THE TREE MEASURED AT 4.5' ABOVE GROUND

4'HIGH PROTECTIVE FENCING WITH STEEL POSTS - 10' O.C. - EXISTING SOIL

CAUTION!! THE LOCATIONS AND ELEVATIONS OF EXISTING UNDERGROUND UTILITIES AS SHOWN ON THIS DRAWING ARE ONLY APPROXIMATE. NO GUARANTEE IS EITHER EXPRESSED OR IMPLIED AS TO THE COMPLETENESS OR ACCURACY THEREOF. THE CONTRACTOR SHALL BE EXCLUSIVELY RESPONSIBLE FOR DETERMINING THE EXPORT HIS CONTRACTOR SHALL BE EXCLUSIVELY RESPONSIBLE FOR DETERMINING THE EXPORT HIS LOCATIONS AND ELEVATIONS.

GROUP

t: 844.813.2949

www.peagroup.com

ANDSCAPE

DETERMINING THE EXACT UTILITY LOCATIONS AND ELEVAPRIOR TO THE START OF CONSTRUCTION. AVON ROAD MEADOWFIELD STAKE JUST BELOW BRANCHES WITH 2"-3" WIDE NYLON OR PLASTIC STRAPS. CONNECT SITE FLEXIBILITY. REMOVE AFTER (1) ONE YEAR. DREXELGATE THREE 2"X2" HARDWOOD STAKES OR STEEL HAMLIN ROAD

DRIPLINE. 4" DEEP AND LEAVE 3" CIRCLE OF

EIG14T 3221 W. BIG BEAVER ROAD, SUITE 111

TROY, MICHIGAN 48084

SPECIFIED PLANTING MIX, WATER & TAMP TO - REMOVE AIR POCKETS, AMEND SOIL PER SITE CONDITIONS & TREE REQUIREMENTS EXPOSE ROOT FLARE OF TREE. CONTRACTOR MAY HAVE TO REMOVE EXCESS SOIL FROM -TOP OF ROOTBALL. REMOVE ALL BURLAP FROM TOP $\frac{1}{3}$ OF ROOTBALL. DISCARD ALL NON-BIODEGRADABLE MATERIAL OFF SITE

PLANT SO THAT TOP OF ROOT BALL IS

FROM TREE TO STAKE AND ALLOW FOR

T-POSTS DRIVEN A MIN. OF 18" DEEP

SHREDDED HARDWOOD BARK MULCH TO

PLACE MULCH IN CONTACT WITH TREE

TRUNK. FORM SAUCER WITH 4" HIGH

BARE SOIL AROUND TREE TRUNK. DO NOT

FIRMLY INTO SUBGRADE PRIOR TO

POORLY DRAINED SOILS

(DO NOT USE WIRE & HOSE)

BACKFILLING

- FINISH GRADE

CONTINUOUS RIM

FLUSH TO GRADE OR 1-2" HIGHER IF IN

PLACE ROOTBALL ON UNEXCAVATED OR TAMPED SOIL

PROJECT TITLE **PRIMROSE** SCHOOL VACANT LOT - ROCHESTER ROAD

REVISIONS

ROCHESTER HILLS, OAKLAND COUNTY, MICHIGAN

SITE PLAN APPROVAL RESUBMITTAL 04-19-23

SITE PLAN APPROVAL RESUBMITTAL 05-25-23

ORIGINAL ISSUE DATE:

FEBRUARY 10, 2023

DRAWING TITLE

PLANT SO THAT TOP OF ROOT BALL IS FLUSH TO GRADE OR 1-2" HIGHER IF IN POORLY DRAINED SOILS SECURE TREE WRAP WITH BIODEGRADABLE MATERIAL AT TOP & BOTTOM, REMOVE AFTER FIRST WINTER DO NOT PRUNE TERMINAL LEADER PRUNE ONLY DEAD, BROKEN BRANCHES AS DIRECTED BY LANDSCAPE ARCHITECT

> STAKE JUST BELOW BRANCHES WITH 2"-3" WIDE NYLON OR PLASTIC STRAPS. CONNECT FROM TREE TO STAKE AND ALLOW FOR FLEXIBILITY. REMOVE AFTER (1) ONE YEAR (DO NOT USE WIRE & HOSE)

(3) THREE 2"X2" HARDWOOD STAKES DRIVEN A MIN. OF 18" DEEP FIRMLY INTO SUBGRADE PRIOR TO BACKFILLING

SHREDDED HARDWOOD BARK MULCH TO DRIPLINE. 4" DEEP AND LEAVE 3" CIRCLE OF BARE SOIL AROUND TREE TRUNK. DO NOT PLACE MULCH IN CONTACT WITH TREE TRUNK. FORM SAUCER WITH 4" HIGH CONTINUOUS RIM

SPECIFIED PLANTING MIX, WATER & TAMP TO REMOVE AIR POCKETS, AMEND SOIL PER SITE CONDITIONS & TREE REQUIREMENTS

-FINISH GRADE

EXPOSE ROOT FLARE OF TREE. CONTRACTOR MAY HAVE TO REMOVE EXCESS SOIL FROM - TOP OF ROOTBALL. REMOVE ALL BURLAP FROM TOP $\frac{1}{3}$ OF ROOTBALL. DISCARD ALL NON-BIODEGRADABLE MATERIAL OFF SITE PLACE ROOTBALL ON UNEXCAVATED OR


NOT FOR CONSTRUCTION

PEA JOB NO. 2022-1301 P.M. BK DN. BGG JLE DRAWING NUMBER:

LANDSCAPE

DETAILS

CITY FILE NO. 22-041 SECTION 23

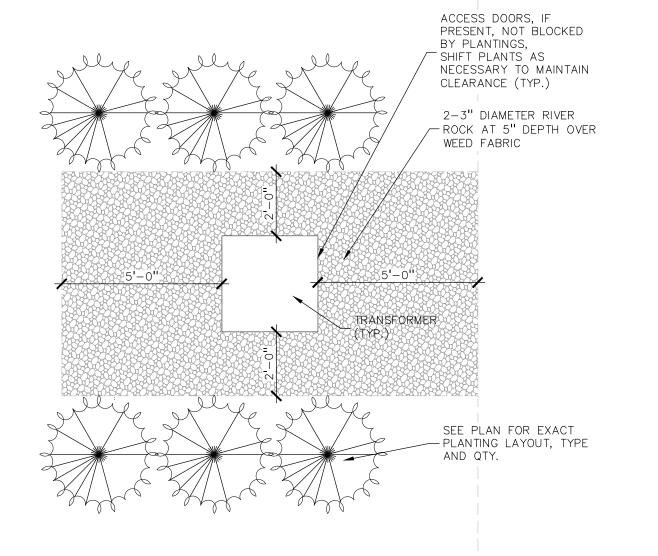

TRANSFORMER SCREENING DETAIL SCALE: 1'' = 3'-0''

CONTINUOUS RIM SHREDDED HARDWOOD BARK MULCH 4" DEEP AND LEAVE 3" CIRCLE OF BARE SOIL AROUND TRUNK. DO NOT PLACE MULCH IN CONTACT WITH TRUNK - FINISH GRADE SPECIFIED PLANTING MIX. WATER AND TAMP TO REMOVE AIR POCKETS REMOVE ALL BURLAP FROM TOP 1/3 OF -ROOTBALL DISCARD ALL NON-BIODEGRADABLE MATERIAL OFF SITE VARIES ON CONTAINER OR BALL SIZE PLACE ROOTBALL ON UNEXCAVATED OR TAMPED SOIL


SHRUB PLANTING DETAIL SCALE: 1'' = 2' - 0''

STAKING/GUYING

<u>LOCATION</u>

DECIDUOUS TREE PLANTING DETAIL

EVERGREEN TREE PLANTING DETAIL

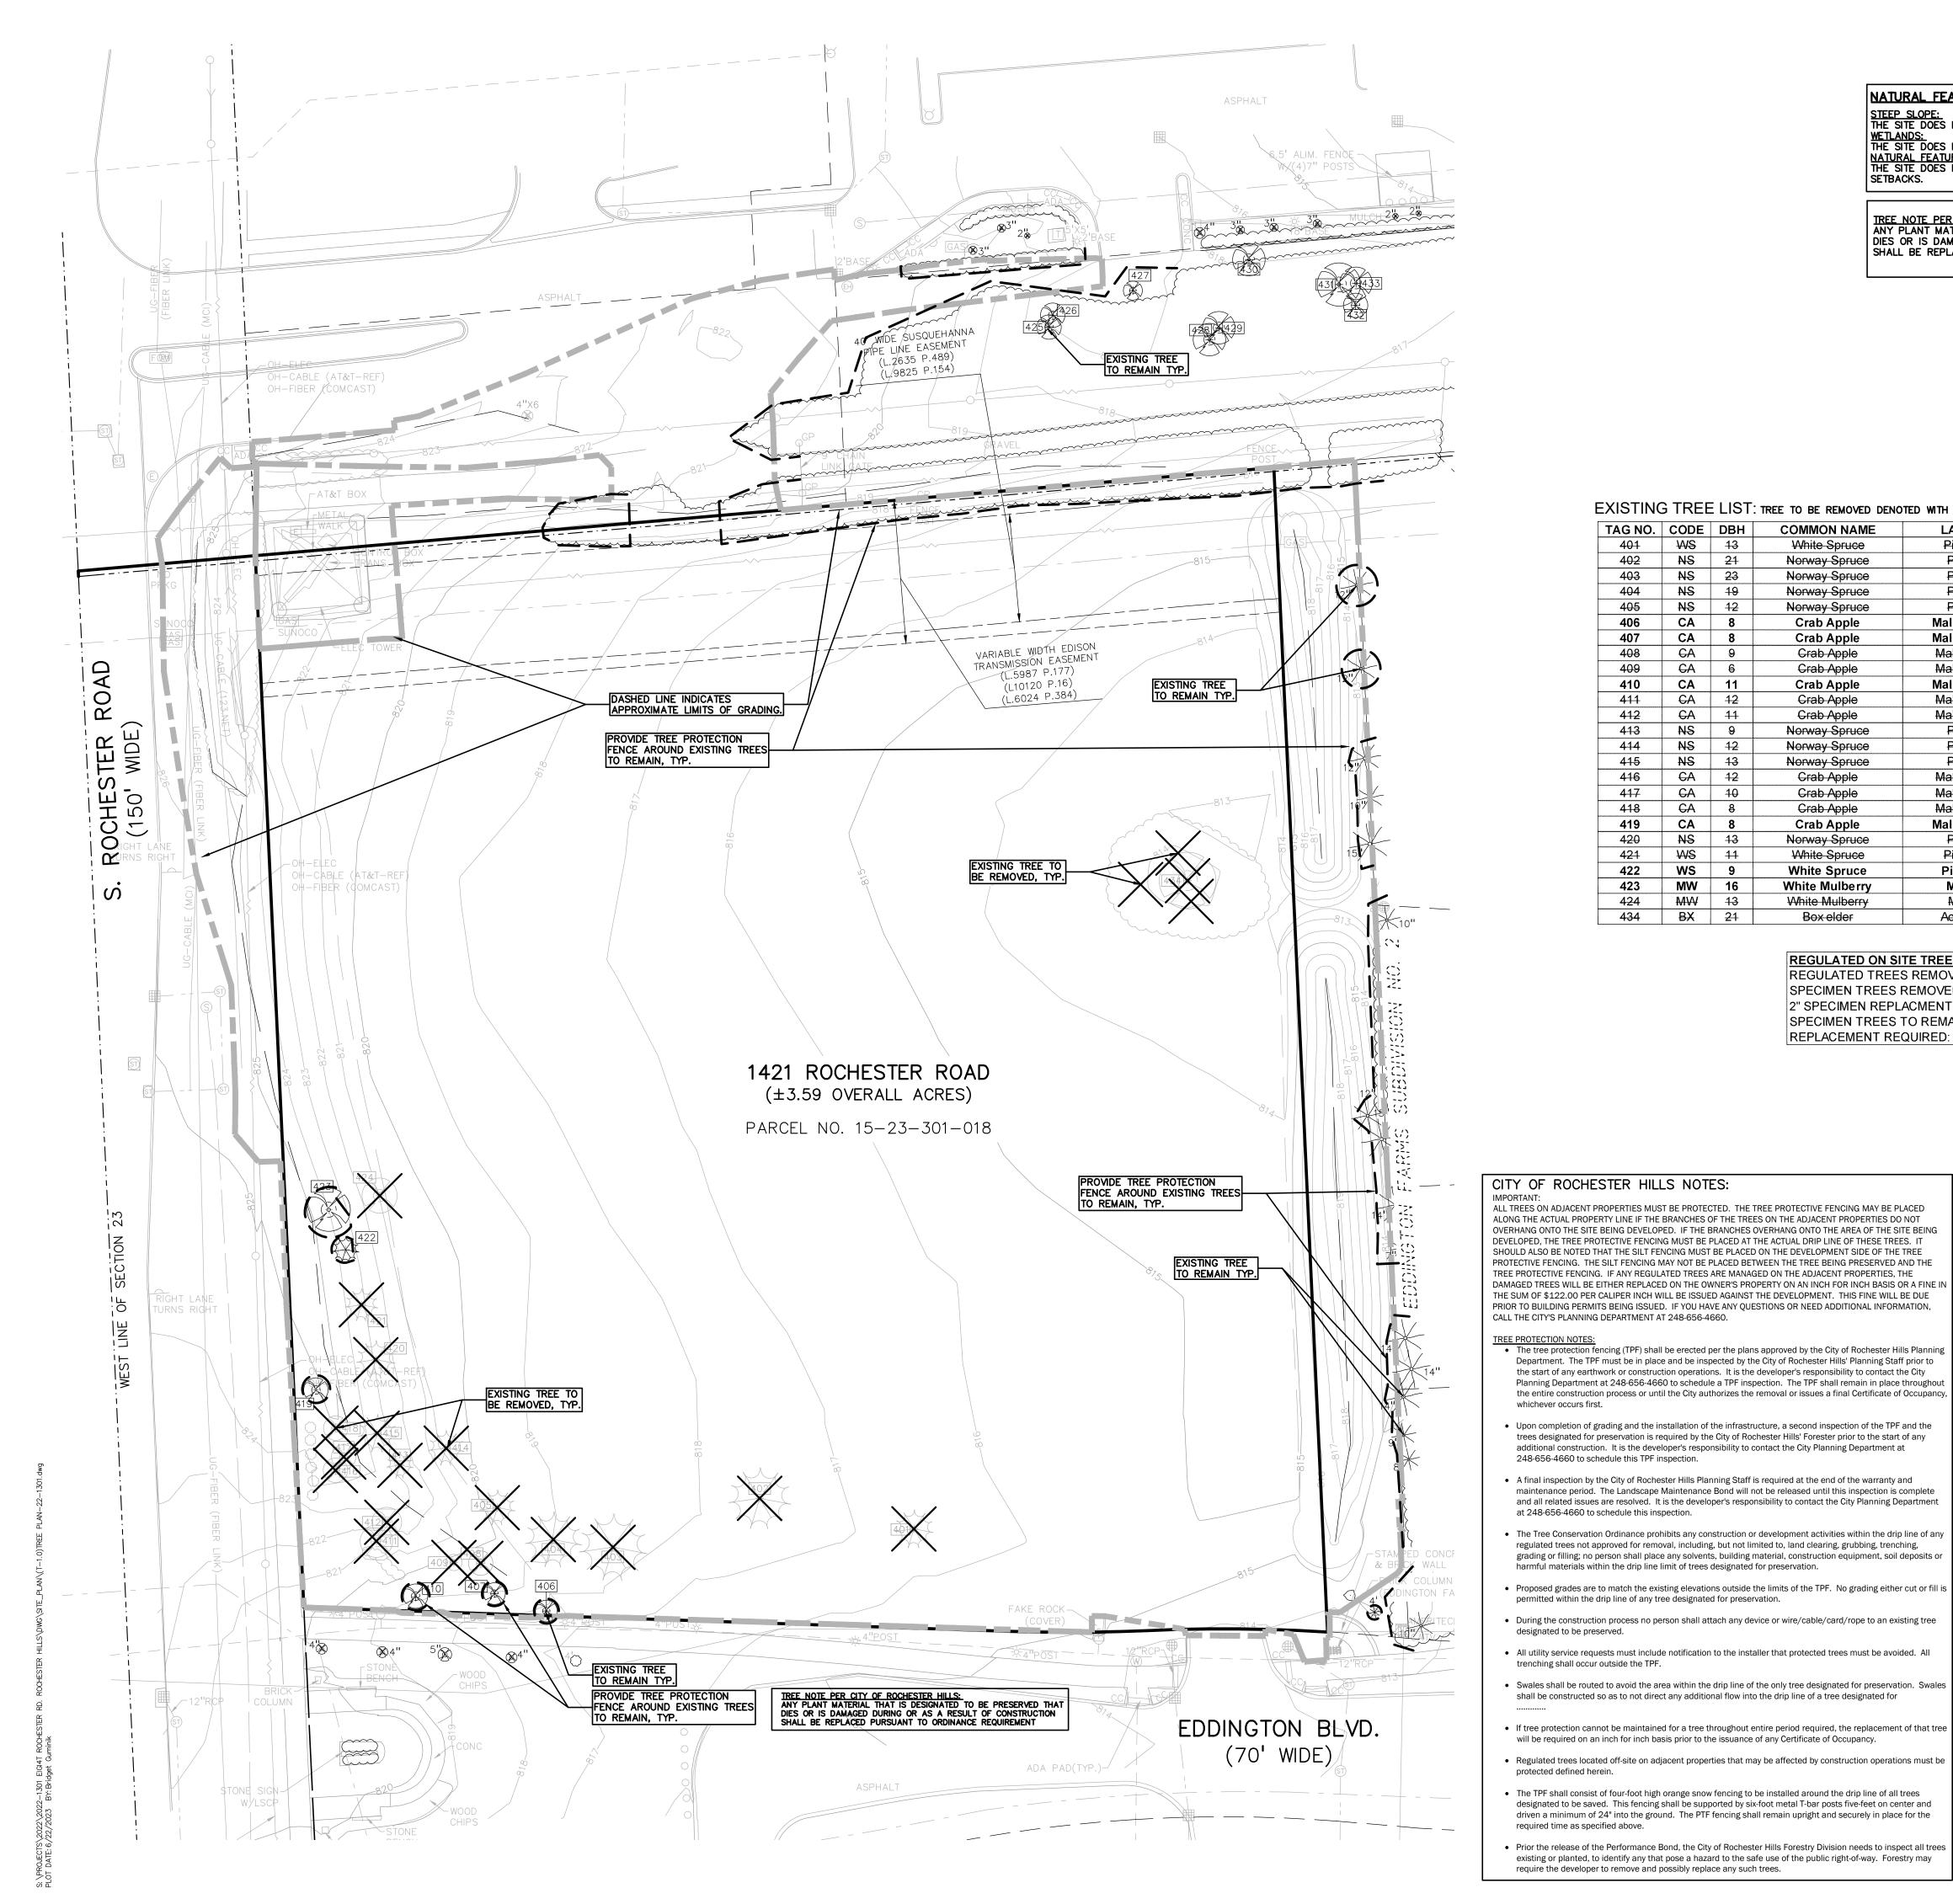


NATURAL FEATURES STATEMENT:

WETLANDS:
THE SITE DOES NOT CONTAIN REGULATED WETLANDS.
NATURAL FEATURES SETBACK:
THE SITE DOES NOT CONTAIN REQUIRED NATURAL FEATURE

TREE NOTE PER CITY OF ROCHESTER HILLS:
ANY PLANT MATERIAL THAT IS DESIGNATED TO BE PRESERVED THAT
DIES OR IS DAMAGED DURING OR AS A RESULT OF CONSTRUCTION
SHALL BE REPLACED PURSUANT TO ORDINANCE REQUIREMENT

STEEP SLOPE: THE SITE DOES NOT CONTAIN REGULATED STEEP SLOPES. = EXISTING TREES TO REMAIN



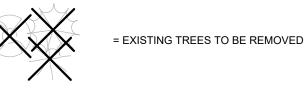



GROUP

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= APPROXIMATE LIMITS OF GRADING

= TREE IDENTIFICATION TAG

= TREE PROTECTION FENCE

SEE SHEET L-1.0 FOR TREE REPLACEMENT



EXISTING TREE LIST: TREE TO BE REMOVED DENOTED WITH STRIKE OUT THROUGH TREE NUMBER

2" SPECIMEN REPLACMENT TREES: SPECIMEN TREES TO REMAIN ON-SITE:

REPLACEMENT REQUIRED:

TAG NO.	CODE	DBH	COMMON NAME	LATIN NAME	CONDITION	NOTES	EXEMPT?	SPECIMEN	SAVE / REMOVE	IN BULDING
401	₩S	13	White Spruce	Picea glauca	Fair			N	₽	H
402	NS	21	Norway Spruce	Picea Abies	Good			¥	R	¥
403	NS	23	Norway Spruce	Picea Abies	Good			¥	R	¥
404	NS	19	Norway Spruce	Picea Abies	Good			¥	R	¥
405	NS	12	Norway Spruce	Picea Abies	Fair			N	R	¥
406	CA	8	Crab Apple	Malus caronaria	Fair	x1		N	S	N
407	CA	8	Crab Apple	Malus caronaria	Fair	x1		N	S	N
408	CA	Ð	Crab Apple	Malus caronaria	Fair	x1		H	R	H
409	CA	6	Crab Apple	Malus caronaria	Fair			N	R	H
410	CA	11	Crab Apple	Malus caronaria	Good			N	S	N
411	CA	12	Crab Apple	Malus caronaria	Fair			¥	R	¥
412	CA	11	Crab Apple	Malus caronaria	Good			N	R	¥
413	NS	Ð	Norway Spruce	Picea Abies	Fair			N	R	¥
414	NS	12	Norway Spruce	Picea Abies	Fair			N	₽	¥
415	NS	13	Norway Spruce	Picea Abies	Fair			N	R	¥
416	CA	12	Crab Apple	Malus caronaria	Good	x1		¥	R	H
417	CA	10	Crab Apple	Malus caronaria	Fair			N	R	N
418	CA	8	Crab Apple	Malus caronaria	Good			N	R	N
419	CA	8	Crab Apple	Malus caronaria	Good			N	S	N
420	NS	13	Norway Spruce	Picea Abies	Good			N	R	¥
421	₩S	11	White Spruce	Picea glauca	Fair			N	R	N
422	WS	9	White Spruce	Picea glauca	Fair			N	S	N
423	MW	16	White Mulberry	Morus alba	Fair			N	S	N
424	MW	13	White Mulberry	Morus alba	Fair			N	R	N
434	₽X	21	Box elder	Acer negundo	Fair	× 4-		N	R	Н

Crab Apple	Malus caronaria	Good		N	S	N	
Norway Spruce	Picea Abies	Good		N N	R	¥	
White Spruce	Picea glauca	Fair		N	R	N	
White Spruce	Picea glauca	Fair		N	S	N	
White Mulberry	Morus alba	Fair		N	S	N	
White Mulberry	Morus alba	Fair		l H	R	H	
Box elder	Acer negundo	Fair	×4	H H	₽	H	
REGULATED ON SITE TREES							
REGULATED TREES	S REMOVED:		14				
SPECIMEN TREES F	REMOVED:	5					

TREES (3" DECIDUOUS OR 8' EVERGREEN) TREES TREES (3" DECIDUOUS OR 8' EVERGREEN) 14+22-0=36

CAUTION!! THE LOCATIONS AND ELEVATION THE LOCATIONS AND ELEVATION THIS IS APPROXIMATE. NO GUARANTE IMPLIED AS TO THE COMPLETE THE CONTRACTOR SHALL BEE DETERMINING THE EXACT UTIL PRIOR TO THE START OF COMS	DRAWING ARE ONLY E IS EITHER EXPRESSED OR NESS OR ACCURACY THERE XCLUSIVELY RESPONSIBLE ITY LOCATIONS AND ELEVAT
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MEADOWFIELD DREXELGATE

CLIENT

PROJECT TITLE

SCHOOL

REVISIONS

PRIMROSE

VACANT LOT - ROCHESTER ROAD

ROCHESTER HILLS, OAKLAND COUNTY, MICHIGAN

EIG14T 3221 W. BIG BEAVER ROAD, SUITE 111 TROY, MICHIGAN 48084

% TREES TO REMAIN:	(6)/(25-10 40.0%
TREES TO REMAIN ON SITE:	6
EXEMPT TREES IN BUILDING:	10
TOTAL TREES ON SITE:	25

TREE PROTECTION WILL BE ERECTED PRIOR TO START OF CONSTRUCTION ACTIVITIES AND SHALL

REMAIN IN PLACE UNTIL CONSTRUCTION IS COMPLETE NO PERSON MAY CONDUCT ANY ACTIVITY WITHIN THE DRIP LINE OF ANY TREE DESIGNATED TO REMAIN; INCLUDING, BUT NOT LIMITED TO PLACING SOLVENTS, BUILDING MATERIAL, CONSTRUCTION EQUIPMENT OR

GRADE CHANGES MAY NOT OCCUR WITHIN THE DRIP LINE OF PROTECTED TREES

SOIL DEPOSITS WITHIN DRIP LINES


DURING CONSTRUCTION, NO PERSON SHALL ATTACH ANY DEVICE OR WIRE TO ANY REMAINING TREE ALL UTILITY SERVICE REQUESTS MUST INCLUDE NOTIFICATION TO THE INSTALLER THAT PROTECTED TREES MUST BE AVOIDED. ALL TRENCHING SHALL OCCUR OUTSIDE OF THE PROTECTIVE FENCING TREES LOCATED ON ADJACENT PROPERTY THAT MAY

BE AFFECTED BY CONSTRUCTION ACTIVITIES MUST BE TREES TO BE PRESERVED SHALL BE IDENTIFIED WITH

FLAGGING PRIOR TO THE TREE CLEARING OPERATIONS


PROVIDE FENCE AROUND CRITICAL ROOT ZONE OF

FENCE SHALL BE PLACED IN A CIRCLE WITH A MINIMUM RADIUS OF 1' PER 1" DIAMETER OF THE TREE MEASURED AT 4.5' ABOVE GROUND

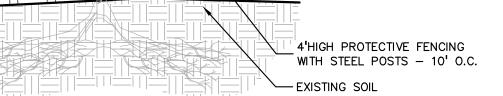

TREE PROTECTION DETAIL

SCALE: 1'' = 3'-0''

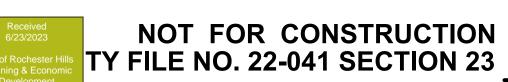

ORIGINAL ISSUE DATE:

SITE PLAN APPROVAL RESUBMITTAL 04-19-23

SITE PLAN APPROVAL RESUBMITTAL 05-25-23

SITE PLAN APPROVAL RESUBMITTAL 06-23-23

DRAWING TITLE **TREE PRESERVATION PLAN**

FEBRUARY 10, 2023

PEA JOB NO. 2022-1301 BGG DES. DRAWING NUMBER:

Plan View Scale - 1" = 40ft

1575 FARNBOROUGH DR.

PARCEL NO. 15-23-300-039

General Note

- 1. SEE SCHEDULE FOR LUMINAIRE MOUNTING HEIGHT.
- 2. PARKING LOT CALCULATIONS ARE SHOWN IN FOOTCANDLES AT: 0' 0"
- 3. PROPERTY LINE CALCULATIONS ARE SHOWN IN FOOTCANDLES AT: 5' 0"

 THE ENGINEER AND/OR ARCHITECT MUST DETERMINE ARRIVED OF THE LAYO

THE ENGINEER AND/OR ARCHITECT MUST DETERMINE APPLICABILITY OF THE LAYOUT TO EXISTING / FUTURE FIELD CONDITIONS. THIS LIGHTING LAYOUT REPRESENTS ILLUMINATION LEVELS CALCULATED FROM LABORATORY DATA TAKEN UNDER CONTROLLED CONDITIONS IN ACCORDANCE WITH ILLUMINATING ENGINEERING SOCIETY APPROVED METHODS. ACTUAL PERFORMANCE OF ANY MANUFACTURER'S LUMINAIRE MAY VARY DUE TO VARIATION IN ELECTRICAL VOLTAGE, TOLERANCE IN LAMPS, AND OTHER VARIABLE FIELD CONDITIONS. MOUNTING HEIGHTS INDICATED ARE FROM GRADE AND/OR FLOOR UP.

THESE LIGHTING CALCULATIONS ARE NOT A SUBSTITUTE FOR INDEPENDENT ENGINEERING ANALYSIS OF LIGHTING SYSTEM SUITABILITY AND SAFETY. THE ENGINEER AND/OR ARCHITECT IS RESPONSIBLE TO REVIEW FOR MICHIGAN ENERGY CODE AND LIGHTING QUALITY COMPLIANCE.

UNLESS EXEMPT, PROJECT MUST COMPLY WITH LIGHTING CONTROLS REQUIRMENTS DEFINED IN ASHRAE 90.1 2013. FOR SPECIFIC INFORMATION CONTACT GBA CONTROLS GROUP AT ASG@GASSERBUSH.COM OR 734-266-6705.

Ordering Note

FOR INQUIRIES CONTACT GASSER BUSH AT QUOTES@GASSERBUSH.COM OR 734-266-6705.

Drawing Note

THIS DRAWING WAS GENERATED FROM AN ELECTRONIC IMAGE FOR ESTIMATION PURPOSE ONLY. LAYOUT TO BE VERIFIED IN FIELD BY OTHERS.

Alternates Note

THE USE OF FIXTURE ALTERNATES MUST BE RESUBMITTED TO THE CITY FOR APPROVAL.

Mounting Height Note


MOUNTING HEIGHT IS MEASURED FROM GRADE TO SKY SIDE OF FIXTURE. POLE HEIGHT SHOULD BE CALCULATED AS THE MOUNTING HEIGHT LESS BASE HEIGHT.

Fixture Note

ALL FIXTURES SHALL COMPLY WITH THE ILLUMINATING ENGINEERING SOCIETY OF NORTH AMERICA.

Controls Note

ALL EXTERIOR LIGHTING IN NON-RESIDENTIAL DISTRICTS SHALL INCORPORATE AUTOMATIC TIMERS AND SHALL BE TURNED OFF BETWEEN THE HOURS OF MIDNIGHT AND SUNRISE, EXCEPT FOR LIGHTING NECESSARY FOR SECURITY PURPOSES OR ACCESSORY TO A USE THAT CONTINUES AFTER MIDNIGHT. SECURITY LIGHTING SHALL, TO THE EXTENT PRACTICAL, USES SENSORS AND DIM OR TURN OFF WHEN THERE IS NO ACTIVITY ON SITE.

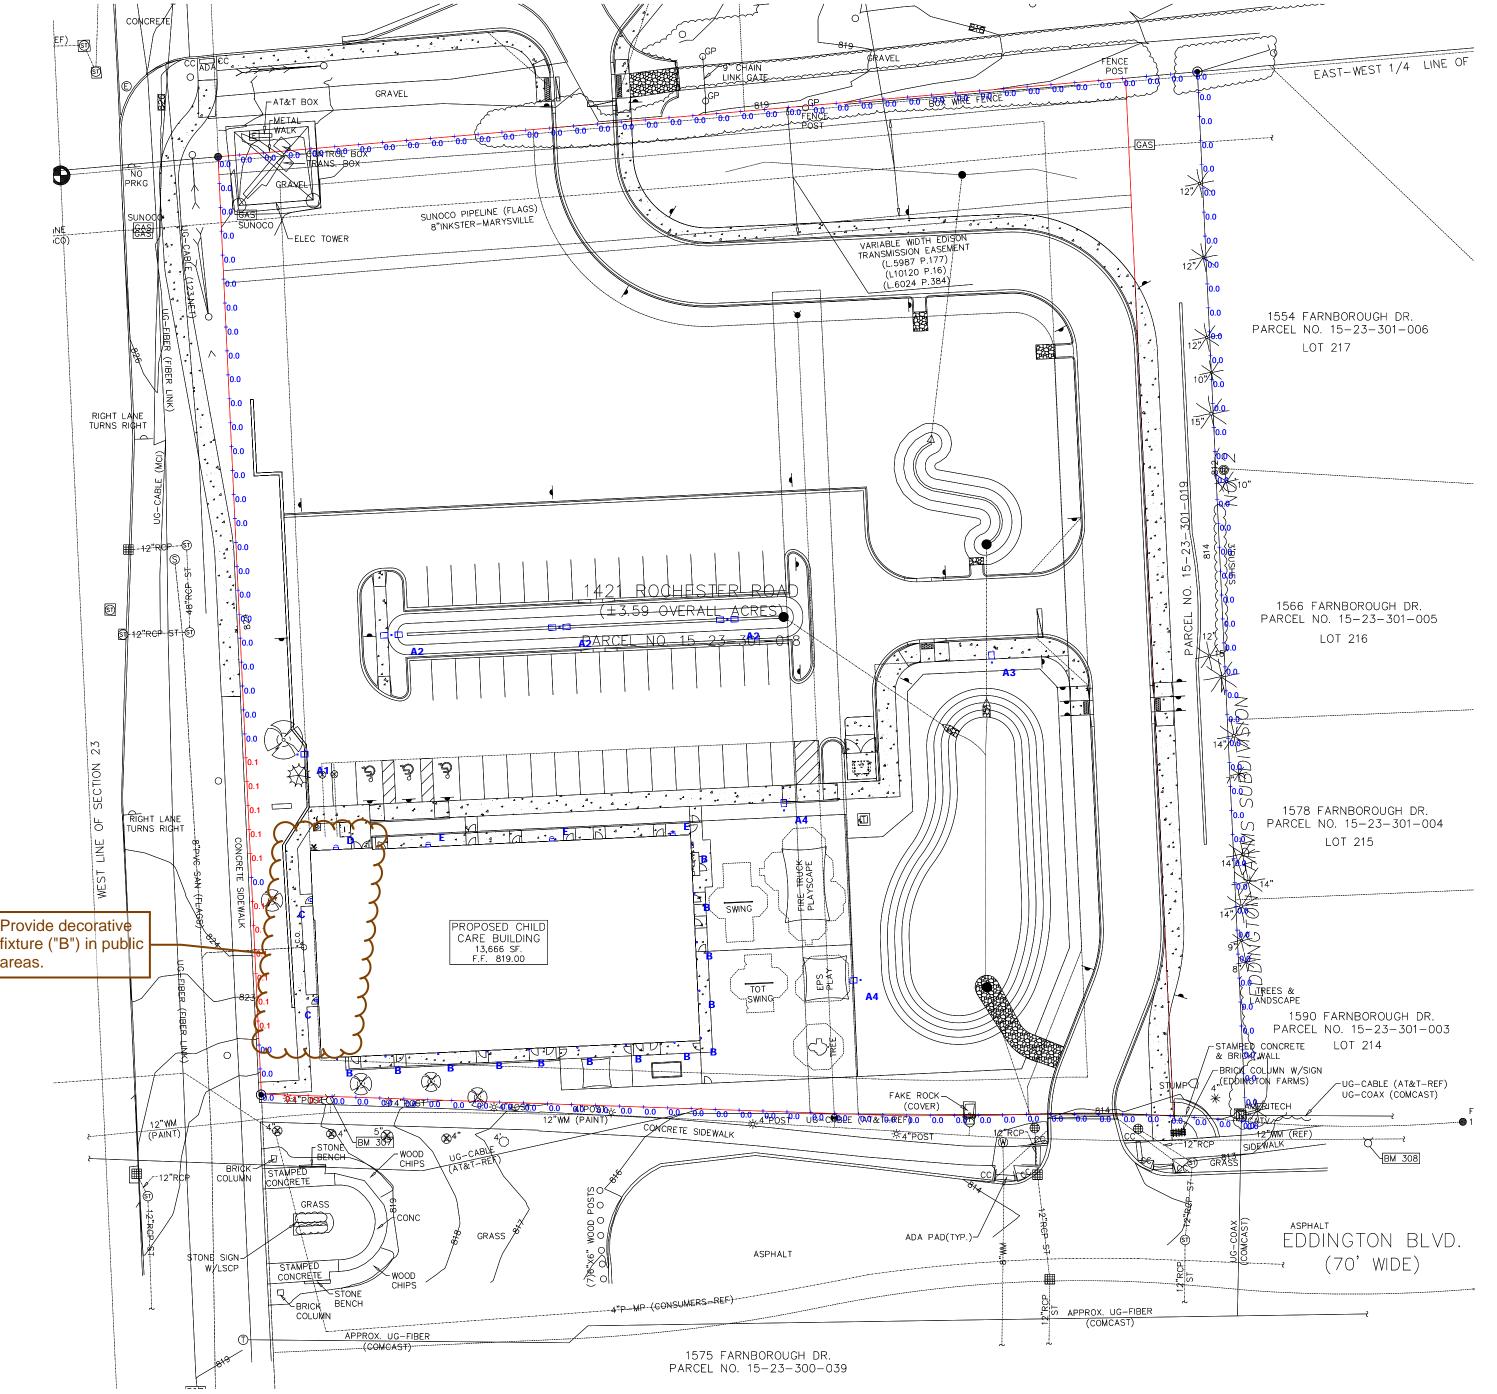


Plan View - PROPERTY LINE

Scale - 1" = 40ft


Symbol	Label	QTY	Manufacturer	Description	Lamp	Mounting Height
	A1	1	Lithonia Lighting	D-Series Size 0 Area Luminaire 3000K	LED	15'-0"
	A2	3	Lithonia Lighting	D-Series Size 0 Area Luminaire 3000K	LED	15'-0"
	A3	1	Lithonia Lighting	D-Series Size 0 Area Luminaire 3000K	LED	15'-0"
	A4	2	Lithonia Lighting	D-Series Size 0 Area Luminaire 3000K	LED	15'-0"
	В	13	Gotham Architectural Lighting	EVO 4IN ROUND CYLINDER, WALL MOUNT, 3000K	LED	9'-0"
	С	2	Lithonia Lighting	WDGE2 LED WALLPACK 3000K	LED	15'-0"
	D	1	Lithonia Lighting	WDGE3 LED WALLPACK 3000K	LED	15'-0"
	Е	3	Lithonia Lighting	WDGE3 LED WALLPACK 3000K	LED	15'-0"

Statistics									
Description	Symbol	Avg	Max	Min	Max/Min	Avg/Min	Avg/Max		
DRIVEWAY	+	0.5 fc	0.8 fc	0.3 fc	2.7:1	1.7:1	0.6:1		
OVERALL	+	0.4 fc	8.3 fc	0.0 fc	N/A	N/A	0.0:1		
PARKING LOT	+	1.3 fc	2.0 fc	0.3 fc	6.7:1	4.3:1	0.7:1		
PARKING LOT (WITHIN 25' OF BUILDING)	+	2.6 fc	3.9 fc	2.0 fc	2.0:1	1.3:1	0.7:1		
PEDESTRIAN AREA (ACCESSIBLE ROUTE)	+	0.6 fc	0.8 fc	0.2 fc	4.0:1	3.0:1	0.8:1		
PEDESTRIAN AREA (CHILD CARE BUILDING: EAST AND SOUTH SIDEWALK)	+	0.6 fc	1.0 fc	0.2 fc	5.0:1	3.0:1	0.6:1		
PLAYGROUND	+	0.8 fc	4.8 fc	0.2 fc	24.0:1	4.0:1	0.2:1		
DDODEDTY LINE	+	0.0 fc	0 1 fc	0.0 fc	NI/A	N/A	0.0.1		

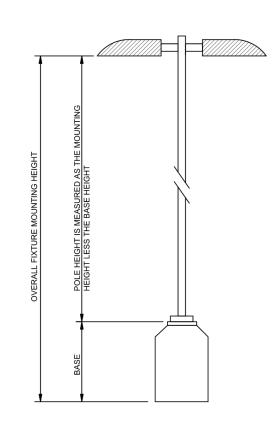





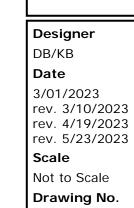

#23-12467-V4



WDGE2 LED Architectural Wall Sconce 20 BAA

The WDGE LED family is designed to meet specifier's every wall-mounted lighting need in a widely accepted shape that blends with any architecture. The clean rectilinear design comes in four sizes with lumen packages ranging from 1,200 to 25,000 lumens, providing a true site-wide solution. Embedded with nLight* AIR wireless controls, the WDGE family provides additional energy savings and code compliance. WDGE2 with industry leading precision refractive optics provides great uniform distribution and optical control. When combined with multiple integrated emergency battery backup options, including an 18W cold temperature option, the WDGE2 becomes the ideal wall-mounted lighting solution for pedestrian scale applications in any environment.

WDGE LED Family Overview

							Approxima	air Lumets (4905k, KOCRI)			
Luminary.	Optics	Standard EM, U.S.	CHIEN SEC	Sesur	PU	n -	72	N.	N N	- 85	1
WDGE1 LED	Visual Comfort	4W		-2	750	1,200	2,000	+		-2-	-
WDGE2 LED	Visual Comfort	16W	18W	Standalone / nLight	-	1,200	2,000	3,000	4,500	6,000	-
WDGE2 LED	Precision Refractive.	10W	18W.	Standalone / nLight	700	1,200	2,000	3,200	4,200	-	
WDGE3 LED	Precision Refractive	ISW	38W	Standalone / nLight	-	7,500	8,500	10,000	12,000	-	1 8
WDGE4 LED	Precision Refractive			Standalone / nLight	~	12,000	16,000	18,000	20,000	22,000	25,0

ing Information	EXAMPLE: WDGE2 LED P3 40K 80CRI VF MVOLT SRM DDB3

WDGE2 LED PO 1 27K 2700 k 70CR1 st T1S type Short MVOLT Shipped included Ship P1 2 30K 3000K 80CRI T2M type Medium 347 st SRM Surface introducing blacket AWS	ed separately
P2 40K 4000K LWF Limited T3M lyne III Medium 480° ICW Indirect Canapy/Ceiling P88V 93° 50K 5000K Wavelength T4M lyne IV Medium Washer tisacket (dry/ famo locations only/*	3/Einch Architectural way spaces

Options-				Heise	
EJOWH	Envergency battery backup, Certified in CA Title 20 MAEDRS (10W.5°C min)	Standalone S	ensors/Controls B-level (100/15%) motion sensor for 8-15' mounting heights, intended for use on	DOBXD	Dark bronze Black
E20WC	Emergency hattiery backup, Certified in CA Title 20 MAEDRS (18W 20°C mim)	PIRH	switched circuits with external dusk to dawn switching Bi-level (100/15%) motion sensel for 15-30" ensuring heights, intended for use on	DNAXD	Natural aleminum Whate
PE?	Photocell, Button Type	1	switched circuits with external dusk to dawn switching		
DMG1	O-TOV dimming were pulled outside betwee (for use with an external control, ordered separately)	PIRTECTA	Bi-layel (100/35%) motion sensor for 8-15 mounting heights with photocell pre- programmed for dusk to dawn operation.	DOBTXD	Sandstone Sessued dark berge
BCE	Bottom conduit entry for back box (PBBW). Total of 4 entry points.	PIRH1FC3V	Bi-level (100/35%) motion sensor for 15-30 mounting heights with photocell pre- programmed for dusk to dawn operation.	DBLBXD	Textured black Textured natural aluminum
BAA	Buy America(n) Act Compliant	Networked Se	ensors/Controls	DWHGXD	Textured white
		NUTAIR2 PIR NUTAIR2 PIRH Seesage 6 for our	nLightAIR Wireless enabled bi-level motion/ambient censor for 8-15' mounting heights nLightAIR Wireless enabled bi-level motion/ambient sensor for 15-10' mounting heights of box forceorality.	DSSTXD	Textured sandstone







COMMERCIAL OUTDOOR One Lithonia Way • Conyers, Georgia 30012 • Phone: 1-900-705-SERV (7978) • © 2019-2022 Acuty Brands Lighting, Inc. All rights reserved.


WDGE2 LED Rev. 11/21/22

Schedule

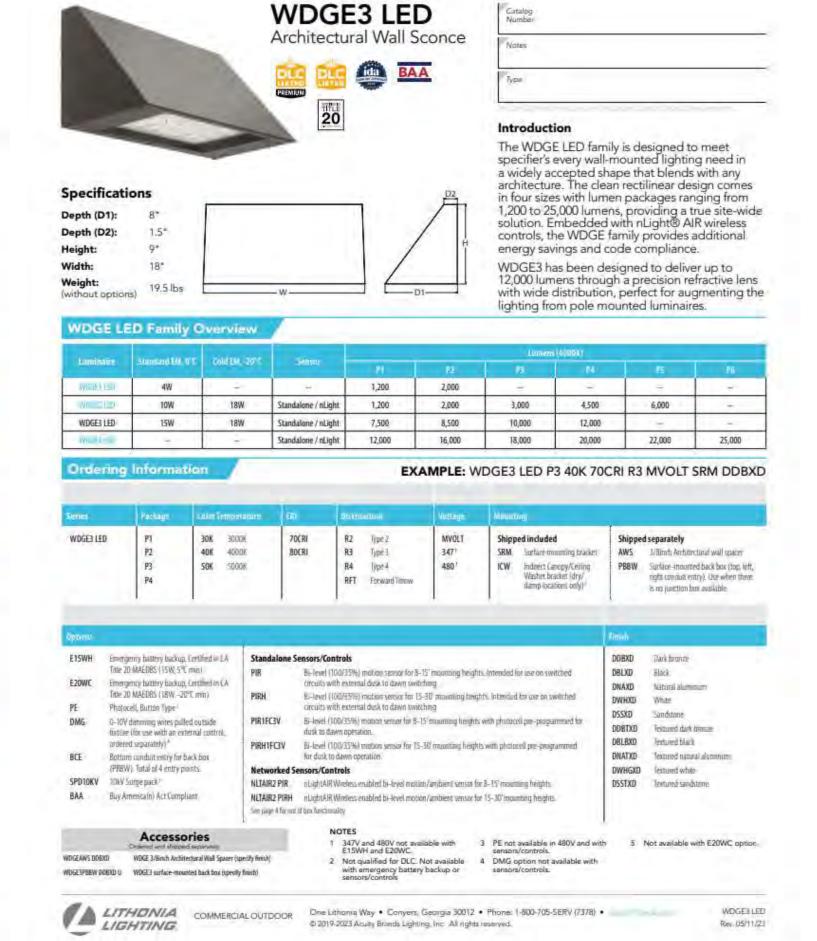

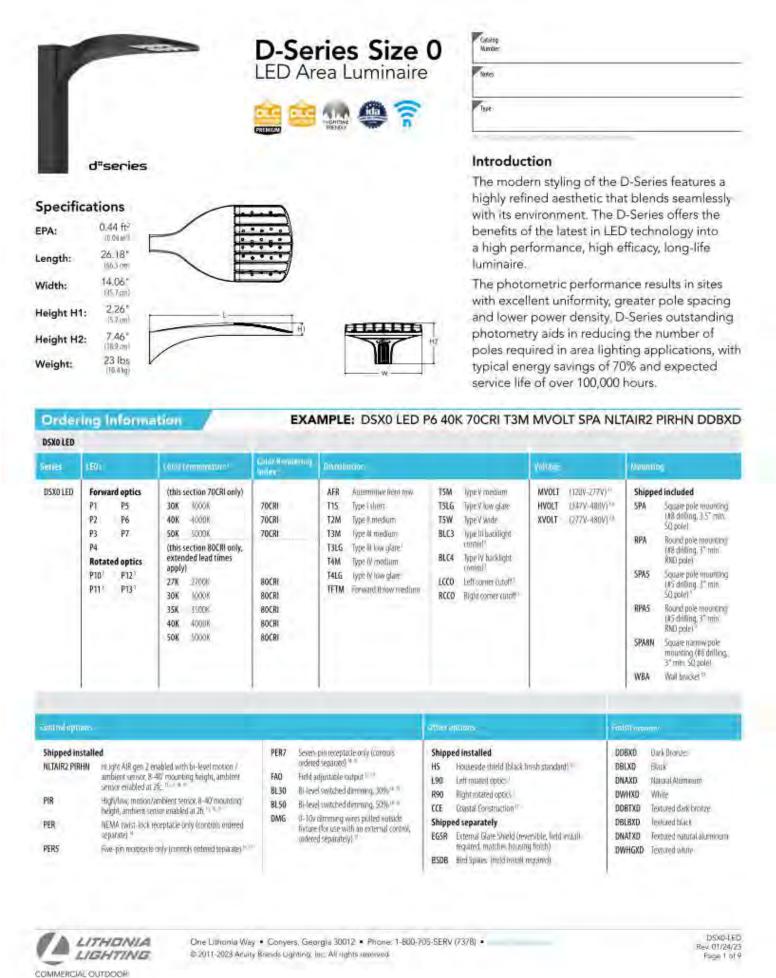



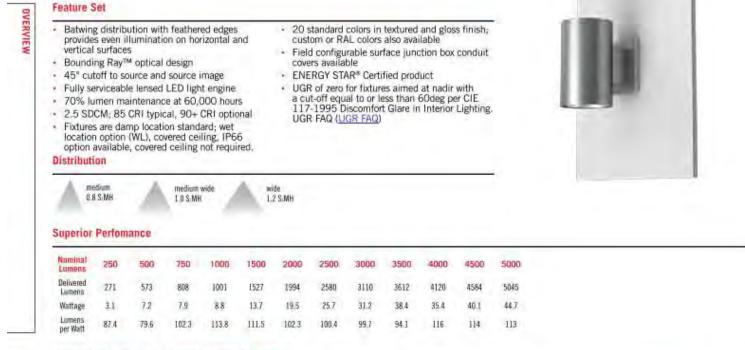

Luminaire Type:



page 1 of 9

GOTHAM ARCHITECTURAL DOWNLIGHTING | 1400 Lester Road Convers, GA 30012 | P 800-705-SERV (7378) | gothamlighting.com © 2014-2022 Acuity Brands Lighting Inc. All Rights Reserved. Rev. 10/30/22 Specifications subject to change without notice. The product images shown are for illustration purposes only and may not be an exact representation of the product.

Symbol	Label	QTY	Manufacturer	Description	Lamp	Mounting Height
	A1	1	Lithonia Lighting	D-Series Size 0 Area Luminaire 3000K	LED	15'-0"
	A2	3	Lithonia Lighting	D-Series Size 0 Area Luminaire 3000K	LED	15'-0"
	A 3	1	Lithonia Lighting	D-Series Size 0 Area Luminaire 3000K	LED	15'-0"
	A 4	2	Lithonia Lighting	D-Series Size 0 Area Luminaire 3000K	LED	15'-0"
	В	13	Gotham Architectural Lighting	EVO 4IN ROUND CYLINDER, WALL MOUNT, 3000K	LED	9'-0"
	С	2	Lithonia Lighting	WDGE2 LED WALLPACK 3000K	LED	15'-0"
	D	1	Lithonia Lighting	WDGE3 LED WALLPACK 3000K	LED	15'-0"
	E	3	Lithonia Lighting	WDGE3 LED WALLPACK 3000K	LED	15'-0"

General Note

- 1. SEE SCHEDULE FOR LUMINAIRE MOUNTING HEIGHT.
- 2. PARKING LOT CALCULATIONS ARE SHOWN IN FOOTCANDLES AT: 0' 0"
- 3. PROPERTY LINE CALCULATIONS ARE SHOWN IN FOOTCANDLES AT: 5' 0"

THE ENGINEER AND/OR ARCHITECT MUST DETERMINE APPLICABILITY OF THE LAYOUT TO EXISTING / FUTURE FIELD CONDITIONS. THIS LIGHTING LAYOUT REPRESENTS ILLUMINATION LEVELS CALCULATED FROM LABORATORY DATA TAKEN UNDER CONTROLLED CONDITIONS IN ACCORDANCE WITH ILLUMINATING ENGINEERING SOCIETY APPROVED METHODS. ACTUAL PERFORMANCE OF ANY MANUFACTURER'S LUMINAIRE MAY VARY DUE TO VARIATION IN ELECTRICAL VOLTAGE, TOLERANCE IN LAMPS, AND OTHER VARIABLE FIELD CONDITIONS. MOUNTING HEIGHTS INDICATED ARE FROM GRADE AND/OR FLOOR UP.

THESE LIGHTING CALCULATIONS ARE NOT A SUBSTITUTE FOR INDEPENDENT ENGINEERING ANALYSIS OF LIGHTING SYSTEM SUITABILITY AND SAFETY. THE ENGINEER AND/OR ARCHITECT IS RESPONSIBLE TO REVIEW FOR MICHIGAN ENERGY CODE AND LIGHTING QUALITY COMPLIANCE.

UNLESS EXEMPT, PROJECT MUST COMPLY WITH LIGHTING CONTROLS REQUIRMENTS DEFINED IN ASHRAE 90.1 2013. FOR SPECIFIC INFORMATION CONTACT GBA CONTROLS GROUP AT ASG@GASSERBUSH.COM OR 734-266-6705.

Alternates Note

THE USE OF FIXTURE ALTERNATES MUST BE RESUBMITTED TO THE CITY FOR APPROVAL.

Drawing Note

THIS DRAWING WAS GENERATED FROM AN ELECTRONIC IMAGE FOR ESTIMATION PURPOSE ONLY. LAYOUT TO BE VERIFIED IN FIELD BY OTHERS.

Ordering Note

FOR INQUIRIES CONTACT GASSER BUSH AT QUOTES@GASSERBUSH.COM OR 734-266-6705.

Mounting Height Note

MOUNTING HEIGHT IS MEASURED FROM GRADE TO SKY SIDE OF FIXTURE. POLE HEIGHT SHOULD BE CALCULATED AS THE MOUNTING HEIGHT LESS BASE HEIGHT.

Fixture Note

ALL FIXTURES SHALL COMPLY WITH THE ILLUMINATING ENGINEERING SOCIETY OF NORTH AMERICA.

Controls Note

ALL EXTERIOR LIGHTING IN NON-RESIDENTIAL DISTRICTS SHALL INCORPORATE AUTOMATIC TIMERS AND SHALL BE TURNED OFF BETWEEN THE HOURS OF MIDNIGHT AND SUNRISE, EXCEPT FOR LIGHTING NECESSARY FOR SECURITY PURPOSES OR ACCESSORY TO A USE THAT CONTINUES AFTER MIDNIGHT. SECURITY LIGHTING SHALL, TO THE EXTENT PRACTICAL, USES SENSORS AND DIM OR TURN OFF WHEN THERE IS NO ACTIVITY ON SITE.

Designer DB/KB Date 3/01/2023 rev. 3/10/2023 rev. 4/19/2023 rev. 5/23/2023 Scale Not to Scale Drawing No. #23-12467-V4

Drawn/Checked	DSC / AKB
Project Number	2302925
Bid Date	//
Permit Date	//
For Construction	//

FLOOR PLAN

JNRNB2022-0010 PSP2023-0009 Revision #3

REQUIRED FOR ENTRY

FROM EXTERIOR)

PUBLIC ENTRANCE—

OCCUPANCY GROUP CLASSIFICATION

E (DAYCARE)

ACCESSORY USE S-1 (STORAGE) ACCESSORY USE B (BUSINESS)

CONSTRUCTION CLASSIFICATION

TYPE V-B, UNPROTECTED SPRINKLERED

BUILDING AREA (PER TABLE 506.2):

ALLOWABLE AREA: 38,000 SF

BUILDING HEIGHT:

PROPOSED AREA:

MAXIMUM ALLOWABLE BUILDING HEIGHT (PER TABLE 504.3): 60'-0" ALLOWABLE NUMBER OF STORIES: 2

13,586 SF

PROPOSED BUILDING HEIGHT: 34'-7"

PROPOSED NUMBER OF STORIES: 1

SPRINKLER SYSTEM:

BUILDING AND ATTIC WILL BE EQUIPPED THROUGHOUT WITH AN

AUTOMATIC SPRINKLER SYSTEM.

BUILDING PROGRAM - MI


Primrose School - ROCHESTER HILLS, MI 04/10/2023

Name	Ages	Primrose S.F.	Michigan State	Michigan Max.	PSFC Staff	PSFC Max	Proposed Room	Staff	Required
Name	Ages	Per Child	Ratio	Group Size	Ratio	Group Size	Capacity	Required	Area S.F.
A1 - Infants	6 Wks - 12 Months	50	1:4	12	1:4	8	8	2	400
A2 - Infants	6 Wks - 12 Months	50	1:4	12	1:4	8	8	2	400
B1 - Toddlers	12 - 18 Months	50	1:4	12	1:6	12	12	3	600
B2 - Toddlers	18 - 23 Months	50	1:4	12	1:6	12	12	3	600
EP1 - Early Preschool	24 - 29 Months	50	1:4	12	1:8	16	12	3	600
EP2 - Early Preschool	30 - 35 Months	35	1:8	16	1:8	16	16	2	560
Pathways	30 - 42 Months	35	1:8	16	1:8	16	16	2	560
C1 - Preschool	3 Years	35	1:10	30	1:12	24	20	2	700
C2 - Preschool	3 Years	35	1:10	30	1:12	24	20	2	700
D1 - Pre - Kindergarten	4 Years	35	1:12	36	1:12	24	24	2	840
D2 - Pre - Kindergarten	4 Years	35	1:12	36	1:12	24	24	2	840
EXP - Kindergarten / After School	5 Years +	35	1:18	36	1:15	30	30	2	1050
NOTE: S.F. VALUES LISTED ON CHART ARE FOR LICENSED CAPACITY ALLOWED BY THE STATE OF MICHIGAN.							202	27	7850

(MUST HAVE KEY TO OPEN FROM EXTERIOR)

NOTE: S.F. VALUES LISTED ON CHART ARE FOR LICENSED CAPACITY ALLOWED BY THE STATE OF MICHIGAN.

OCCUPANT LOAD S.F. AND VALUES WILL COMPLY WITH THE BUILDING CODE.

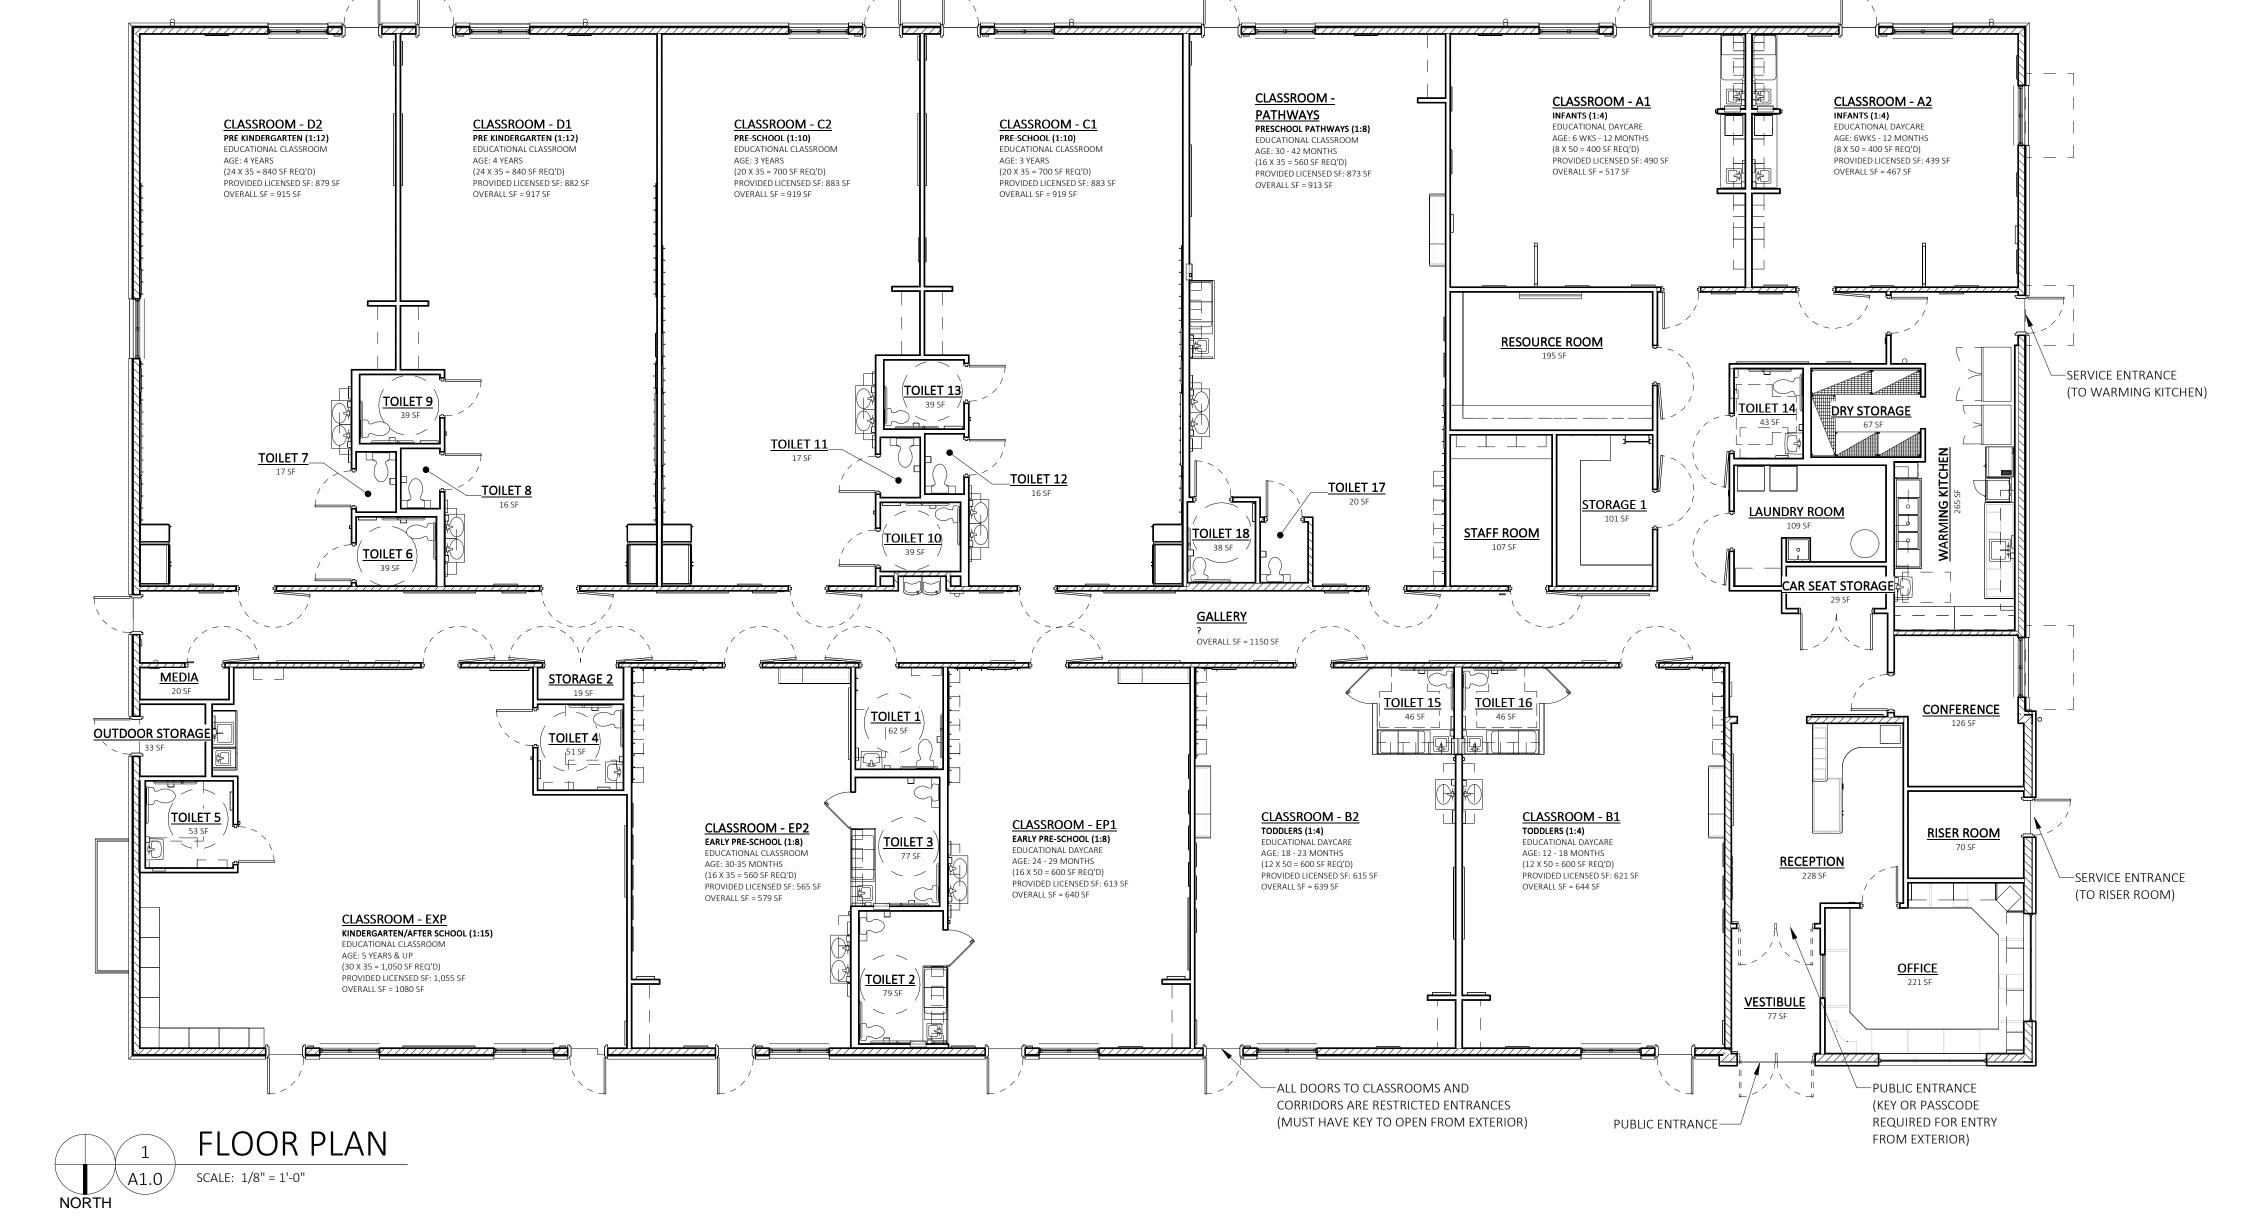

ELEVATION KEYED NOTES

4 42" ROUND LED LIGHTED SIGN (INTERNALLY LIT). SEE 6/A2.4 FOR MOUNTING DETAIL.

6 TRIMBOARD AT OFFICE WINDOW: HORIZ TO BE 5/4 x 6, VERT TO BE 5/4 x 4, BOTH WD-3

7 TRIMBOARD AT ALL EXTERIOR DOORS AND CLASSROOM WINDOWS TO BE 5/4 x 6, WD - 3

9 CUPOLA WITH WEATHERVANE. PAINT ALL SURFACES TO MATCH "ARCTIC WHITE", ROOF TO BE

8 60" ROUND LED LIGHTED SIGN (INTERNALLY LIT). SEE 6/A2.4 FOR MOUNTING DETAIL

11 GLAZING TO RECIEVE WINDOW FILM, TINT - 1. SEE FINISH SCHEDULE SHEET A2.2

13 KNOX BOX OR APPROVED EQUAL. COORDINATE LOCATION WITH LOCAL FIRE OFFICIAL

15 BEIGE ALUMINUM PLAQUE W/6" REFLECTIVE BLACK VINYL NUMBERS. PROVIDED BY 1 HOUR

SPECIFICATION

MISC METAL TRIM & FLASHING ANY MISC METAL FLASHING AND TRIM NOT NOTED AS

DIRECTION AS REQ'D.

TRIM (FASCIA, FRIEZE, RUNNING | HARDIE TRIM BOARDS, 5/4 NT3 SMOOTH, VARIOUS

"AGED PEWTER"

SPOUTS U.N.O.

GUTTERS ALONG METAL ROOF | COLOR: TO MATCH "MR - 1"

TO MATCH "ARCTIC WHITE") COLOR: TO MATCH "MR-1"

BERRIDGE CEE-LOCK SYSTEM. COLOR: DARK BRONZE.

CORONADO: CHISELED STONE SILL. COLOR: TWILIGHT.

BM COLOR REVIEW #OC - 21 WINTER WHITE. (COLOR

HARDIE PANEL (4' X 10') & HARDIE TRIM BATTEN

HARDIE PANEL (4' X 10') & HARDIE TRIM BATTEN

HARDIE PANEL (4' X 10') & HARDIE TRIM BATTEN

BOARDS (2 1/2" WIDE @ 2' - 0" O.C.) FINISH: SMOOTH COLOR: ARCTIC WHITE (PRIMED AND FIELD PAINTED)

BOARDS (3 1//2" WIDE @ 4' - 0" O.C.) FINISH: SMOOTH

COLOR: ARCTIC WHITE (PRIMED AND FIELD PAINTED)

BOARDS (2 1/2" WIDE @ 16" O.C.) FINISH: SMOOTH COLOR:ARCTIC WHITE (PRIMED AND FIELD PAINTED)

WIDTHS AS REQUIRED (SEE ELEVATIONS). COLOR:

HARDIE TRIM BOARDS, 5/4 NT3 SMOOTH, VARIOUS WIDTHS AS REQUIRED (SEE ELEVATIONS) COLOR: AGED

HARDIE TRIM BOARDS, 5/4 NT3 SMOOTH, SEE WALL SECTIONS FOR SIZE. COLOR: PAINT TO MATCH MR-1

EKENA MILLWORK: TWO BATTEN W/Z-BAR BOARD &

SHUTTERS TO BE ORDERED PRIMED, PAINT TO MATCH

AMERICAN LOUVER & VENT COMPANY, TGV81260 OR APPROVED EQUAL. BM COLOR REVIEW #OC - 21 WINTER WHITE (COLOR TO MATCH "ARCTIC WHITE")

LARGE COPPER ROOSTER WEATHERVANE. SEE 1A/A6.3

BM COLOR REVIEW #OC - 21 WINTER WHITE. (COLOR

TO MATCH "ARCTIC WHITE"): 6" GUTTERS AND DOWN

EXTERIOR INSULATED METAL HALF LITE DOOR; COLOR

(INTERIOR & EXTERIOR): WHITE. SEE DOOR SCHEDULE

EXTERIOR INSULATED METAL FULL LITE DOOR: COLOR

(INTERIOR & EXTERIOR): WHITE. SEE DOOR SCHEDULE

ANDERSEN: SILVERLINE 2200 SERIES. COLOR: WHITE.

ANDERSEN: 100 SERIES. COLOR: WHITE. SEE WINDOW

FOR ADDITIONAL INFORMATION.

FOR ADDITIONAL INFORMATION.

<u>3</u>_/

14

SEE WINDOW SCHEDULE.

SCHEDULE

***ALL SIGNS MUST MEET THE REQUIREMENTS OF THE CITY AND BE APPROVED UNDER SEPARATE

***ALL ROOFTOP MECHANICAL EQUIPMENT WILL BE SCREENED UTILIZING RTU SCREENS. SCREENS WILL BE AT A MINIMUM AS TALL AS THE TALLEST PIECE OF MECHANICAL EQUIPMENT. SCREENS TO

BATTEN COMPOSITE SHUTTERS. 3' - 6"T x 1' - 6"W.

ARCTIC WHITE (PRIMED AND FIELD PAINTED)

PEWTER (PRIMED AND FIELD PAINTED)

CORONADO: EASTERN MOUNTAIN LEDGE, HURON

TRIM-1 OR TRIM-2 SHOULD MATCH COLOR OF ADJACENT SURFACE. CONTACT ARCHITECT FOR

12 DOWNSPOUTS TIED INTO UNDERGROUND STORM SEWER BELOW GRADE.

1 5/4 x 8 TRIMBOARD, WD - 2

2 5/4 x 6 TRIMBOARD, WD - 2

3 5/4 x 4 TRIMBOARD, WD - 2

5 LIGHTING, REFER TO ELECTRICAL DRAWINGS.

MR - 1 REFER TO 1A/A6.3 FOR CONSTRUCTION.

14 4' - 0" HIGH SOLID VINYL FENCE WITH (2) 3' - 0"W GATES.

SIGN. COORDINATE LOCATION WITH LOCAL FIRE OFFICIAL.

EXTERIOR FINISH LEGEND

10 ROOF LINE BEHIND PARAPET WALL.

MARK DESCRIPTION

METAL ROOF

STONE WAINSCOT

TRIM-1 MTL TRIM @ METAL ROOF

TRIM-2 MTL TRIM @ METAL ROOF

WD-1A BOARD & BATTEN SIDING

WD-1B BOARD & BATTEN SIDING

(BELOW 10' -0")

WD-1C BOARD & BATTEN SIDING (@ ENTER TOWER)

TRIM (DOOR AND WINDOW

TRIM (FASCIA TRIM @ METAL

ROOF)

SHUTTERS

GABLED ROOF

HALF LITE DOORS

FULL LITE DOOR

WIN - 2 VINYL WINDOWS (@ OFFICE)

DR-1 \(11 \)

MR-1

\(\text{WD-4}\)
\(\text{DS-2}\)
\(\text{DS-1}\)

5\7\ \(\text{DR-1}\)

PERMITS ISSUED BY THE BUILDING DEPARTMENT***


BE PAINTED TO MATCH SIDING COLOR ON BUILDING.***

(ABOVE 10' - 0")

STONE CAP @ WAINSCOT

 $\langle X \rangle$

PRIMROSE

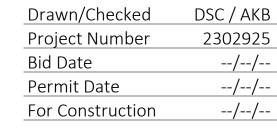


EXTERIOR ELEVATIONS




 $\overline{WD-4}$

—⟨<u>WD-1C</u>⟩



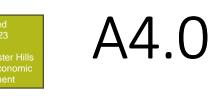



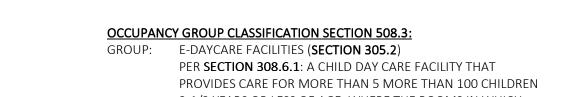

2-1/2 YEARS OR LESS OF AGE, WHERE THE ROOMS IN WHICH THE CHILDREN ARE CARED FOR ARE LOCATED ON A LEVEL OF EXIT DISCHARGE SERVING SUCH ROOMS AND EACH OF THESE CHILD CARE ROOMS HAS AN EXIT DIRECTLY TO THE EXTERIOR, SHALL BE CLASSIFIED AS GROUP E. B - BUSINESS (SECTION 304)

ACCESSORY USE GROUP S-1 - STORAGE (SECTION 311)

CONSTRUCTION CLASSIFICATION: TYPE V-B - UNPROTECTED - SPRINKLED

2015 MI ENERGY CODE - CHAPTERS 1 THROUGH 6 & MI ENERGY CODE, PART 10a RULES - ANSI/ASHRAE/IES STANDARD 90.1-2013 2015 INTERNATIONAL FUEL GAS CODE FUEL GAS:

2018 MI PLUMBING CODE

2015 MI BUILDING CODE

NEC 2017 STATE OF MI ELECTRICAL CODE/

2017 NEC WITH PART 8 AMENDMENTS

2015 MI BUILDING CODE - CHAPTER 13 &

12 14

ICC ANSI A117.1-2009

FIRE: 2015 INTERNATIONAL FIRE CODE

FIRE SUPPRESSION: NFPA 13-2013 FIRE ALARM: NFPA 72-2013

ADOPTED BUILDING CODES:

BUILDING:

ELECTRICAL:

PLUMBING:

ENERGY:

ACCESSIBILITY:

SPRINKLER SYSTEM: BUILDING AND ATTIC WILL BE EQUIPPED THROUGHOUT WITH AN AUTOMATIC SPRINKLER SYSTEM. TYPICAL DIMENSIONS AT SCUPPER OPENINGS 1' - 2" 2' - 0" 1' - 2" (WD-1C) 18' - 0" A.F.F. ± DS-2 (DS-1) CENTERLINE OF TRIMBOARD 10'-2" A.F.F. $\neg \langle MR-1 \rangle$ T.O. WATERTABLE 2'-8" A.F.F. FINISH FLOOR

SOUTH ELEVATION

OCCUPANCY GROUP CLASSIFICATION

ACCESSORY USE S-1 (STORAGE)


ACCESSORY USE B (BUSINESS)

CONSTRUCTION CLASSIFICATION

TYPE V-B, UNPROTECTED, SPRINKLERED

E (DAYCARE)

SCALE: 1/8" = 1'-0"

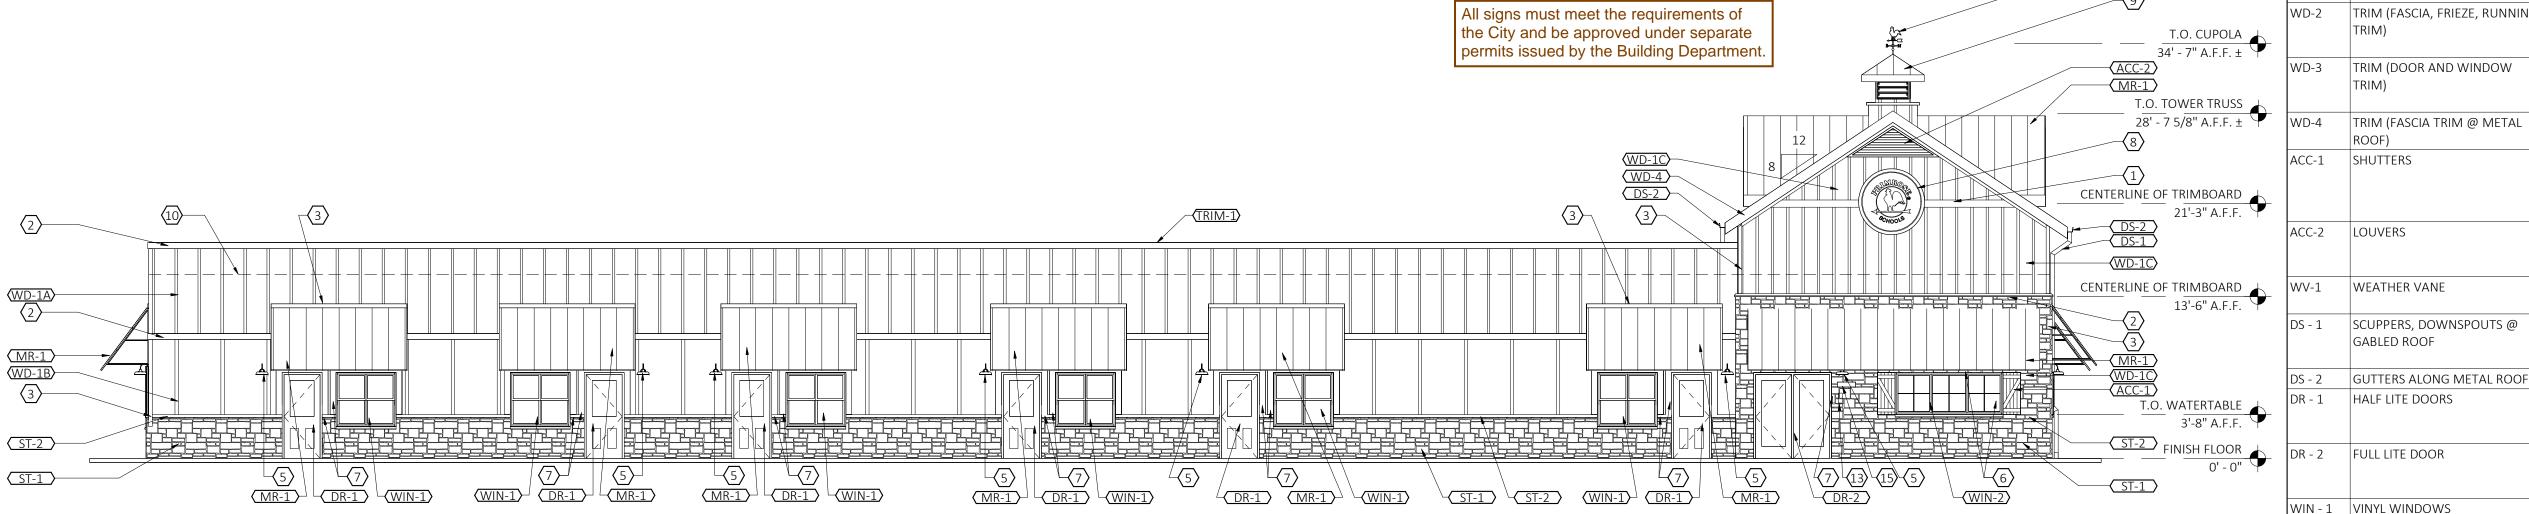

NORTH ELEVATION SCALE: 1/8" = 1'-0"

T.O. CUPOLA 34' - 7" A.F.F. ± T.O. TRUSS ______ A.F.F. ± (WD-4) C.L. OF LOGO 23' - 7" A.F.F. ± (DS-2) CENTERLINE OF TRIMBOARD CENTERLINE OF TRIMBOARD
SEE SECTIONS FOR ELEVATION

CENTERLINE OF TRIMBOARD
10'-2" A.F.F. T.O. WATERTABLE
3'-8" A.F.F. $\frac{\sqrt{\text{WIN-1}}}{\sqrt{\text{MR-1}}}$

BUILDING AREA (PER TABLE 506.2):

ALLOWABLE AREA: 38,000 SF

ALLOWABLE NUMBER OF STORIES: 2

PROPOSED NUMBER OF STORIES: 1

PROPOSED BUILDING HEIGHT: 34'-7"

13,586 SF

MAXIMUM ALLOWABLE BUILDING HEIGHT (PER TABLE 504.3): 60'-0"

PROPOSED AREA:

BUILDING HEIGHT:

WEST ELEVATION A4.0 SCALE: 1/8" = 1'-0"

EAST ELEVATION

(MR-1) (7) (WIN-1) (ST-1) (ST-2)

SCALE: 1/8" = 1'-0"

FINISH FLOOR



NORTH ELEVATION

ELEVATION KEYED NOTES

X

- 2 5/4 x 6 TRIMBOARD, WD 2
- 3 5/4 x 4 TRIMBOARD, WD 2
- 4 42" ROUND LED LIGHTED SIGN (INTERNALLY LIT). SEE 6/A2.4 FOR MOUNTING DETAIL.
- 5 LIGHTING, REFER TO ELECTRICAL DRAWINGS.
- TRIMBOARD AT OFFICE WINDOW: HORIZ TO BE 5/4 x 6, VERT TO BE 5/4 x 4, BOTH WD-3
- TRIMBOARD AT ALL EXTERIOR DOORS AND CLASSROOM WINDOWSA TO BE 5/4 x 6, WD 3
- 8 60" ROUND LED LIGHTED SIGN (INTERNALLY LIT). SEE 6/A2.4 FOR MOUNTING DETAIL
- CUPOLA WITH WEATHERVANE, PAINT ALL SURFACES TO MATCH "ARCTIC WHITE", ROOF TO BE MR - 1 REFER TO 1A/A6.3 FOR CONSTRUCTION.
- 10 ROOF LINE BEHIND PARAPET WALL
- 11 GLAZING TO RECIEVE WINDOW FILM, TINT 1. SEE FINISH SCHEDULE SHEET A2.2
- 12 DOWNSPOUTS TIED INTO UNDERGROUND STORM SEWER BELOW GRADE.
- 13 KNOX BOX OR APPROVED EQUAL. COORDINATE LOCATION WITH LOCAL FIRE OFFICIAL
- 14 4'-0" HIGH SOLID VINYL FENCE WITH (2) 3'-0"W GATES.
- 15 BEIGE ALUMINUM PLAQUE W/6" REFLECTIVE BLACK VINYL NUMBERS. PROVIDED BY 1 HOUR SIGN. COORDINATE LOCATION WITH LOCAL FIRE OFFICIAL














MARK	DESCRIPTION	SPECIFICATION			
MR-1	METAL ROOF	BERRIDGE CEE-LOCK SYSTEM, COLOR: DARK BRONZE.			
ST-1	STONE WAINSCOT	CORONADO: EASTERN MOUNTAIN LEDGE, HURON			
ST-2	STONE CAP @ WAINSCOT	CORONADO: CHISELED STONE SILL. COLOR: TWILIGHT.			
TRIM	MISC METAL TRIM & FLASHING	ANY MISC METAL FLASHING AND TRIM NOT NOTED ITRIM-1. OR TRIM-2 SHOULD MATCH COLOR OF ADJACENT SURFACE. CONTACT ARCHITECT FOR DIRECTION AS REQ'O.			
TRIM-1	MTL TRIM @ METAL ROOF	BM COLOR REVIEW #OC - 21 WINTER WHITE. (COLOR TO MATCH "ARCTIC WHITE")			
TRIM-2	MTL TRIM @ METAL ROOF	COLOR: TO MATCH "MR-1"			
WD-1A	BOARD & BATTEN SIDING (ABOVE 10' - 0")	HARDIE PANEL (4' X 10') & HARDIE TRIM BATTEN BOARDS (2 1/2" WIDE @ 2' - 0" O.C.) FINISH: SMOOTI COLOR: ARCTIC WHITE (PRIMED AND FIELD PAINTED)			
WD-1B	BOARD & BATTEN SIDING (BELOW 10' -0")	HARDIE PANEL (4' X 10') & HARDIE TRIM BATTEN BOARDS (3 1//2" WIDE @ 4' - 0" O.C.) FINISH: SMO(COLOR: ARCTIC WHITE (PRIMED AND FIELD PAINTE			
WD-1C	BOARD & BATTEN SIDING (@ ENTER TOWER)	HARDIE PANEL (4' X 10') & HARDIE TRIM BATTEN BOARDS (2 1/2" WIDE @ 16" O.C.) FINISH; SMOOTH COLOR:ARCTIC WHITE (PRIMED AND FIELD PAINTED)			
WD-2	TRIM (FASCIA, FRIEZE, RUNNING TRIM)	HARDIE TRIM BOARDS, 5/4 NT3 SMOOTH, VARIOUS WIDTHS AS REQUIRED (SEE ELEVATIONS). COLOR: ARCTIC WHITE (PRIMED AND FIELD PAINTED)			
E-DW	TRIM (DOOR AND WINDOW TRIM)	HARDIE TRIM BOARDS, 5/4 NT3 SMOOTH, VARIOUS WIDTHS AS REQUIRED (SEE ELEVATIONS) COLOR: AG PEWTER (PRIMED AND FIELD PAINTED)			
WD-4	TRIM (FASCIA TRIM @ METAL ROOF)	HARDIE TRIM BOARDS, 5/4 NT3 SMOOTH, SEE WALL SECTIONS FOR SIZE: COLOR: PAINT TO MATCH MR-1			
ACC-1	SHUTTERS	EKENA MILLWORK: TWO BATTEN W/Z-BAR BOARD & BATTEN COMPOSITE SHUTTERS, 3' - 6"T x 1' - 6"W. SHUTTERS TO BE ORDERED PRIMED, PAINT TO MATCH "AGED PEWTER"			
ACC-2	LOUVERS	AMERICAN LOUVER & VENT COMPANY, TGV81260 OR APPROVED EQUAL. BM COLOR REVIEW #0C - 21 WINTER WHITE (COLOR TO MATCH "ARCTIC WHITE")			
WV-1	WEATHER VANE	LARGE COPPER ROOSTER WEATHERVANE, SEE 1A/A6.2 FOR ADDITIONAL INFORMATION.			
DS - 1	SCUPPERS, DOWNSPOUTS @ GABLED ROOF	BM COLOR REVIEW #OC - 21 WINTER WHITE. (COLOR TO MATCH "ARCTIC WHITE"): 5" GUTTERS AND DOWN SPOUTS U.N.O.			
DS - 2	GUTTERS ALONG METAL ROOF	COLOR: TO MATCH "MR - 1"			
DR-1	HALF LITE DOORS	EXTERIOR INSULATED METAL HALF LITE DOOR; COLOR (INTERIOR & EXTERIOR): WHITE, SEE DOOR SCHEDULE FOR ADDITIONAL INFORMATION.			
DR-2	FULL LITE DOOR	EXTERIOR INSULATED METAL FULL LITE DOOR: COLOR (INTERIOR & EXTERIOR): WHITE: SEE DOOR SCHEDULE FOR ADDITIONAL INFORMATION.			
WIN - 1	VINYL WINDOWS	ANDERSEN: SILVERLINE 2200 SERIES. COLOR: WHITE. SEE WINDOW SCHEDULE.			
WIN - 2	VINYL WINDOWS (@ OFFICE)	ANDERSEN: 100 SERIES, COLOR: WHITE, SEE WINDOW SCHEDULE			

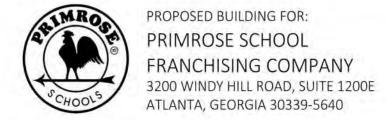





MATERIAL BOARD AND COLORED ELEVATION PRIMROSE SCHOOL

1421 SOUTH ROCHESTER ROAD ROCHESTER HILLS, MI 06/21/23


Additional masonry should be provided on each facade and limit amount of non masonry material

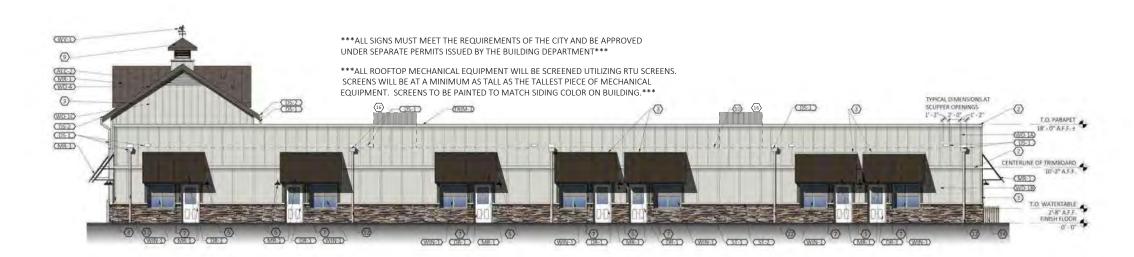


SOUTH ELEVATION

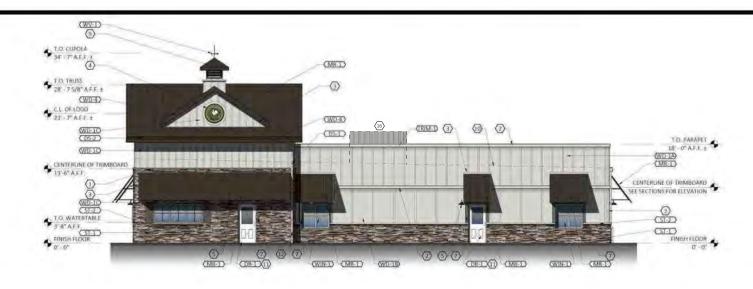


WEST ELEVATION

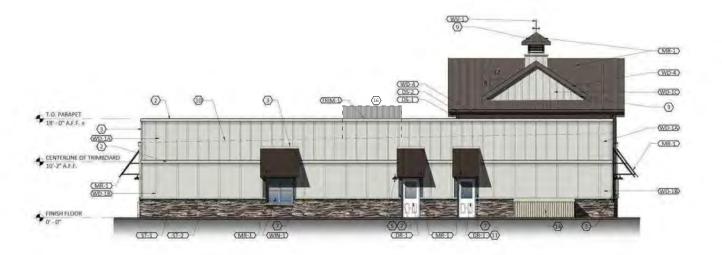

EAST ELEVATION

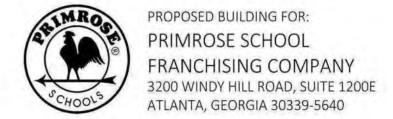

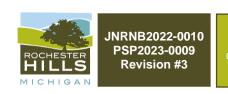

City of Rochester Hill Planning & Economic

PRIMROSE SCHOOL 1421 SOUTH ROCHESTER ROAD ROCHESTER HILLS, MI 06/21/23

COMBINED PLANS.pdf Markup Summary

Building Department (2)

Subject: Building Department

Author: Bluebeam

Date: 7/11/2023 12:57:42 PM

Status:

Question: Unchecked BackCheck: Unchecked Back Checker Initials: CrossCheck- PM: Unchecked

Cross Check Initials:

Mark Artinian 248-841-2446 ArtinianM@RochesterHills.org



Subject: Building Department

Author: Bluebeam

Date: 7/11/2023 12:58:37 PM

Status:

Question: Unchecked BackCheck: Unchecked Back Checker Initials: CrossCheck- PM: Unchecked

Cross Check Initials:

Yes

Engineering Department (2)



Subject: Engineering Department

Author: Jason Boughton Date: 6/27/2023 7:38:07 AM

Status:

Question: Unchecked
BackCheck: Unchecked
Back Checker Initials:
CrossCheck- PM: Unchecked

Cross Check Initials:

The applicant needs to submit a Land Improvement Permit (LIP) application with engineer's estimate, fee and construction plans to proceed with the construction plan review process.

A

Subject: Engineering Department

Author: Jason Boughton Date: 6/27/2023 7:41:50 AM

Status:

Question: Unchecked BackCheck: Unchecked Back Checker Initials: CrossCheck- PM: Unchecked

Cross Check Initials:

Engineering Legal Review (1)



Subject: Engineering Legal Review

Author: Jenny McGuckin Date: 7/5/2023 2:30:53 PM

Status:

Question: Unchecked BackCheck: Unchecked Back Checker Initials: CrossCheck- PM: Unchecked Cross Check Initials: Extend easement 10 feet past stub.

Fire Department (2)

Subject: Fire Department Author: Jon Mills

Date: 6/29/2023 3:03:39 PM

Status:

Question: Unchecked BackCheck: Unchecked **Back Checker Initials:** CrossCheck- PM: Unchecked

Cross Check Initials:

Provide the following on this sheet:

1. A minimum number of 3 hydrants are required on the site with an average spacing of 400'. A maximum distance from any point on street or road

frontage to a hydrant of 225'.

Subject: Fire Department Author: Jon Mills

Date: 6/29/2023 3:03:14 PM

Status:

Question: Unchecked BackCheck: Unchecked **Back Checker Initials:** CrossCheck- PM: Unchecked

Cross Check Initials:

Group (21)



Subject: Group Author: macdonaldj

Date: 6/23/2023 10:21:47 AM

Status:

Question: Unchecked BackCheck: Unchecked **Back Checker Initials:** CrossCheck- PM: Unchecked

Cross Check Initials:

City of Rochester Hills Planning & Economic

Development



Subject: Group Author: C.McLeod

Date: 7/11/2023 10:25:28 AM

Status:

Question: Unchecked BackCheck: Unchecked **Back Checker Initials:** CrossCheck- PM: Unchecked

Cross Check Initials:

SP



Subject: Group Author: C.McLeod

Date: 7/11/2023 10:25:28 AM

Status:

Question: Unchecked BackCheck: Unchecked **Back Checker Initials:**

CrossCheck- PM: Unchecked

Cross Check Initials:

Subject: Group Author: C.McLeod

Date: 7/11/2023 10:25:28 AM

Status:

Question: Unchecked BackCheck: Unchecked **Back Checker Initials:** CrossCheck- PM: Unchecked

Cross Check Initials:



Subject: Group Author: C.McLeod

Date: 7/11/2023 10:25:28 AM

Status:

Question: Unchecked BackCheck: Unchecked **Back Checker Initials:** CrossCheck- PM: Unchecked **Cross Check Initials:**

Subject: Group Author: C.McLeod Date: 7/11/2023 2:40:25 PM

Status:

Question: Unchecked BackCheck: Unchecked **Back Checker Initials:** CrossCheck- PM: Unchecked

Cross Check Initials:

Subject: Group Author: C.McLeod

Date: 7/11/2023 2:40:40 PM

Status:

Question: Unchecked

BackCheck: Unchecked **Back Checker Initials:** CrossCheck- PM: Unchecked

Cross Check Initials:



Subject: Group Author: C.McLeod

Date: 7/11/2023 2:40:44 PM

Status:

Question: Unchecked BackCheck: Unchecked **Back Checker Initials:** CrossCheck- PM: Unchecked

Cross Check Initials:



Subject: Group Author: C.McLeod Date: 7/11/2023 2:40:47 PM

Status:

Question: Unchecked

BackCheck: Unchecked **Back Checker Initials:** CrossCheck- PM: Unchecked

Cross Check Initials:



Subject: Group Author: C.McLeod Date: 7/11/2023 2:40:55 PM

Status:

Question: Unchecked BackCheck: Unchecked **Back Checker Initials:** CrossCheck- PM: Unchecked

Cross Check Initials:

Received 6/23/2023

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City of Rochester Hills Planning & Economic

Development



Subject: Group Author: C.McLeod

Date: 7/11/2023 2:41:03 PM

Status:

Question: Unchecked BackCheck: Unchecked **Back Checker Initials:** CrossCheck- PM: Unchecked

Cross Check Initials:

Received 6/23/2023

City of Rochester Hills Planning & Economic

Development



Subject: Group Author: C.McLeod

Date: 7/11/2023 2:41:08 PM

Status:

Question: Unchecked BackCheck: Unchecked **Back Checker Initials:** CrossCheck- PM: Unchecked

Cross Check Initials:

Received 6/23/2023

City of Rochester Hills Planning & Economic

Development



Subject: Group Author: C.McLeod

Date: 7/11/2023 2:41:12 PM

Status:

Question: Unchecked BackCheck: Unchecked **Back Checker Initials:** CrossCheck- PM: Unchecked

Cross Check Initials:

Received 6/23/2023

City of Rochester Hills Planning & Economic

Development



Subject: Group Author: C.McLeod

Date: 7/11/2023 2:41:21 PM

Status:

Question: Unchecked BackCheck: Unchecked **Back Checker Initials:** CrossCheck- PM: Unchecked

Cross Check Initials:

Received 6/23/2023

City of Rochester Hills Planning & Economic

Development



Subject: Group Author: C.McLeod Date: 7/11/2023 2:41:25 PM

Status:

Question: Unchecked

BackCheck: Unchecked **Back Checker Initials:** CrossCheck- PM: Unchecked

Cross Check Initials:

Received 6/23/2023

City of Rochester Hills Planning & Economic

Development



Subject: Group Author: C.McLeod Date: 7/11/2023 2:41:32 PM

Status:

Question: Unchecked BackCheck: Unchecked **Back Checker Initials:** CrossCheck- PM: Unchecked

Cross Check Initials:

Received 6/23/2023

City of Rochester Hills Planning & Economic

Development



Subject: Group Author: C.McLeod

Date: 7/11/2023 2:41:39 PM

Status:

Question: Unchecked BackCheck: Unchecked

Back Checker Initials:
CrossCheck- PM: Unchecked

Cross Check Initials:

Received 6/23/2023

City of Rochester Hills Planning & Economic

Development

- Section 1

Subject: Group Author: C.McLeod Date: 7/11/2023 2:41:43 PM

Ctatura

Question: Unchecked BackCheck: Unchecked Back Checker Initials:

Cross Check Initials:

Received 6/23/2023

City of Rochester Hills Planning & Economic

Development

- Secret

Subject: Group Author: C.McLeod

Date: 7/11/2023 2:41:48 PM

Status:

Question: Unchecked

BackCheck: Unchecked Back Checker Initials: CrossCheck- PM: Unchecked

Cross Check Initials:

Received 6/23/2023

City of Rochester Hills Planning & Economic

Development



Subject: Group Author: C.McLeod

Date: 7/11/2023 2:42:23 PM

Status:

Question: Unchecked BackCheck: Unchecked

Back Checker Initials: CrossCheck- PM: Unchecked

Cross Check Initials:

Received 6/23/2023

City of Rochester Hills Planning & Economic

Development



Subject: Group Author: C.McLeod Date: 7/11/2023 2:42:29 PM

Status:

Question: Unchecked

BackCheck: Unchecked Back Checker Initials: CrossCheck- PM: Unchecked

Cross Check Initials:

Received 6/23/2023

City of Rochester Hills Planning & Economic

Development

Highlight (6)



Subject: Highlight Author: Jon Mills

Date: 6/26/2023 8:30:59 AM

Status:

Question: Unchecked BackCheck: Unchecked Back Checker Initials: CrossCheck- PM: Unchecked

Cross Check Initials:



Subject: Highlight Author: Jon Mills

Date: 6/26/2023 8:31:11 AM

Status:

Question: Unchecked BackCheck: Unchecked Back Checker Initials: CrossCheck- PM: Unchecked

Cross Check Initials:



Subject: Highlight Author: Jon Mills

Date: 6/26/2023 8:31:48 AM

Status:

Question: Unchecked BackCheck: Unchecked Back Checker Initials: CrossCheck- PM: Unchecked

Cross Check Initials:



Subject: Highlight **Author:** Jon Mills

Date: 6/26/2023 8:32:07 AM

Status:

Question: Unchecked BackCheck: Unchecked Back Checker Initials: CrossCheck- PM: Unchecked

Cross Check Initials:



Subject: Highlight Author: Jon Mills

Date: 6/26/2023 8:32:21 AM

Status:

Question: Unchecked BackCheck: Unchecked Back Checker Initials: CrossCheck- PM: Unchecked

Cross Check Initials:



Subject: Highlight Author: Jon Mills

Date: 6/26/2023 8:36:41 AM

Status:

Question: Unchecked BackCheck: Unchecked Back Checker Initials: CrossCheck- PM: Unchecked

Cross Check Initials:

Jenny McGuckin - YES (1)

Subject: Jenny McGuckin - YES Author: Jenny McGuckin Date: 7/5/2023 2:45:32 PM

Status:

Question: Unchecked
BackCheck: Unchecked
Back Checker Initials:
CrossCheck- PM: Unchecked

Cross Check Initials:

Natural Resouces (1)


Subject: Natural Resouces Author: Matt Einheuser Date: 6/27/2023 11:26:48 AM

Status:

Question: Unchecked BackCheck: Unchecked **Back Checker Initials:** CrossCheck- PM: Unchecked

Cross Check Initials:

Planning Department (15)

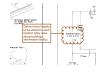

Subject: Planning Department

Author: C.McLeod

Date: 6/27/2023 9:11:38 AM

Status:

Question: Unchecked BackCheck: Unchecked **Back Checker Initials:** CrossCheck- PM: Unchecked

Cross Check Initials:

Define fence heights to be utilized in each location (play area, along buildings, stormwater facility).



Subject: Planning Department

Author: C.McLeod

Date: 7/5/2023 4:05:14 PM

Status:

Question: Unchecked BackCheck: Unchecked **Back Checker Initials:** CrossCheck- PM: Unchecked

Cross Check Initials:

What is area is considered to be a part of the 2.03

acres.

Subject: Planning Department

Author: C.McLeod

Date: 7/11/2023 9:37:54 AM

Status:

Question: Unchecked BackCheck: Unchecked **Back Checker Initials:** CrossCheck- PM: Unchecked

Cross Check Initials:

Assessing

Yes

Subject: Planning Department

Author: C.McLeod

Date: 7/11/2023 9:40:14 AM

Status:

Question: Unchecked BackCheck: Unchecked **Back Checker Initials:** CrossCheck- PM: Unchecked

Cross Check Initials:

Additional masonry should be provided on each facade and limit amount of non masonry material

Subject: Planning Department

Author: C.McLeod

Date: 7/11/2023 10:25:03 AM

Status:

Question: Unchecked BackCheck: Unchecked **Back Checker Initials:** CrossCheck- PM: Unchecked

Cross Check Initials:

For all conditional uses, a "Conditional Use Proposed Sign" shall be placed onsite no less than fifteen (15) days prior to the public hearing date. Such sign shall be compliant with Section

138-1.203 of City Ordinances.

Subject: Planning Department

Author: C.McLeod

Date: 7/11/2023 10:25:11 AM

Status:

Question: Unchecked BackCheck: Unchecked Back Checker Initials: CrossCheck- PM: Unchecked

Cross Check Initials:

"All plan review comments must be addressed prior to scheduling for the Planning Commission, unless otherwise noted."

DVERHANG—

All sines must meat the requirements of \$4EVATI

Subject: Planning Department

Author: C.McLeod

Date: 7/11/2023 12:32:58 PM

Status:

Question: Unchecked BackCheck: Unchecked Back Checker Initials: CrossCheck- PM: Unchecked

Cross Check Initials:

All signs must meet the requirements of the City and be approved under separate permits issued by the Building Department.

All signs must meet the requirements of the City and be approved under separate nemits issued by the Ruilifum Department **Subject:** Planning Department

Author: C.McLeod

Date: 7/11/2023 2:42:12 PM

Status:

Question: Unchecked BackCheck: Unchecked Back Checker Initials: CrossCheck- PM: Unchecked

Cross Check Initials:

All signs must meet the requirements of the City and be approved under separate permits issued by

the Building Department.

.....

Subject: Planning Department

Author: C.McLeod

Date: 7/11/2023 2:43:39 PM

Status:

Question: Unchecked
BackCheck: Unchecked
Back Checker Initials:
CrossCheck- PM: Unchecked

Cross Check Initials:



Subject: Planning Department

Author: C.McLeod

Date: 7/11/2023 2:46:12 PM

Status:

Question: Unchecked BackCheck: Unchecked Back Checker Initials: CrossCheck- PM: Unchecked

Cross Check Initials:

SECTION 138-4.424 - Nursery Schools, Day Nurseries and Child Care Centers

A.Such facilities shall be located on major thoroughfares with an existing or proposed right-of-way of 120 feet. Additionally, the facility shall be on a corner lot or shall directly abut nonresidential zoning on at least one side, and such zoning shall be on the same side of the major thoroughfare.

B.Hours of operation shall not exceed 15 hours a day with closing time of not later than 9:00 p.m. C.All parking and child dropoff areas shall be in the side or rear yard only. This requirement may be waived when an existing building that has front yard parking or circulation is being occupied by a nursery school, day nursery, or child care center. D.Outdoor play areas shall be in the side or rear yard in the amount required by the Licensing Rules for Child Care Centers as set forth by the State of Michigan.

E.Parking, dropoff, and play areas shall be screened in a manner deemed sufficient by the Planning Commission to achieve the objective of screening and controlling noise levels.

F.Any trash receptacle shall be screened with a six-foot-high obscuring fence or wall, with evergreen screening provided on the three sides of the enclosure without access gates.

G.Lighting shall be shielded downward so as not to become a nuisance to abutting property.
H.Front, side and rear elevations of the building shall be provided to ensure that the use will have

shall be provided to ensure that the use will have the appearance and character of residences in the vicinity. If there are no residences within 200 feet, in making a determination on the compatibility of such uses, the following architectural features shall be reviewed:

- 1.Roof pitch, overhang, and drainage.
- 2. Window sills and other window features.
- 3. Facade treatment (both material and appearance).
 - 4. Entrance features.
 - 5. Heating exhaust devices.
- 6.Penthouses or similar mechanical rooftop features shall be prohibited unless completely screened from adjacent properties and the adjacent public right-of-way.

I. Signs shall meet the requirements of Chapter 134 of the City's Code of Ordinances.

J.The facility shall comply with applicable state licensing requirements and regulations.
K.Any other conditions which the Planning Commission and City Council deem necessary to ensure that the residential character of the neighborhood shall be maintained.

Subject: Planning Department

Author: C.McLeod

Date: 7/11/2023 2:47:42 PM

Status:

Question: Unchecked
BackCheck: Unchecked
Back Checker Initials:
CrossCheck- PM: Unchecked

Cross Check Initials:

Can be detailed as a part of conditions review of site plan review should the project be approved.



Subject: Planning Department

Author: C.McLeod

Date: 7/11/2023 2:49:03 PM

Status:

Question: Unchecked BackCheck: Unchecked Back Checker Initials: CrossCheck- PM: Unchecked

Cross Check Initials:

Parking, dropoff, and play areas shall be screened in a manner deemed sufficient by the Planning Commission to achieve the objective of screening and controlling noise levels.



Subject: Planning Department

Author: C.McLeod

Date: 7/11/2023 2:49:52 PM

Status:

Question: Unchecked
BackCheck: Unchecked
Back Checker Initials:
CrossCheck- PM: Unchecked

Cross Check Initials:

Evergreen screening along eastern property line may need to be increased to help screen headlights and noise from abutting residential uses.



Subject: Planning Department

Author: C.McLeod

Date: 7/11/2023 2:51:59 PM

Status:

Question: Unchecked BackCheck: Unchecked Back Checker Initials: CrossCheck- PM: Unchecked

Cross Check Initials:

Provide decorative fixture ("B") in public areas.



Subject: Planning Department

Author: C.McLeod

Date: 7/11/2023 2:53:44 PM

Status:

Question: Unchecked BackCheck: Unchecked Back Checker Initials: CrossCheck- PM: Unchecked

Cross Check Initials:

To be provided at a later date

Underground Utilities (1)



Subject: Underground Utilities Author: Jason Boughton Date: 6/27/2023 7:39:21 AM

Status:

Question: Unchecked
BackCheck: Unchecked
Back Checker Initials:
CrossCheck- PM: Unchecked
Cross Check Initials:

Maintain 10 foot horizontal separation, revise as necessary