

ZONED FB-2

DECIDUOUS TREE PLANT LIST:

QUANTITY KEY SYMBOL COMMON NAME

Allegheny Serviceberry

SCIENTIFIC NAME Amelanchier laevis

LANDSCAPE CALCULATIONS: R-4 (ONE FAMILY RESIDENTIAL)

PER CITY OF ROCHESTER HILLS ZONING ORDINANCE

SIZE SPEC

10' Ht. B&B







MPLIED AS TO THE COMPLETENESS OR ACCURACY THEREO

DETERMINING THE EXACT UTILITY LOCATIONS AND ELEVATIONS PRIOR TO THE START OF CONSTRUCTION.

3221 W. BIG BEAVER ROAD, SUITE 111

**PRELIMINARY** LANDSCAPE

2022-1301 BGG JLE

CITY FILE NO. 22-041 SECTION 23



## JNRNB2022-0010 PSP2023-0009 **Revision #5** (partial submittal) Received 8/4/2023

**City of Rochester** Hills Planning & **Economic Development** 

**Site Plan Review**A review of this partial submittal was completed by Planning and Natural Resources.
Conditions and mark-ups noted throughout plan set must be addressed prior to final approval and are in addition to comments noted on the full site plan set.

Department	Reviewer	Approved
Assessing	N/A	N/A
Building	N/A	N/A
Engineering - Utilities	N/A	N/A
Engineering Legal	N/A	N/A
Fire	N/A	N/A
Natural Resources	Matt Einheuser 248-841-2551 EinheuserM@RochesterHills.org	Yes
Planning	Chris McLeod 248-841-2572 mcleodc@RochesterHills.org	Yes
Traffic	N/A	N/A







little tikes

COMMERCIAL

Playgrounds Fun & Easy!™

PRIMROSE STANDARD PLAYGROUND PACKAGE



## **Standard Primrose Package**

- Infant Area
  - PlayBuilder 3-Panel Infant Unit
  - 12' x 12' x 8' Independent Shade
- Early Preschool Area (EPS)
  - Tot Tree (special colors for Primrose)
  - PlayBuilder Ground Unit
  - 14' x 14' Shade Topper (Integrated into Playground Structure)
  - MaxPlay Swing 8' Beam with Tot Seats
- Pre-School Area
  - KidBuilder Firetruck Unit
  - 18' x 30' Shade Topper (Integrated into Playground Structure)
  - MaxPlay Swing 8' Beam with Belt Seats

- Additional Items Needed:
  - Junior Picnic Tables Qty 3 (EPS, PS, and AS Areas)
  - Kid Timbers
    - Primrose Patch (Qty 6)
    - Loose Fill Border if needed





## INFANT PLAY 3-Panel Unit and 12' X 12' X 8' Ind Shade Green





## ADDITIONAL ITEMS Primrose Patch





## General Notes:

## Age Group $\bigcirc$ 6-23 months $\bigcirc$ 2-5 years ☐ 5-12 years ☐ 2-12 years

- 1. The Americans with Disabilities Act (ADA) may require that you make your park and/or playground accessible when viewed in its entirety. Please consult your legal counsel to determine if the ADA applies to you.

  2. For playground equipment to be considered accessible, accessible surfacing must be utilized in applicable areas.

  3. Although a particular playground design may not meet the proposed Access Board Regulations in regards to the appropriate number of ground level events, the actual playground may be in compliance when considering existing play components.


  4. All deck heights are measured from top of ground cover.


  5. Fall absorbing ground cover is required under and around all play equipment.

  6. The minimum recommended fall zone around the entire playstructure is shown. This zone is to be free of all tripping or collision hazards (i.e. roots, rocks, border material, etc.).

  7. All post lengths are identified by text showing the post lengths, i.e. 96 represents a 96 inch post.

  8. Not all equipment may be appropriate for all children. Supervision is required.

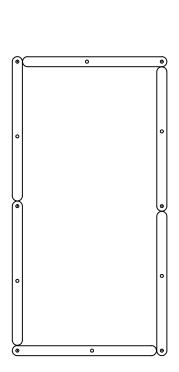

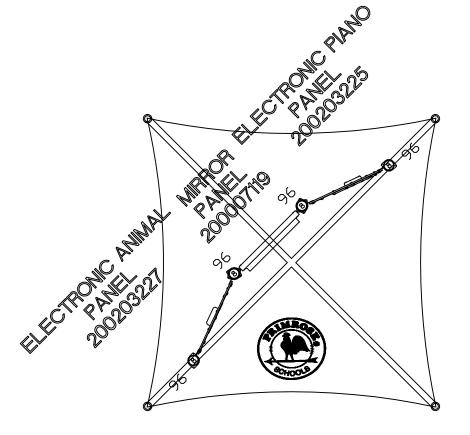



Playgrounds Fun & Easy!

Project: Primrose Infant with Shade LTCPS rep: Jolean Boyer LTCPS 573-760-7390

Drawn by: Gabe Lindsey Date: 04/05/2018 DWG Name: QU070625

Scale: 1/4"=1' Approved by:

LTCPS - Farmington One Iron Mountain Drive Farmington, Missouri 63640 Voice: 1-800-325-8828

Fax: 573-756-0319

Playground Layout Compliance:

✓ ASTM F1487 - Playground Equipment for Public Use. ✓ ASTM F2373 - Playground


Equipment for Public Use.

CPSC Handbook for Public Playground Safety

☐ This playground design meets the final Access Board Regulations



The play components identified in this plan are IPEMA certified. The use and layout of these components conform to the requirements of ASTM F1487.

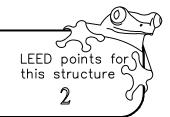



## EARLY PRESCHOOL PB Ground Unit with Shade Topper







# **EARLY PRESCHOOL MaxPlay Tot Swings**







## **EARLY PRESCHOOL**Tot Tree






## General Notes:


Age Group 6-23 months 2-5 years ☐ 5-12 years ☐ 2-12 years

- The Americans with Disabilities Act (ADA) may require that you make your park and/or playground accessible when viewed in its entirety. Please consult your legal counsel to determine if the ADA applies to you.


   For playground equipment to be considered accessible, accessible particular than the players.
- For playground equipment to be considered accessible, accessible surfacing must be utilized in applicable areas.
   Although a particular playground design may not meet the proposed Access Board Regulations in regards to the appropriate number of ground level events, the actual playground may be in compliance when considering existing play components.
   All deck heights are measured from top of ground cover.
   Eall descripting around cover is required under and
- 4. All deck heights are measured from top of ground cover.
  5. Fall absorbing ground cover is required under and around all play equipment.
  6. The minimum recommended fall zone around the entire playstructure is shown. This zone is to be free of all tripping or collision hazards (i.e. roots, rocks, border material, etc.).
  7. All post lengths are identified by text showing the post lengths, i.e. 96 represents a 96 inch post.
  8. Not all equipment may be appropriate for all children. Supervision is required.

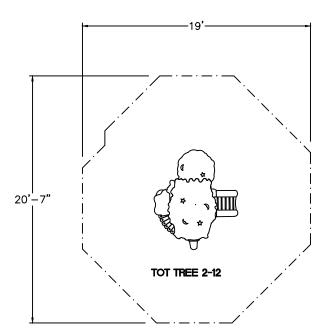

Minimal recommended fallzone Area 308 sa. feet Perimeter 64 feet

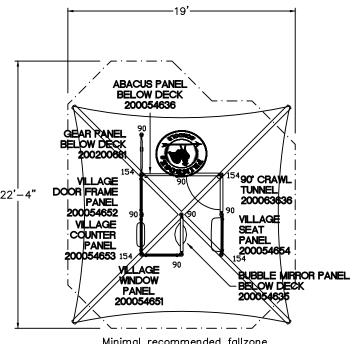

Minimal recommended fallzone Area 368 sq. feet Perimeter 72 feet

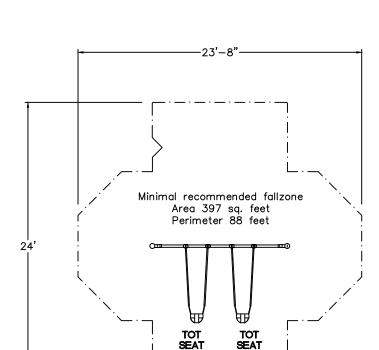

200202836 200202836



Playgrounds Fun & Easy!

Project: Primrose Early Preschool with Shade Topper LTCPS rep: Jolean Boyer LTCPS 573-760-7390

Drawn by: Gabe Lindsey Date: 12/3/2020

DWG Name: QU070623

Scale: 1/8"=1' Approved by:

LTCPS - Farmington One Iron Mountain Drive Farmington, Missouri 63640 Voice: 1-800-325-8828

Fax: 573-756-0319

Playground Layout Compliance:


✓ ASTM F1487 - Playground Equipment for Public Use. ✓ ASTM F2373 - Playground Equipment for Public Use.

CPSC Handbook for Public Playground Safety

☐ This playground design meets the final Access Board Regulations



The play components identified in this plan are IPEMA certified. The use and layout of these components conform to the requirements of ASTM F1487.

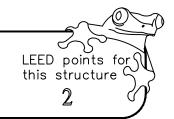





## PRESCHOOL Firetruck Unit with Shade Topper









# PRESCHOOL/AFTER SCHOOL Belt Swings








## ADDITIONAL ITEMS JR Picnic Table – One in Each Play Area





## Play Areas



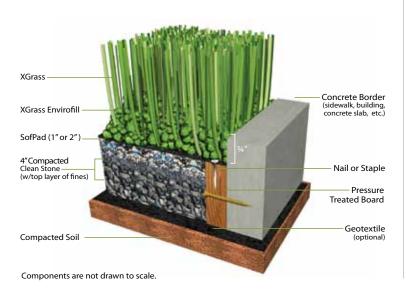



IPEMA certified, meets ASTM F1292 requirements for up to a 12'fall height, Compliant with HIC standard

Low Maintenance
Eliminates constant maintenance of loose fill surfacing

Kid-Friendly
Dries quickly, allowing children to play immediately following a rain, Reduces allergic reactions caused by grass

Environmentally Friendly Earn up to 6 LEED points



XGrass synthetic turf meets ASTM 1292 requirements.



SofPad is our innovative pad providing the ultimate shock absorption and drainage.



XGrass synthetic turf ensures safety and accessibility across installations.







## SYNTHETIC GRASS PLAYGROUND SAFETY SURFACING SPECIFICATION

### **PART 1 - GENERAL**

### 1.1 DESCRIPTION OF WORK

- 1. Provide all labor, materials, equipment, and tools necessary for the complete installation of synthetic grass safety surface. Surface shall meet the requirements of ASTM F1292-13, that states that the surface must yield both a peak deceleration of no more than 200 g's and a Head Injury Criteria (HIC) value of no more than 1,000 for a headfirst fall from the accessible height of the play equipment. System must be IPEMA certified and supported by test data that is less than 3 years executed. The system shall consist of, but not necessarily be limited to, the following:
  - a. Synthetic grass consisting of fibers that are 1.55" long. Turf fiber construction consisting of polyethylene monofilament and texturized polyethylene thatch tufted to a 2-layer stabilized woven polypropylene fabric (primary backing), with a secondary backing (stitch binder) of DuraFlo. (XGrass<sup>®</sup> Prime synthetic turf).
  - b. Pad underlayment system consisting of porous closed cell composite materials. Thickness and density of panels shall be sufficient so that system meets the requirements of ASTM F1292-13. (SofPad™)
  - c. Synthetic Grass Infill, consisting of anti-microbial acrylic coated round silica particles, designed to provide the look, feel, and performance of optimally maintained natural grass. (EnviroFill®)
  - d. 1/2" Screenings, 3/4" clean aggregate, compacted 4" deep
  - e. Synthetic grass shall be CPSIA compliant with valid supporting test documents

### 1.2 SUBMITTALS

- 1. Product Data: Submit manufacturer's product data, including installation instructions and subsurface instructions.
- 2. Samples: Submit samples of synthetic grass, infill, pad underlayment.
- 3. Warranty: Submit manufacturer's standard 10-year warranty.

### **PART 2 - PRODUCTS**

#### 2.1 SYNTHETIC GRASS SAFETY SURFACE

- 1. Aggregate Base Crushed angular hard stone, 3/4" minus compactible stone (not clean) or clean stone with top layer of compacted fines. (Refer to Section 3.2-4).
- 2. Synthetic grass: 1.55" XGrass<sup>®</sup> Prime Synthetic Turf from XGrass, 1224 Riverbend Dr. Dalton, GA 30721, Phone (877) 881-8477
  - a. Face Weight: 53 oz/sy
  - b. Face Yarn Type: Polyethylene
  - c. Yarn Size: 10800/7300
  - d. Pile Height: 1.55"
  - e. Color: Summer Blend (Heat Block)
  - f. Construction: Broadloom tufted
  - g. Stitch Rate: 8 per 3 inches



h. Tufting Gauge: 3/8"i. Tuft Bind: 13.1 lbs

j. Permeability: 405.7 inches/hour

k. Primary Backing: Stabilized dual layered woven polypropylene

I. Secondary Backing: 10 oz. DuraFlom. Total Product Weight: 72.7 oz/syn. Finished Roll Width: 180" untrimmed

o. Warranty: 10 Year

p. Manufactured in the USA, Internationally manufactured products will not be accepted

3. Pad Underlayment System: SofPad™ 100% recycled, non-contaminated, Post industrial cross-link, closed cell Polyethylene – polyolefin foam pad from XGrass.

a. Foam Type: Polyethylene – Polyolefin

b. Bulk Density: 5.0-8.0 lb/cu ft

c. Effective Size: 24 sq ft (net coverage)

d. Tensile Strength: 34-36 psi

4. Synthetic Grass Infill: EnviroFill<sup>®</sup> from XGrass, 1224 Riverbend Dr. Dalton, GA 30721, Phone (877) 881-8477. Coating: Priority acrylic with Microban®, iron oxide and chromium oxide.

a. Grain shape: Hardness: 6-8 Mohs

b. Curvature: 0.7+

c. Specific Gravity: 1.76 g/cm3d. Bulk Density: 110 lb/cu ft

e. Uniform Coefficient: 1.10 to 1.40f. Effective Size: .84 –1.68 mm

- 5. Splicing Material: 1000 denier coated nylon (Cordura®) 12" wide minimum.
- 6. Adhesive: Synthetic Turf Adhesive (from XGrass)

#### **PART 3 - EXECUTION**

### **3.1 GROUND PREPARATION**

- General: The ground area to receive synthetic grass safety surface is indicated on the Drawings.
- 2. Leveling and Site Preparation: All organic material and organic debris to be removed. Soil to be graded level and stabilized (compacted) 6-7 " below grade, per site requirements. Compaction shall be done with mechanical compactors, including vibratory compactors, and/or powered tampers, and rollers.

### 3.2 BASE AND SYNTHETIC GRASS CONSTRUCTION

1. General: The area to be smooth and graded to allow for proper drainage. Refer to engineered grading plan if available. The overall grade of the playground is not to exceed 3%.




- 2. Nailer Board: Installation of pressure treated or composite board per site requirements.
  - a. Concrete edges: Nailer board attached directly to vertical concrete edge with a Tapcon hardware situated 3/4" below concrete grade.
  - b. Non-concrete edges: Nailer board installed with round, steel stake, 3 per 10' board. Top of nailer boards to be situated 3/4" below grade.
- 3. Optional layer of geotextile fabric
- 4. Compacted Aggregate Base: Place 4" of 3/4" clean aggregate base and 1/2" of screening as leveling layer compacted to 90% of max density per AASHTO T99 or 3/4" minus compactible stone. Compaction shall be done with mechanical compactors, including vibratory compactors, and/or powered tampers, and rollers.
- 5. Underlayment Pad: Lay underlayment pad with seam staggered, trimming edge to fit flush against the nailer board.
- 6. Synthetic Grass: Place turf and cut to fit configuration as shown on Drawings. Splice seams. All seams must be attached with splicing film/fabric and adhesive as approved by the manufacturer for this type of installation of their product.
- 7. Anchoring/Edging: Edges of turf will be secured to nailer board perimeter.
- 8. Infill: Apply layers of synthetic grass infill evenly with a drop spreader and broom the turf fibers with stiff bristle broom to stand fibers up and allow infill to settle into the bottom. Broom in infill round quartz silica sand approximately 3 pounds per square foot.


### PART 4 - WARRANTY 4.1 WARRANTY

1. Please refer to the current XGrass warranty for details.

## PRIMROSE SCHOOL

VACANT LOT - NORTHEAST CORNER ROCHESTER ROAD AND EDDINGTON BLVD CITY OF ROCHESTER HILLS, OAKLAND COUNTY, MICHIGAN

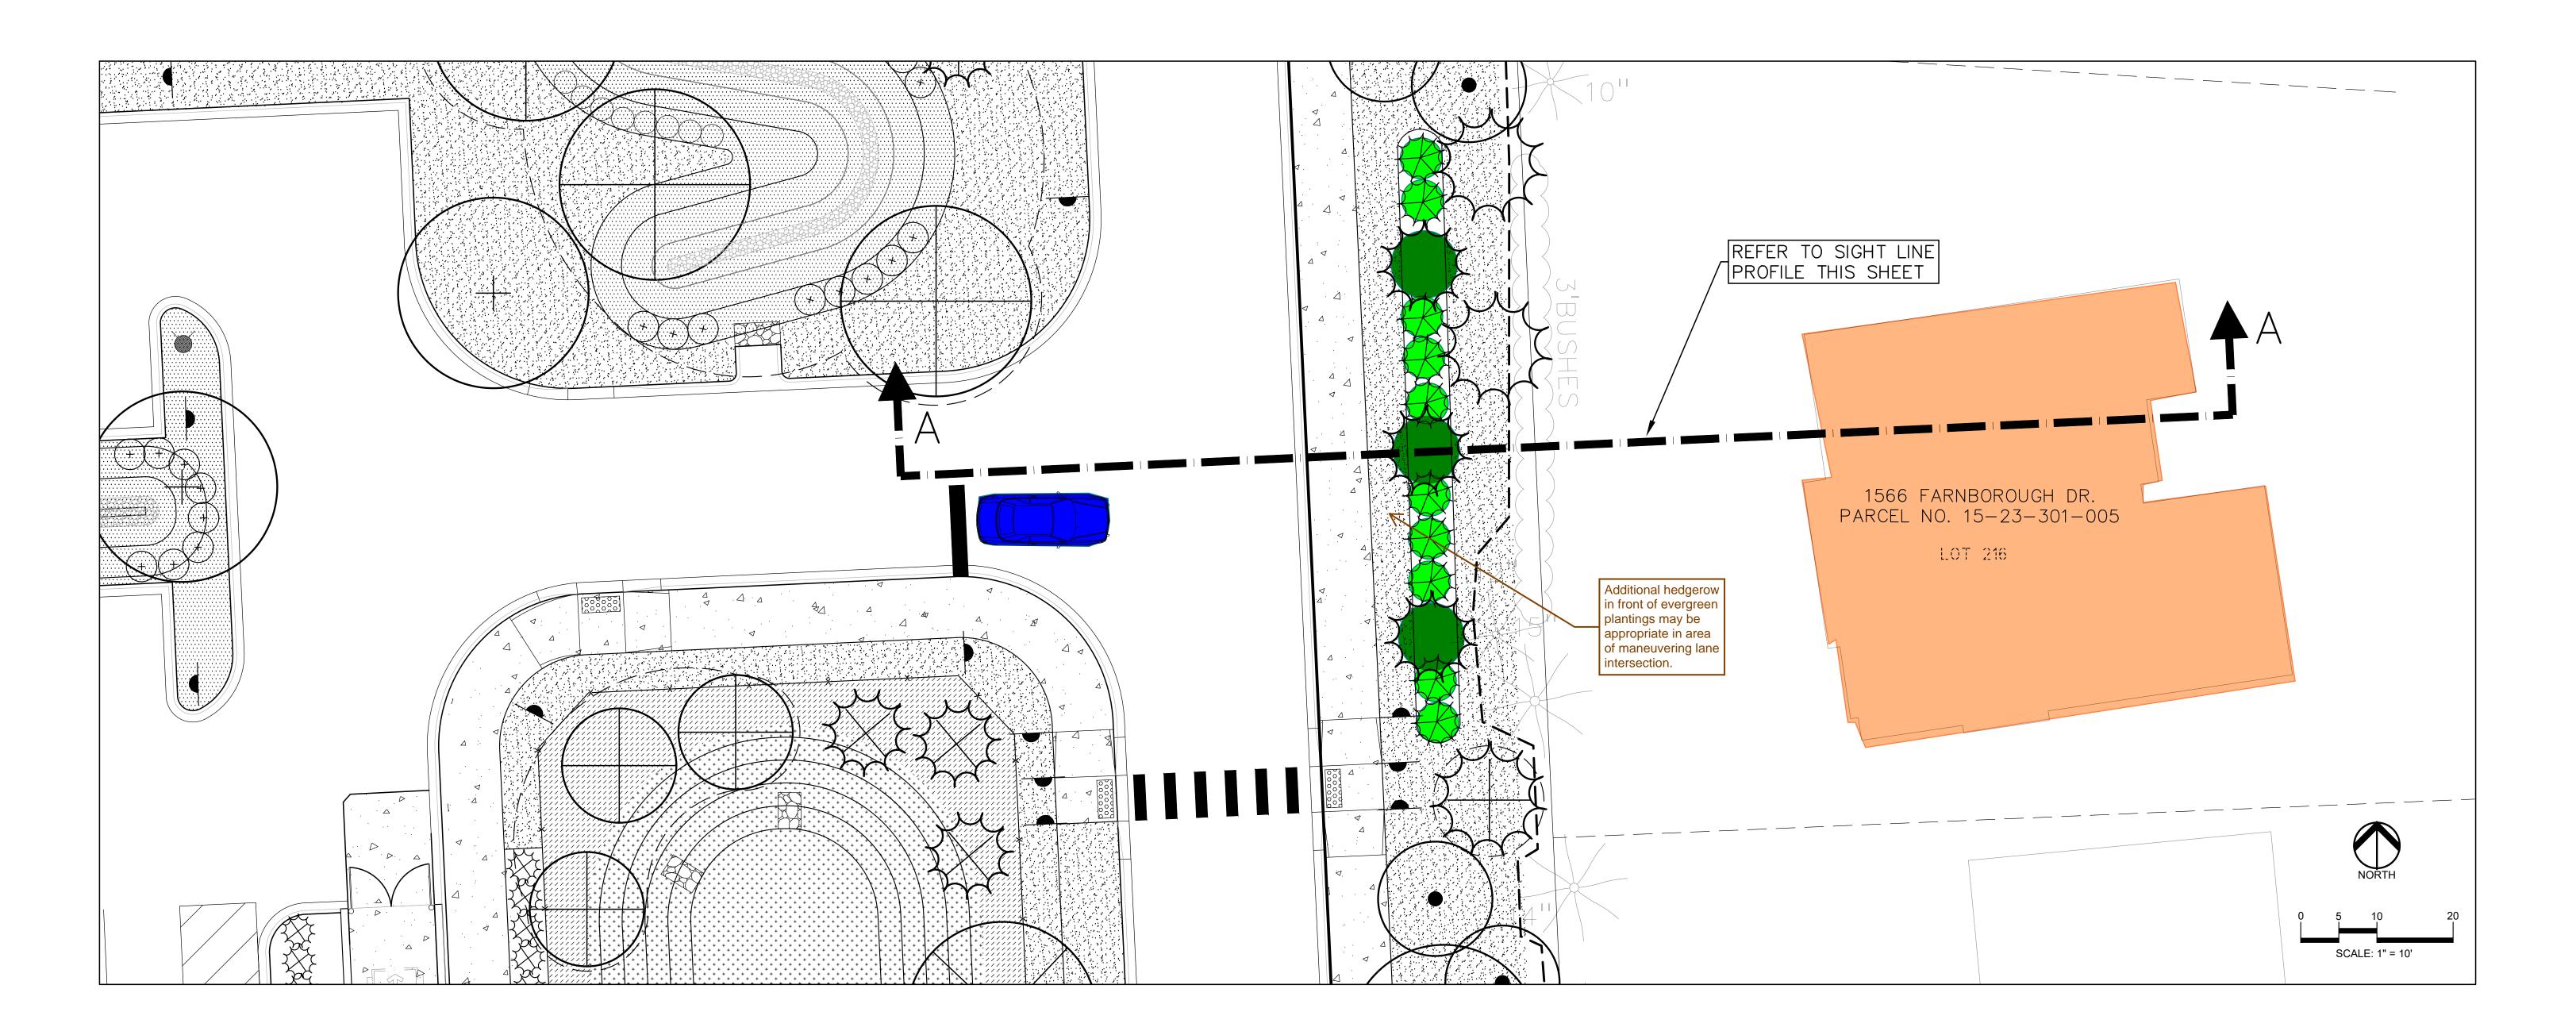

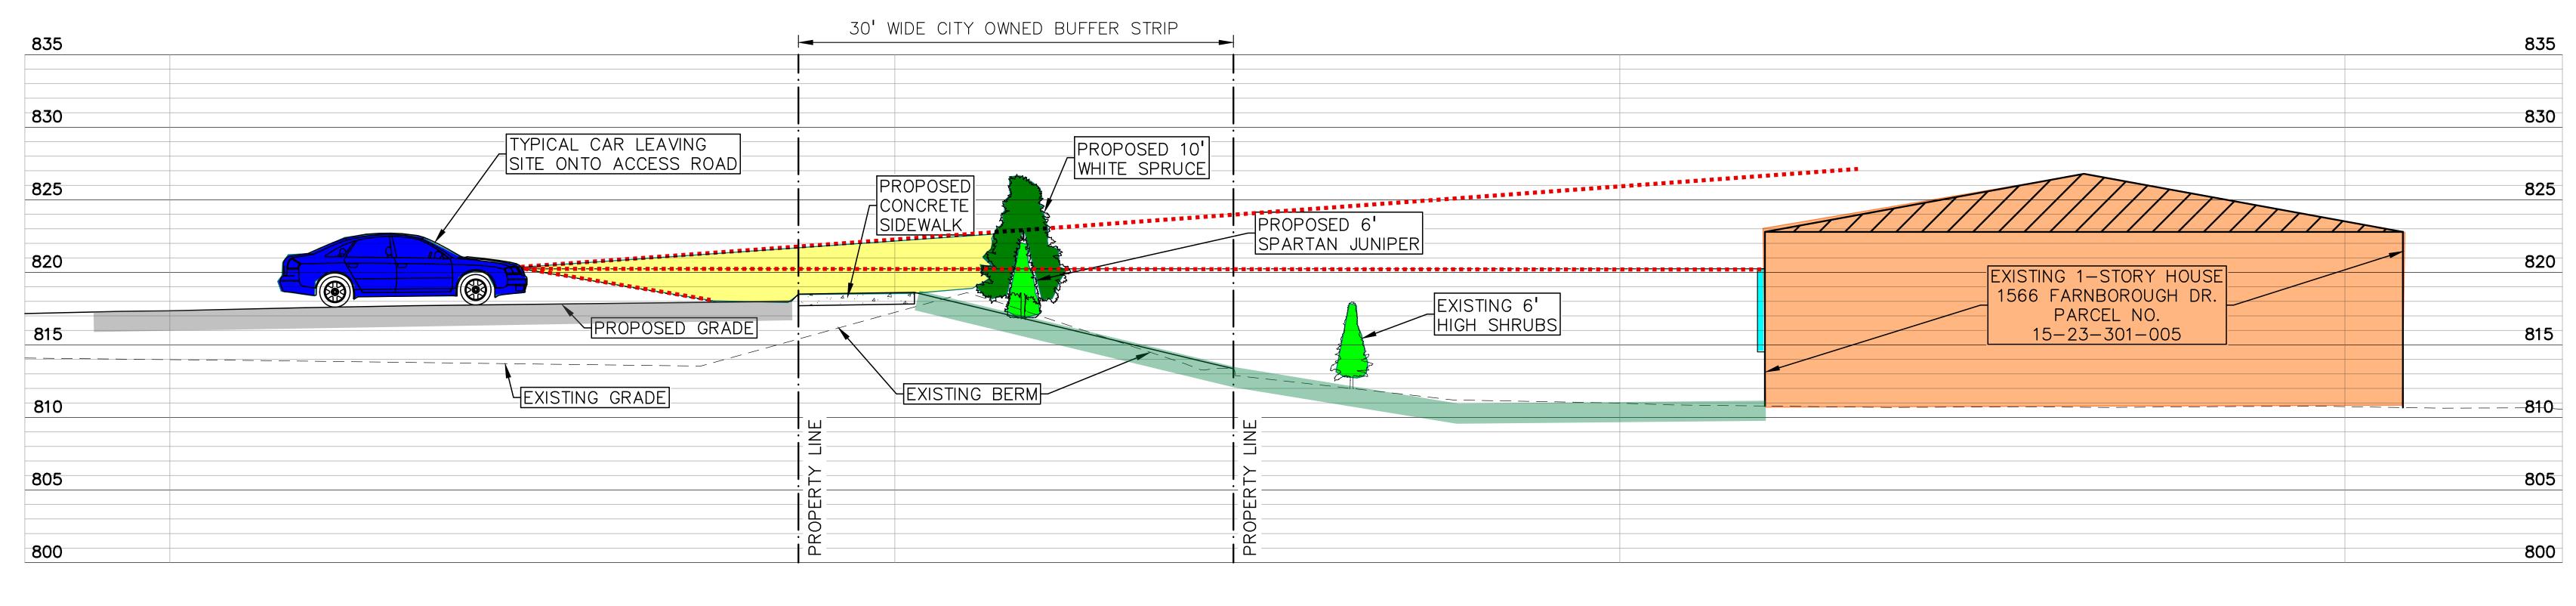







E A JOB NO. 22-1301

S: \PROJECTS\2022\2022-1301 EIGI4T ROCHESTER RD. ROCHESTER HILLS\DWG\EXHIBIT\SIGHT PROFILE\((C-3.2)\SITE \PROFILE\-22-1301.dwg\)

## PRIMROSE SCHOOL

VACANT LOT - NORTHEAST CORNER ROCHESTER ROAD AND EDDINGTON BLVD CITY OF ROCHESTER HILLS, OAKLAND COUNTY, MICHIGAN

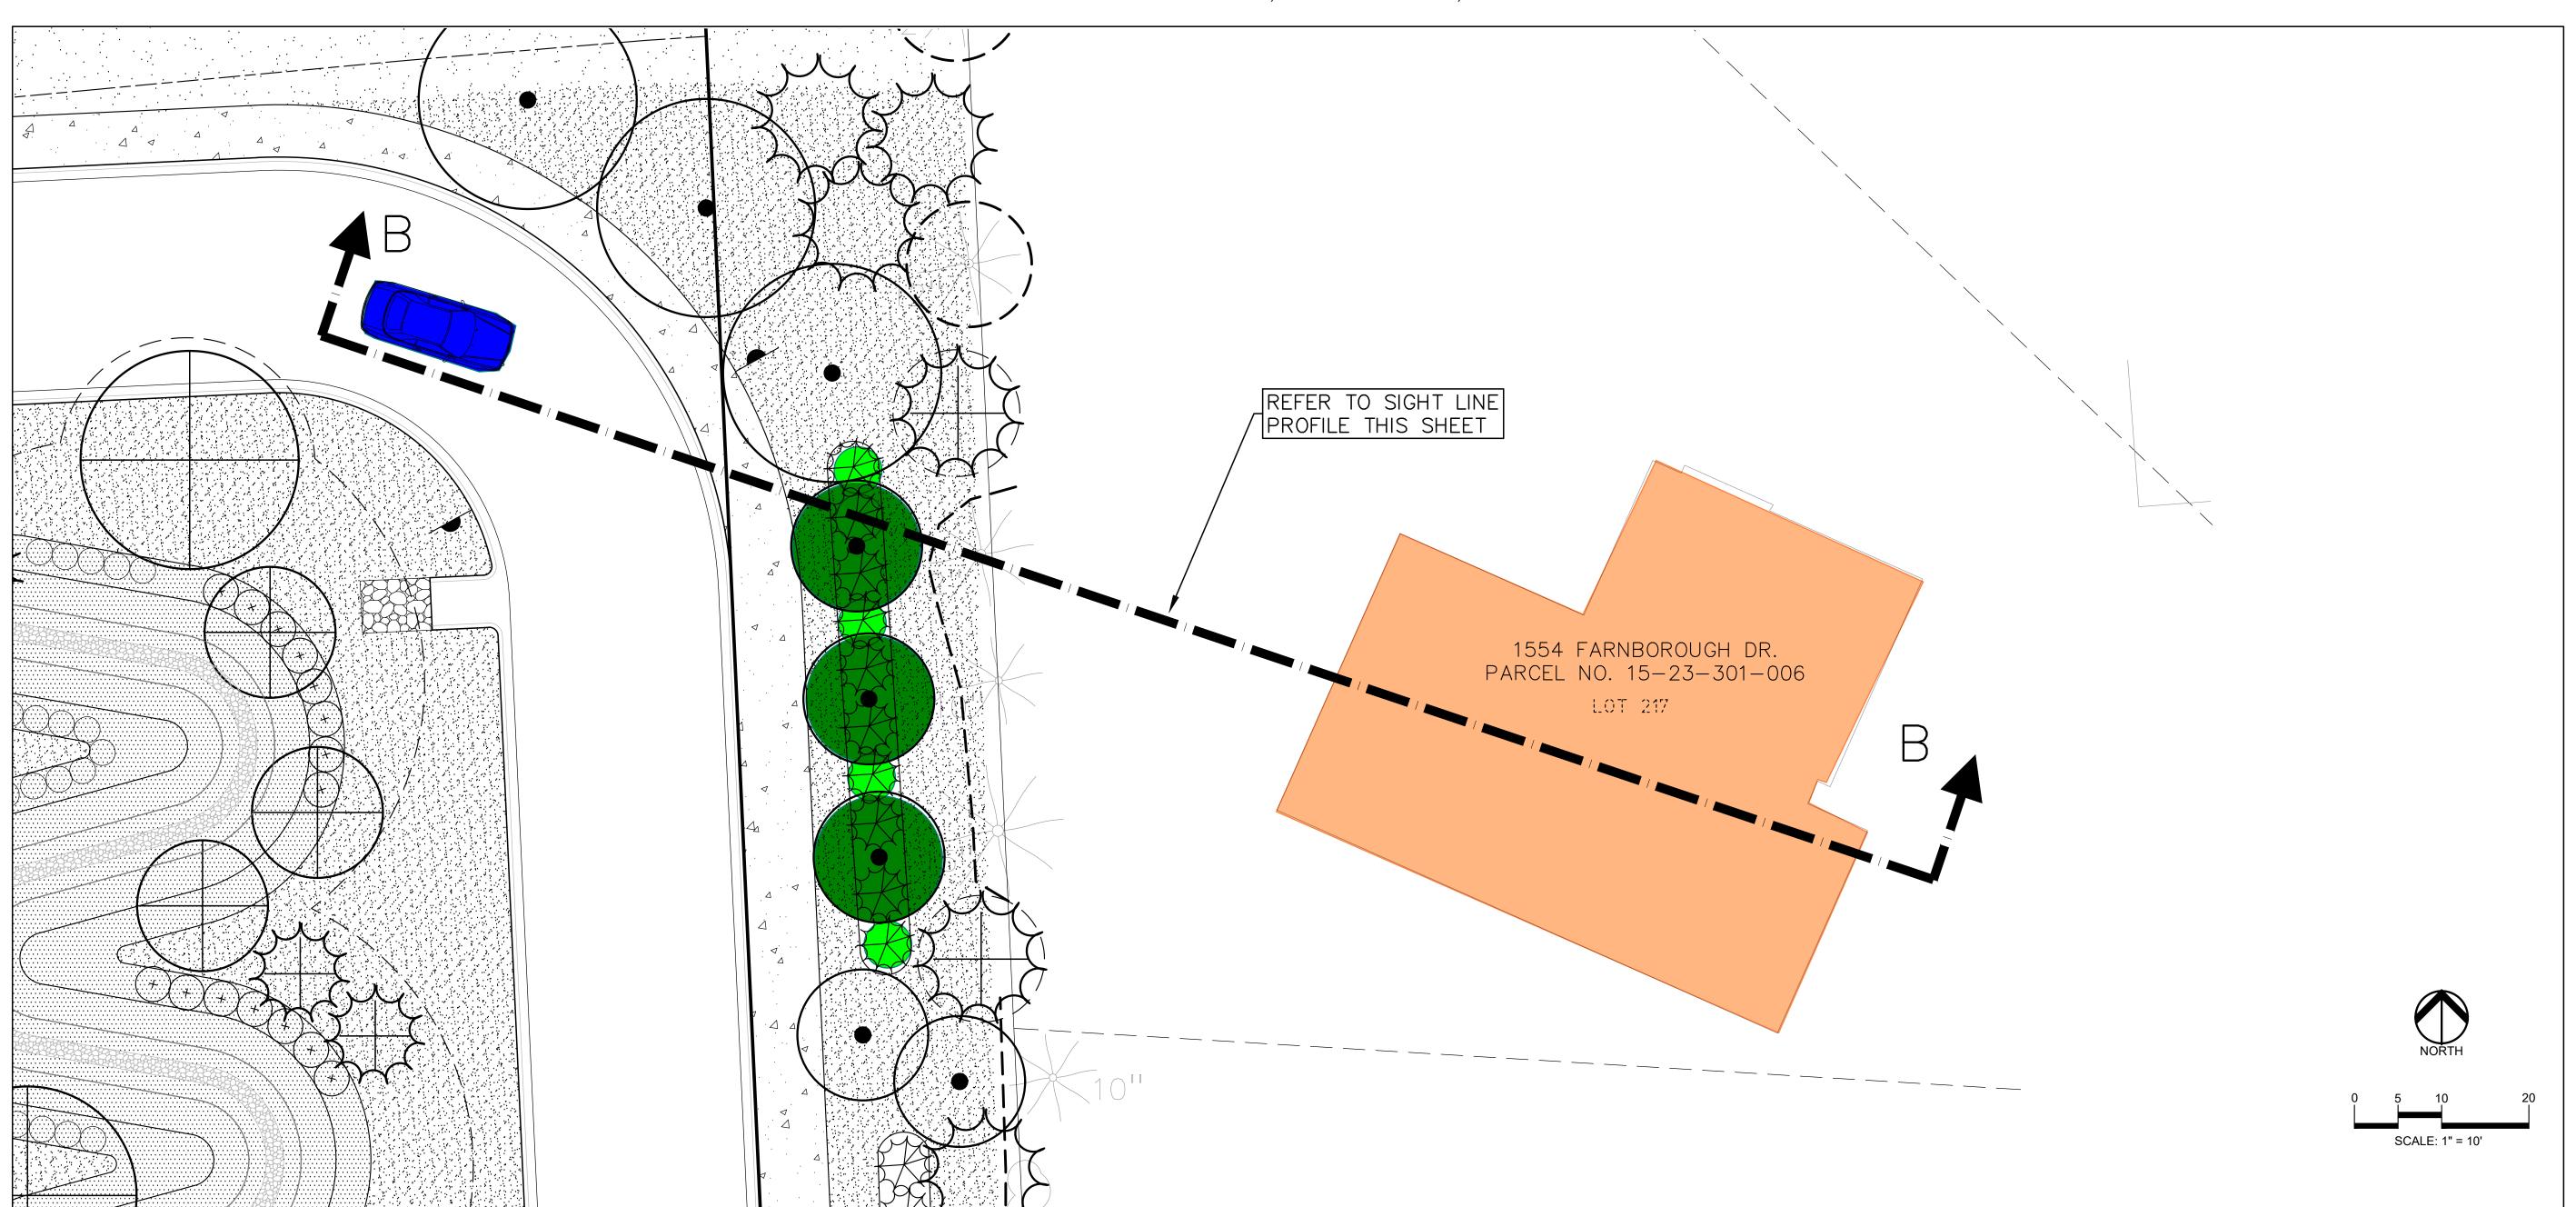

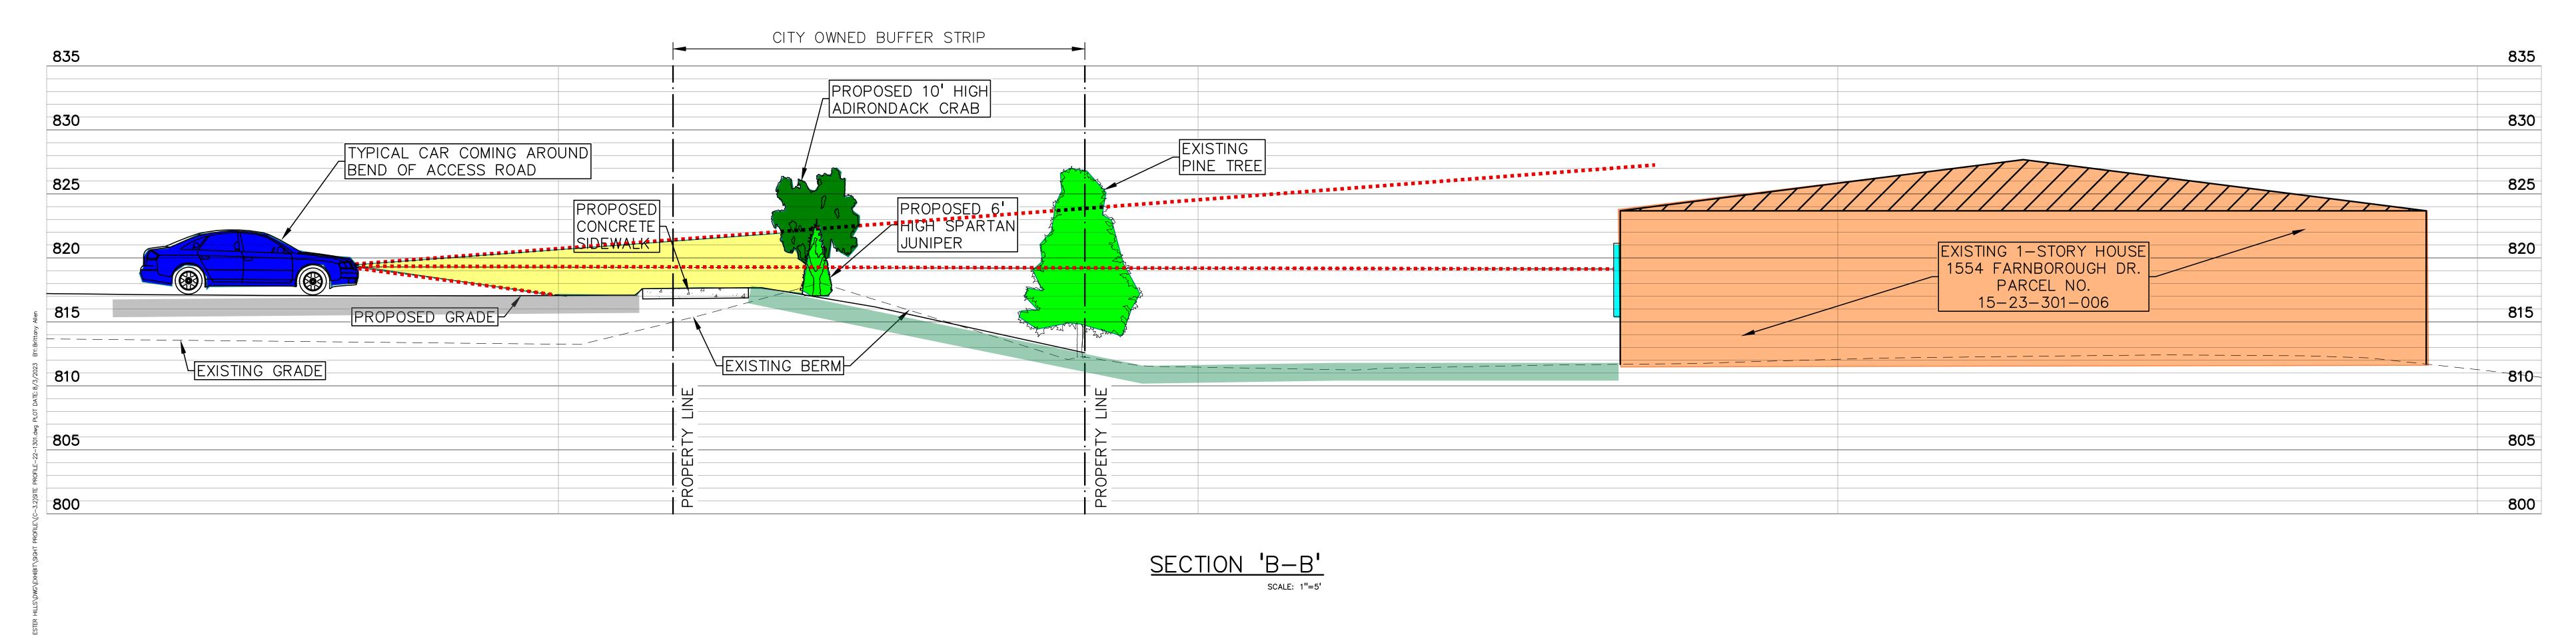



PEA JOB NO. 22-1301
S:\PROJECTS\2022\2022-1301 EIGI4T ROCHESTER RD. ROCHESTER HILLS\DWG\EXHIBIT\SIGHT PROFILE\(C-3.2)SITE PROFILE-22-1301.dwg