OAKS AT HAMPTON APARTMENTS

5

NEW LEASING CENTER AND MAINTENANCE GARAGE

EAST OF DORSET DR, NORTH OF HAMPTON CR **ROCHESTER HILLS MICHIGAN**

ARCHITECT:

STUCKY VITALE ARCHITECTS 27172 WOODWARD AVENUE **ROYAL OAK, MICHIGAN 48067** (248) 546-6700

CIVIL ENGINEER:

NOWAK AND FRAUS 48680 VAN DYKE SUITE 200 SHELBY TOWNSHIP MICHIGAN (586) 739-0939

MECHANICAL / ELECTRICAL ENGINEER: MA ENGINEERING 180 HIGH OAK ST. **BLOOMFIELD HILLS, MI 48304** (248) 258-1610

APPLICABLE CODES: (COMMERCIAL) BUILDING CODE:

2015 MICHIGAN BUILDING CODE (MBC) AS AMENDED

MECHANICAL CODE: 2021 MICHIGAN MECHANICAL CODE AS AMENDED PLUMBING CODE:

2021 MICHIGAN PLUMBING CODE AS AMENDED

ELECTRICAL CODE:

BARRIER FREE REQUIREMENTS: 2010 ADA STANDARDS FOR ACCESSIBLE DESIGN (DOJ) MBC-2012 (CHAPTER 11)

PROJECT DATA:

BUILDING CODE AUTHORITY: **CITY OF ROCHESTER HILLS**

OWNER: OAKS AT HAMPTON 643 DORCHESTER DR. ROCHESTER HILLS MICHIGAN (248) 852-1377

TYPE OF CONSTRUCTION: 5B

USE GROUP: S-2

PROJECT AREA: NEW WORK:

4,350 = SF LEASING CENTER TOTAL PROJECT AREA 4,350 = SF

MAINTENANCE GARAGE TYPE OF CONSTRUCTION: 5B

USE GROUP:

U

PROJECT AREA: NEW WORK: MAINTENANCE GARAGE

TOTAL PROJECT AREA

SITE AREA OF WORK:


1,200 = SF

1,200 = SF



	SHEET INDEX		SUED FOR	
	•••==•			
	DRAWING INDEX KEY:			
	NOT ISSUED			
		9-03-2024 SPA	24 SPA	
		09-03-20	10-11-2024	
GENE	ERAL	·		
G001	TITLE SHEET AND SHEET INDEX AND LOCATOR PLAN	0		
	-			
C1	TOPOGRAPHIC SURVEY	0		
C2	DEMOLITION PLAN	\cap		
C3	SITE PLAN	0		
C4	FIRE TRUCK MANEUVERING PLAN	Ŏ		
C5	ENGINEERED SITE PLAN			
		Ŭ		
1	LAND TITLE SURVEY			
2	LAND TITLE SURVEY	—Ŕ		
3	LAND TITLE SURVEY	-		
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LAND	SCAPE			
L1	LANDSCAPE PLAN	0		
	HITECTURAL			
				<u> </u>
A101 A102	LEASING CENTER FLOOR PLAN MAINTENANCE GARAGE FLOOR PLAN	0		+ $+$
A102 A300	LEASING CENTER EXTERIOR RENDER	0		+ $+$
A300	LEASING CENTER EXTERIOR RENDER	0		+ $+$
A302	LEASING CENTER EXTERIOR ELEVATIONS	0		+ $+$
A302 A303	MAINTENANCE GARAGE EXTERIOR ELEVATIONS	-0		+ $+$
7303		-		+
				+
				+ $+$

3

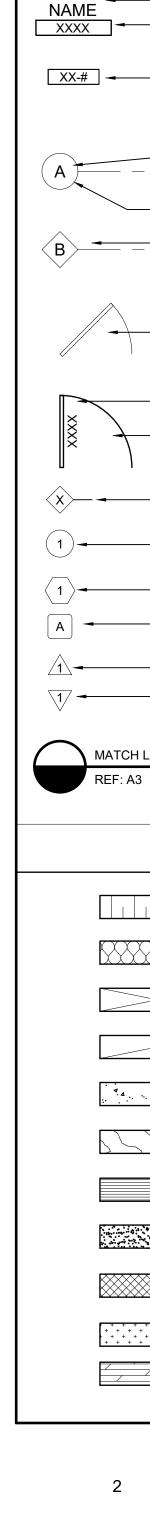


roup.

SYMBOL LEGEND

A	- DARKENED ARROW INDICATES ELEVATED SECTION
	- ELEVATION NUMBER
A-X	- SHEET NUMBER WHERE ELEVATION IS LOCATED
	- ELEVATION NUMBER
A-X	- SHEET NUMBER WHERE ELEVATION IS LOCATED
\sim	
	- DETAIL REFERENCE NUMBER - SHEET NUMBER WHERE DETAIL IS LOCATED
	- DETAIL NUMBER
X DETAIL -	
SCALE: X/X" = 1'-0"-	- DRAWING SCALE - SHEET NUMBER WHERE DETAIL IS REFERENCED
	- REFERENCE POINT OF ELEVATION - HEIGHT ABOVE FINISHED FLOOR
�8'-0" A.F.F ≺	- HEIGHT ABOVE FINISHED FLOOR
	NOTE: DATUM SYMBOL INDICATES A SPECIFIC REFERENCE HEIGHT OF MATERIAL INDICATED
ROOM NAME	- ROOM NAME
	- ROOM NUMBER
XX-# -	- FINISH TAG
	- NUMBERS DESIGNATE VERTICAL COLUMN LINES
	LETTERS DESIGNATE HORIZONTAL COLUMN LINES
	- CIRCLES REPRESENT NEW COLUMN LINES
B	- DIAMOND REPRESENT EXISTING COLUMNS
· ·	
	- EXISTING DOOR SYMBOL
	- NEW DOOR SYMBOL
× ·	- DOOR DESIGNATION
×	- WALL TYPE DESIGNATION NUMBER - COORDINATE WITH SCHEDULE
1-	- EQUIPMENT DESIGNATION NUMBER - COORDINATE WITH PLAN NOTES
$\langle 1 \rangle$	- KEY NOTE DESIGNATION NUMBER -
	COORDINATE WITH PLAN NOTES - WINDOW DESIGNATION LETTER -
	COORDINATE WITH PLAN NOTES
	- ADDENDUM DESIGNATION NUMBER - BULLETIN DESIGNATION NUMBER
V	
MATCH LINE	
REF: A3	- SHEET REFERENCE FOR DRAWING CONTINUATION
IVI <i>7</i>	ATERIAL LEGEND
	ACOUSTICAL CEILING
	BATT/LOOSE INSULATION
	BLOCKING/ROUGH LUMBER - CONTINUOUS
	BLOCKING/ROUGH LUMBER
	CONCRETE
	FINISHED WOOD

	ACOUSTICAL CEILING
	BATT/LOOSE INSULATION
	BLOCKING/ROUGH LUMBER - CONTINUOUS
	BLOCKING/ROUGH LUMBER
	CONCRETE
252	FINISHED WOOD
	GLASS
	GYPSUM WALLBOARD
	MASONRY
+ + + + + + + + + + + + + + + + + + +	PARTICLE BOARD
, / /	PLYWOOD

AT ACOUSTICAL ACOUST. ACOUSTIC CEILING TILE A.C.T. ADJACENT A.F.F. ABOVE FINISH FLOOR ALUM. ALUMINUM ANOD. ANODIZED BOARD BLDG. BUILDING BLOCK BLKG. BLOCKING CEM. CEMENT CONTROL JOINT CEILING CENTER LINE CLEAN OUT COLUMN CONC. CONCRETE CORNER GUARD CONST CONSTRUCTION CONT CONTINUOUS CORR CORRUGATED CARPET CERAMIC TILE DETAIL DIAMETER DIMENSION DOWN DOOR OPENING DOOR DWG. DRAWING EACH ELEV. ELEVATION EACH WAY EXISTING EXIST FXISTING EXPANSION, EXPOSED EXTERIOR FLOOR DRAIN FOUNDATION F.R.P. FIBER REINFORCED PANELS FINISH FLOOR FACE OF F.O.S. FACE OF STUD FRAME FOOTING FIELD VERIFY GAUGE GALV. GALVANIZED GYPSUM HDW. HARDWARE HOLLOW METAL HORIZ HORIZONTAL HEIGHT INSIDE DIAMETER INSUL INSULATION INTERIOR JOINT LAVATORY LONG L.L.O. LONG LEG OUTSTANDING L.L.V. LONG LEG VERTICAL MAX. MAXIMUM MECH. MECHANICAL MET. METAL MEZZ. MEZZANINE MISCELLANEOUS IRON MINIMUM MISCELLANEOUS MASONRY OPENING NOT IN CONTRACT N.T.S. NOT TO SCALE ON CENTER OUTSIDE DIAMETER OPNG. OPENING OPP. OPPOSITE PL.G. PLATE GLASS PL.S. PLATE STEEL P.LAM PLASTIC LAMINATE PLAS. PLASTER PREFAB PREFABRICATED PROJ. PROJECT, PROJECTION P.S.F. POUNDS PER SQUARE FOOT PAINT, POINT RISFR RETURN AIR RUBBER BASE ROOF CONDUCTOR R.C.P. REFLECTED CEILING PLAN ROOF DRAIN RUBBER FLOORING REINF. REINFORCED, REINFORCING REQ'D. REQUIRED RFG. ROOFING ROOM ROOF SUMP RUBBER TILE SANITARY SCHED. SCHEDULE SHEET SIMILAR SPEC. SPECIFICATION SERVICE SINK STEEL STANDARD STOR. STORAGE STRUCT STRUCTURAL SUSP. SUSPENDED SWITCH SYM. SYMMETRICAL TREAD TOP AND BOTTOM TELEPHONE TERR. TERRAZZO T&G TONGUE AND GROOVE THICK, THICKNESS THRES. THRESHOLD T.O.S. TOP OF STEEL TYPICAL UNDERCUT U.N.O. UNLESS NOTED OTHERWISE VINYL BASE V.C.T. VINYL COMPOSITION TILE VERIFY IN FIELD WIDE VERT. VERTICAL WAINS. WAINSCOT W.C. WATER CLOSET WD.WIN. WOOD WINDOW WEIGHT W.W.F. WELDED WIRE FABRIC

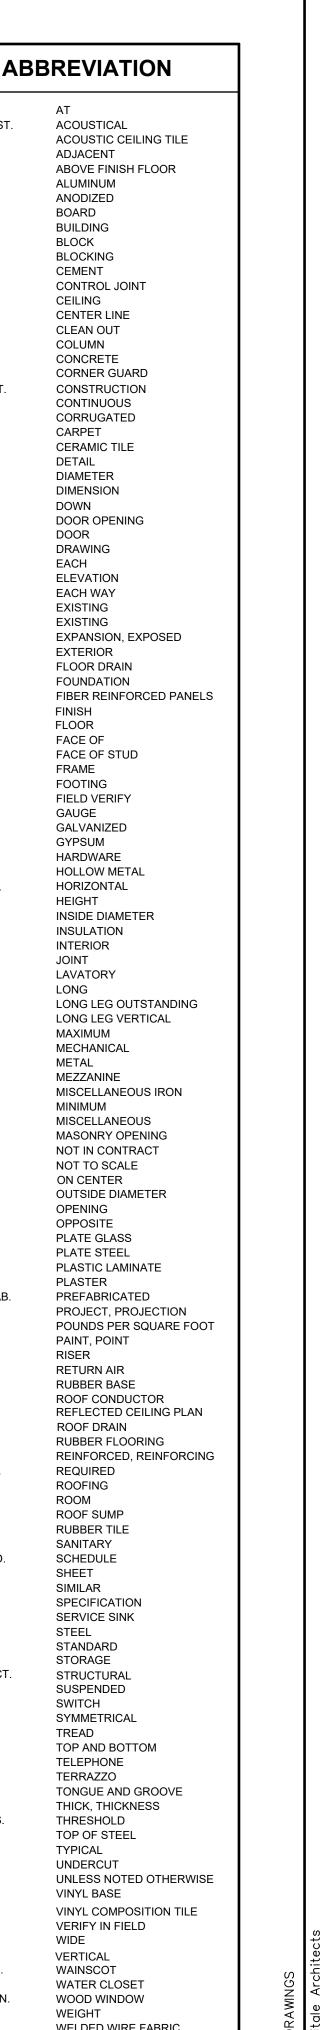

STUCKY VITALE ARCHITECTS 27172 WOODWARD AVENUE ROYAL OAK, MI 48067-0925 P. 248.546.6700 F. 248.546.8454 W W W . STUCKYVITALE.COM STATEMENT OF INTELLECTUAL PROPERTY THE IDEAS, CONCEPTS, DRAWINGS AND THOUGHT CONVEYED HEREIN ARE THE INTELLECTUAL PROPERTY OF STUCKY VITALE ARCHITECTS. THIS SE OF DRAWINGS, IN WHOLE OR IN PART, MAY NOT E REPRODUCED, WITHOUT THE WRITTEN CONSENT OF STUCKY VITALE ARCHITECTS. THIS INFORMATION IS PROTECTED UNDER U.S. COPYRIGHT LAW. ALL RIGHTS RESERVED Consultants: NOT FOR CONSTRUCTION Project : OAKS AT HAMPTON APARTMENTS EAST SIDE OF DORSET DR NORTH OF HAMPTON CR ROCHESTER HILLS MI Issued for : REVIEW: 05/20/2024 SPA REVIEW: 09/03/2024 SPA REVIEW: 10/11/2024 JOHN A. VITALE ARCHITECT No. 1301029086 Drawn by ARA Checked by JAV, MJB Sheet Title TITLE SHEET, SHEET INDEX, + LOCATOR PLAN Project No. : 2024.066 Sheet No.

City File #24-0157 Section #26 in the lower right hand corner of each sheet

The applicant will need to submit a Land Improvement Permit (LIP) application with engineer's estimate, fee and construction plans to proceed with the construction plan review process.

@

ADJ.

BD.

BLK.

C.J.

CLG.

C.O.

COL.

C.G.

CPT.

C.T.

DET.

DIA

DM.

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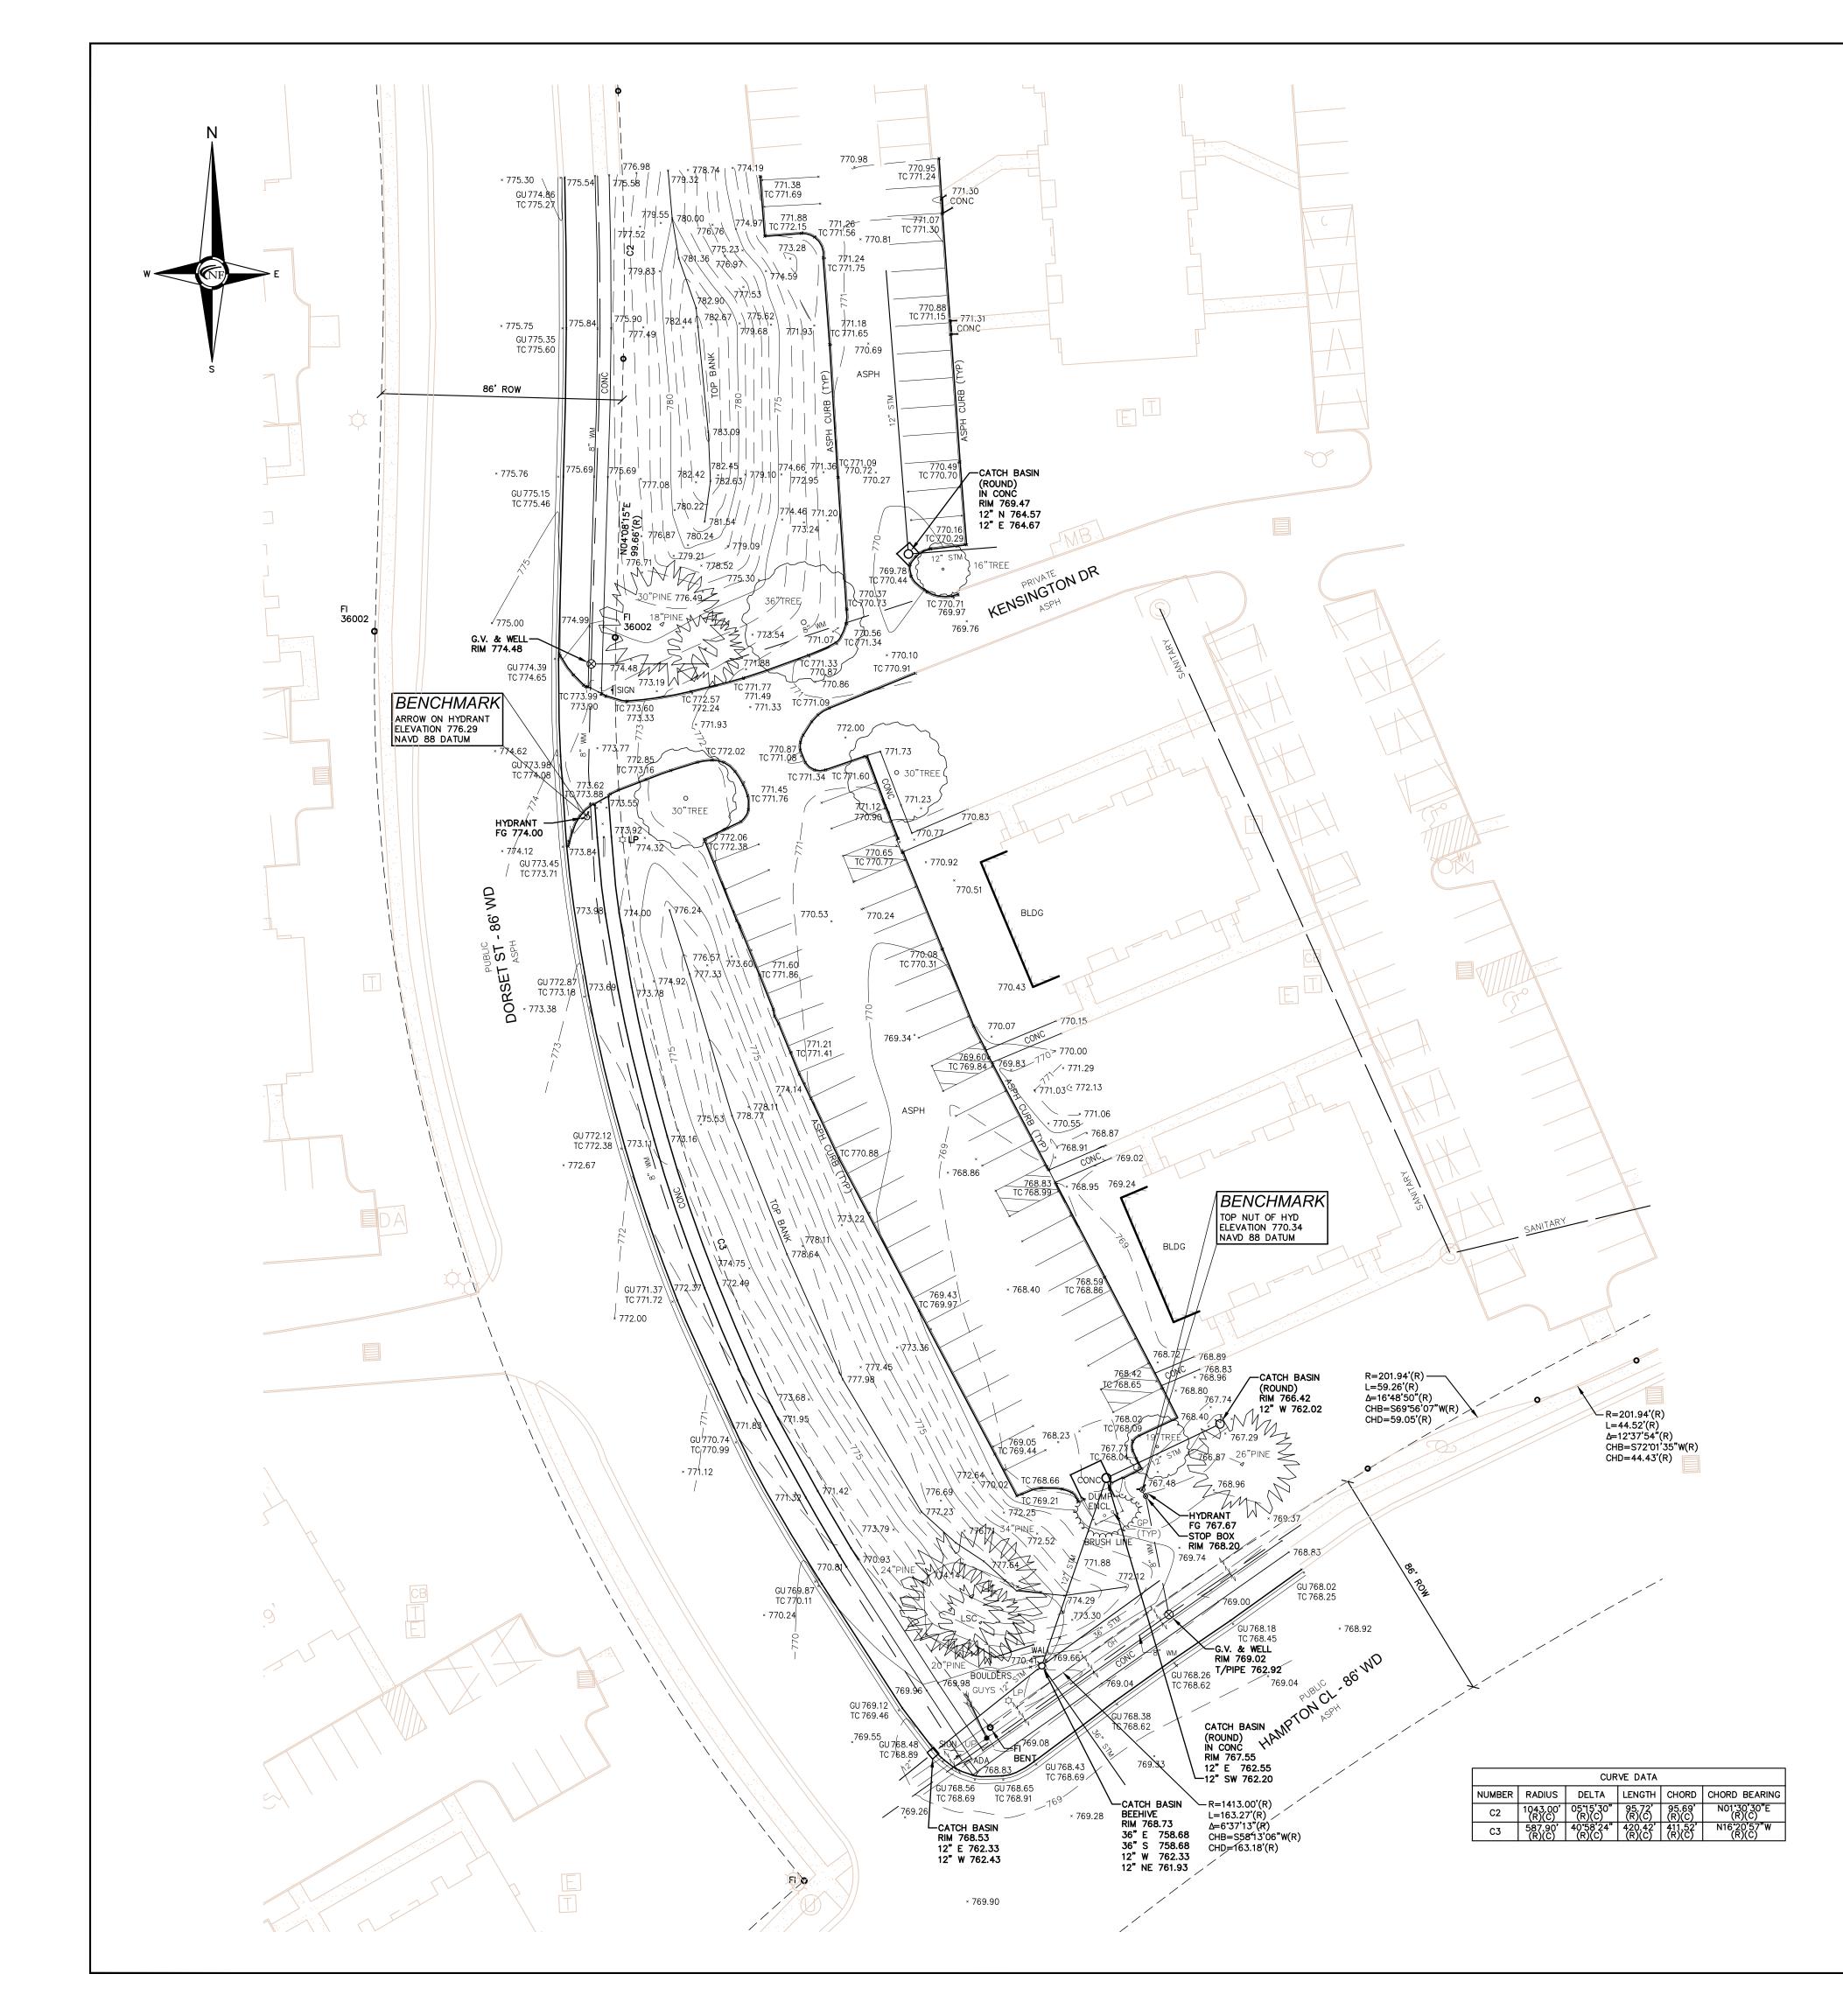
V.B.

V.I.F.

WT.

R.T.

FDN.











PROJECT

Oaks at Hampton Apartments Leasing Center

CLIENT

The Monahan Company 21321 Kelly Road Eastpointe, MI 48021

Contact:

Nathan Knapp, Senior Construction Estimator Phone: (586) 774-3800 Email: nathan@themonahanco.com

PROJECT LOCATION

Part of the Northwest ¹/₄ of Section 26, Town 3 North, Range 11 East, City of Rochester Hills, Oakland County, Michigan

sнеет Topographic Survey



Know what's below Call before you dig.

DATE	ISSUED/REVISED
09/03/2024	ISSUED FOR SPA
10/11/2024	REVISED PER CITY REVIEW
DDAWNID	V
DRAWN B	
J. Nelso	n
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J. Nelso	n Manager: ley
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J. Nelso PROJECT I C. Findl APPROVEI K. Nava DATE: 1-11-24 SCALE: 1	MANAGER: ley D BY: uroli $uroli$ $15 30$

LEGAL DESCRIPTION

PARCEL II: PART OF THE NORTHWEST 1/4 OF SECTION 26, TOWN 3 NORTH, RANGE II EAST, CITY OF ROCHESTER HILLS, OAKLAND COUNTY, MICHIGAN, BEING MORE PARTICULARLY DESCRIBED AS FOLLOWS: BEGINNING AT A POINT WHICH IS NORTH 88 52' 45" EAST, 1218.13 FEET ALONG THE NORTH LINE OF SECTION 26 AND SOUTH 01 DEG. 07' 15" EAST, 60.00 FEET FROM THE NORTHWEST COMER OF SECTION 26, TOWN 3 NORTH, RANGE II EAST; THENCE NORTH 88 DEG. 52' 45" EAST, 885.91 FEET ALONG A LINE PARALLEL TO AND 60.00 FEET SOUTH OF THE NORTH LINE OF SECTION 26; THENCE SOUTH 01 DEG. 07' 15" EAST, 483.05 FEET, THENCE WESTERLY 567.90 FEET ALONG A CURVE CONCAVE TO THE SOUTH, RADIUS OF 1400.00 FEET CENTRAL ANGLE OF 23 DEG. 14' 30" LONG CHORD BEARS SOUTH 77 DEG. 19' 53" WEST 564.02 FEET; THENCE WESTERLY 44.52 FEET ALONG A CURVE CONCAVE TO THE NORTH RADIUS OF 201.94 FEET, CENTRAL ANGLE OF 12 DEG. 37' 54" LONG CHORD BEARS SOUTH 72 DEG. 01'35" WEST 44.43 FEET; THENCE WESTERLY 59.26 FEET ALONG A CURVE CONCAVE TO THE SOUTH RADIUS OF201.94 FEET, CENTRAL ANGLE OF 16 DEG. 48' 50", LONG CHORD BEARS SOUTH 69 DEG. 56' 07" WEST, 59.05 FEET, THENCE WESTERLY 163.27 FEET ALONG A CURVE CONCAVE TO THE SOUTH, RADIUS OF 1413.00 FEET, CENTRAL ANGLE OF 06 DEG. 37' 13", LONG CHORD BEARS SOUTH 58 DEG. 13' 06" WEST, 163.18 FEET, THENCE NORTHERLY 420.42 FEET ALONG A CURVE CONCAVE TO THE EAST, RADIUS OF 587.90 FEET, CENTRAL ANGLE OF 40 DEG. 58' 24", LONG CHORD BEARS NORTH 16 DEG. 20' 57" WEST, 411.52 FEET; THENCE NORTH 04 DEG. 08' 15" EAST, 99.66 FEET; THENCE NORTHERLY 95.72 FEET ALONG A CURVE CONCAVE TO THE WEST, RADIUS OF 1043.00 FEET, CENTRAL ANGLE OF 05 DEG. 15' 30", LONG CHORD BEARS NORTH 01 DEG. 30' 30" EAST, 95.69 FEET; THENCE NORTH 01 DEG. 07' 15" WEST, 119.32 FEET TO THE POINT OF BEGINNING.

PARCEL ID NO. - 15-26-127-002

TOPOGRAPHIC SURVEY NOTES ALL ELEVATIONS ARE EXISTING ELEVATIONS, UNLESS OTHERWISE NOTED.

UTILITY LOCATIONS WERE OBTAINED FROM MUNICIPAL OFFICIALS AND RECORDS OF UTILITY COMPANIES, AND NO GUARANTEE CAN BE MADE TO THE COMPLETENESS, OR EXACTNESS OF LOCATION.


THIS SURVEY MAY NOT SHOW ALL EASEMENTS OF RECORD UNLESS AN UPDATED TITLE POLICY IS FURNISHED TO THE SURVEYOR BY THE OWNER.

MISS DIG / UTILITY DISCLAIMER NOTE A MISS DIG TICKET NUMBER 2023122901370, PURSUANT TO MICHIGAN PUBLIC ACT 174 WAS ENTERED FOR THE SURVEYED PROPERTY. DUE TO THE EXTENDED REPORTING PERIOD FOR UNDERGROUND FACILITY OWNERS TO PROVIDE THEIR RECORDS, THE SURVEY MAY NOT REFLECT ALL THE UTILITIES AT THE TIME THE SURVEY WAS ISSUED ON 1–11–24. THE SURVEY ONLY REFLECTS THOSE UTILITIES WHICH COULD BE OBSERVED BY THE SURVEYOR IN THE FIELD OR AS DEPICTED BY THE UTILITY COMPANY RECORDS FURNISH PRIOR TO THE DATE THIS SURVEY WAS ISSUED. THE CLIENT AND/OR THEIR AUTHORIZED AGENT SHALL VERIFY WITH THE FACILITY OWNERS AND/OR THEIR AUTHORIZED AGENTS, THE COMPLETENESS AND EXACTNESS OF THE UTILITIES LOCATION.

LEGEND MANHOLE - EXISTING SANITARY SEWER –(S)– EXISTING SAN. CLEAN OUT HYDRANT GATE VALVE — EXISTING WATER MAIN MANHOLE CATCH BASIN ______ —¤— EX. R.Y. CATCH BASIN EXISTING BURIED CABLES UTILITY POLE GUY POLE OVERHEAD LINES LIGHT POLE SIGN EXISTING GAS MAIN

J024-0157 PSP2024-0032 Revision #1

Received 10/17/2024 City of Rochester Hill Planning & Economic

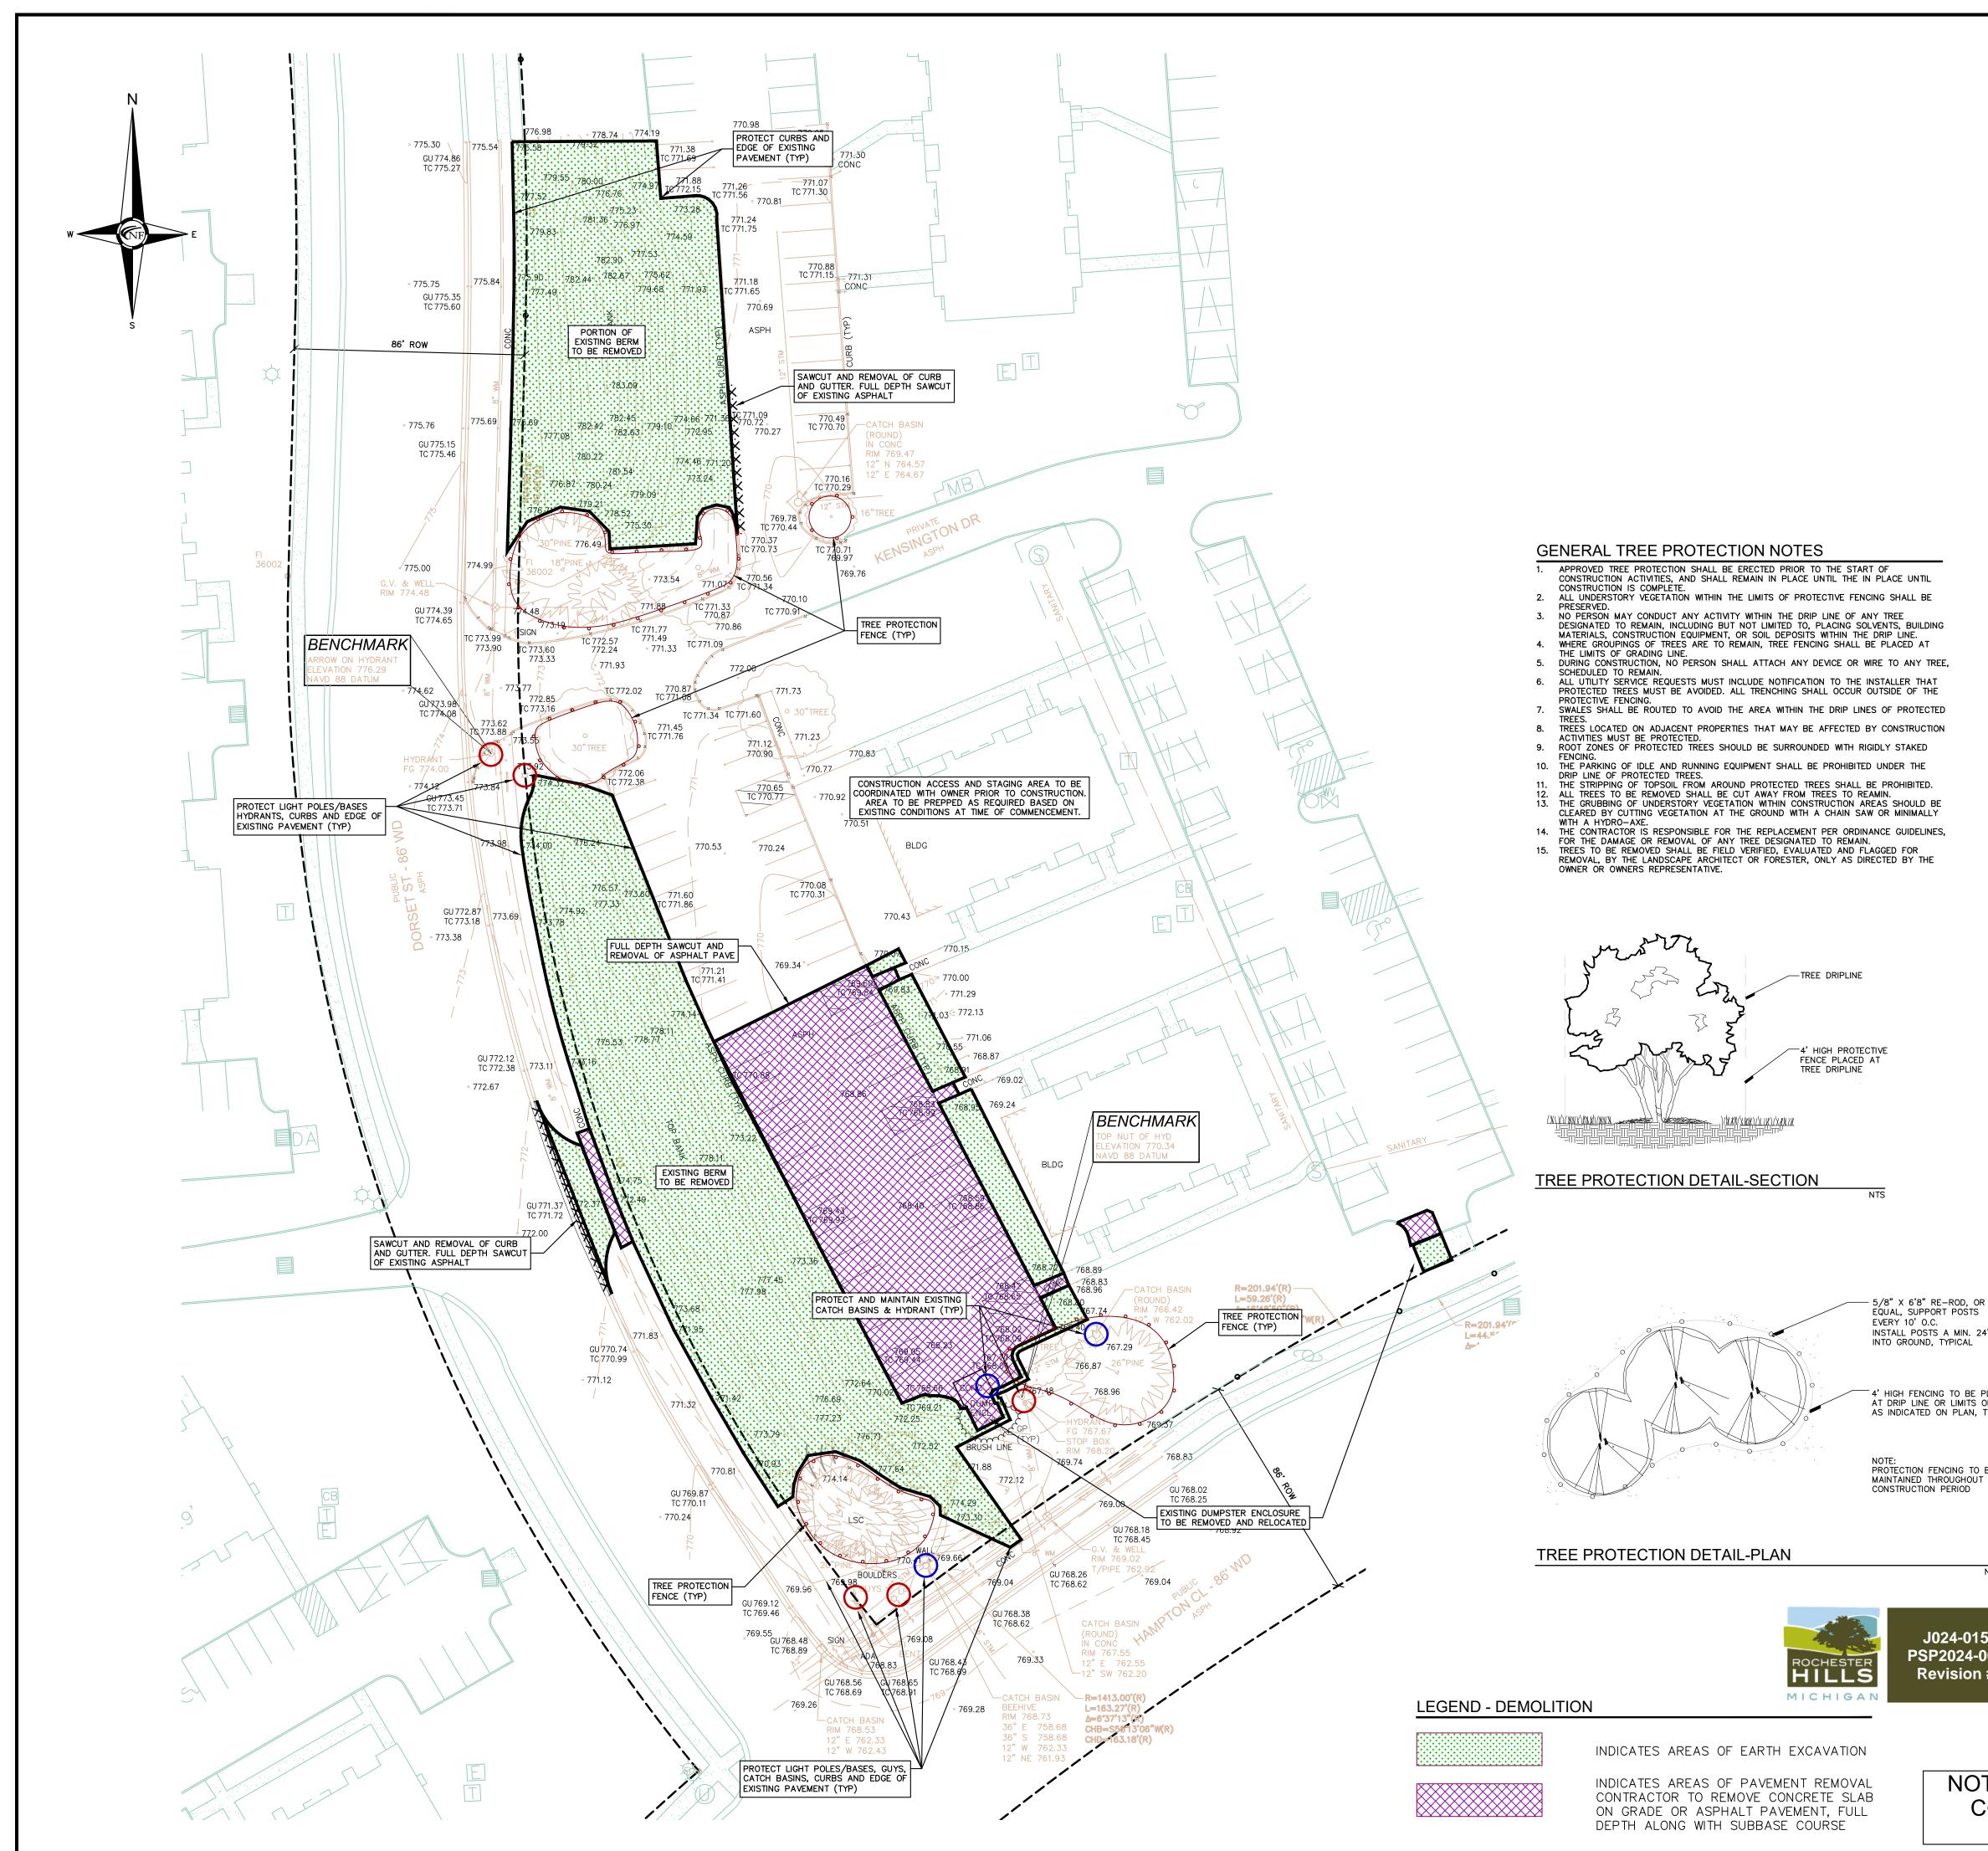



DEMOLITION NOTES

DEMOLITION OF SITE IMPROVEMENTS SHALL BE ALLOWED ONLY AFTER AN APPROVED PERMIT HAS BEEN SECURED FROM THE PUBLIC AGENCY HAVING JURISDICTION OVER SAID DEMOLITION. FOR ANY DEMOLITION WITHIN PUBLIC RIGHT-OF-WAY, THE CONTRACTOR SHALL PAY FOR, AND SECURE, ALL NECESSARY PERMITS AND LIKEWISE SHALL ARRANGE FOR ALL SITE INSPECTIONS.

SITE DEMOLITION INCLUDES THE COMPLETE REMOVAL OF SITE IMPROVEMENTS AND OFF-SITE DISPOSAL. DEBRIS SHALL BE TRANSPORTED TO AN APPROPRIATE DISPOSAL FACILITY THAT IS LICENSED FOR THAT TYPE OF DEBRIS.

THE CONTRACTOR SHALL COORDINATE TRUCK ROUTES WITH THE MUNICIPALITY PRIOR TO COMMENCEMENT OF SITE DEMOLITION. ALL TRUCKS SHALL BE TARPED OR PROPERLY SECURED TO CONTAIN DEMOLITION DEBRIS PRIOR TO LEAVING SITE.

EXISTING ON-SITE UNDERGROUND UTILITIES AND BUILDING SERVICES HAVE BEEN INDICATED BASED UPON THE BEST AVAILABLE UTILITY RECORDS AND/OR ON-SITE INSPECTION. NO GUARANTEE IS MADE BY THE DESIGN ENGINEER, AS TO THE COMPLETENESS OR ACCURACY OF UTILITY DATA. THE CONTRACTOR SHALL BE RESPONSIBLE FOR FIELD VERIFICATION OF UTILITY INFORMATION (THE DESIGN ENGINEER MAKES NO GUARANTEE NOR ASSUMES ANY LIABILITY AS TO THE COMPLETENESS AND/OR ACCURACY OF UTILITY DATA).

PRIOR TO THE REMOVAL OR ABANDONMENT OF ANY EXISTING UNDERGROUND UTILITY OR BUILDING SERVICE LINES CALLED FOR IN THE PLANS OR DISCOVERED DURING EXCAVATION, THE CONTRACTOR MUST DETERMINE IF THE UTILITY LINE OR BUILDING SERVICE IS STILL IN USE. IF THE UTILITY LINE OR BUILDING SERVICE IS STILL IN USE/ACTIVE THE CONTRACTOR MUST TAKE ALL THE NECESSARY STEPS TO GUARANTEE THAT THE UTILITY LINE OR BUILDING SERVICE IS RECONNECTED WITHOUT AN INTERRUPTION IN SERVICE. THE RECONNECTION OF THE UTILITY LINE OR BUILDING SERVICE MUST BE IN ACCORDANCE WITH THE STANDARDS AND REQUIREMENTS OF THE APPROPRIATE GOVERNMENTAL AGENCY OR PRIVATE UTILITY COMPANY.

SOIL EROSION AND SEDIMENTATION CONTROL MEASURES SHALL BE INSTALLED BY THE CONTRACTOR PRIOR TO SITE DEMOLITION.

* THE CONTRACTOR SHALL NOTIFY MISS DIG (1-800-482-7171) A MINIMUM OF THREE (3) WORKING DAYS PRIOR TO THE START OF THE SITE DEMOLITION.

THE CONTRACTOR SHALL COORDINATE THE REMOVAL AND/OR RELOCATION OF EXISTING UTILITY POLES AND BUILDING SERVICES WITH THE DETROIT EDISON COMPANY. REMOVAL OF DETROIT EDISON ELECTRICAL SERVICES SHALL BE IN ACCORDANCE WITH THE CURRENT STANDARDS AND REQUIREMENTS OF DETROIT EDISON.

THE CONTRACTOR SHALL COORDINATE THE REMOVAL AND/OR RELOCATION OF EXISTING UTILITY POLES AND BUILDING SERVICES WITH CONSUMERS ENERGY/MICHCON. REMOVAL OF CONSUMERS ENERGY/ MICHCON GAS SERVICES SHALL BE IN ACCORDANCE WITH THE STANDARDS AND REQUIREMENTS OF CONSUMERS ENERGY/MICHCON.

THE CONTRACTOR SHALL COORDINATE THE REMOVAL AND/OR RELOCATION OF EXISTING UTILITY POLES AND BUILDING SERVICES WITH AMERITECH. REMOVAL OF AMERITECH COMMUNICATION SERVICES SHALL BE IN ACCORDANCE WITH THE CURRENT STANDARDS AND REQUIREMENTS OF AMERITECH.

THE CONTRACTOR SHALL COORDINATE THE REMOVAL AND/OR RELOCATION OF EXISTING UTILITY POLES AND BUILDING SERVICES WITH THE APPROPRIATE CABLE MEDIA COMPANY. REMOVAL OF CABLE SERVICES SHALL BE IN ACCORDANCE WITH THE CURRENT STANDARDS AND REQUIREMENTS OF THE CABLE COMPANY. THE CONTRACTOR SHALL BE RESPONSIBLE FOR NOTIFICATION OF PRIVATE UTILITY COMPANIES

AND COORDINATE UTILITY SERVICE SHUT OFF/DISCONNECT, PRIOR TO DEMOLITION OF EXISTING STRUCTURES OR PROPERTIES. ALL UTILITY METERS SHALL BE REMOVED BY THE APPROPRIATE UTILITY COMPANY.

ANY ON-SITE STORM SEWER FACILITIES LOCATED DURING DEMOLITION SHALL BE REMOVED AND BULK HEADED AT THE PROPERTY LINE IF INDICATED FOR REMOVAL ON THE PLANS. PRIOR TO BUILDING DEMOLITION, ALL HAZARDOUS MATERIAL SHALL BE REMOVED BY OTHERS. THE DEMOLITION CONTRACTOR SHALL IMMEDIATELY NOTIFY THE OWNER SHOULD ANY SUSPICIOUS MATERIAL BE FOUND.

WATER SERVICES AND/OR STOP-BOX SHALL BE PRESERVED AND BULK HEADED AT THE PROPERTY LINE OR AS DIRECTED BY THE OWNER'S REPRESENTATION. WHERE EXISTING BUILDINGS PLANED FOR DEMOLITION FALL WITHIN PROPOSED BUILDING FOOT PRINTS, BASEMENT FLOOR SLABS, FOUNDATION WALLS AND FOOTINGS SHALL BE COMPLETELY

REMOVED AND BACK FILLED WITH MDOT CLASS II GRANULAR MATERIAL AND BE MACHINE COMPACTED TO A MINIMUM OF 98% OF MATERIALS MAXIMUM DENSITY.

INSTALL POSTS A MIN. 24" INTO GROUND, TYPICAL

⁻ 4' HIGH FENCING TO BE PLACED AT DRIP LINE OR LIMITS OF GRADING, AS INDICATED ON PLAN, TYPICAL

PROTECTION FENCING TO BE MAINTAINED THROUGHOUT THE CONSTRUCTION PERIOD

NTS

J024-0157 PSP2024-0032 Revision #1

Received City of Rochester Hill Planning & Economic Development

NOT TO BE USED AS CONSTRUCTION DRAWINGS

TOPOGRAPHIC SURVEY NOTES ALL ELEVATIONS ARE EXISTING ELEVATIONS, UNLESS OTHERWISE


UTILITY LOCATIONS WERE OBTAINED FROM MUNICIPAL OFFICIALS AND RECORDS OF UTILITY COMPANIES, AND NO GUARANTEE CAN BE MADE TO THE COMPLETENESS, OR EXACTNESS OF LOCATION. THIS SURVEY MAY NOT SHOW ALL EASEMENTS OF RECORD UNLESS AN UPDATED TITLE POLICY IS FURNISHED TO THE SURVEYOR BY THE OWNER

LEGEND	
	EXISTING SANITARY SEWER
HYDRANT	EXISTING SAN. CLEAN OUT
	EXISTING WATER MAIN
MANHOLE CATCH BASIN	EXISTING STORM SEWER
X	EX. R. Y. CATCH BASIN
UTILITY POLE GUY POLE	EXISTING BURIED CABLES
	OVERHEAD LINES
\$	LIGHT POLE
q	SIGN
· · · · · · · · · · · · · · · · · · ·	EXISTING GAS MAIN
· X·X·X·X·X·X·X·X·X·X·X·X ·X·X·X·	EXISTING CURB & GUTTER TO BE REMOVED
• //• //• //• //• //•	EXISTING UTILITY TO BE ABANDONED
12" MAPLE	INDICATES EXISTING TREE TO BE REMOVED



Land Planners NOWAK & FRAUS ENGINEERS 46777 Woodward Ave.

Pontiac, MI 48342-5032 Tel. (248) 332-7931 Fax. (248) 332-8257 WWW.NOWAKFRAUS.COM

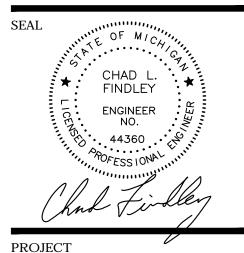

Oaks at Hampton Apartments Leasing Center

CLIENT

The Monahan Company 21321 Kelly Road Eastpointe, MI 48021

Contact: Nathan Knapp, Senior Construction Estimator Phone: (586) 774-3800 Email: nathan@themonahanco.com

PROJECT LOCATION


Part of the Northwest $\frac{1}{4}$ of Section 26, Town 3 North, Range 11 East, City of Rochester Hills, Oakland County, Michigan


SHEET Site Plan Demolition Plan




Call before you dig.

DATE	ISSUED/REVISED	
09/03/2024	ISSUED FOR SPA	
10/11/2024	REVISED PER CITY REVIEW	
DRAWN B	Y:	
J. Klink	enberger	
J. Klinko PROJECT N	e nberger MANAGER:	
J. Klinko PROJECT N J. Klinko	enberger MANAGER: enberger	
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J. Klinko PROJECT N J. Klinko APPROVEI	enberger MANAGER: enberger D BY:	
J. Klinko PROJECT N J. Klinko APPROVEI C. Findl	enberger MANAGER: enberger D BY: ey	
J. Klinko PROJECT M J. Klinko APPROVEL C. Findl DATE: 08/07/20	enberger MANAGER: enberger D BY: ey 24	
J. Klinko PROJECT N J. Klinko APPROVEE <u>C. Findl</u> DATE: 08/07/20 SCALE: 1	enberger MANAGER: enberger O BY: ey 024 " = 30'	
J. Klinko PROJECT M J. Klinko APPROVEL C. Findl DATE: 08/07/20	enberger MANAGER: enberger D BY: ey 24	
J. Klinko PROJECT M J. Klinko APPROVEE C. Findl DATE: 08/07/20 SCALE: 1 50 15	enberger MANAGER: enberger D BY: ey 224 " = 30' $_0$ 15 30	
J. Klinko PROJECT N J. Klinko APPROVEE <u>C. Findl</u> DATE: 08/07/20 SCALE: 1	enberger MANAGER: enberger D BY: ey 224 " = 30' $_0$ 15 30	

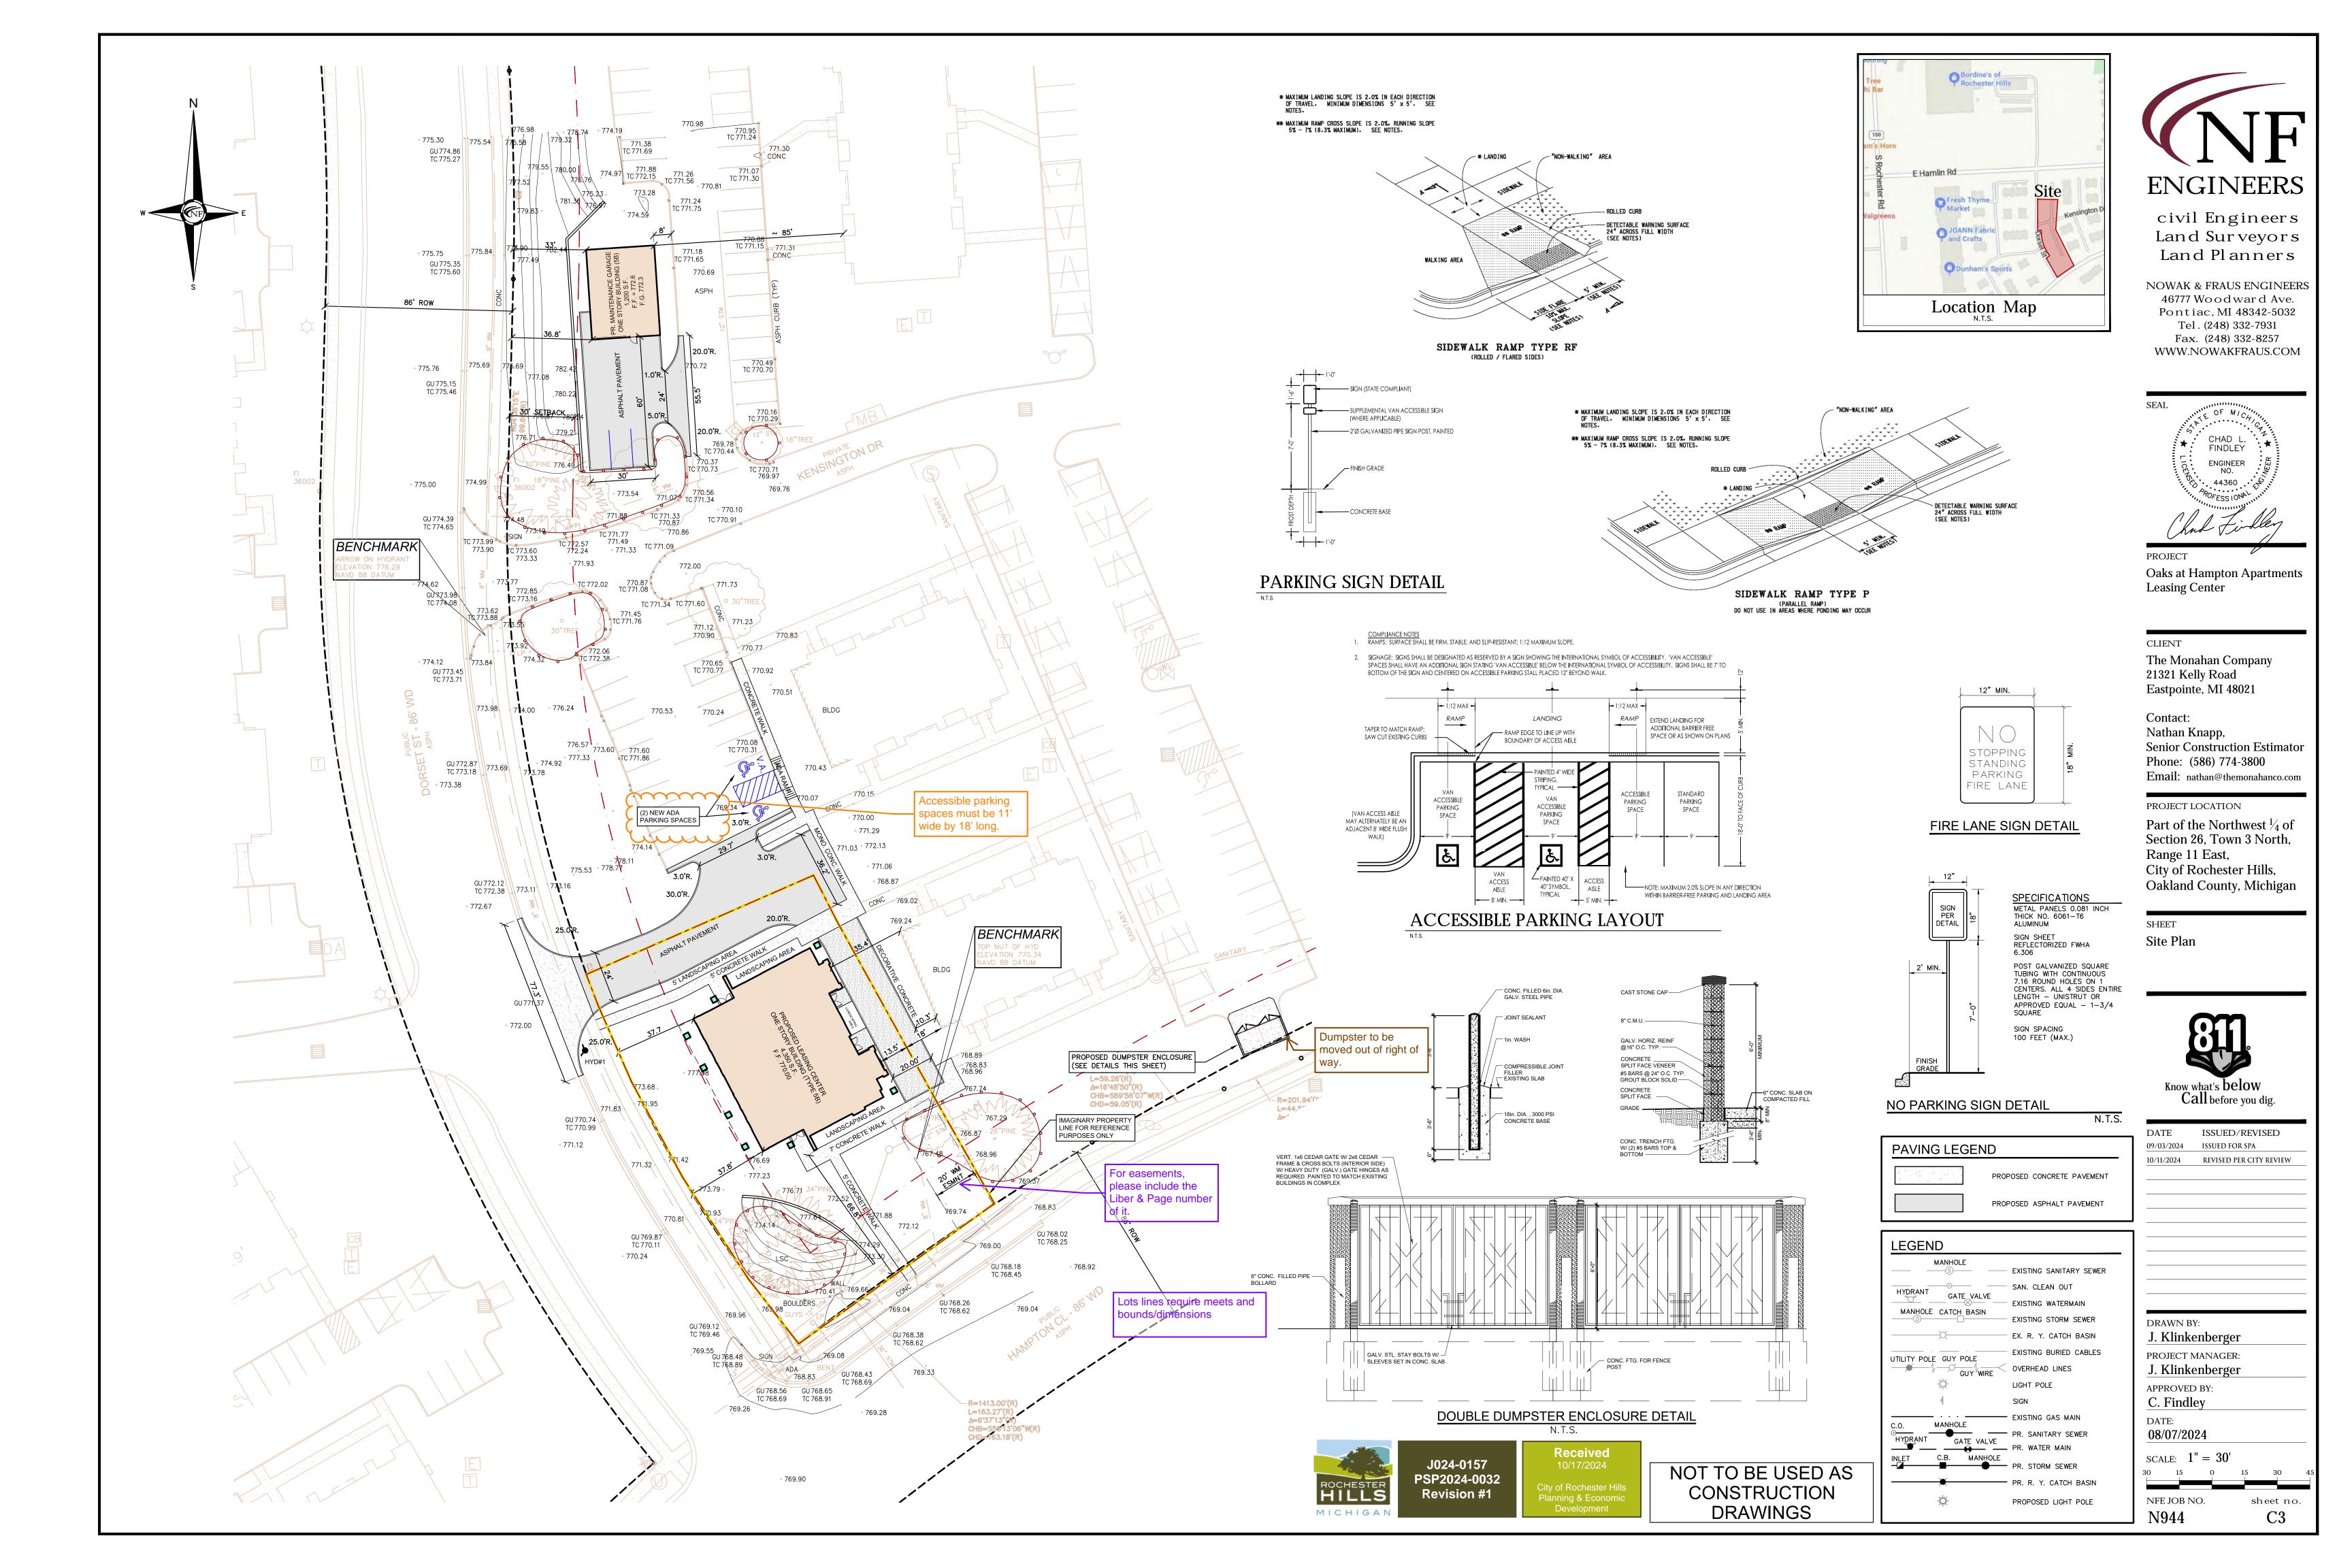


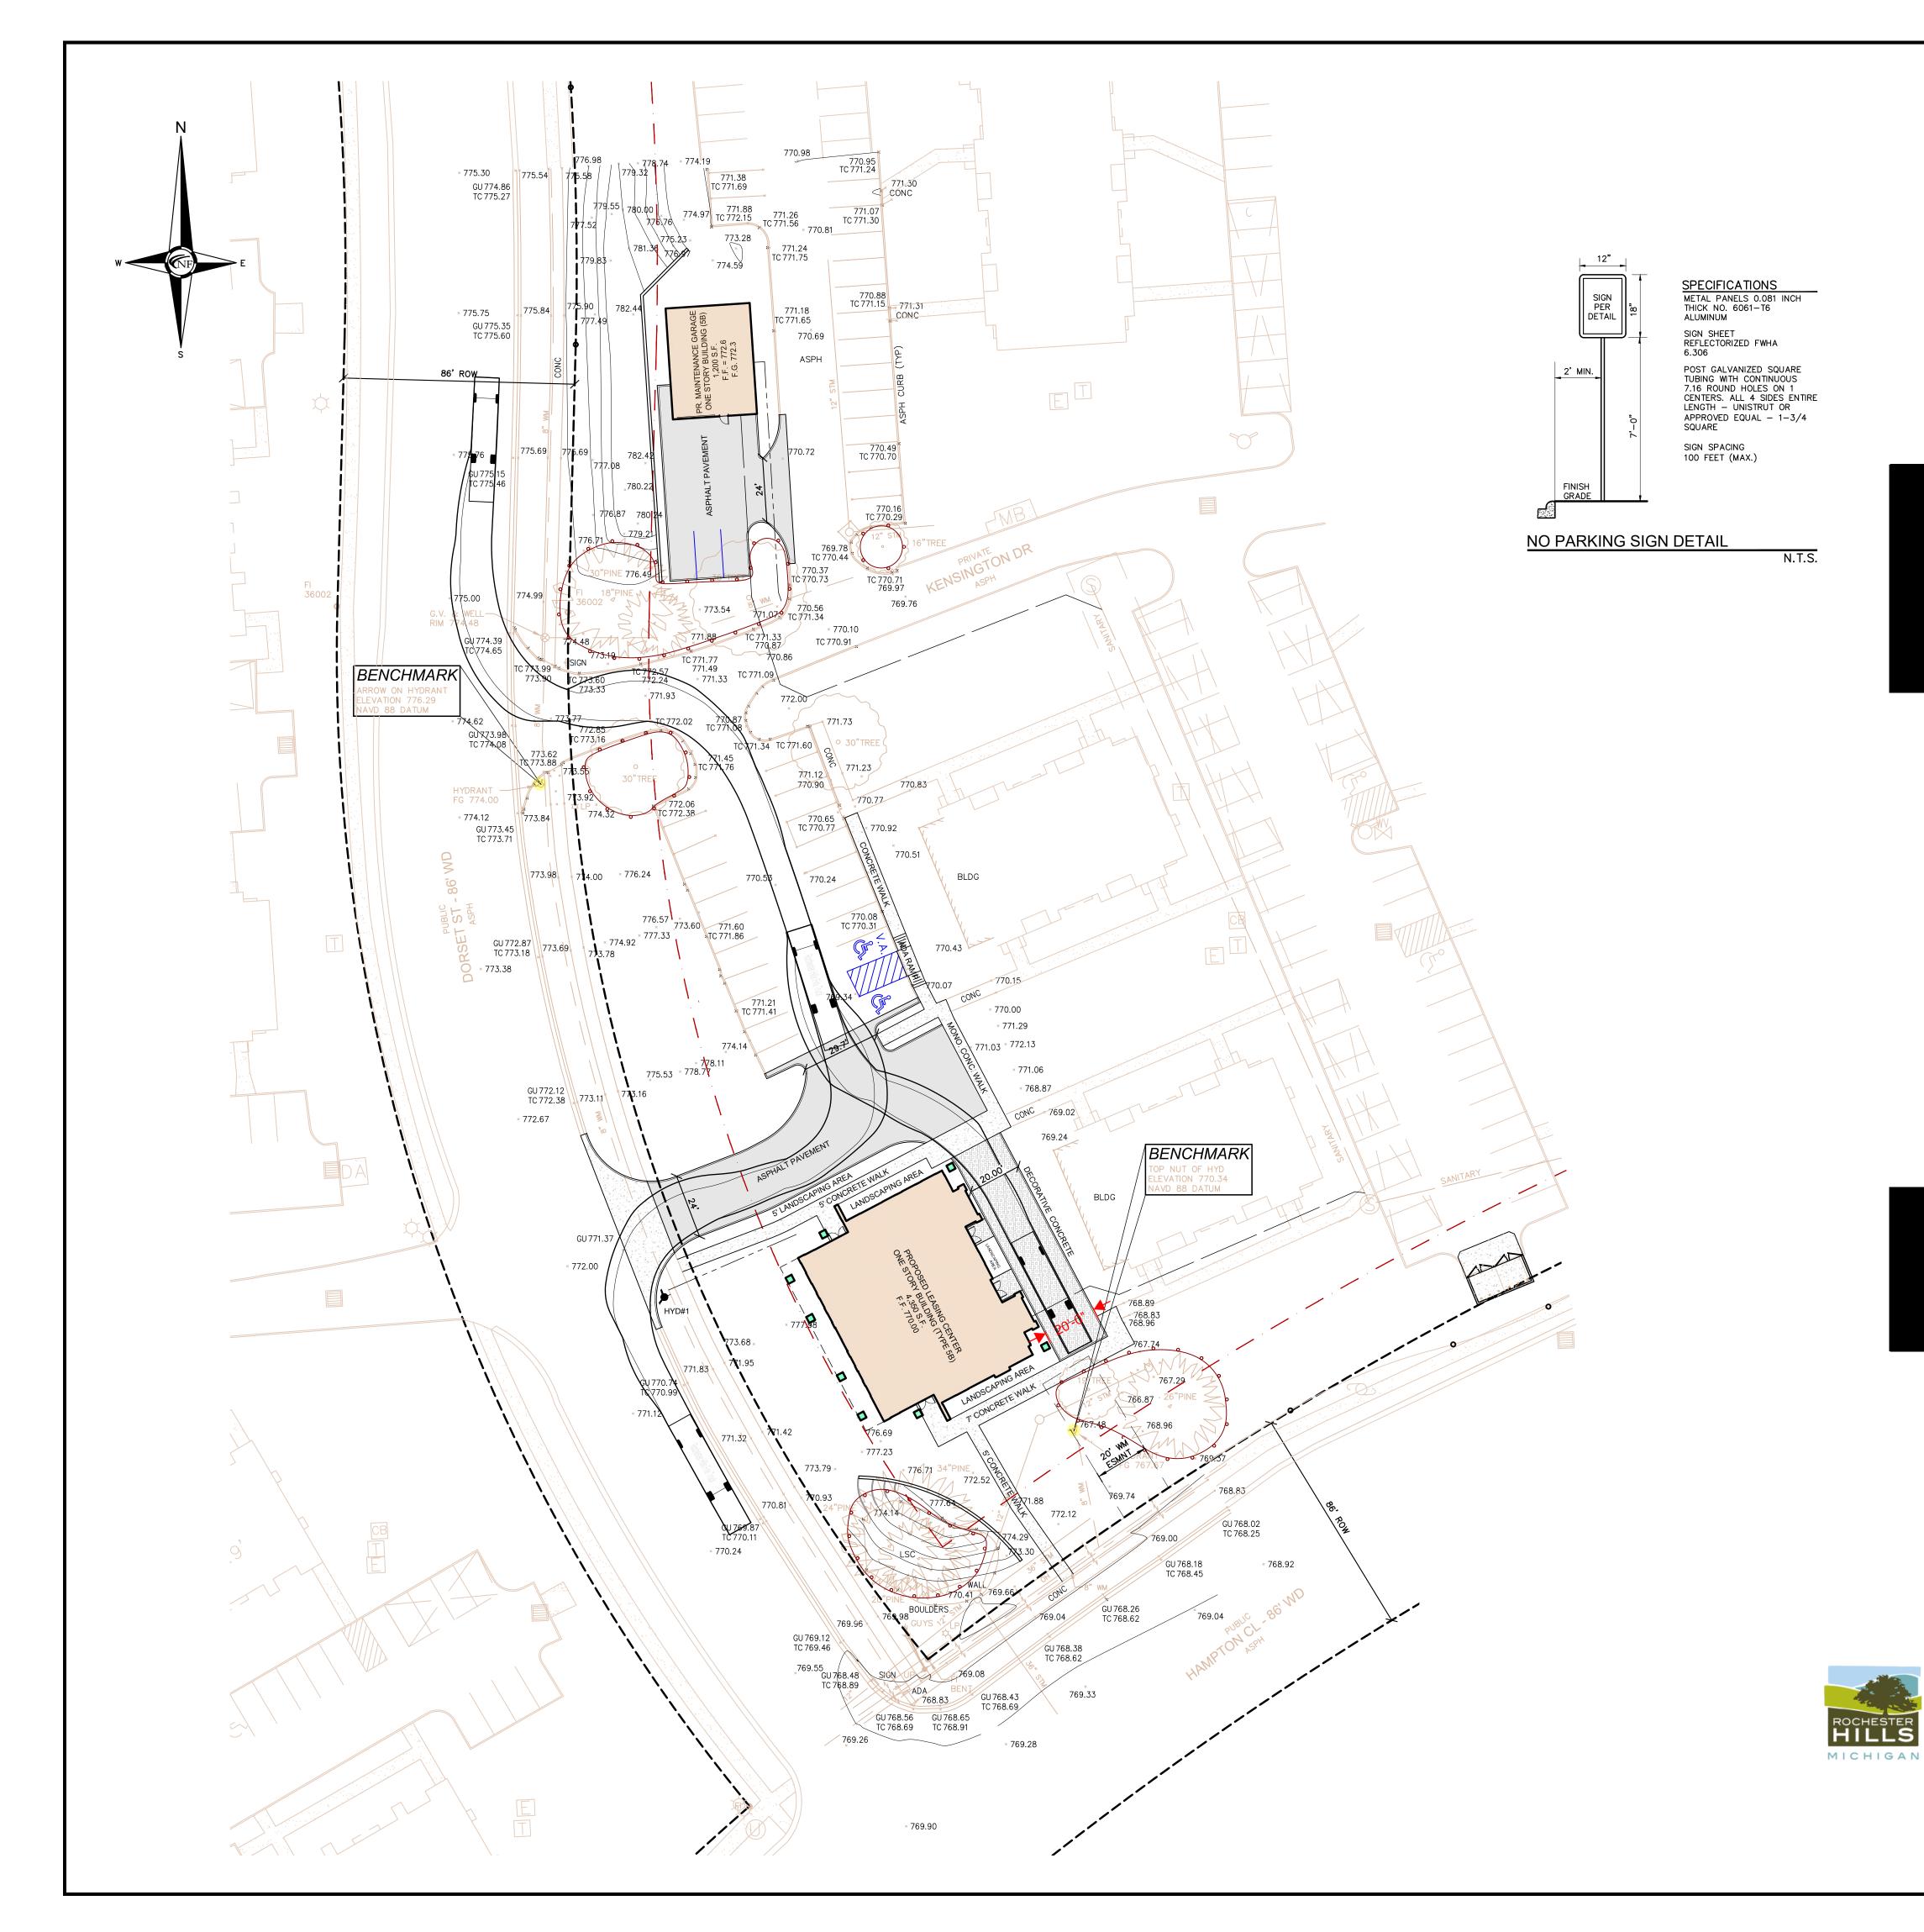



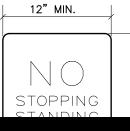




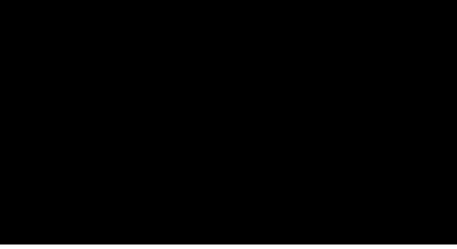



Turning Performance Analysis

Chassis: Arrow XT Chassis, PAP/Midmount Body: Aerial, Platform, 95', Mid-Mount, Alum Body

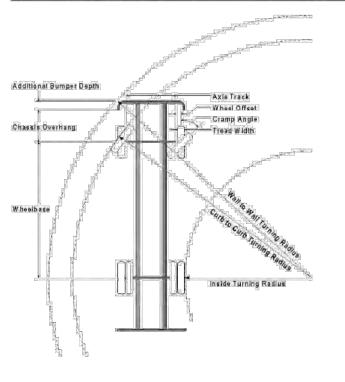


Inside Cramp Angle:	45
Axle Track:	82.92 in.
Vheel Offset:	4.68 in.
Fread Width:	17.4 in.
Chassis Overhang:	68.99 in.
Additional Bumper Depth:	7 in.
Front Overhang:	75.99 in.
Wheelbase:	270 in.
Overall Length	46'3"
Calculated Turning Radii:	
nside Turn:	21 ft. 5 in.
Curb to curb:	38 ft. 2 in.
Wall to wall:	41 ft. 0 in.

03/30/2017

95' PAP - City of Rochester Hills Rear Overhang - 16 feet


FIRE DEPARTMENT NOTES 1) A "KNOX" KEY SYSTEM MAY BE REQUIRED IN A LOCATION APPROVED BY THE FIRE CODE OFFICIAL. ORDERING INFORMATION IS

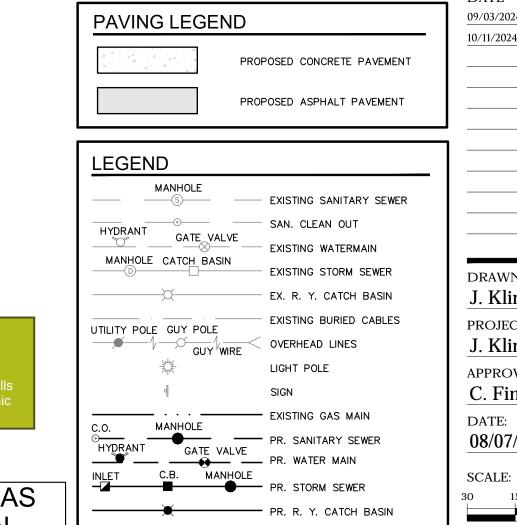

PROPOSED LIGHT POLE


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ter Hills onomic ent

CONSTRUCTION DRAWINGS

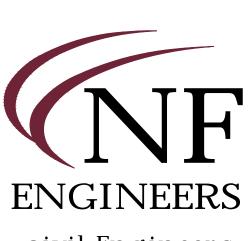

civil Engineers Land Surveyors Land Planners

NOWAK & FRAUS ENGINEERS 46777 Woodward Ave. Pontiac, MI 48342-5032 Tel. (248) 332-7931 Fax. (248) 332-8257 WWW.NOWAKFRAUS.COM

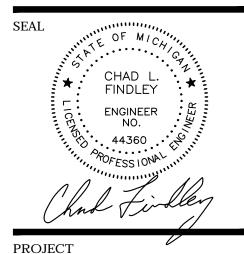

Oaks at Hampton Apartments Leasing Center

CLIENT

The Monahan Company 21321 Kelly Road Eastpointe, MI 48021

Contact: Nathan Knapp, Senior Construction Estimator Phone: (586) 774-3800 Email: nathan@themonahanco.com

PROJECT LOCATION

Part of the Northwest $\frac{1}{4}$ of Section 26, Town 3 North, Range 11 East, City of Rochester Hills, Oakland County, Michigan

SHEET

Site Plan Fire Truck Maneuvering Plan



Know what's below Call before you dig.


DATE	ISSUED/REVISED
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0/11/2024	REVISED PER CITY REVIEW
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J. Klinke	
PROJECT M	ANAGER:
J. Klinke	
APPROVED	
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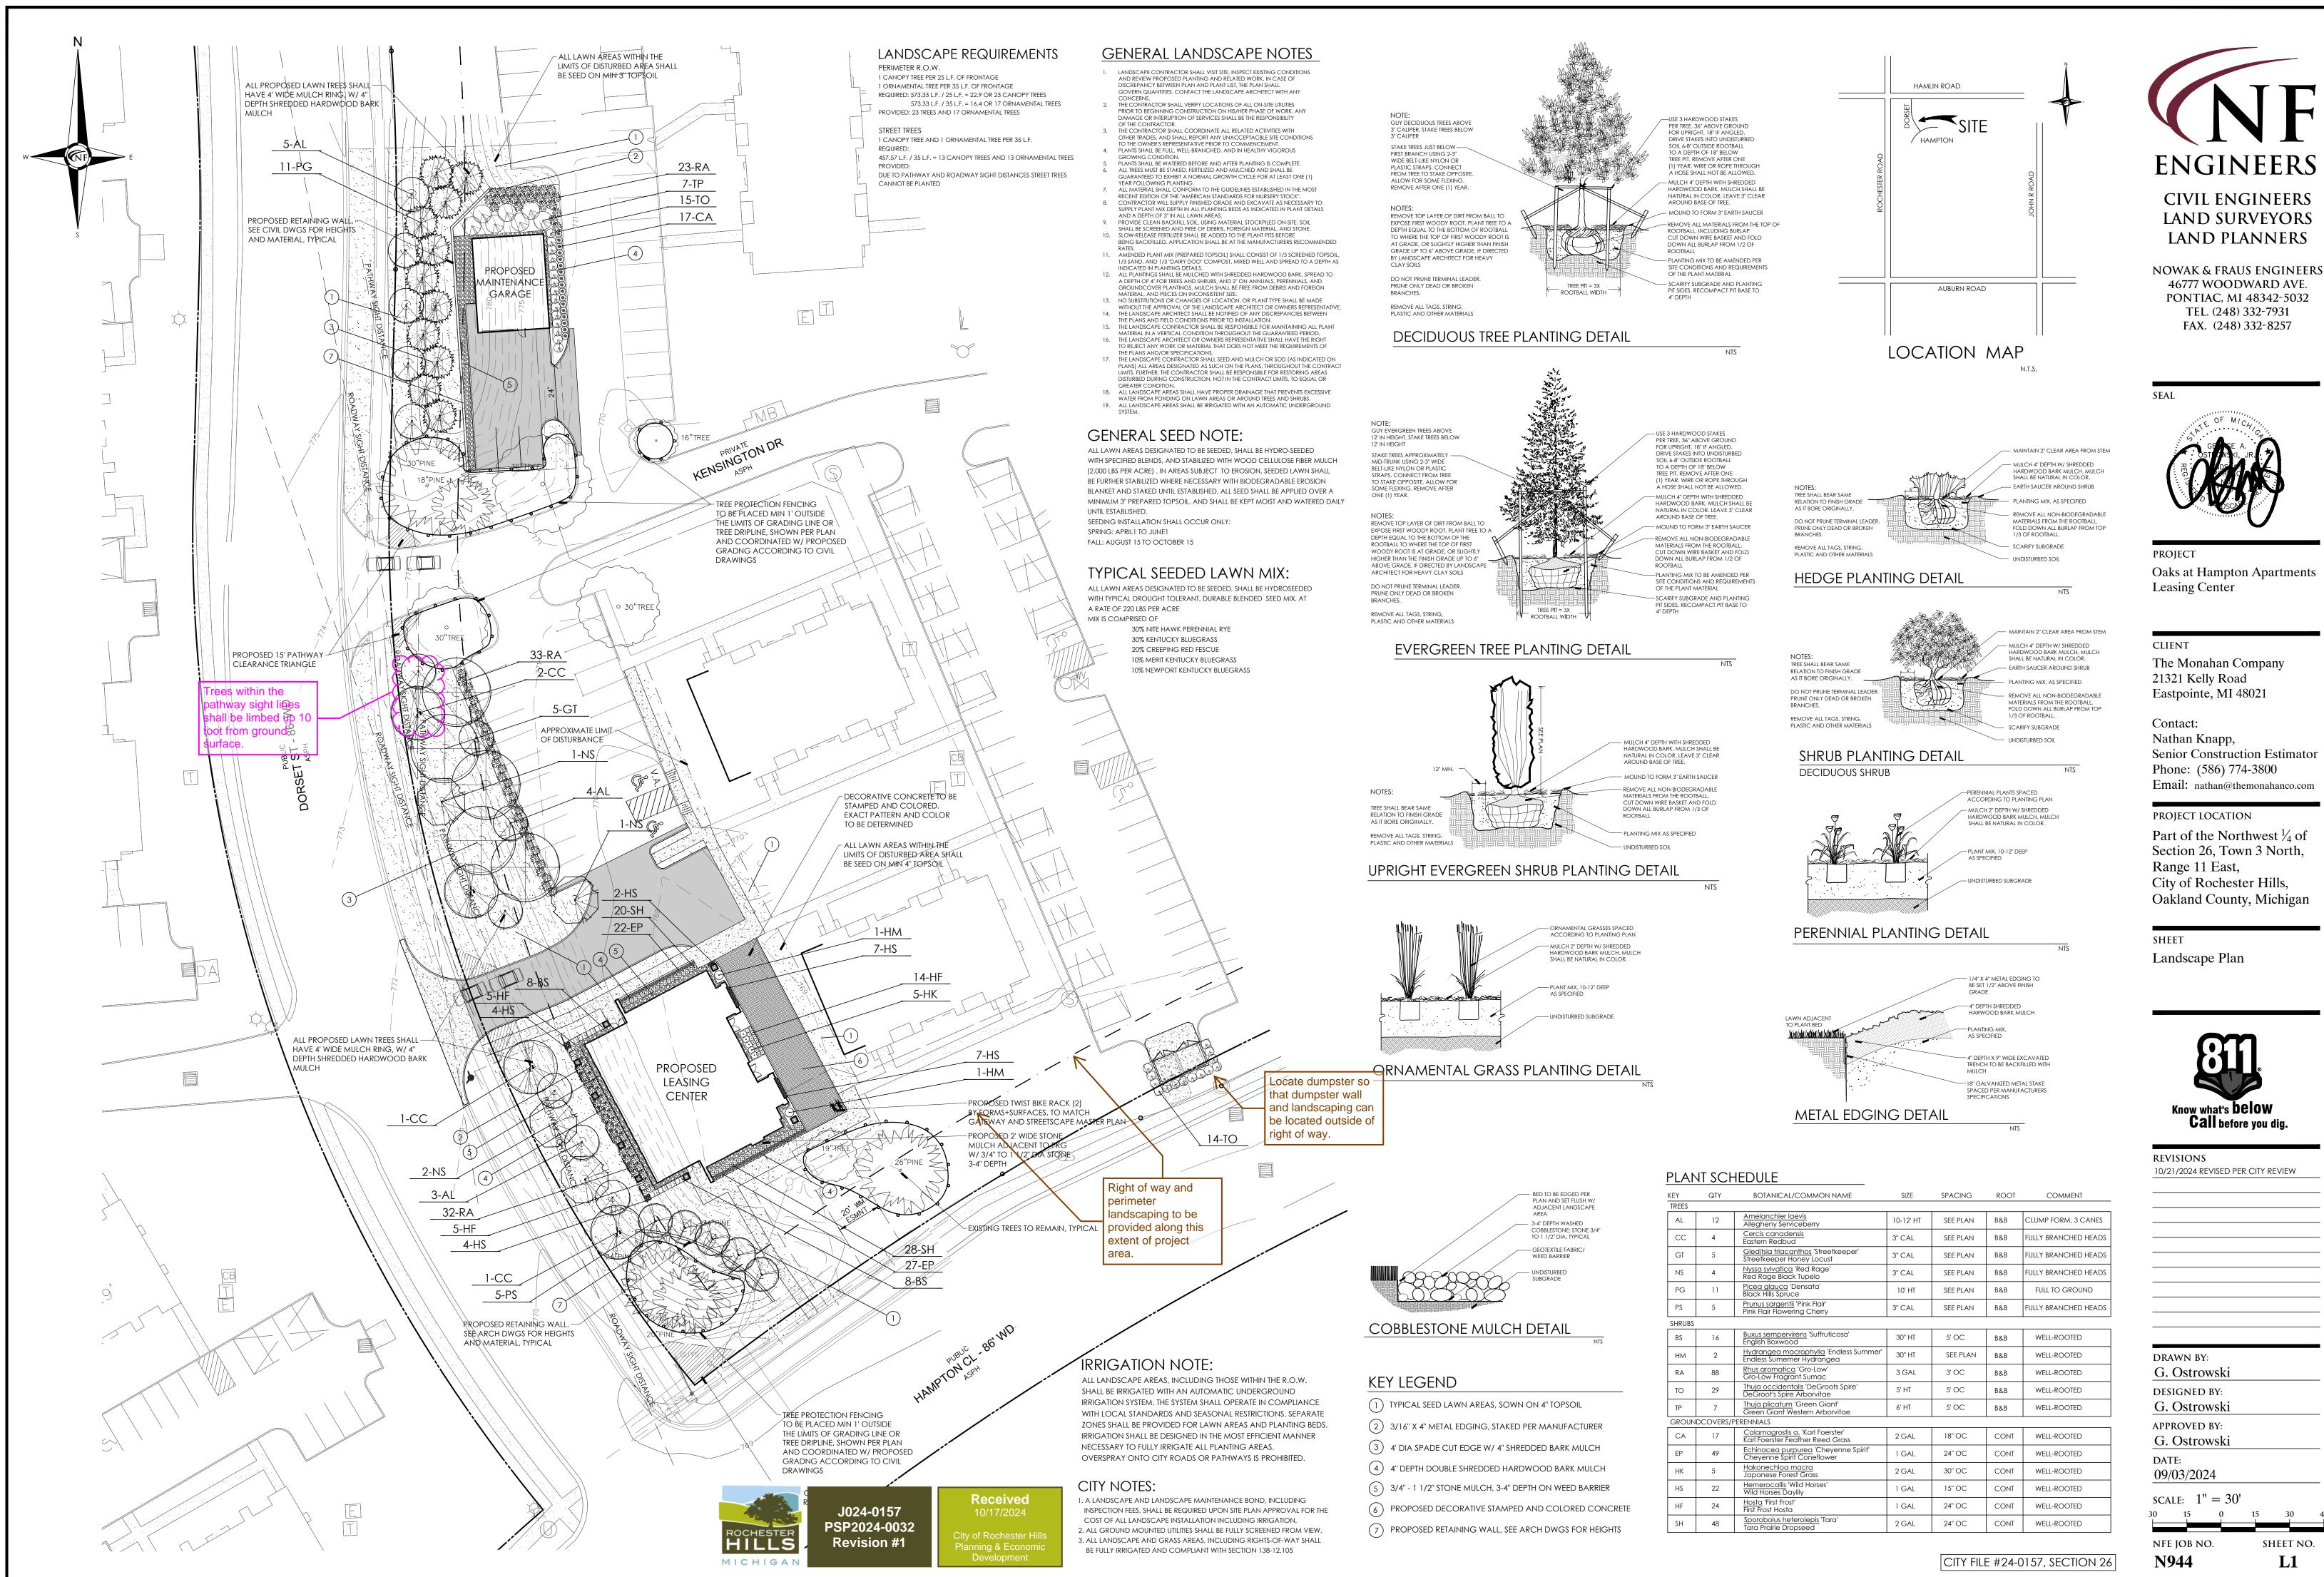





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▼	PR. R. Y. CATCH BASIN

DATE	ISSUED/REVISED)
09/03/2024	ISSUED FOR SPA	
10/11/2024	REVISED PER CITY REV	IEW
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	MANAGER:	
J. Klink	enberger	
APPROVEI	D BY:	
C. Findl	lev	
DATE:		
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00/07/20	J24	
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	Q (1)		OILL		ROOT	COMMENT
TREES						
AL	12	Amelanchier laevis Allegheny Serviceberry	10-12' HT	SEE PLAN	B&B	CLUMP FORM, 3 CANES
СС	4	Cercis canadensis Eastern Redbud	3" CAL	SEE PLAN	B&B	FULLY BRANCHED HEADS
GT	5	<u>Gleditsia triacanthos</u> 'Streetkeeper' Streetkeeper Honey Locust	3" CAL	SEE PLAN	B&B	FULLY BRANCHED HEADS
NS	4	<u>Nyssa sylvatica</u> 'Red Rage' Red Rage Black Tupelo	3" CAL	SEE PLAN	B&B	FULLY BRANCHED HEADS
PG	11	<u>Picea glauca</u> 'Densata' Black Hills Spruce	10' HT	SEE PLAN	B&B	FULL TO GROUND
PS	5	<u>Prunus sargentii</u> 'Pink Flair' Pink Flair Flowering Cherry	3" CAL	SEE PLAN	B&B	FULLY BRANCHED HEADS
SHRUBS						
BS	16	Buxus sempervirens 'Suffruticosa' English Boxwood	30" HT	5' OC	B&B	WELL-ROOTED
НМ	2	Hydrangea macrophylla 'Endless Summer' Endless Sumemer Hydrangea	30" HT	SEE PLAN	B&B	WELL-ROOTED
RA	88	<u>Rhus aromatica</u> 'Gro-Low' Gro-Low Fragrant Sumac	3 GAL	3' OC	B&B	WELL-ROOTED
TO	29	<u>Thuja occidentalis</u> 'DeGroots Spire' DeGroot's Spire Arborvitae	5' HT	5' OC	B&B	WELL-ROOTED
TP	7	<u>Thuja plicatum</u> 'Green Giant' Green Giant Western Arborvitae	6' HT	5' OC	B&B	WELL-ROOTED
GROUN	IDCOVERS/F					
CA	17	<u>Calamagrostis a.</u> 'Karl Foerster' Karl Foerster Feather Reed Grass	2 GAL	18'' OC	CONT	WELL-ROOTED
EP	49	Echinacea purpurea 'Cheyenne Spirit' Cheyenne Spirit Coneflower	1 GAL	24" OC	CONT	WELL-ROOTED
НΚ	5	Hakonechloa macra Japanese Forest Grass	2 GAL	30" OC	CONT	WELL-ROOTED
HS	22	Hemerocallis 'Wild Horses' Wild Horses Daylily	1 GAL	15" OC	CONT	WELL-ROOTED
HF	24	Hosta 'First Frost' First Frost Hosta	1 GAL	24" OC	CONT	WELL-ROOTED
SH	48	Sporobolus heterolepis 'Tara' Tara Prairie Dropseed	2 GAL	24" OC	CONT	WELL-ROOTED

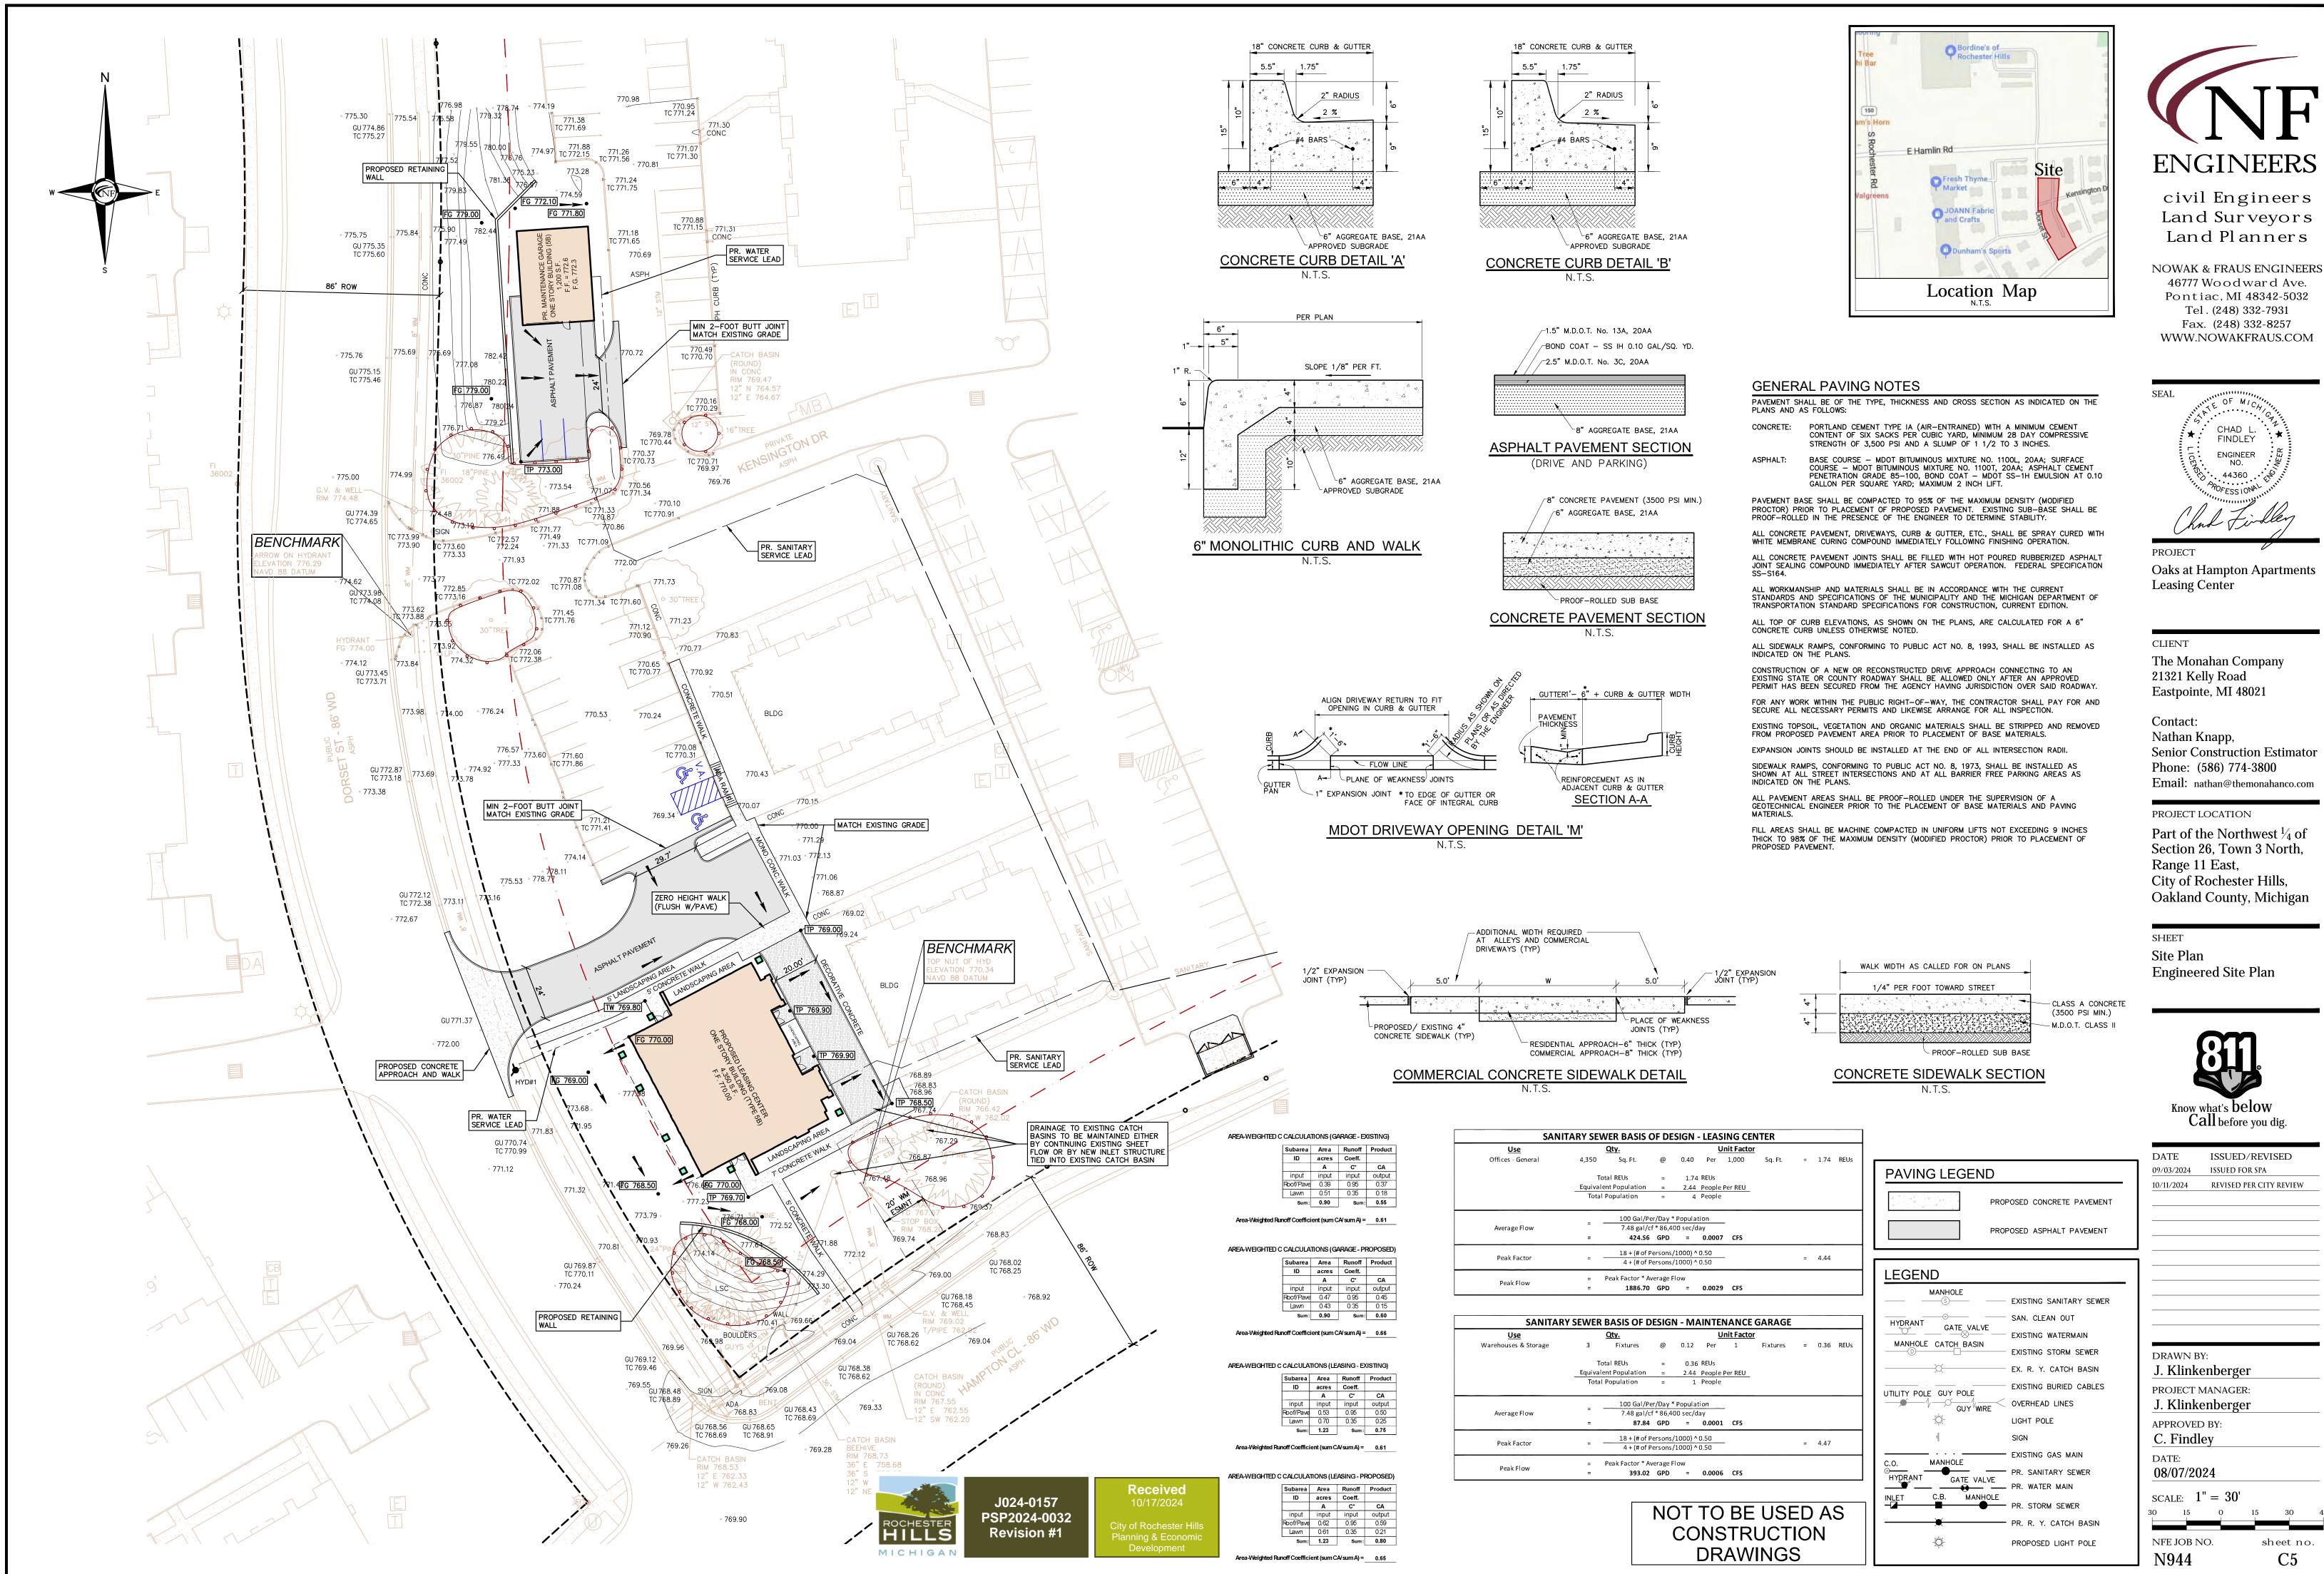

GENERAL FLOOR PLAN NOTES:

WALL BASE CONDITION.

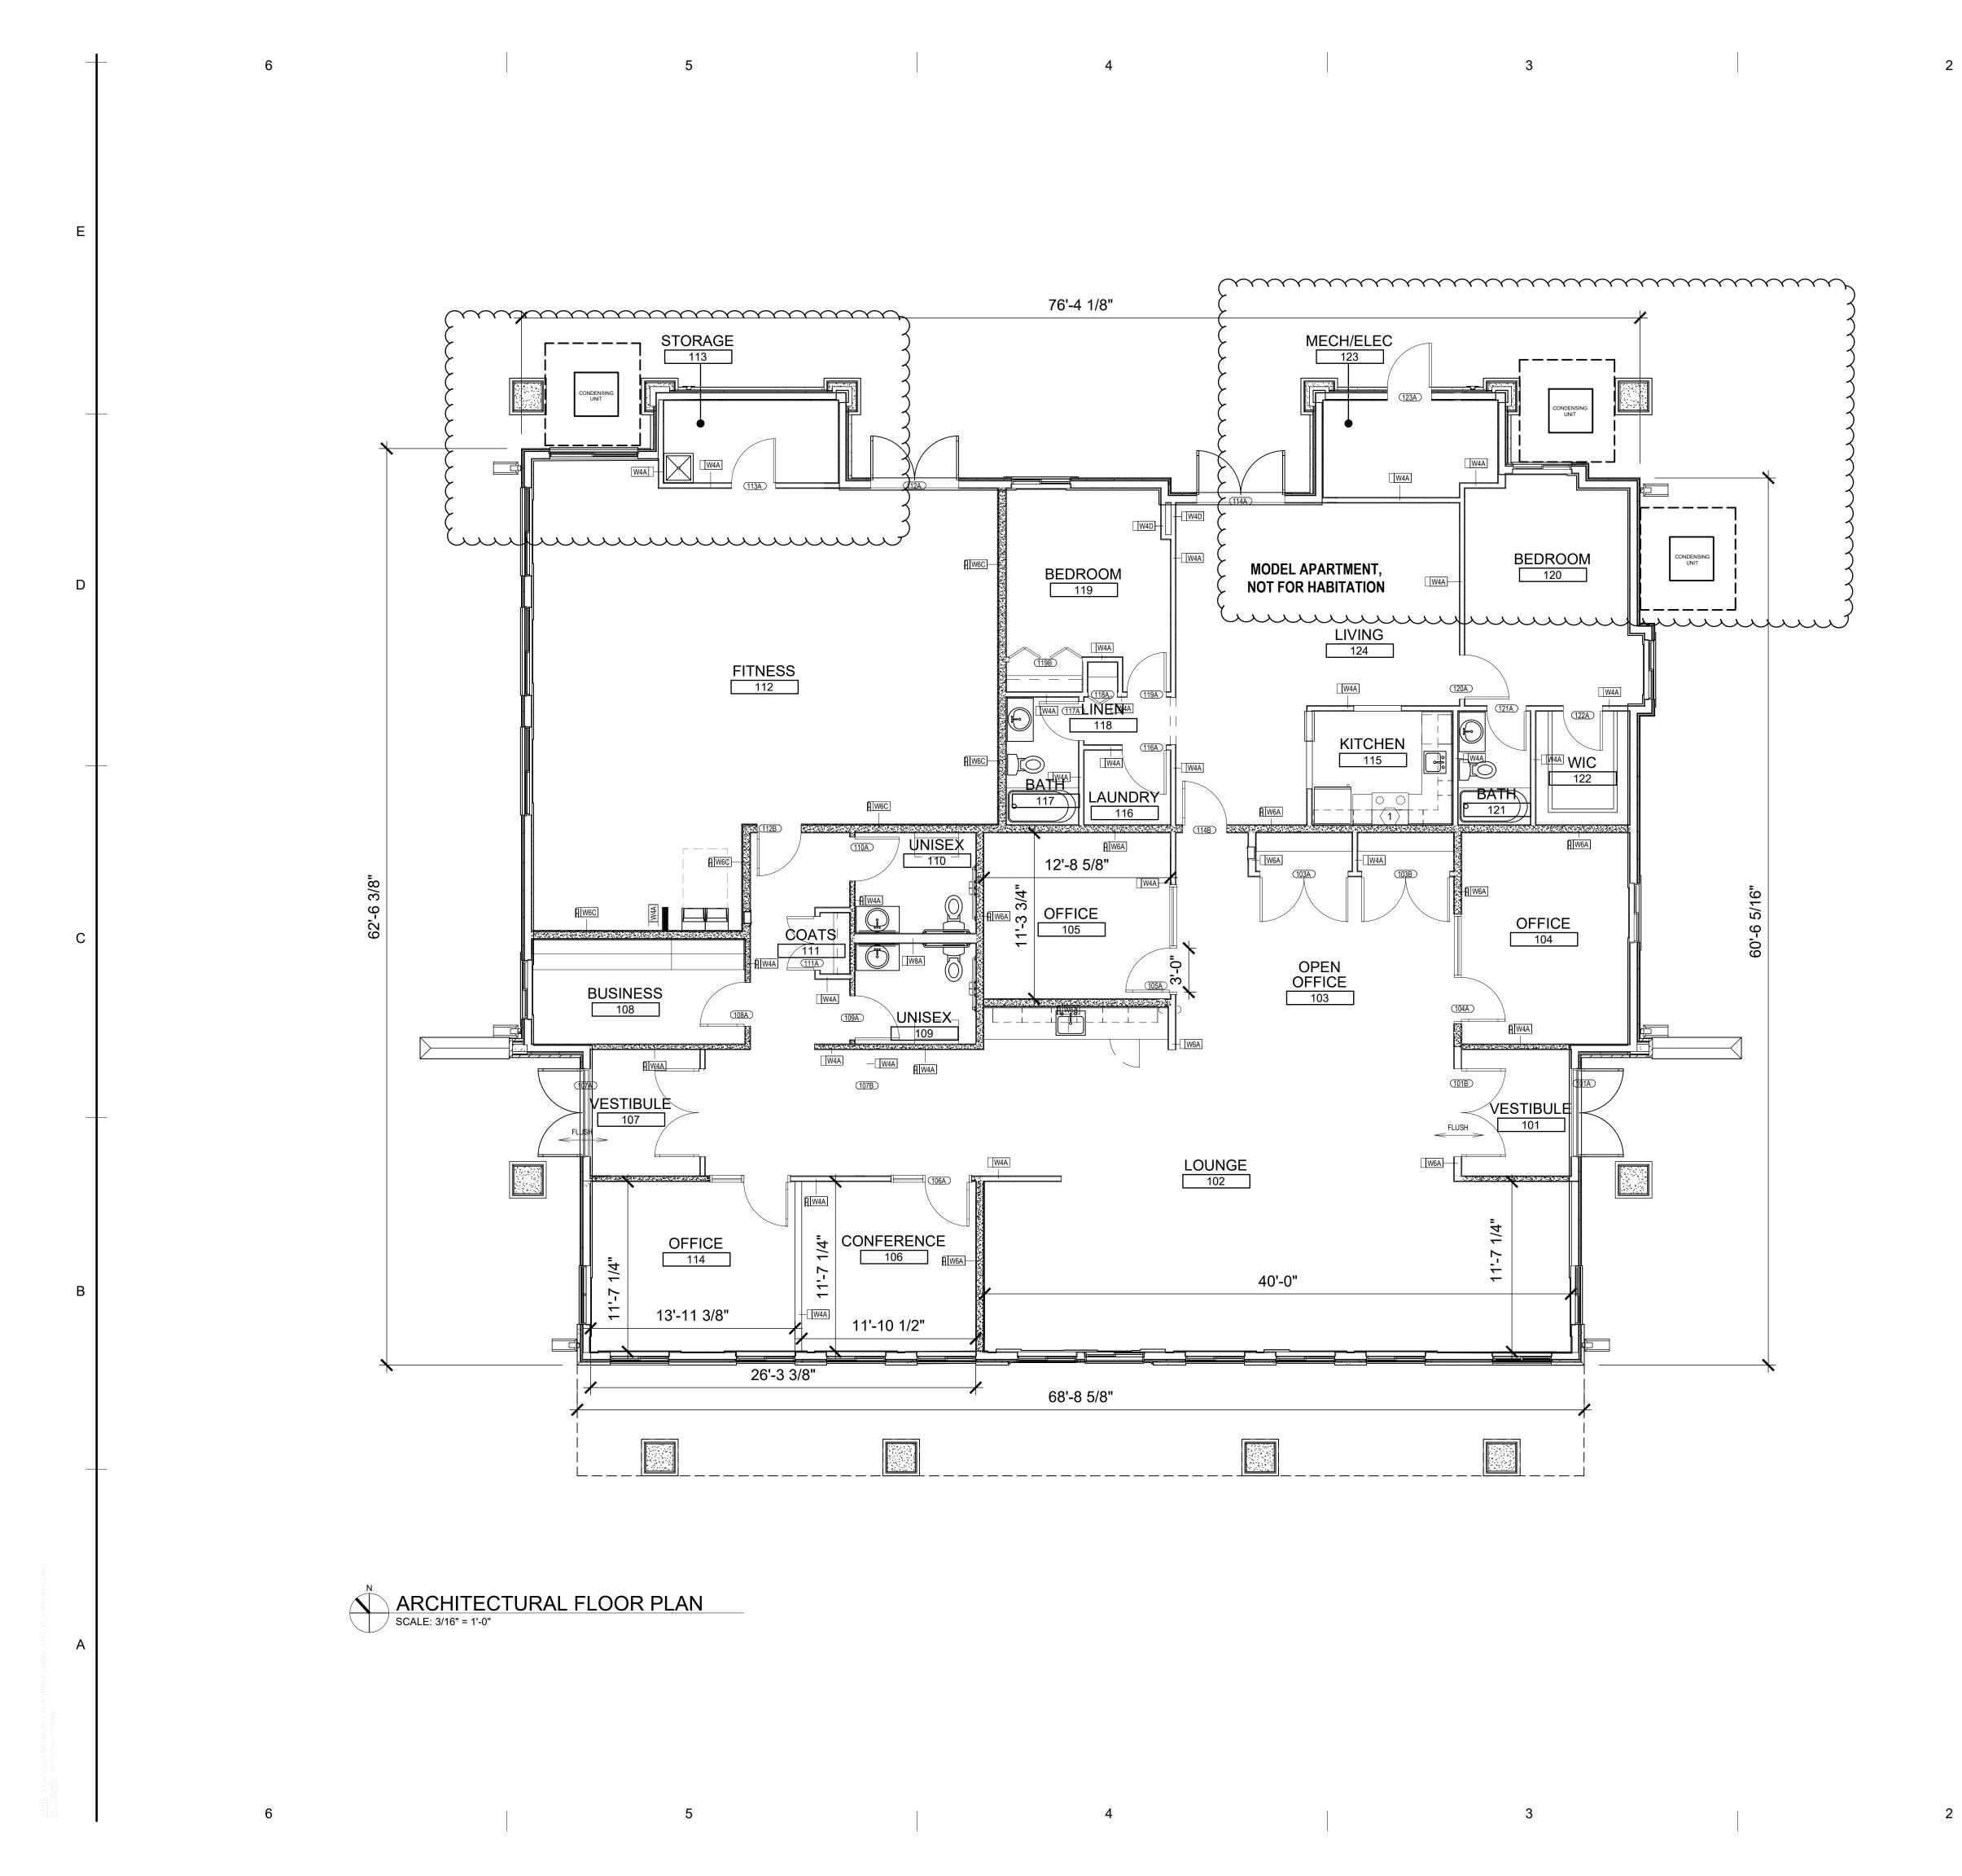- 1. THIS DRAWING IS DIAGRAMMATIC AND SHOULD BE USED TO DETERMINE THE DESIGN INTENT. THE CONTRACTOR IS RESPONSIBLE FOR THE COMPLETE SET OF WORK AS INDICATED AND SHALL FIELD VERIFY ALL WORK, COORDINATE ALL DRAWINGS / NEW WORK AND SHALL NOTIFY ARCHITECT IMMEDIATELY OF ANY DISCREPANCIES IN THE DOCUMENTS BEFORE PROCEEDING. FAILURE TO DO SO WILL RESULT IN THE CONTRACTOR TAKING FULL RESPONSIBILITY AND LIABILITY FOR SAID DISCREPANCIES.
- 2. ALL DIMENSIONS ARE SHOWN FROM FINISH FACE TO FINISH FACE OF PARTITION UNLESS OTHERWISE NOTED.
- 3. WALL THICKNESS' ARE NOMINAL NOT ACTUAL DIMENSIONS. SEE WALL SCHEDULE FOR ACTUAL DIMENSIONS.
- 4. ALL WOOD, INCLUDING BLOCKING, USED ON THE PROJECT SHALL BE FIRE RETARDANT TREATED.
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- 6. PROVIDE POSITIVE SLOPE TO ALL FLOOR DRAINS WHILE KEEPING FLOOR LEVEL AT
- 7. PROVIDE TRANSITION STRIPS AT EACH CHANGE IN FLOOR FINISH MATERIALS.
- 8. PAINT, PATCH AND REPAIR THE FOLLOWING TO MATCH EXISTING MATERIALS: FLOOR, WALL, AND CEILING SURFACES AS REQUIRED ADJACENT TO AREAS BEING DEMOLISHED. REFER TO DEMOLITION DRAWINGS FOR MORE INFORMATION.
- 9. REINFORCE WALL AND PROVIDE BLOCKING AS REQUIRED TO SUPPORT WALL CABINETS AND COUNTERTOPS.
- 10. THE CONTRACTOR SHALL PROVIDE AND INSTALL WALL REINFORCING FOR INSTALLATION OF ACCESSORIES, COAT RACKS, CHART RACKS, CASEWORK, AND OTHER WALL MOUNTED ITEMS.
- 11. CLEAN AND REPAIR ALL EXISTING FLOOR FINISHES AS NECESSARY.
- 12. ALL EXPOSED PIPES, DUCTS, AND CONDUIT TO BE PAINTED TO MATCH EXISTING.
- 13. PROVIDE CONTROL JOINTS IN GYPSUM BOARD PARTITIONS AT 30'-0" O.C. MAXIMUM AND AS INDICATED IN THE CONTRACT DOCUMENTS.
- 14. COORDINATE WITH OWNER'S EQUIPMENT SUPPLIER FOR INSTALLATION REQUIREMENTS / LOCATIONS OF FLOOR / WALL / CEILING MOUNTED ITEMS; IE. CAMERAS, TV'S, SPEAKERS, SENSORS, SECURITY WIRING, VAULTS, ATM'S.
- 15. CONTRACTOR SHALL CONDUCT A ROUGH ELECTRICAL INSPECTION WITH OWNER, PRIOR TO ENCLOSING WALLS, FOR THE PURPOSE OF CONFIRMING ALL J-BOX LOCATIONS FOR POWER, DATA, VOICE, SWITCH, THERMOSTAT, ETC.
- 16. CONTRACTOR TO FILL ANY AND ALL EQUIPMENT PENETRATIONS OR DEPRESSIONS INTO OR THROUGH THE EXISTING SLAB THAT WILL NOT BE UTILIZED TO FEED NEW EQUIPMENT (I.E. ABANDONED FLOOR CORES, IMPRESSION FROM PREVIOUS EQUIPMENT FLOOR PLATE REMOVAL). PENETRATIONS SHALL BE FILLED WITH NON-SHRINK GROUT. THE SIDES OF ANY EXISTING OPENINGS SHALL BE MODIFIED/TAPERED SO THAT THEY ARE WIDER AT THE TOP THAN AT THE BOTTOM. FOR LARGE OPENINGS, PROVIDE ONE (1) #5 BAR 2" UP FROM BOTTOM OF HOLE.
- 17. A TACTILE SIGN STATING 'EXIT' AND COMPLYING WITH ICC-A117.1 SHALL BE PROVIDED ADJACENT TO EACH DOOR TO AN 'AREA OF REFUGE', AN EXTERIOR AREA FOR ASSISTED RESCUE, AN EXIT STAIRWAY, AN EXIT RAMP, AN EXIT PASSAGEWAY, AND THE EXIT DISCHARGE.
- 18. PROVIDE PERMANENT MIN 3-INCH HIGH CONTRASTING COLOR MARKING AND IDENTIFICATION AT ALL FIRE WALLS, FIRE BARRIERS, FIRE PARTITIONS, SMOKE BARRIERS, SMOKE PARTITIONS OR ANY OTHER WALL REQUIRED TO HAVE PROTECTED OPENINGS OR PENETRATIONS WITHIN 15 FEET AT THE END OF EACH WALL, AND NOT EXCEEDING 30 FEET MAXIMUM HORIZONTAL INTERVALS, MINIMUM 2 LOCATIONS EACH WALL. TYPICAL FOR ACCESSIBLE CONCEALED FLOOR, FLOOR-CEILING, OR ATTIC SPACES PER CODE (MBC 703.7)

FLOOR PLAN KEY NOTES:

(TYPICAL THIS SHEET ONLY)

1 TYPE II HOOD SUPPRESSION SYSTEM INSTALLED NOTE



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Consultants:



Project :

OAKS AT HAMPTON APARTMENTS EAST SIDE OF DORSET DR NORTH OF HAMPTON CR ROCHESTER HILLS MI

Issued for : REVIEW: 06/27/2024 REVIEW: 07/03/2024 SPA REVIEW: 10/11/2024



Drawn by : ARA

Checked by : JAV, MJB

Sheet Title : LEASING CENTER FLOOR PLAN


Project No. : 2024.066

Sheet No.

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J024-0157 PSP2024-0032 Revision #1 Received 10/17/2024 City of Rochester Hills Planning & Economic Development



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GENERAL FLOOR PLAN NOTES:
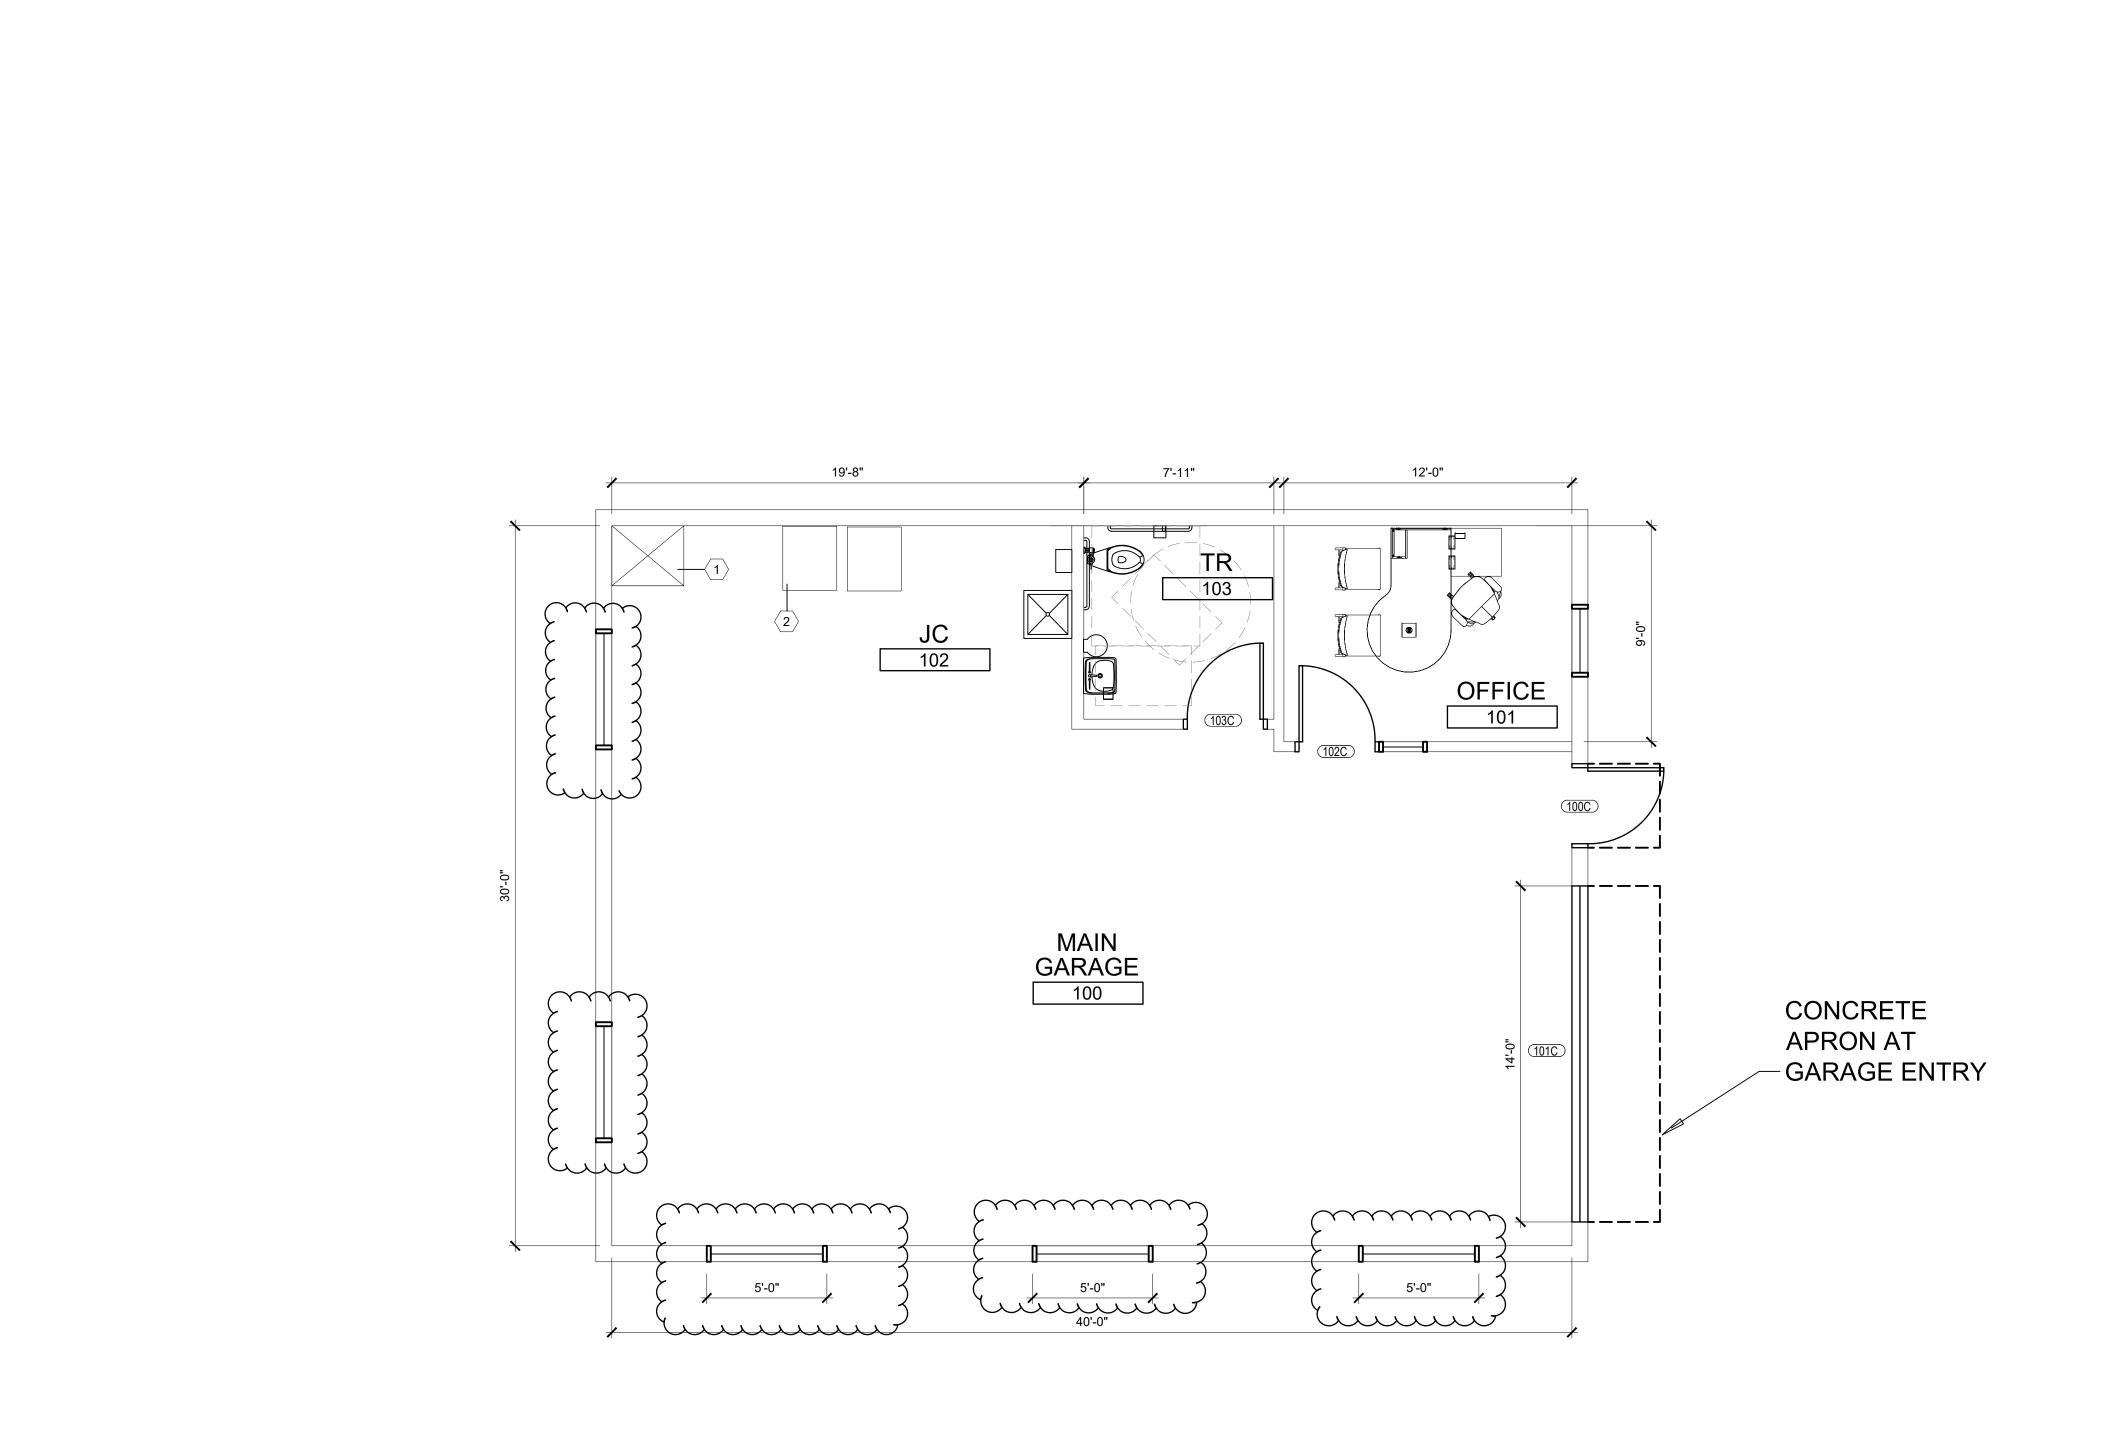
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- 1. THIS DRAWING IS DIAGRAMMATIC AND SHOULD BE USED TO DETERMINE THE DESIGN INTENT. THE CONTRACTOR IS RESPONSIBLE FOR THE COMPLETE SET OF WORK AS INDICATED AND SHALL FIELD VERIFY ALL WORK, COORDINATE ALL DRAWINGS / NEW WORK AND SHALL NOTIFY ARCHITECT IMMEDIATELY OF ANY DISCREPANCIES IN THE DOCUMENTS BEFORE PROCEEDING. FAILURE TO DO SO WILL RESULT IN THE CONTRACTOR TAKING FULL RESPONSIBILITY AND LIABILITY FOR SAID DISCREPANCIES.
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FLOOR PLAN KEY NOTES:

- (TYPICAL THIS SHEET ONLY)
- 1 FUTURE FURNACE LOCATION
- $\langle 2 \rangle$ FUTURE W/D HOOK UP LOCATION



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Consultants:



Project :

OAKS AT HAMPTON APARTMENTS EAST SIDE OF DORSET DR NORTH OF HAMPTON CR ROCHESTER HILLS MI

Issued for : REVIEW: 05/16/2024 REVIEW: 05/20/2024 SPA REVIEW: 06/18/2024

SPA REVIEW: 10/11/2024



Drawn by : ARA Checked by : JAV, MJB

Sheet Title : MAINTENANCE GARAGE FLOOR PLAN




J024-0157 PSP2024-0032 Revision #1 **Received** 10/17/2024 City of Rochester Hills


Planning & Economic


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J024-0157 PSP2024-0032 Revision #1

Received 10/17/2024 City of Rochester Hill Planning & Economic Development

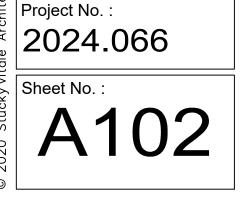SVA STUCKY VITALE ARCHITECTS 27172 WOODWARD AVENUE ROYAL OAK, MI 48067-0925 P. 248.546.6700 F. 248.546.8454 W W W . S T U C K Y V I T A L E . C O M STATEMENT OF INTELLECTUAL PROPERTY: THE IDEAS, CONCEPTS, DRAWINGS AND THOUGHT CONVEYED HEREIN ARE THE INTELLECTUAL PROPERTY OF STUCKY VITALE ARCHITECTS. THIS SET OF DRAWINGS, IN WHOLE OR IN PART, MAY NOT BE REPRODUCED, WITHOUT THE WRITTEN CONSENT OF STUCKY VITALE ARCHITECTS. THIS INFORMATION IS PROTECTED UNDER U.S. COPYRIGHT LAW, ALL RIGHTS RESERVED Consultants: NOT FOR CONSTRUCTION Project : OAKS AT HAMPTON APARTMENTS EAST SIDE OF DORSET DR NORTH OF HAMPTON CR ROCHESTER HILLS MI Issued for : REVIEW: 06/27/2024 SPA REVIEW: 10/11/2024

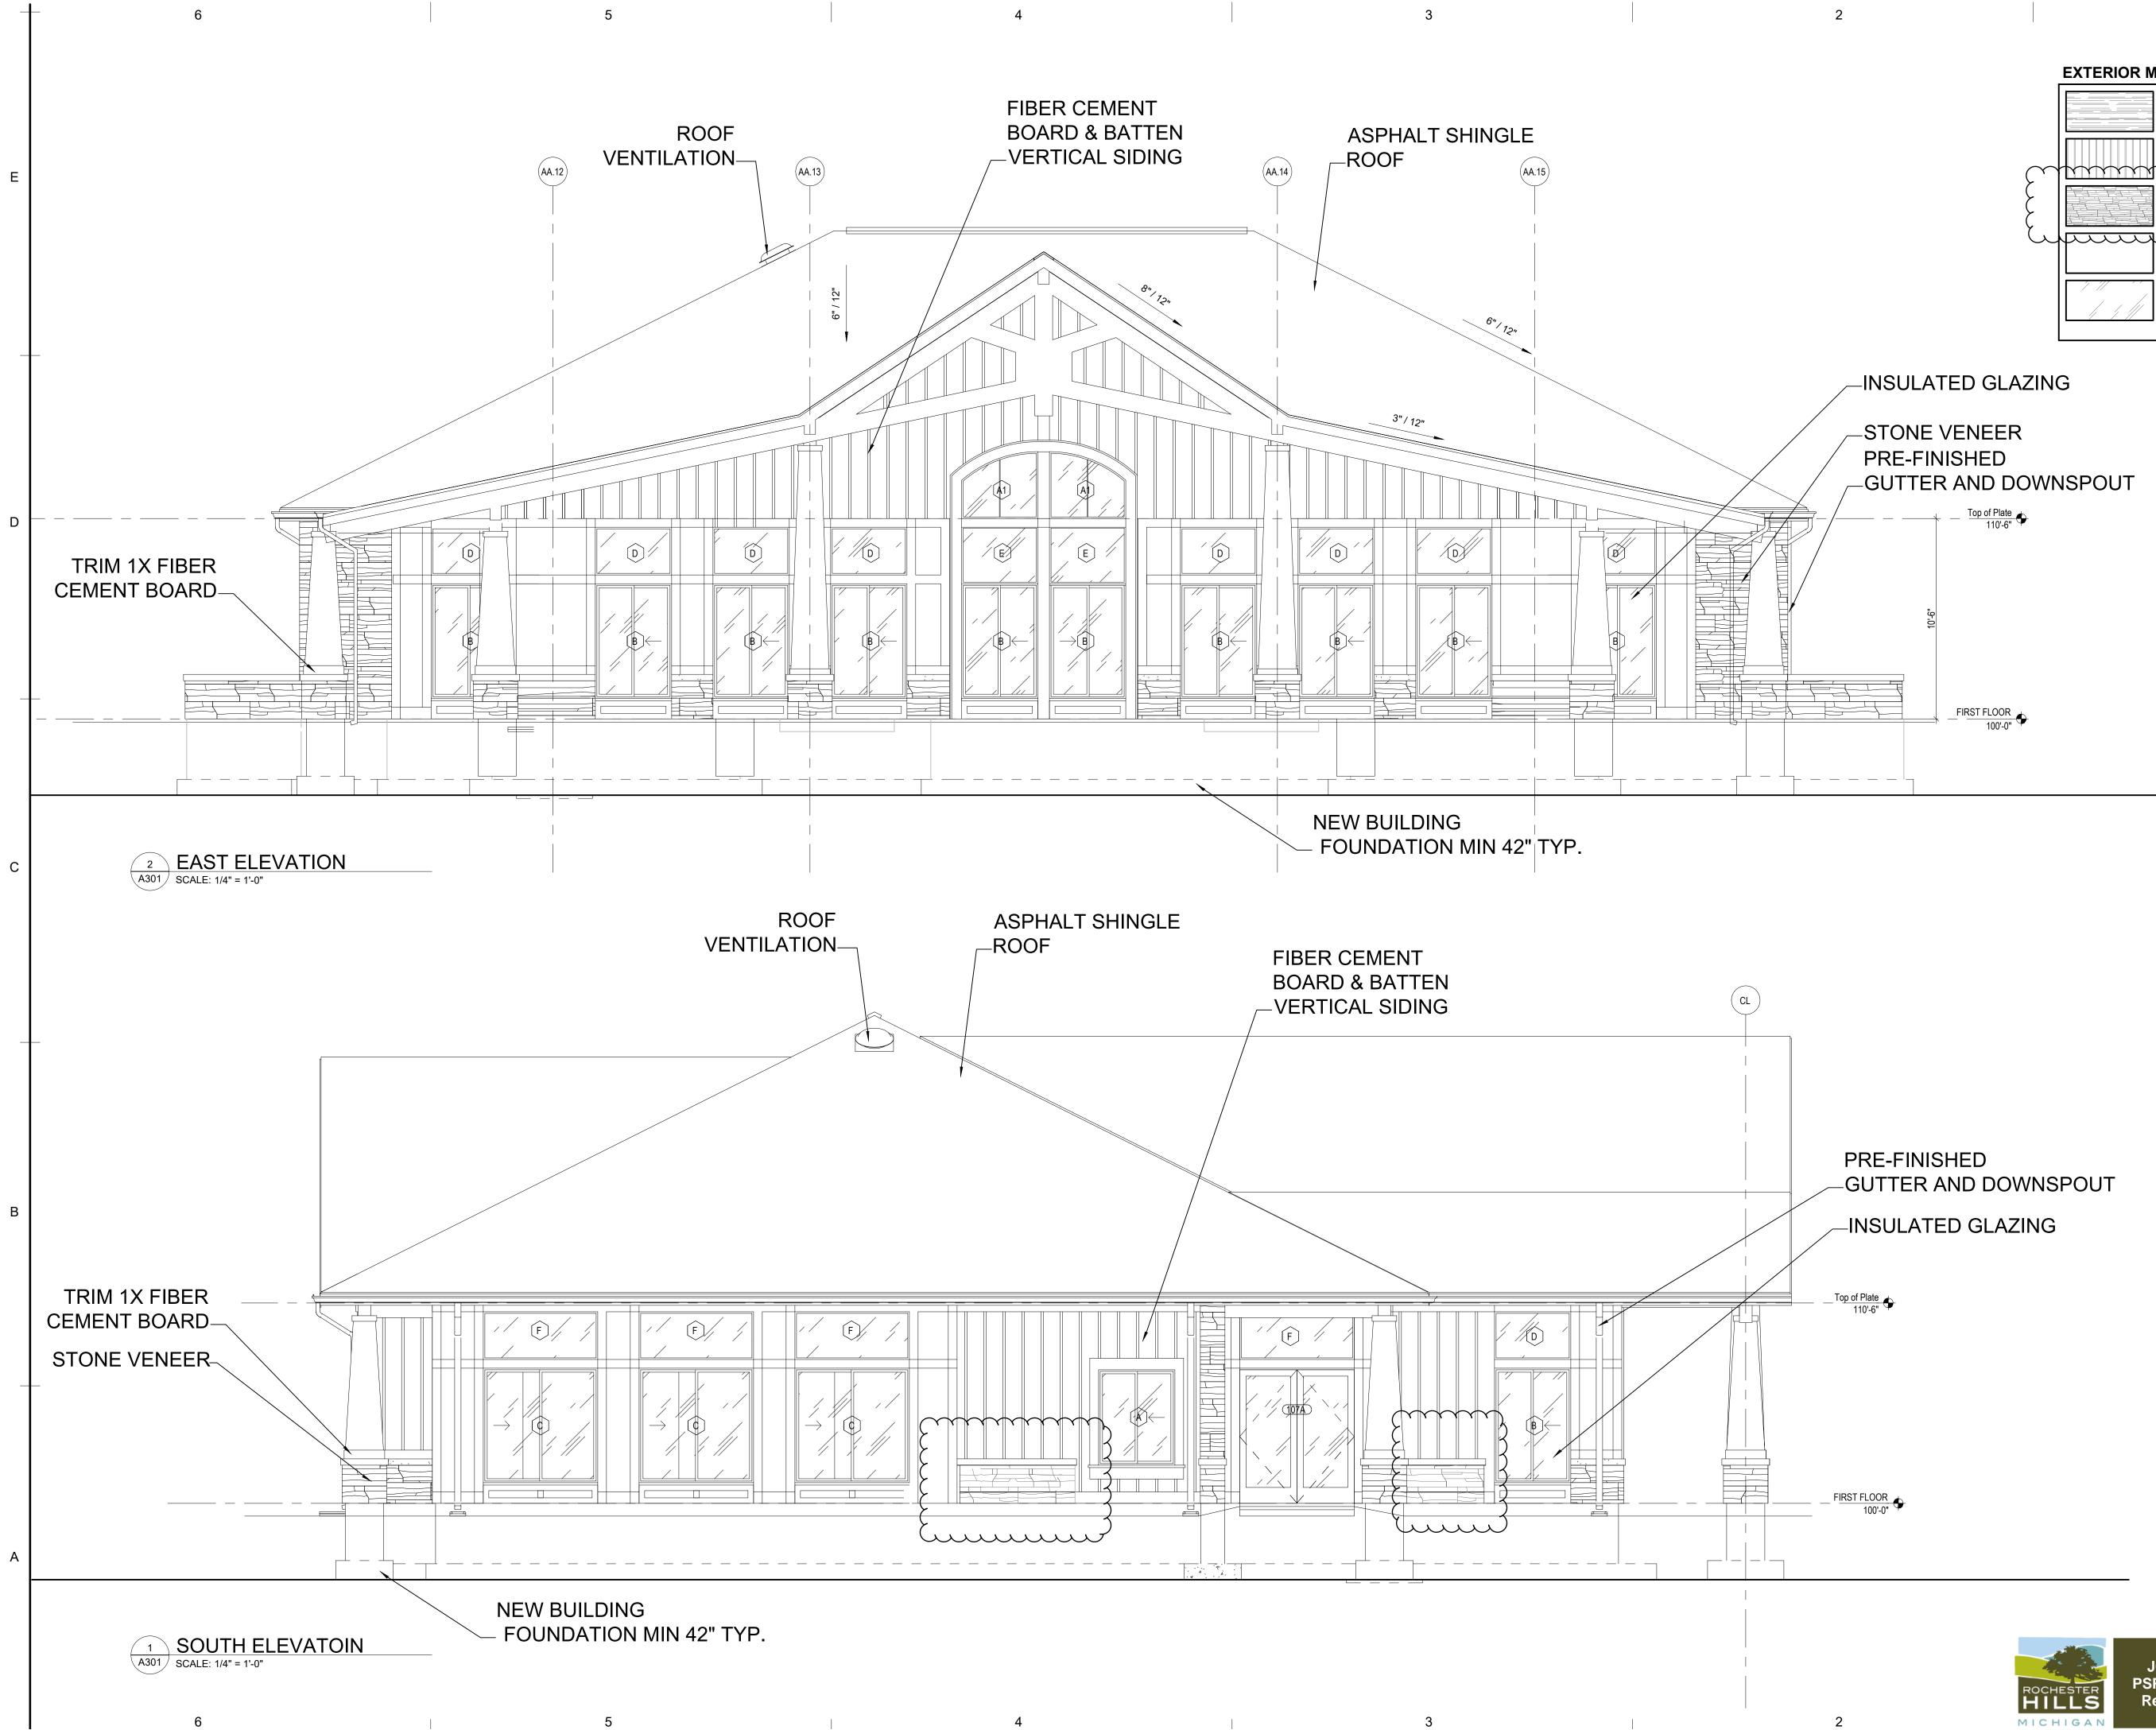


Drawn by : ARA Checked by : JAV, MJB

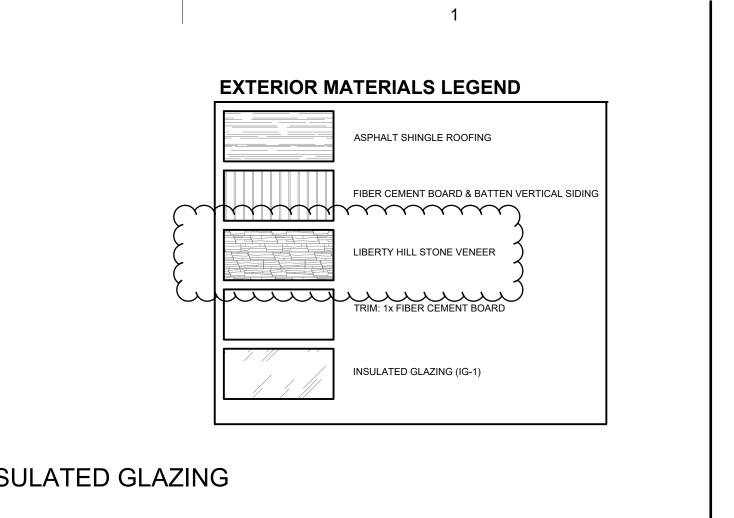Sheet Title : LEASING CENTER EXTERIOR ELEVATIONS


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Project No.





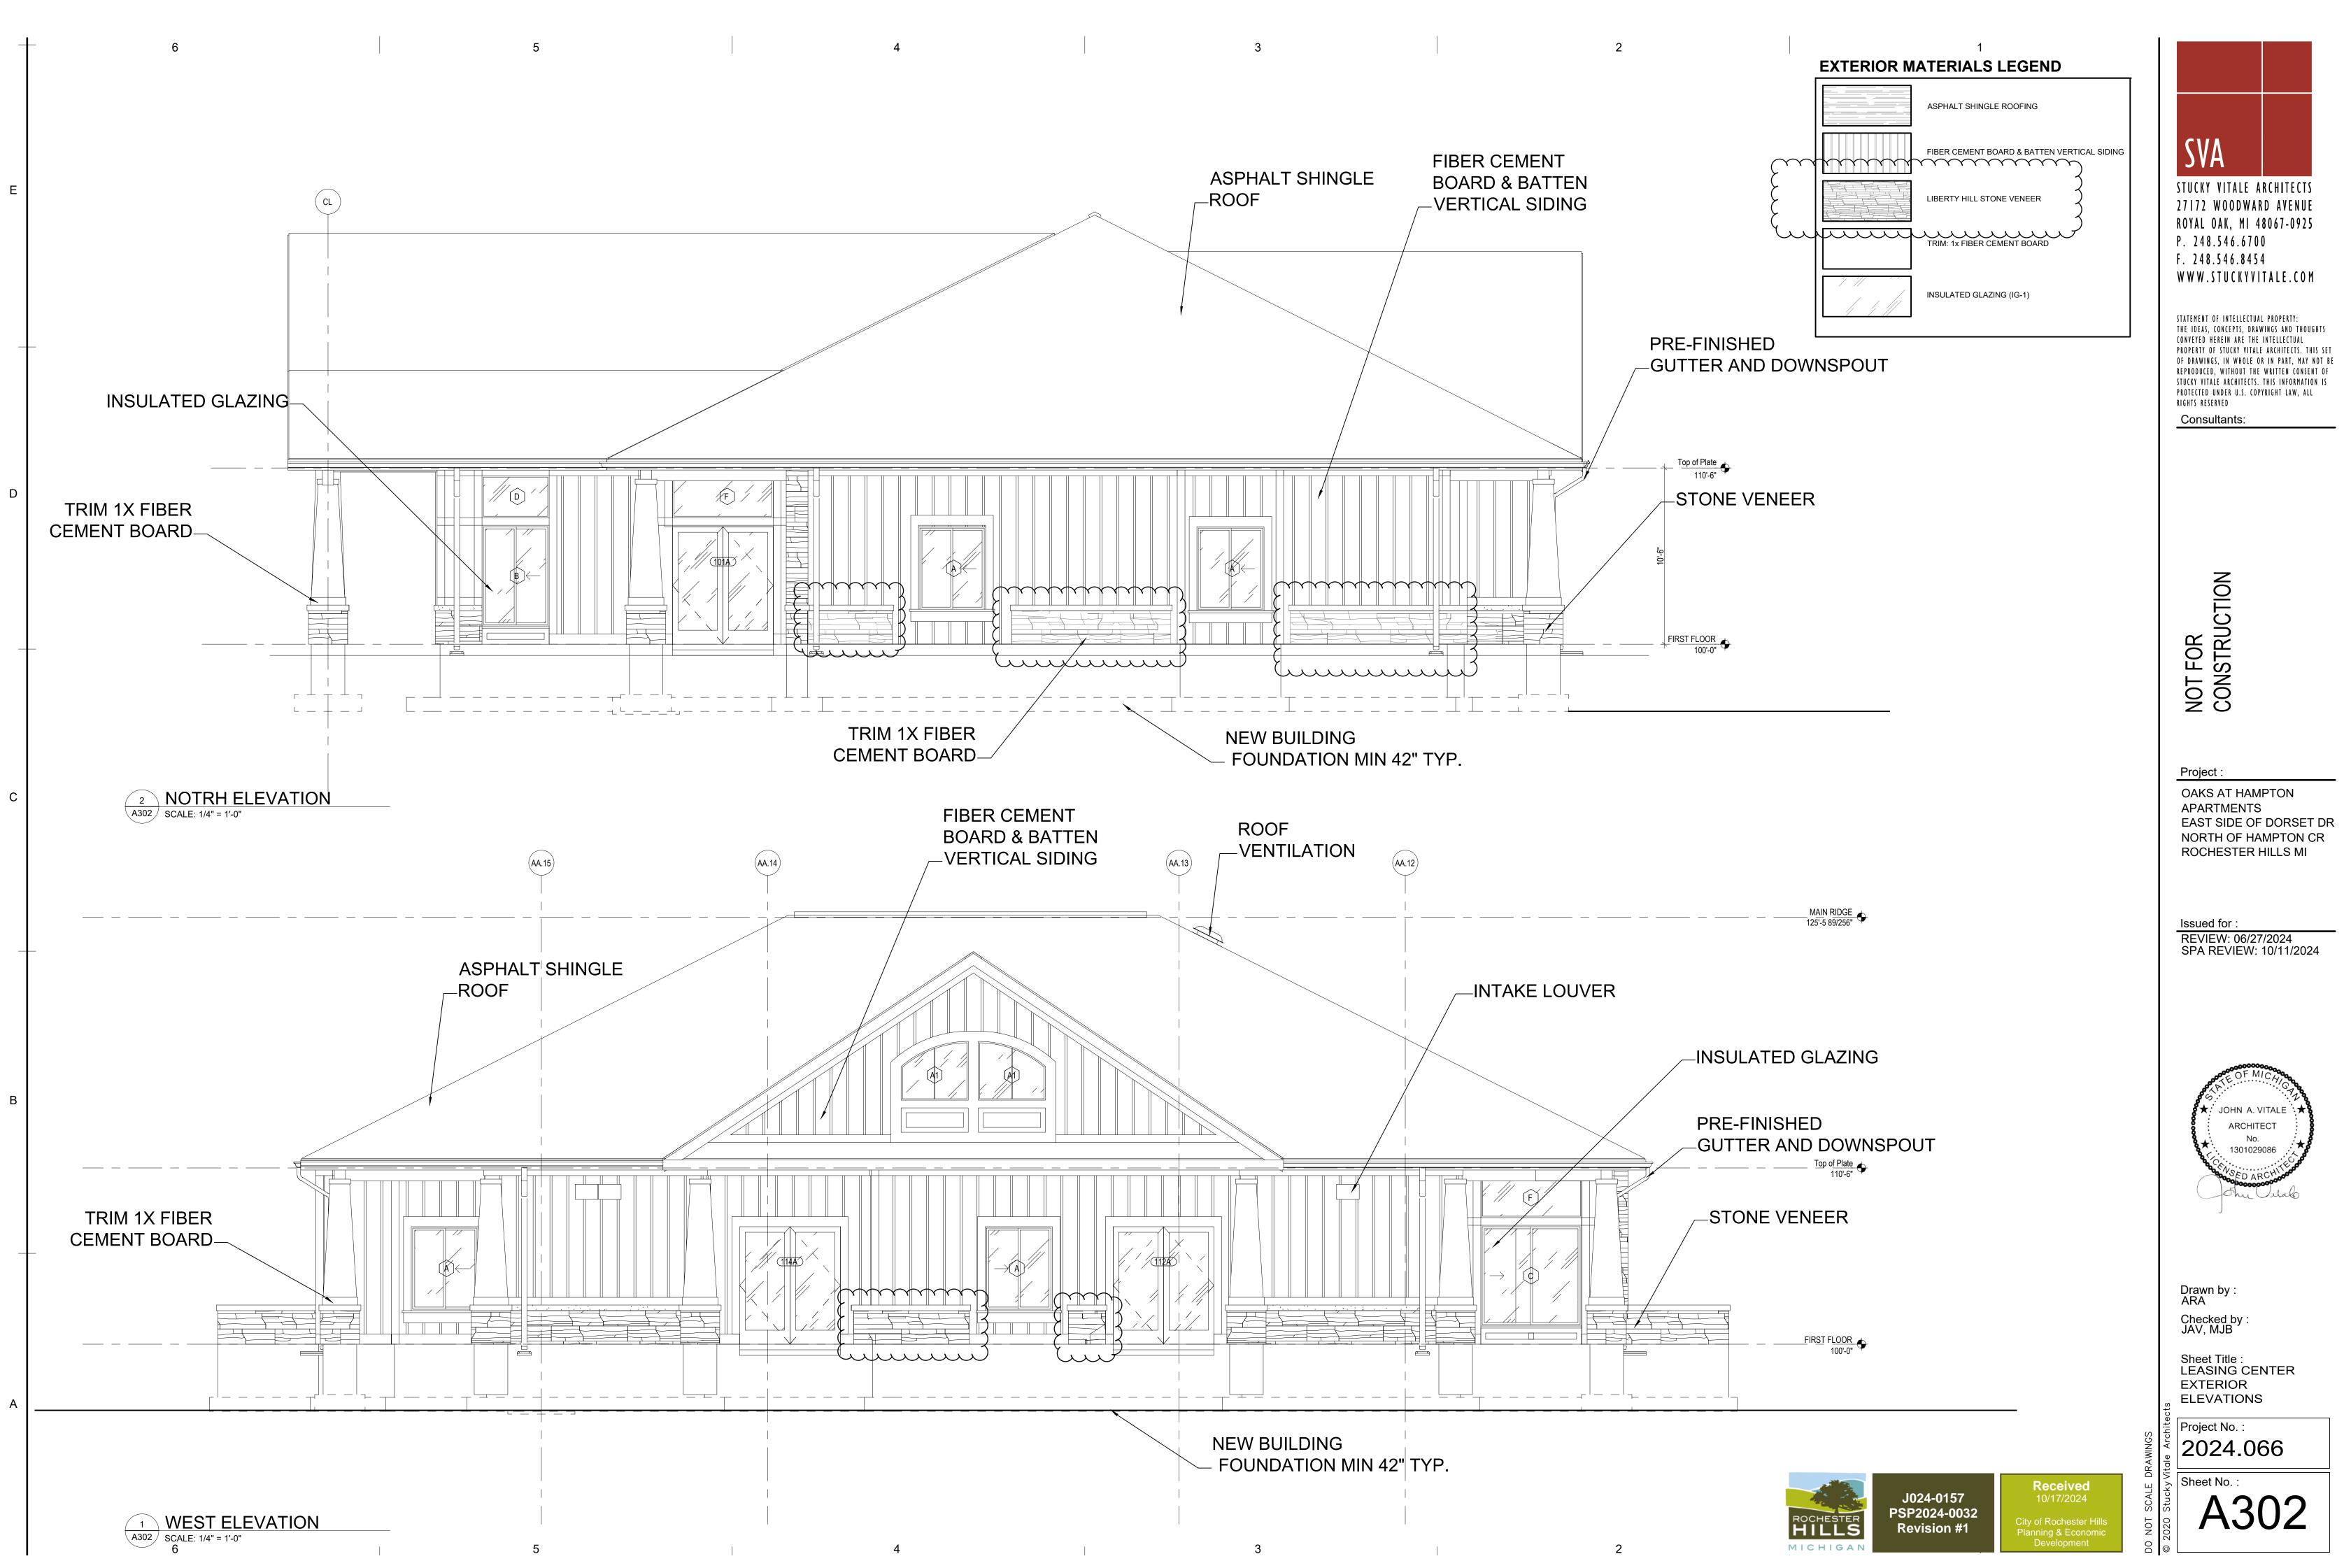



ROCHESTER HILLS MICHIGAN

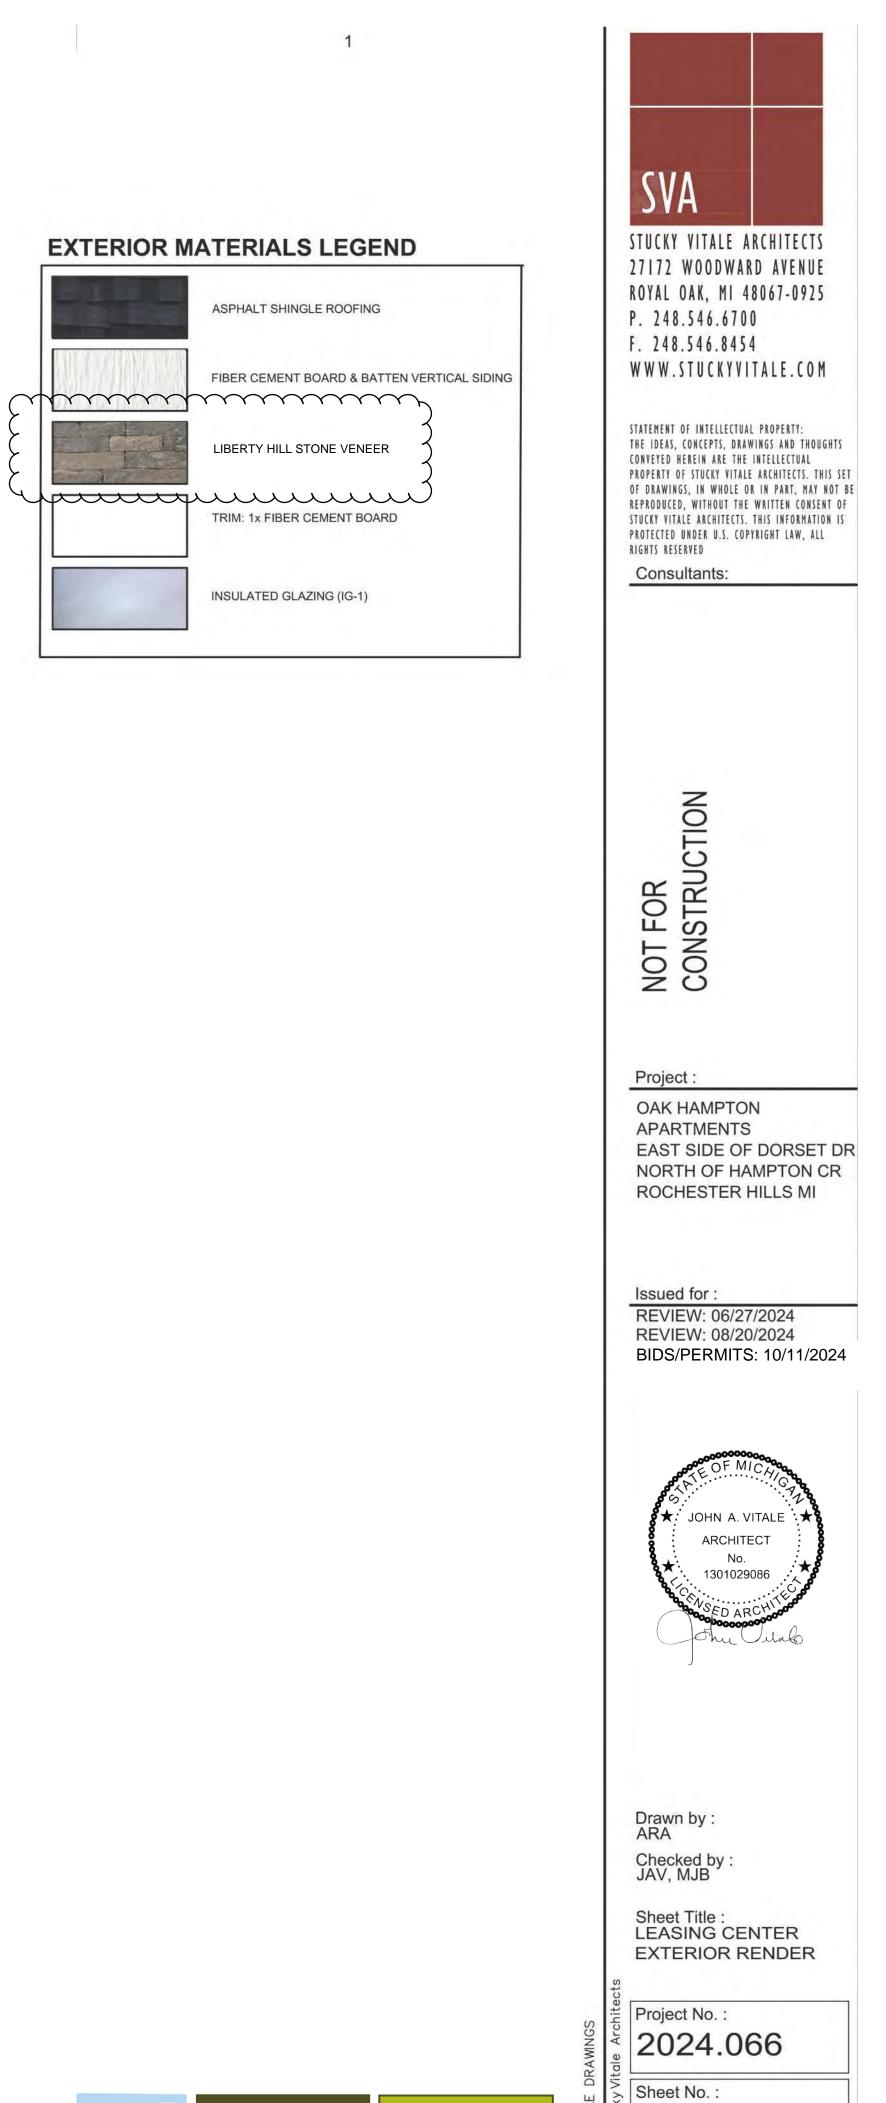J024-0157 PSP2024-0032 Revision #1

Received 10/17/2024 City of Rochester Hills Planning & Economic Development

A300

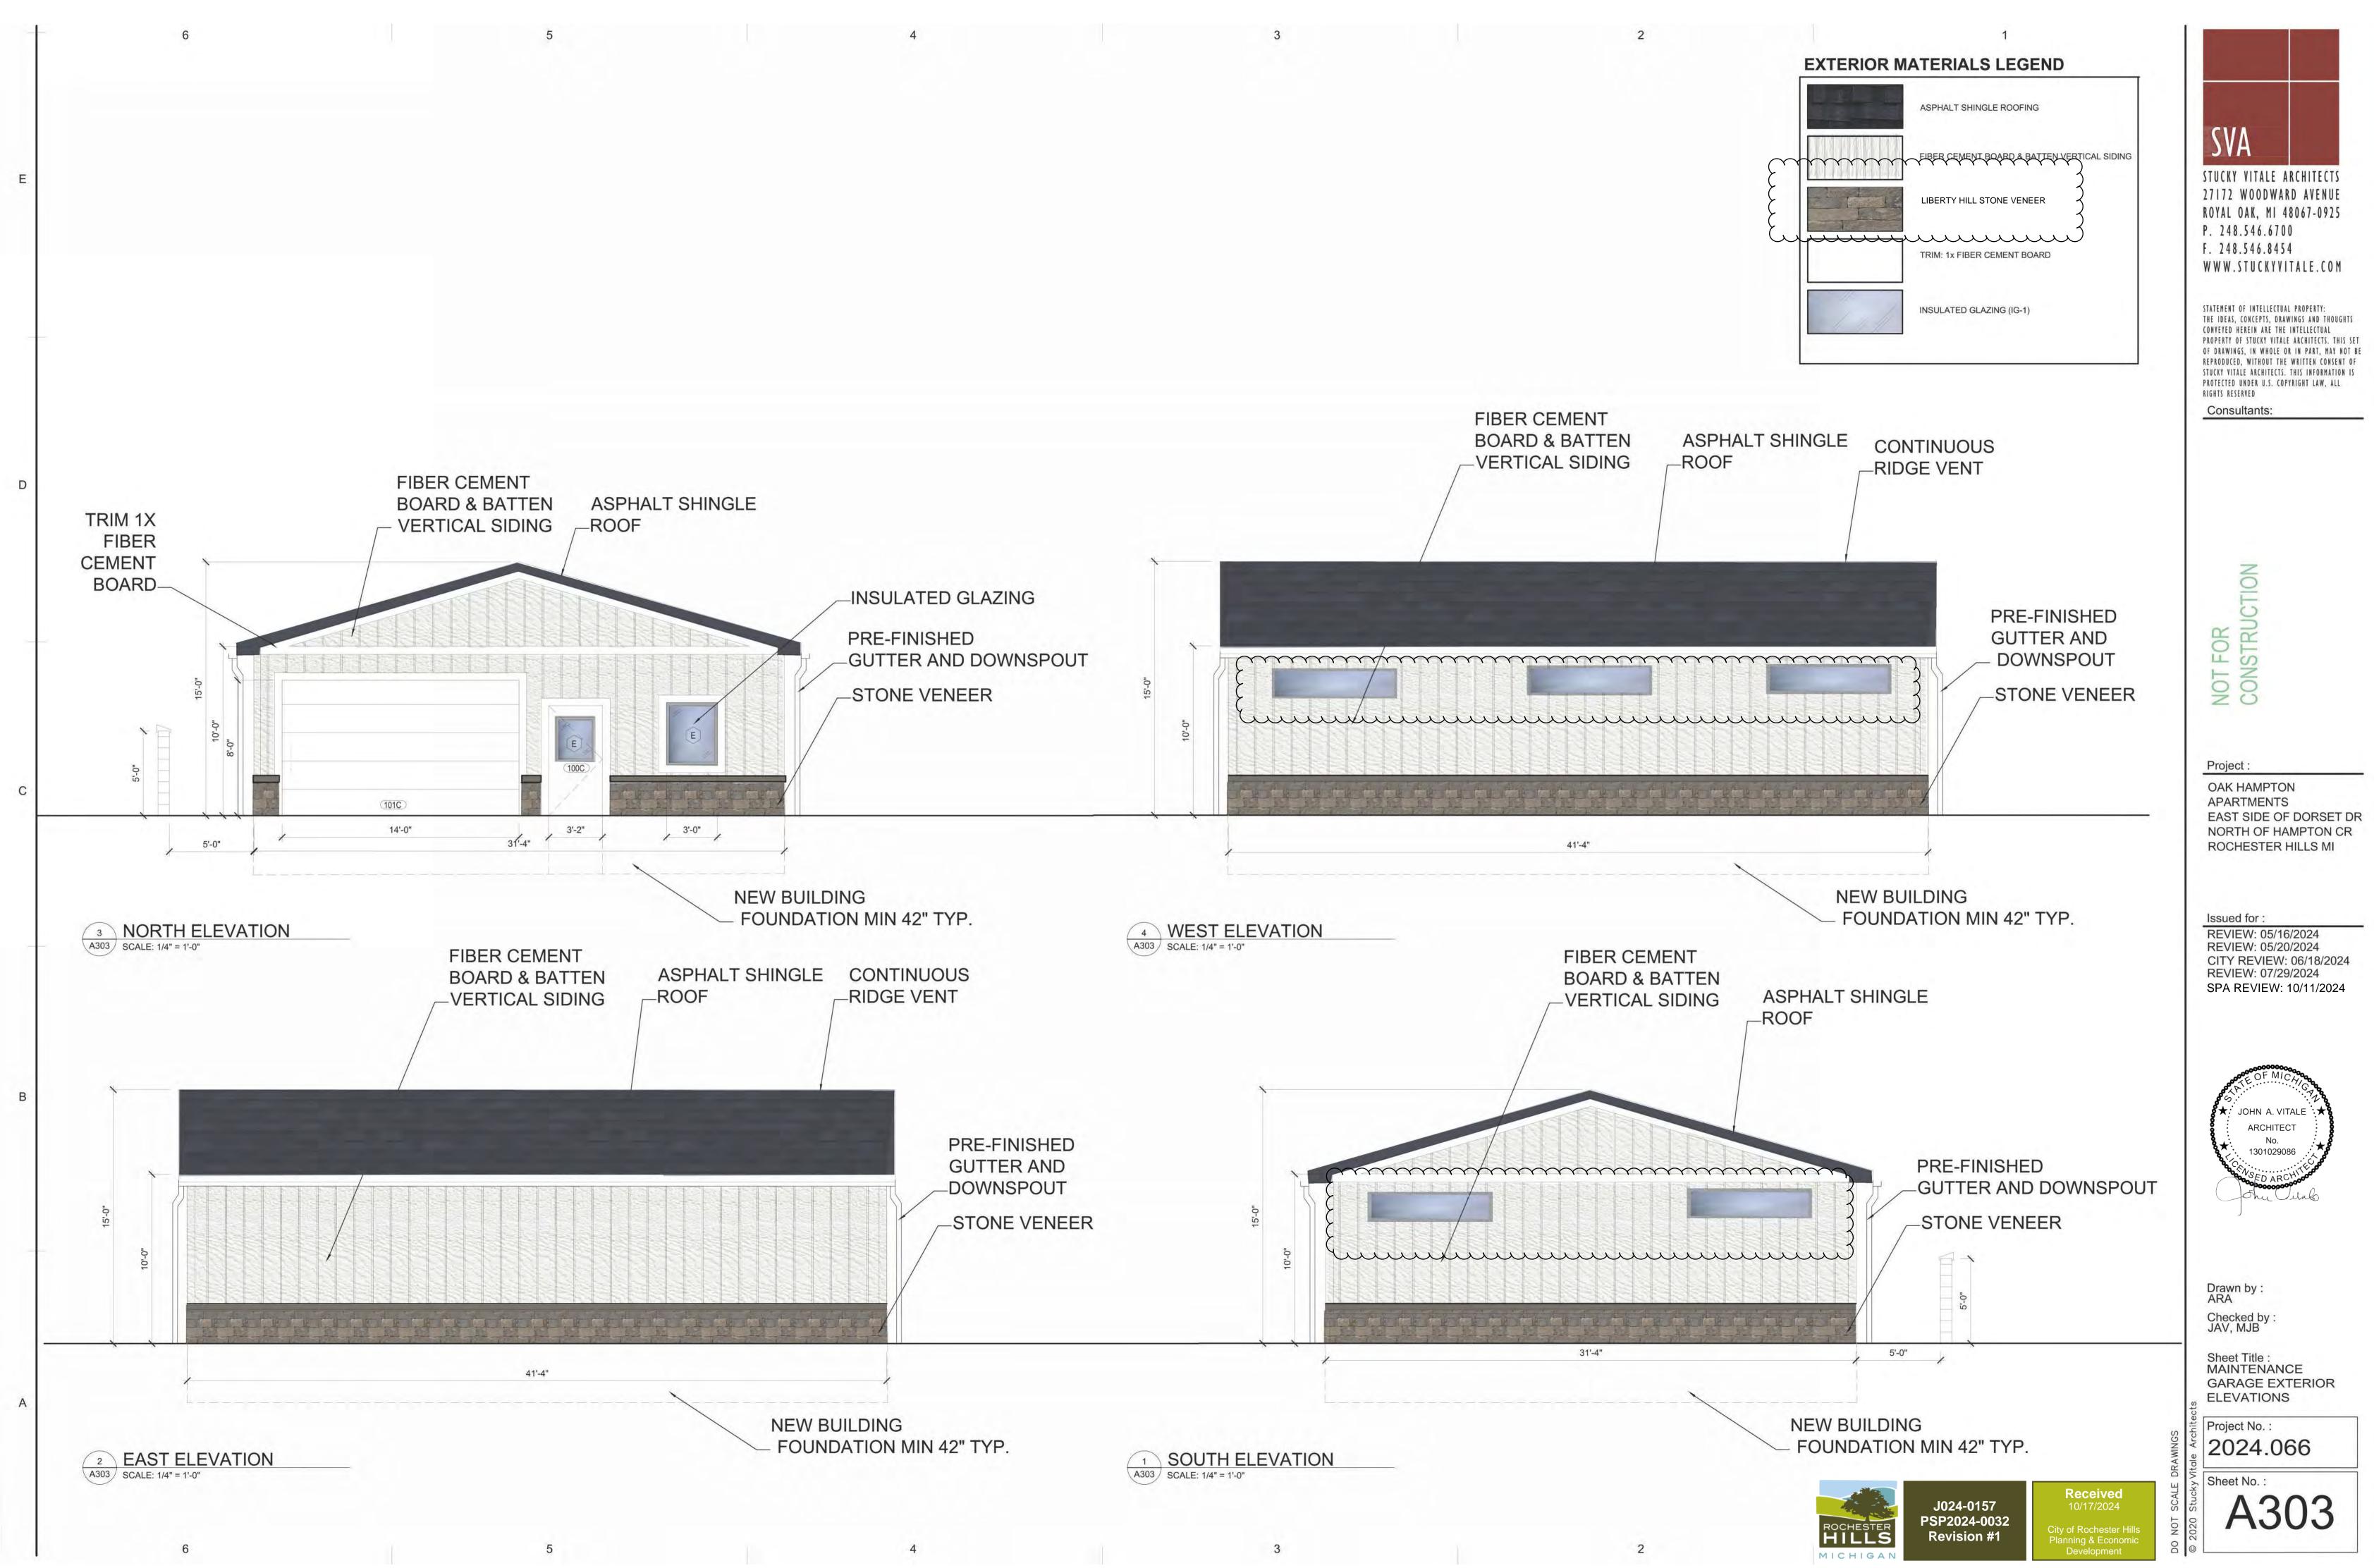

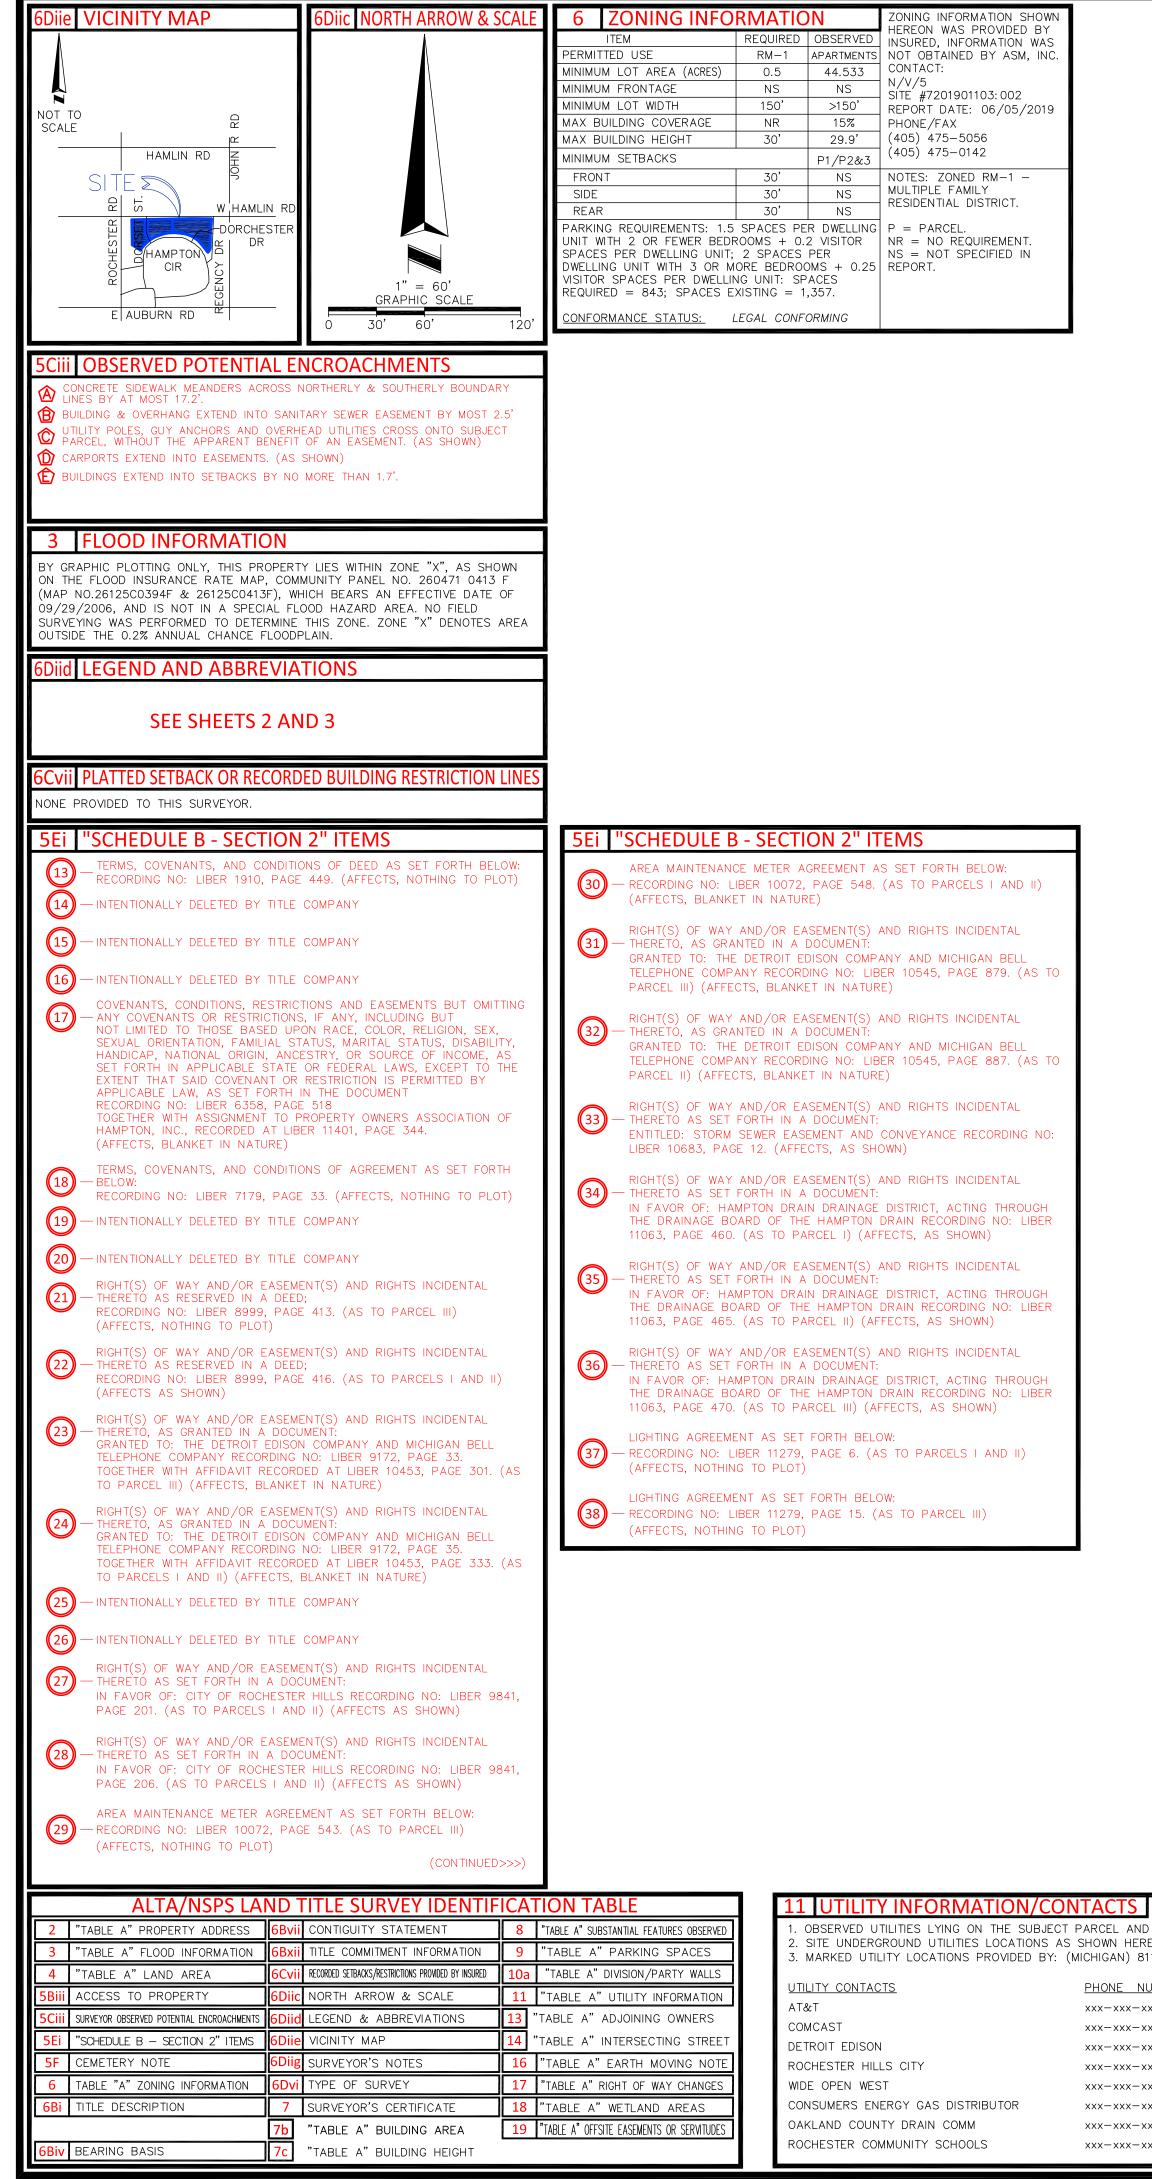

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SEE SHEETS 2 AND 3 FOR SURVEY DRAWING

OF MY KNOWLEDGE, INFORMATION, AND BELIEF. DATE REVISIONS TECH FIFLD BW SLN DRAWN BY JWN /30/19 UPDATE TITLE 9/23/19 COMMENTS/UPDATE TITLE SLN DRAWING | 1908626-AME /24/19 COMMENTS SLN

MICHIGAI

J024-0157 PSP2024-0032 Revision #1

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'HE TITLE DESCRIPTION AND SCHEDULE "B" ITEMS HEREON ARE FROM: IDELITY NATIONAL TITLE INSURANCE COMPANY, COMMITMENT NO.: A0738432 REVISION 4, AVING AN EFFECTIVE DATE OF SEPTEMBER 5, 2019.

i TITLE DESCRIPTION

ARCEL III.

AND SITUATED IN THE CITY OF ROCHESTER HILLS, COUNTY OF OAKLAND AND STATE OF MICHIGAN, DESCRIBED S FOLLOWS:

SHEET 1

OF 3

PART OF THE NORTHWEST 1/4 OF SECTION 26, TOWN 3 NORTH, RANGE 11 EAST, CITY OF ROCHESTER HILLS, AKLAND COUNTY, MICHIGAN, BEING MORE PARTICULARLY DESCRIBED AS FOLLOWS: BEGINNING AT A POINT WHICH S NORTH 88 DEG. 52' 45" EAST 658.84 FEET ALONG THE NORTH LINE OF SECTION 26 FROM THE NORTHWEST CORNER OF SECTION 26, TOWN 3 NORTH, RANGE 11 EAST; THENCE NORTH 88 DEG. 52' 45" EAST 473.29 FEET ALONG THE NORTH LINE OF SECTION 26; THENCE SOUTH 01 DEG. 07' 15" EAST 179.32 FEET; THENCE OUTHERLY 87.83 FEET ALONG A CURVE CONCAVE TO THE WEST, RADIUS OF 957.00 FEET, CENTRAL ANGLE OF 5 DEG. 15' 30", LONG CHORD BEARS SOUTH 01 DEG. 30' 30" WEST, 87.80 FEET; THENCE SOUTH 04 DEG. 08' 5" WEST, 99.66 FEET, THENCE SOUTHERLY 481.92 FEET ALONG A CURVE CONCAVE TO THE EAST RADIUS OF 73.90 FEET, CENTRAL ANGLE OF 40 DEG. 58' 24" LONG CHORD BEARS SOUTH 16 DEG. 20' 57" EAST 471.72 EET; THENCE SOUTHWESTERLY 442.93 FEET ALONG A CURVE CONCAVE TO THE SOUTHEAST, RADIUS OF 1413.0 EET, CENTRAL ANGLE OF 17 DEG. 57' 37" LONG CHORD BEARS SOUTH 42 DEG. 26' 24" WEST, 441.12 FEET; HENCE NORTH 56 DEG. 32' 25" WEST, 340.14 FEET, THENCE NORTH 01 DEG. 07' 15" WEST, 948.03 FEET TO HE POINT OF BEGINNING, EXCEPT THE NORTHERLY 60 FEET THEREOF.

PART OF THE NORTHWEST 1/4 OF SECTION 26, TOWN 3 NORTH, RANGE 11 EAST, CITY OF ROCHESTER HILLS, DAKLAND COUNTY, MICHIGAN, BEING MORE PARTICULARLY DESCRIBED AS FOLLOWS: BEGINNING AT A POINT WHICH S NORTH 88 DEG. 52' 45" EAST, 1218.13 FEET ALONG THE NORTH LINE OF SECTION 26 AND SOUTH 01 DEG. 07' 5" EAST, 60.00 FEET FROM THE NORTHWEST CORNER OF SECTION 26, TOWN 3 NORTH, RANGE 11 EAST; THENCE IORTH 88 DEG. 52' 45" EAST, 885.91 FEET ALONG A LINE PARALLEL TO AND 60.00 FEET SOUTH OF THE NORTH INE OF SECTION 26; THENCE SOUTH 01 DEG. 07' 15" EAST, 483.05 FEET, THENCE WESTERLY 567.90 FEET ALONG A CURVE CONCAVE TO THE SOUTH, RADIUS OF 1400.00 FEET CENTRAL ANGLE OF 23 DEG. 14' 30" LONG CHORD BEARS SOUTH 77 DEG. 19' 53" WEST 564.02 FEET; THENCE WESTERLY 44.52 FEET ALONG A CURVE CONCAVE TO THE NORTH RADIUS OF 201.94 FEET, CENTRAL ANGLE OF 12 DEG. 37' 54" LONG CHORD BEARS OUTH 72 DEG. 01' 35" WEST 44.43 FEET: THENCE WESTERLY 59.26 FEET ALONG A CURVE CONCAVE TO THE COUTH RADIUS OF 201.94 FEET, CENTRAL ANGLE OF 16 DEG. 48' 50", LONG CHORD BEARS SOUTH 69 DEG. 56' 7" WEST, 59.05 FEET, THENCE WESTERLY 163.27 FEET ALONG A CURVE CONCAVE TO THE SOUTH, RADIUS OF 413.00 FEET, CENTRAL ANGLE OF 06 DEG. 37' 13", LONG CHORD BEARS SOUTH 58 DEG. 13' 06" WEST, 163.18 EET, THENCE NORTHERLY 420.42 FEET ALONG A CURVE CONCAVE TO THE EAST, RADIUS OF 587.90 FEET, CENTRAL ANGLE OF 40 DEG. 58' 24", LONG CHORD BEARS NORTH 16 DEG. 20' 57" WEST, 411.52 FEET; THENCE NORTH 04 DEG. 08' 15" EAST, 99.66 FEET; THENCE NORTHERLY 95.72 FEET ALONG A CURVE CONCAVE TO THE VEST, RADIUS OF 1043.00 FEET, CENTRAL ANGLE OF 05 DEG. 15' 30", LONG CHORD BEARS NORTH 01 DEG. 30' 30" EAST, 95.69 FEET; THENCE NORTH 01 DEG. 07' 15" WEST, 119.32 FEET TO THE POINT OF BEGINNING.

PART OF THE NORTH 1/2 OF SECTION 26, TOWN 3 NORTH, RANGE 11 EAST, AVON TOWNSHIP, NOW CITY OF COCHESTER HILLS, OAKLAND COUNTY, MICHIGAN, BEING MORE PARTICULARLY DESCRIBED AS FOLLOWS: BEGINNING AT A POINT WHICH IS SOUTH 89 DEG. 28' 50" EAST 704.85 FEET ALONG THE NORTH LINE OF SECTION 26 AND SOUTH 00 DEG. 31' 10" WEST 60.00 FEET FROM THE NORTH 1/4 CORNER OF SECTION 26, TOWN 3 NORTH, ANGE 11 EAST; THENCE SOUTH 00 DEG. 31' 10" WEST 100.00 FEET; THENCE SOUTHERLY 85.50 FEET ALONG A CURVE CONCAVE TO THE WEST (RADIUS OF 570.00 FEET, CENTRAL ANGLE OF 08 DEG. 35' 40", LONG CHORD BEARS SOUTH 04 DEG. 49' 00" WEST 85.42 FEET); THENCE SOUTH 09 DEG. 06' 50" WEST 100.00 FEET; THENCE SOUTHERLY 154.50 FEET, ALONG A CURVE CONCAVE TO THE EAST (RADIUS OF 1030.00 FEET, CENTRAL ANGLE F 08 DEG. 35' 40", LONG CHORD BEARS SOUTH 04 DEG. 49' 00" WEST 154.36 FEET); THENCE SOUTH 00 DEG. 1' 10" WEST 563.79 FEET; THENCE SOUTHERLY 207.26 FEET ALONG A CURVE CONCAVE TO THE WEST (RADIUS OF 250.00 FEET, CENTRAL ANGLE OF 47 DEG. 29' 58", LONG CHORD BEARS SOUTH 24 DEG. 16' 69" WEST 201.37 FEET); THENCE NORTHWESTERLY 94.58 FEET ALONG A CURVE CONCAVE TO THE NORTHEAST (RADIUS OF 970.00 FEET, CENTRAL ANGLE OF 02 DEG. 45' 03", LONG CHORD BEARS NORTH 39 DEG. 44' 00" WEST 94.57 EET); THENCE NORTH 38 DEG. 21' 28" WEST 270.10 FEET; THENCE NORTHWESTERLY 806.37 FEET ALONG A CURVE CONCAVE TO THE SOUTHWEST (RADIUS OF 1030.00 FEET, CENTRAL ANGLE OF 44 DEG. 51' 22", LONG CHORD BEARS NORTH 60 DEG. 47' 09" WEST 785.94 FEET); THENCE NORTH 83 DEG. 12' 50" WEST 147.31 FEET; HENCE WESTERLY 191.42 FEET ALONG A CURVE CONCAVE TO THE SOUTH (RADIUS OF 1400.00 FEET, CENTRAL ANGLE OF 07 DEG. 50'02", LONG CHORD BEARS NORTH 87 DEG. 07'51" WEST 191.27 FEET); THENCE NORTH (DEG. 07' 15" WEST 483.05 FEET; THENCE, ALONG A LINE PARALLEL TO AND 60.00 FEET SOUTH OF THE NORTH INE OF SECTION 26, NORTH 88 DEG. 52' 45" EAST 681.71 FEET AND SOUTH 89 DEG. 28' 50" EAST 703.99 FEET TO THE POINT OF BEGINNING.

EASEMENT PARCEL IV: OGETHER WITH NON-EXCLUSIVE EASEMENTS SET FORTH IN DECLARATION OF RESTRICTIONS, EASEMENTS, ONDITIONS AND LIENS - RESIDENTIAL RECORDED IN LIBER 6358, PAGE 518, AND ASSIGNMENT RECORDED IN IBER 11401, PAGE 344.

HIS SURVEY DESCRIBES AND DEPICTS THE SAME LAND AS DESCRIBED IN THE TITLE COMMITMENT AS REFERENCED ABOVE.

6Diig	SURVEYOR'S NOTES			7
1. NO U	JNDERGROUND UTILITIES ARE SHOWN ON THIS SURVEY, ONLY ABOVE GROUND VISIBLE ENCE OF UTILITIES ARE SHOWN.			U I A I A I
2. ALL HERE PARK GROU	STATEMENTS WITHIN THE CERTIFICATION, AND OTHER REFERENCES LOCATED ELSEWHERE ON, RELATED TO: UTILITIES, IMPROVEMENTS, STRUCTURES, BUILDINGS, PARTY WALLS, KING, EASEMENTS, SERVITUDES, AND ENCROACHMENTS ARE BASED SOLELY ON ABOVE JND, VISIBLE EVIDENCE, UNLESS ANOTHER SOURCE OF INFORMATION IS SPECIFICALLY RENCED HEREON.		S) HILLS. MICHIGAN
3. THIS FORT 4. NO (SURVEY MEETS OR EXCEEDS THE SURVEY STANDARDS/STANDARDS OF CARE AS SET H IN SECTION 3 OF THE 2011 ALTA/ACSM SURVEY REQUIREMENTS. GOVERNMENTAL AGENCY REQUIREMENTS HAVE BEEN FURNISHED TO THE UNDERSIGNED AT TIME OF THE SURVEY, FOR THE SUBJECT PARCEL.	SURVEY	RTMENT	DORCHESTER RD ROCHESTER HILLS N
4	LAND AREA 1,939,834± SQUARE FEET 44.533± ACRES		PA	Ш Ц Ц Ц
	BEARING BASIS	ΙĒ		ST ST
	NGS SHOWN HEREON ARE BASED ON THE SOUTH RIGHT OF WAY LINE OF N ROAD, WHICH BEARS N88*52'45"E.	LAND TITLE	OF	CHE
5F	CEMETERY NOTE		μ	R
	IS NO VISIBLE EVIDENCE OF CEMETERIES ON SUBJECT PROPERTY.	SP	⊈	ă
9	PARKING SPACES	Z	ΪĒ	43
	AR = 791 DRT = 550 HANDICAP = 16 TOTAL = 1357	ALTA/NSPS	A S	ů F
5Biii	ACCESS TO PROPERTY	AI		
	UBJECT PROPERTY HAS DIRECT PHYSICAL ACCESS TO REGENCY DRIVE, HAMPTON E AND DORSET DRIVE, ALL A DEDICATED PUBLIC STREET OR HIGHWAY.		OAKS AT H	DAKLAND COI
16	EARTH MOVING NOTE			AN
	IS NO OBSERVABLE EVIDENCE OF EARTH MOVING WORK, BUILDING CONSTRUCTION JILDING ADDITIONS WITHIN RECENT MONTHS.	6Dvi		AKL
6Bvii	CONTIGUITY STATEMENT	6	2	C
	ARCELS CONTAINED IN THE LEGAL DESCRIPTION ARE NOT CONTIGUOUS AND MAY AIN GAPS, GORES OR OVERLAPS.			
7	SURVEYOR'S CERTIFICATE		ZUU)
COMPA CORPC APPEA OWNER DELAW LIABILI ROCHE 7, LLC	RACH EICHLER L.L.C.; AERC OAKS HAMPTON, LLC, A DELAWARE LIMITED LIABILITY ANY; M&T REALTY CAPITAL CORPORATION AND/OR FEDERAL HOME LOAN MORTGAGE DRATION, ITS SUCCESSORS AND/OR ASSIGNS AS THEIR RESPECTIVE INTERESTS MAY R; ROCHESTER OWNER 1, LLC, A DELAWARE LIMITED LIABILITY COMPANY; ROCHESTER R 2, LLC, A DELAWARE 1, MITED LIABILITY COMPANY; ROCHESTER OWNER 3, LLC, A VARE LIMITED LIABILITY COMPANY; ROCHESTER OWNER 4, LLC, A DELAWARE LIMITED TY COMPANY; ROCHESTER OWNER 5, LLC, A DELAWARE LIMITED LIABILITY COMPANY; STER OWNER 6, LLC, A DELAWARE LIMITED LIABILITY COMPANY; A DELAWARE LIMITED LIABILITY COMPANY AS TENANTS IN COMMON; FIDELITY NAL TITLE INSURANCE COMPANY:), FLORIDA 32803
WERE FOR A AND N 16, AN THE F	S TO CERTIFY THAT THIS MAP OR PLAT AND THE SURVEY ON WHICH IT IS BASED MADE IN ACCORDANCE WITH THE 2016 MINIMUM STANDARD DETAIL REQUIREMENTS ALTA/NSPS LAND TITLE SURVEYS, JOINTLY ESTABLISHED AND ADOPTED BY ALTA ISPS, AND INCLUDES ITEMS 1, 2, 3, 4, 6(a), 6(b), 7(a), 8, 9, 11(DIG TICKET), 13, ND 20 OF TABLE A THEREOF. IELD WORK WAS COMPLETED ON 05/28/2019. OF PLAT OR MAP: 05/31/2019.			200 ORLANDO,
	Bayldilli 10/1/19		S () of	SUITE
STATE	BARRY L. WILLIS DATE SSIONAL LAND SURVEYOR NO: 36002 OF: MICHIGAN CCT NO: 1908626–22512			IIRE BLVD.,
AMERI 3191 I ORLAN	EY PREPARED BY: CAN SURVEYING & MAPPING, INC. MAGUIRE BLVD., SUITE 200 NDO, FL 32803 FICATE OF AUTHORIZATION # 60625Y			3191 MAGUIF
PHONE	E: (407) 426–7979 (407) 426–9741 THIS DOCUMENT SHOULD BE CONSIDERED INVALID WITHOUT			7

NFO@ASMCORPORATE.COM A LICENSED SURVEYOR'S SIGNATURE AND SEAL.

SUBSTANTIAL FEATURES OBSERVED

SUBSTANTIAL ABOVE GROUND FEATURES THAT WERE OBSERVED ON THE SUBJECT PARCEL, SUCH AS PARKING AREAS, DRIVES, WALKS, PLANTERS/LANDSCAPE AREAS AND OTHER, HAVE BEEN LOCATED AS SHOWN HEREON. NOTE: THERE WERE NO OBSERVED SUBSTANTIAL AREAS OF REFUSE ON THE SUBJECT PARCEL PER THE DATE OF THIS SURVEY.

Received


City of Rochester H


Planning & Econor

ALL PARTS OF THIS SURVEY AND DRAWING HAVE BEEN COMPLETED IN ACCORDANCE WITH THE CURRENT REQUIREMENTS FOR SURVEYING IN THE STATE OF MICHIGAN TO THE BEST

	DRAWING SCALE	1"= 60'					
	QC BY	DK 06/03/19					
22512 ROCHESTER HILLS MI.DWG							

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Reviewed Site Plan 11062024.pdf Markup Summary

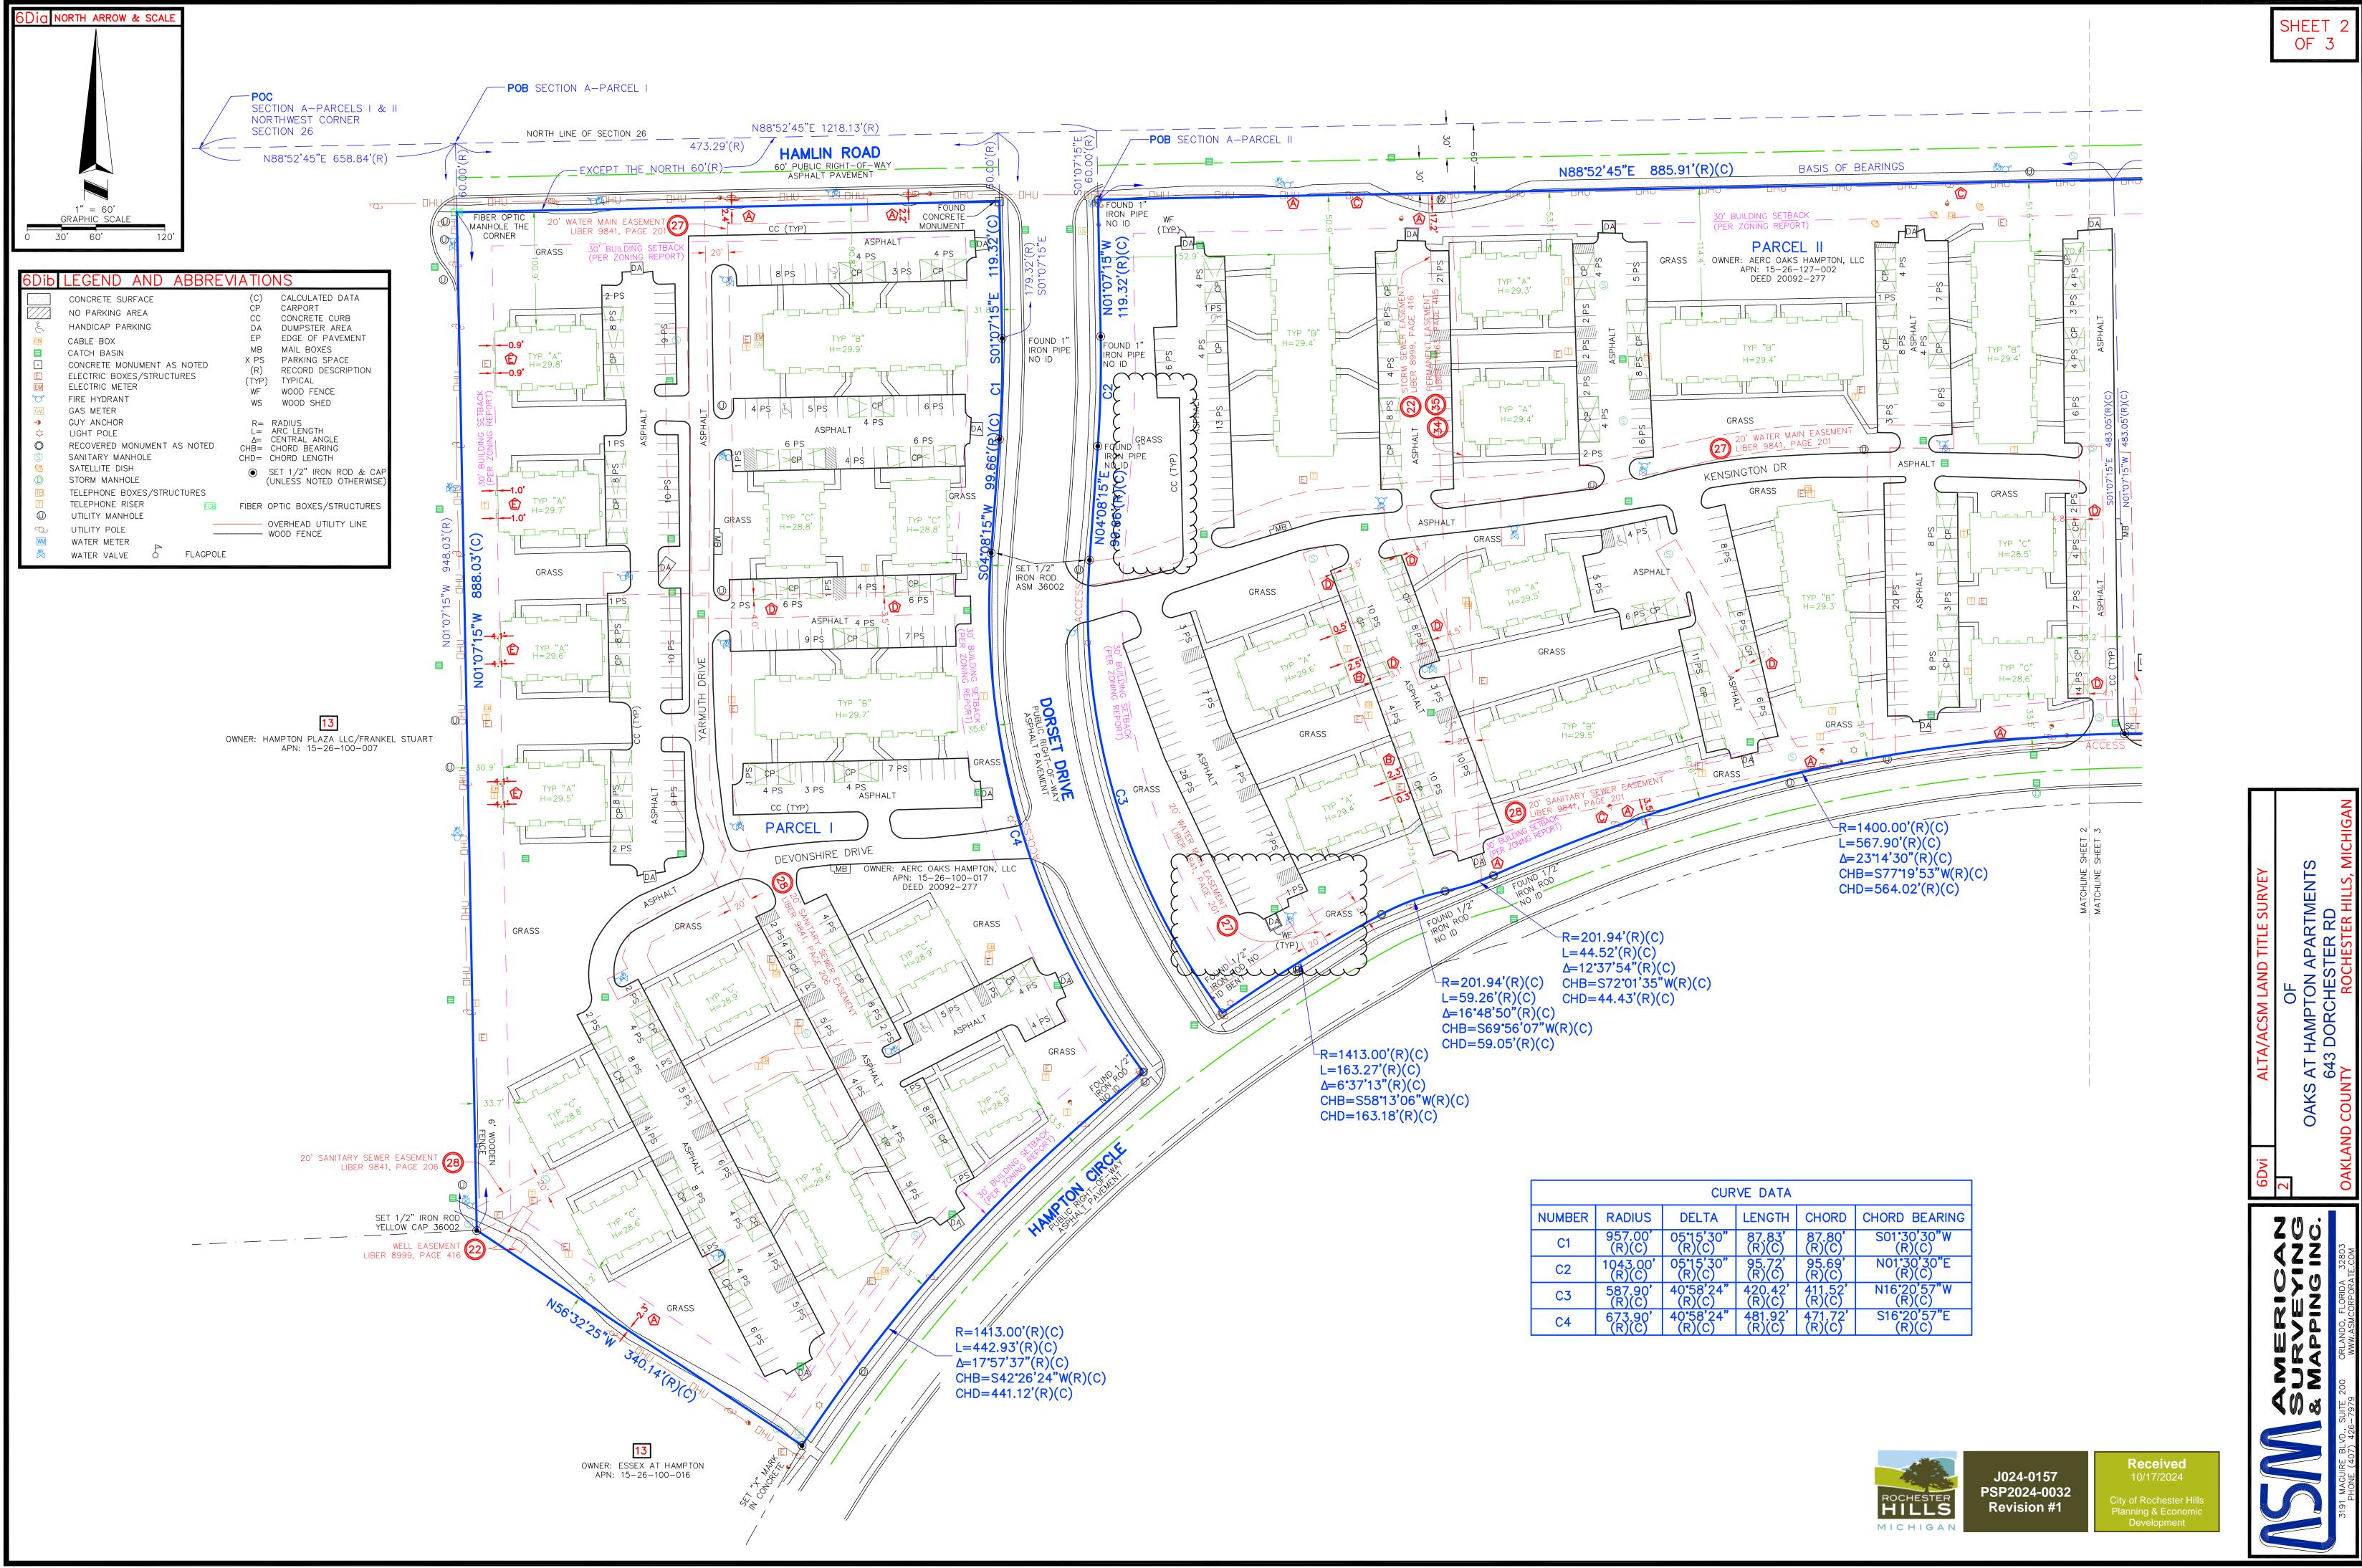Building Department (4) Subject: Building Department Accessible parking spaces must be 11' wide by 18' Author: J Rhoades long. Date: 11/4/2024 7:33:25 AM Status: -----..... Subject: Building Department Which use group is being applied to which Author: J Rhoades building? The garage cannot be considered a U Date: 11/4/2024 7:47:20 AM use group. Status: . Subject: Building Department Jason Rhoades 248-841-2436 Author: J Rhoades RhoadesJa@RochesterHills.org Date: 11/4/2024 8:58:56 AM Status: Subject: Building Department Yes with conditions Author: J Rhoades Date: 11/4/2024 8:58:52 AM Status: Engineering Department (3) Subject: Engineering Department Author: Jason Boughton Date: 10/24/2024 7:20:32 AM Status: Subject: Engineering Department The applicant will need to submit a Land Author: Jason Boughton Improvement Permit (LIP) application with Date: 10/24/2024 7:20:52 AM engineer's estimate, fee and construction plans to Status: proceed with the construction plan review process. -----..... Subject: Engineering Department City File #24-0157 Section #26 in the lower right Author: Jason Boughton hand corner of each sheet Date: 10/24/2024 7:21:18 AM Status:

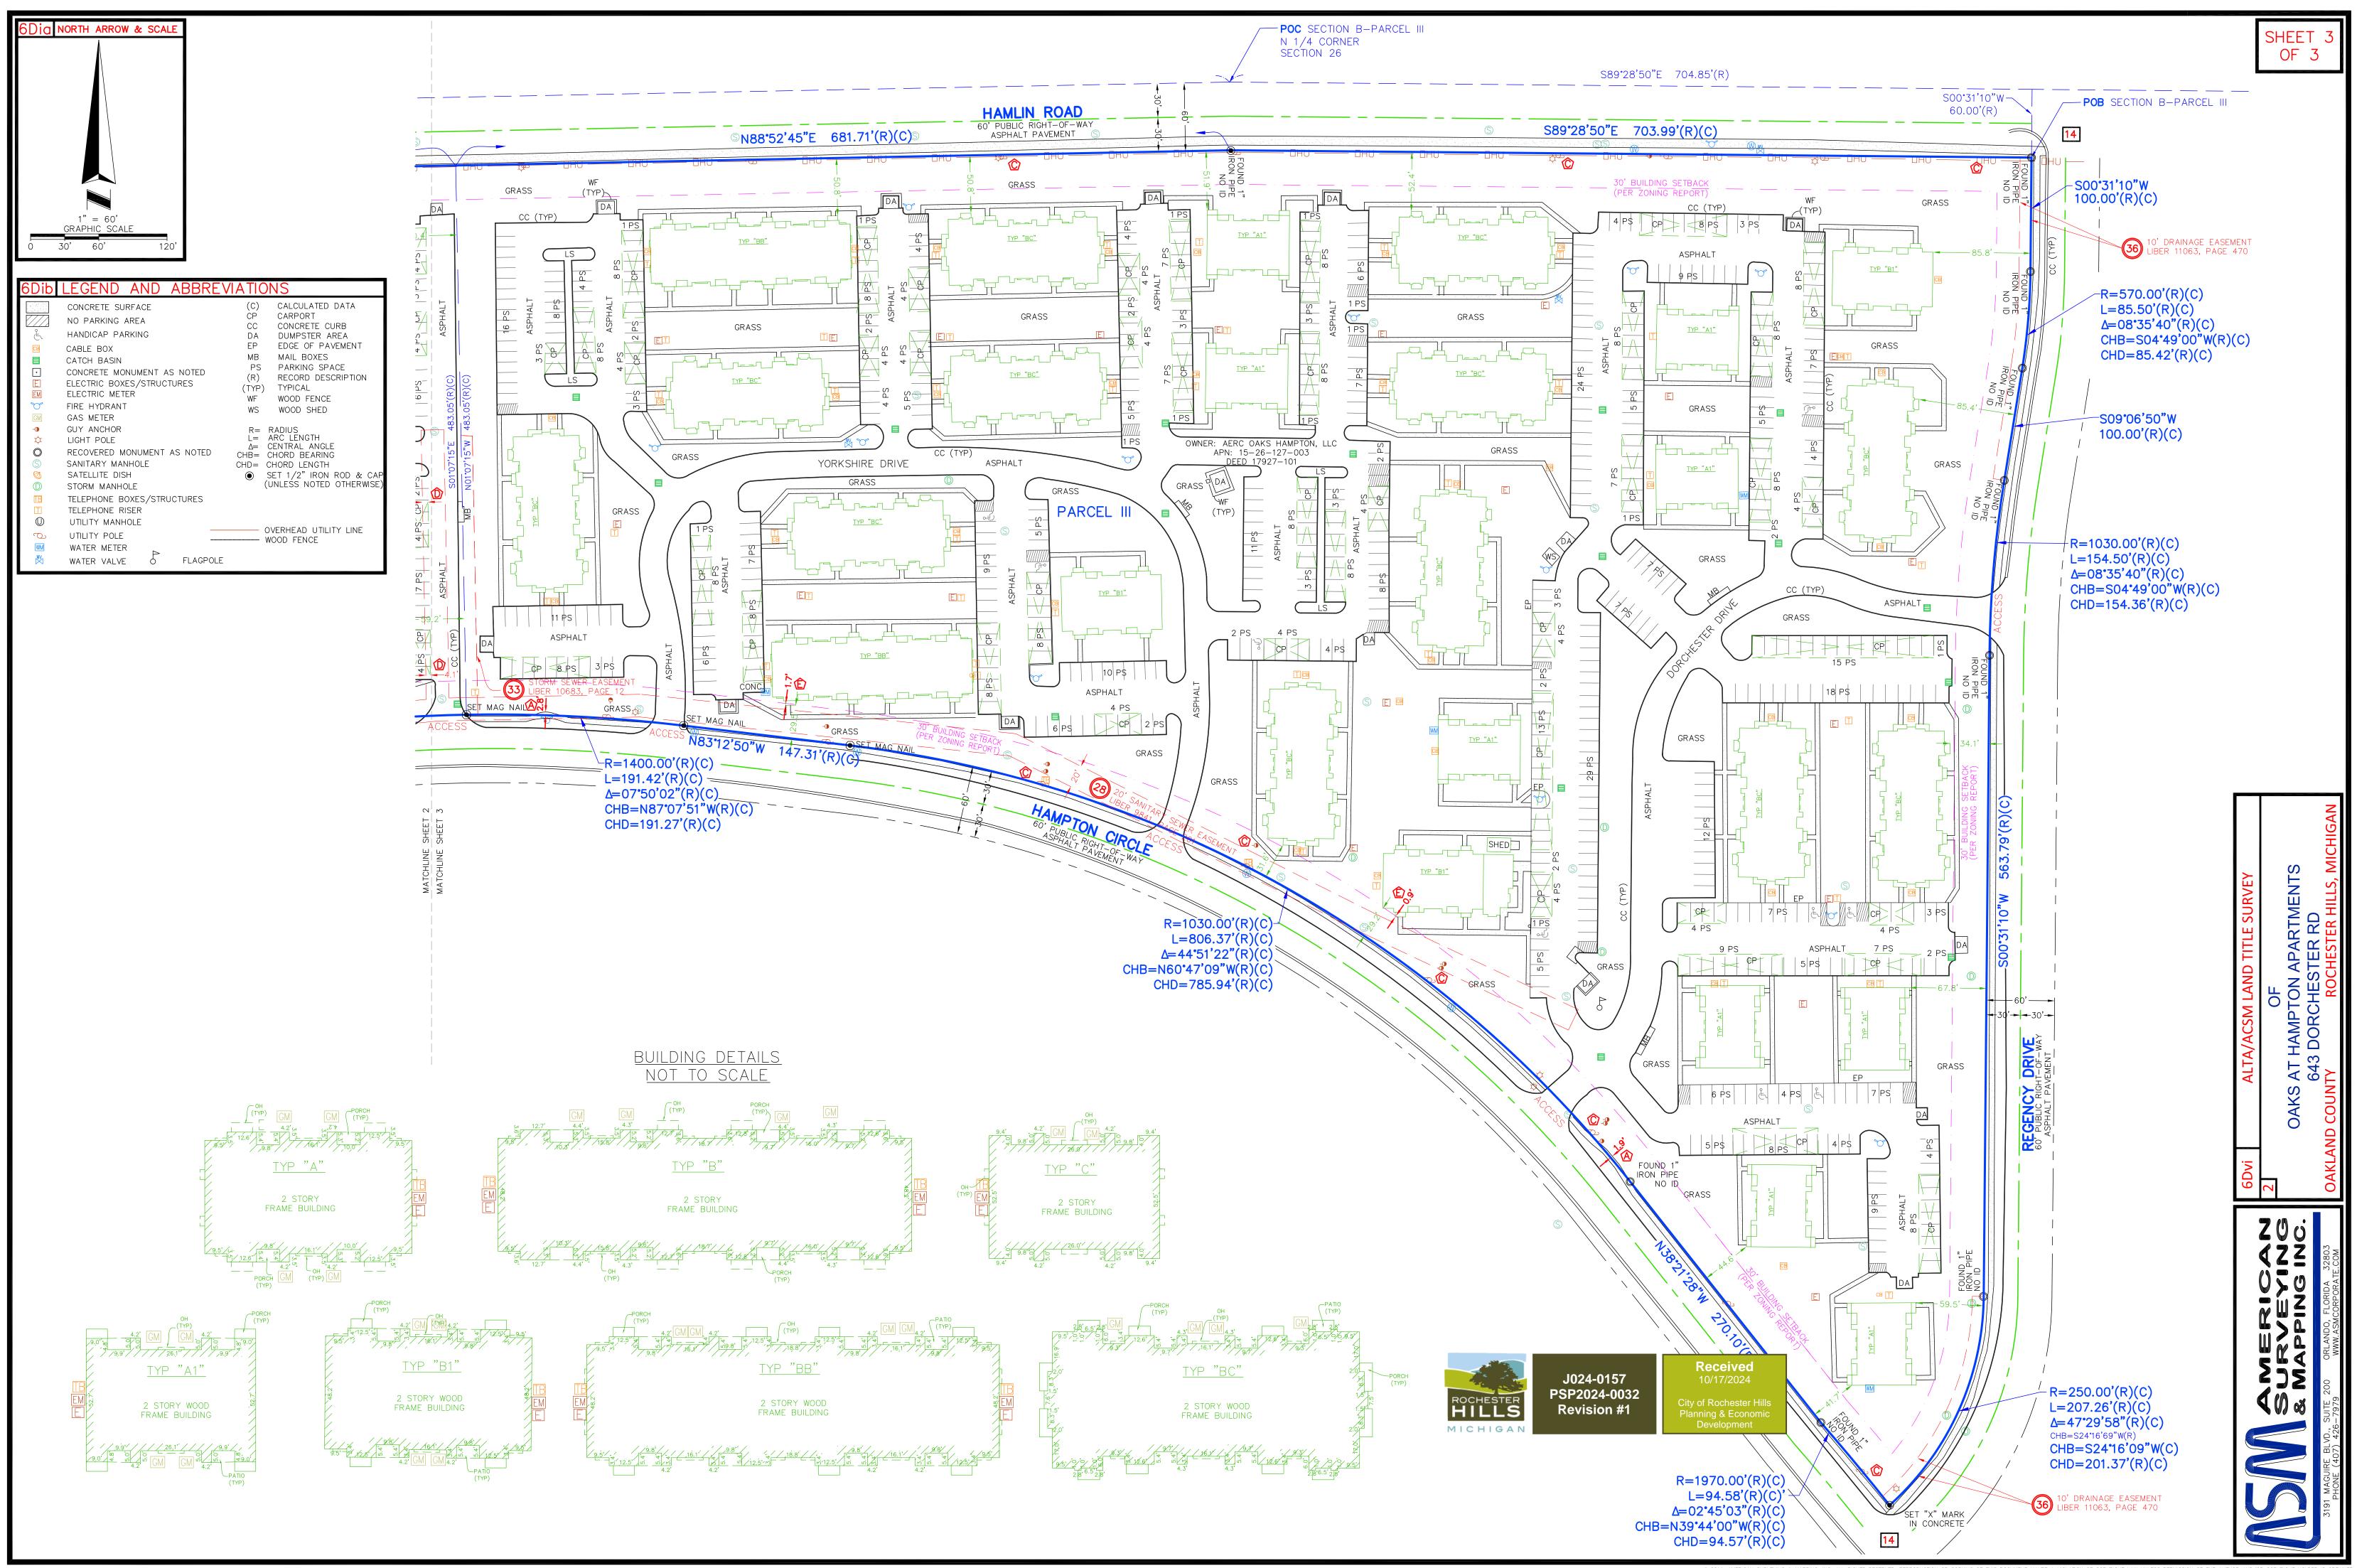Engineering Legal Review (3)



Subject: Engineering Legal Review Author: Seth Bucholz Date: 10/29/2024 8:23:14 AM Status:



Subject: Engineering Legal Review Author: Seth Bucholz Date: 10/29/2024 8:23:49 AM Status:

For easements, please include the Liber & Page number of it.

Lots lines require meets and bounds/dimensions



Subject: Engineering Legal Review Author: Seth Bucholz Date: 10/29/2024 3:05:38 PM Status:

Fire Department (2)



Subject: Fire Department Author: Jon Mills Date: 10/22/2024 4:03:41 PM Status:

20'-0"

.



Subject: Fire Department Author: Jon Mills Date: 10/28/2024 9:30:52 AM Status:

Group (20)



Subject: Group Author: macdonaldj Date: 10/22/2024 3:10:14 PM Status:



Subject: Group Author: C.McLeod Date: 11/5/2024 10:41:56 AM Status:

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Subject: Group Author: C.McLeod Date: 11/5/2024 10:42:07 AM Status:



Subject: Group Author: C.McLeod Date: 11/5/2024 10:42:20 AM Status:



Subject: Group Author: C.McLeod Date: 11/5/2024 10:42:38 AM Status:



Subject: Group Author: C.McLeod Date: 11/5/2024 10:42:48 AM Status:

.....



Subject: Group Author: C.McLeod Date: 11/5/2024 10:42:59 AM Status: City of Rochester Hills Planning & Economic Development

As long as additional comments are addressed.

Received 10/17/2024

City of Rochester Hills Planning & Economic Development

Received 10/17/2024

City of Rochester Hills Planning & Economic Development

Received 10/17/2024

City of Rochester Hills Planning & Economic Development

Received 10/17/2024

City of Rochester Hills Planning & Economic Development

Received 10/17/2024

City of Rochester Hills Planning & Economic Development

Received 10/17/2024

City of Rochester Hills Planning & Economic Development

Activity Parameters	Subject: Group Author: C.McLeod Date: 11/5/2024 10:43:07 AM Status:	Received 10/17/2024 City of Rochester Hills Planning & Economic Development
Annual Annual Report	Subject: Group Author: C.McLeod Date: 11/5/2024 10:43:16 AM Status:	Received 10/17/2024 City of Rochester Hills Planning & Economic Development
	Subject: Group Author: C.McLeod Date: 11/5/2024 10:43:23 AM Status:	Received 10/17/2024 City of Rochester Hills Planning & Economic Development
	Subject: Group Author: C.McLeod Date: 11/5/2024 10:43:31 AM Status:	Received 10/17/2024 City of Rochester Hills Planning & Economic Development
Address Addres	Subject: Group Author: C.McLeod Date: 11/5/2024 10:43:39 AM Status:	Received 10/17/2024 City of Rochester Hills Planning & Economic Development
NITE BUCONS FOLGATION NUCT THE FOLGATION NUCT THE FOLGATION NUCL THE F	Subject: Group Author: C.McLeod Date: 11/5/2024 10:43:47 AM Status:	Received 10/17/2024 City of Rochester Hills Planning & Economic Development
	Subject: Group Author: C.McLeod Date: 11/5/2024 10:43:57 AM Status:	Received 10/17/2024 City of Rochester Hills Planning & Economic Development
	Subject: Group Author: C.McLeod Date: 11/5/2024 10:44:07 AM Status:	Received 10/17/2024 City of Rochester Hills Planning & Economic Development
e e e e e e e e e e e e e e e e e e e	Subject: Group Author: C.McLeod Date: 11/5/2024 10:44:20 AM Status:	Received 10/17/2024 City of Rochester Hills Planning & Economic Development
	Subject: Group Author: mcleodc Date: 11/5/2024 10:59:34 AM Status:	SP



Subject: Group Author: mcleodc Date: 11/5/2024 10:59:43 AM Status:

.

BP



Subject: Group Author: mcleodc Date: 11/5/2024 10:59:51 AM Status:

LIP



Subject: Group Author: mcleodc Date: 11/5/2024 11:00:07 AM Status:

Highlight (5)



Subject: Highlight Author: Jon Mills Date: 10/22/2024 4:04:34 PM Status:



Subject: Highlight Author: Jon Mills Date: 10/22/2024 4:04:51 PM Status:

NEW WORK: LEASING CENTER TOTAL PROJECT AREA TYPE OF CONSTRUCTI USE GROUP:

Subject: Highlight Author: J Rhoades Date: 11/4/2024 7:35:43 AM Status:

Status:

PROJECT AREA: NEW WORK: LEASING CENTER TOTAL PROJECT AREA

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PROJECT AREA: NEW WORK:

MAINTENANCE GARAGE TOTAL PROJECT AREA

SITE AREA OF WORK:

Subject: Highlight Author: J Rhoades Date: 11/4/2024 7:35:58 AM Status:

Date: 11/4/2024 7:36:12 AM

LEASING CENTER

MAINTENANCE GARAGE

MAINTENANCE GARAG Subject: Highlight Author: J Rhoades

MAINTENANCE GARAGE

Jenny McGuckin - YES (1)




Subject: Jenny McGuckin - YES Author: Seth Bucholz Date: 10/29/2024 3:05:08 PM Status:

Natural Resouces (1)



Subject: Natural Resouces Author: Matt Einheuser Date: 10/28/2024 11:45:29 AM Status:

Planning Department (7)

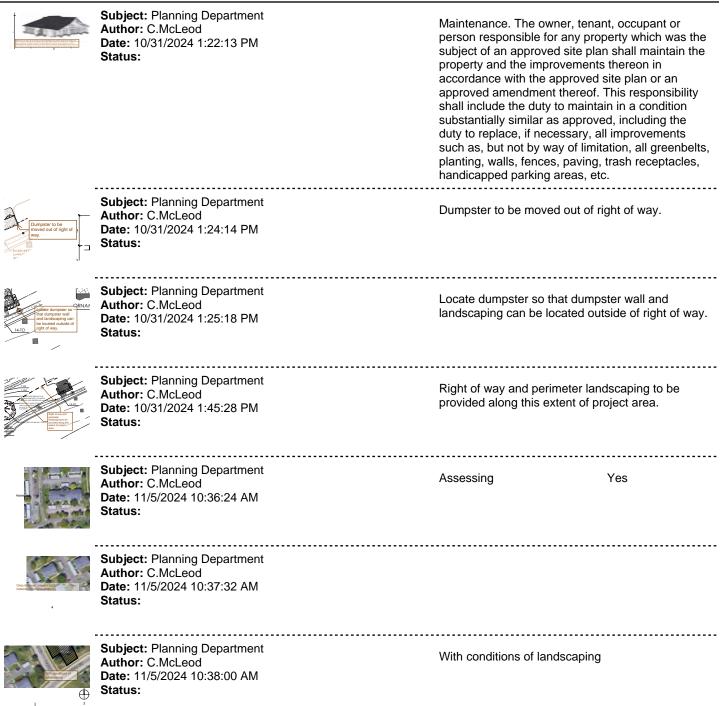

Traffic (1)



Subject: Traffic Author: Keith Date: 10/28/2024 2:38:18 PM Status:

Traffic, Pathways, Sidewalks (1)



Subject: Traffic, Pathways, Sidewalks Author: Keith Date: 10/28/2024 2:37:37 PM Status:

Underground Utilities (1)



Subject: Underground Utilities Author: Jason Boughton Date: 10/24/2024 7:23:33 AM Status: Trees within the pathway sight lines shall be limbed up 10 foot from ground surface.

The WRC letter states that the construction plans will need to be submitted to their office for a drain review for a possible drain permit. The storm sewer design improvements will be determined by the WRC with that review.