


FLOOR PLAN

ENLARGED FLOOR PLAN

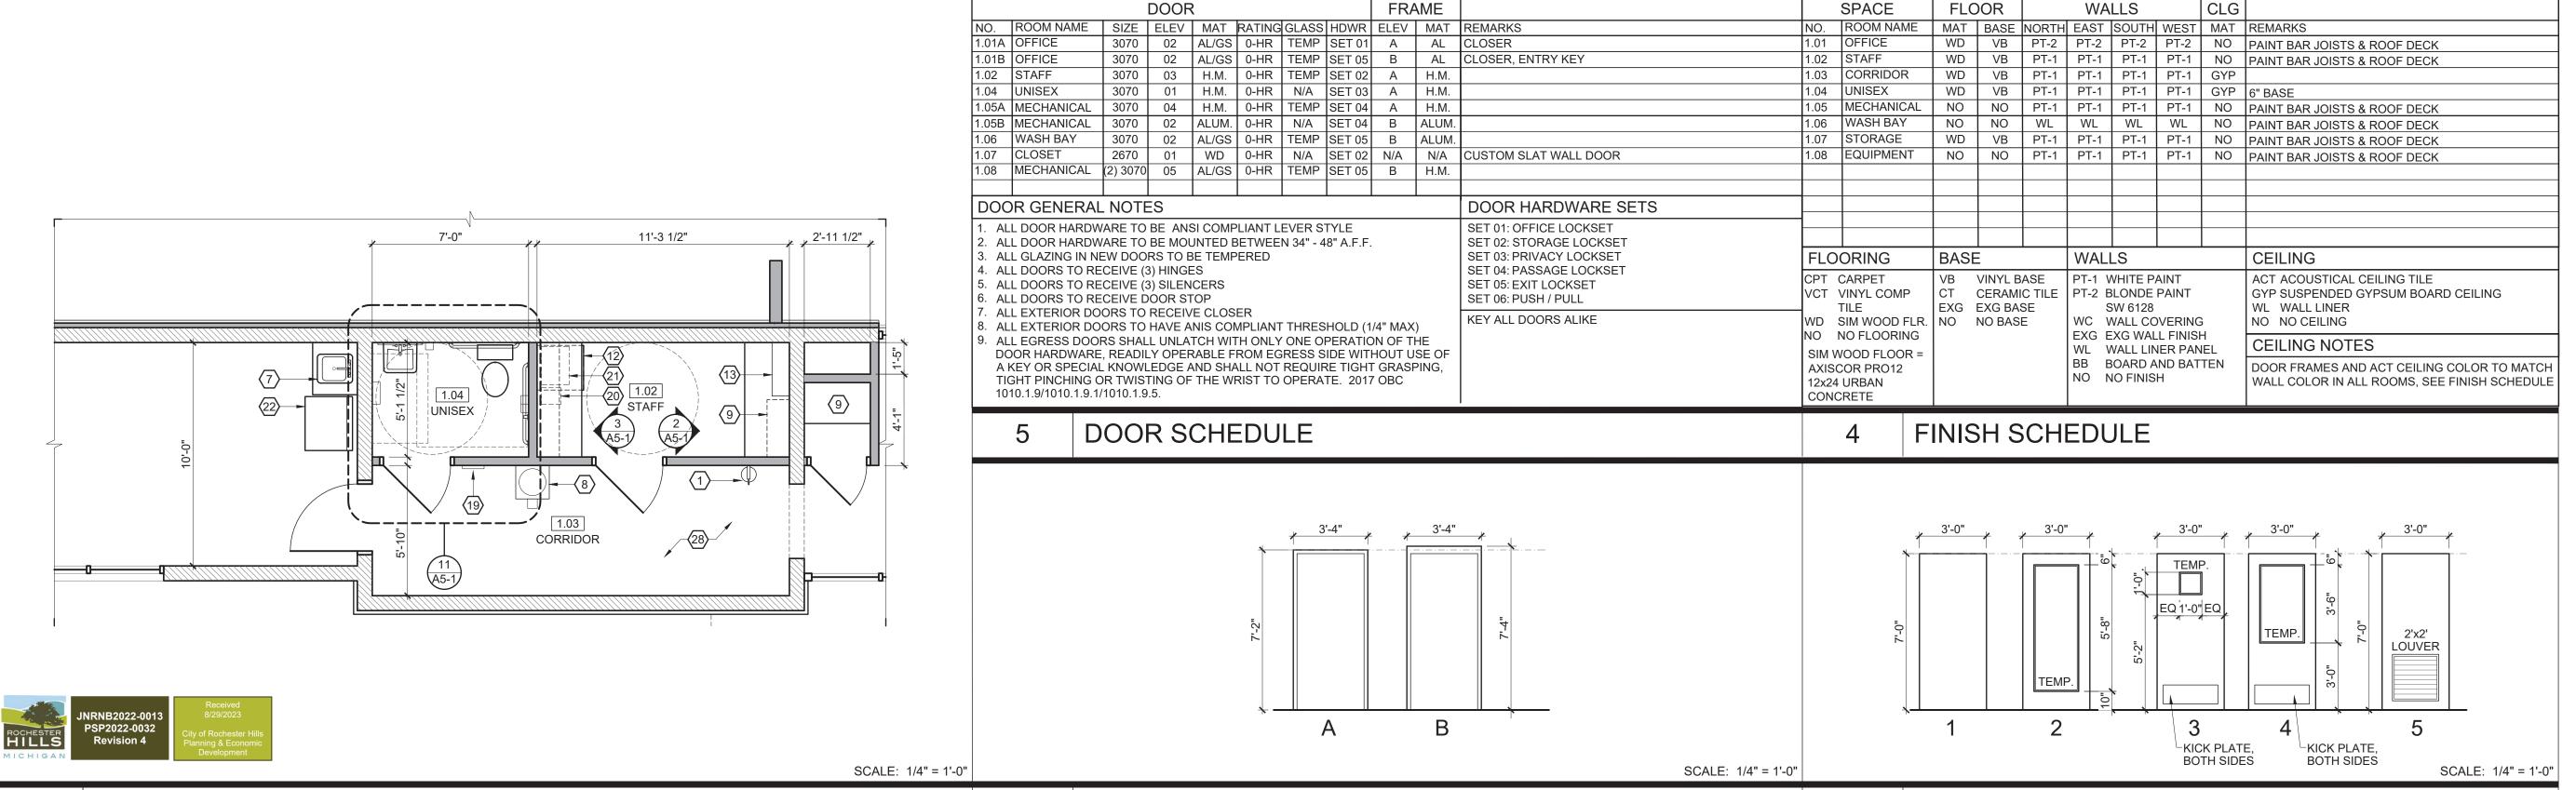

FLOOR PLAN CODED NOTES

1. WALL MOUNTED FIRE EXTINGUISHER. EXTINGUISHER TO BE:

RED ENEMELED FINISH HEAVY DUTY STEEL CYLINDER. UL AND FM APPROVED. ABC MULTI PURPOSE DRY CHEMICAL, 10 LB CAPACITY UL RATED 4A 60B: C, HOSE TYPE, UPRIGHT, SQUEEZE

6. DECORATIVE AWNING W/ BRACKETS, CENTER OVER WINDOWS /

2. INTERIOR WALL LINER PANEL

GRIP OPERATION

3. 14'-0" x 8'-0" OVERHEAD DOOR

4. 10'-0" x 8'-0" OVERHEAD DOOR 5. CAR WASH TRENCH, SEE MANUFACTURER'S DRAWINGS

DEDICATED COMMERCIAL GRADE SINK FOR UTILITY SINK

8. ANSI COMPLIANT BOTTLED WATER COOLER WITH CUP

DISPENSER

9. 12" DEEP SHELVING W/ STANDARDS AND BRACKETS 10. WIND WALL, P.T. 2x6 WALL W/ 7/16" OSB SHEATHING & LINER

PANEL BOTH SIDES 11. NOT USED

12. UNDER COUNTER REFRIGERATOR 13. SERVER RACK, SEE SHEET A5-1

14. DOWNSPOUT

15. ALUMINUM STOREFRONT SYSTEM, WINDOW HEAD HEIGHT = 8'-0",

SEE ELEVATION 13/A5-1, PROVIDE 1" INSULATED GLASS

17. RECEPTIONIST DESK BY OTHERS. ANSI COMPLIANCE IS THE

RESPONSIBILITY OF THE DESK DESIGNER 18. PROVIDE 2 1/2" METAL Z-FURRING STRIPS @ 24" HORIZONTAL

W/ MIN R-13 RIGID INSULATION IN FURRING CAVITIES W/ 5 MIL

VAPOR BARRIER 19. ANSI COMPLIANT SIGNAGE DESIGNATING UNISEX TOILET ROOM

20. COFFEE MAKER, SEE INTERIOR ELEVATION 21. MICROWAVE, SEE INTERIOR ELEVATION 22. STACKABLE WASHER / DRYER

23. ANSI COMPLIANT SIGNAGE DESIGNATING MAXIMUM OCCUPANCY OF 15 PERSONS

24. QUIK-BRIK MASONRY CONSTRUCTION 25. ANSI COMPLIANT EXIT SIGNAGE, SEE 9/A5-1

26. STORAGE CABINETRY, SEE INTERIOR ELEVATION ON SHEET A5-1

27. 10'-0" x 8'-0" OVERHEAD DOOR 28. HVAC PLATFORM ABOVE, SEE DETAILS ON SHEET A1-3

29. 8" CMU WALL

STRUCTURAL CODED NOTES

A. #5 VERTICAL EACH CELL

B. W8x28 W/ 5/16" PLATE, FASTEN TO WALL PER DETAIL 7/A4-2

C. (2) L5x3-1/2x5/16 LLV D. PROVIDE HORZ. JOINT REINF. @ EACH COURSE IN END WALL

F. PROVIDE HORIZONTAL JOINT REINFORCING @ EACH COURSE IN 18'-4" TALL WALLS

E. (2) #5 VERT. TYP. @ ALL MASONRY OPENINGS

G. #5 @ CORNERS AND 16" O.C. MAX @ END WALL

H. PROVIDE #5 VERT. @ 48" O.C. IN WALL ABOVE OPENINGS NOT USED

. W8x24 W/ 5/16" PLATE

K. W16x31 W/ 5/16" PLATE, FASTEN TO WALL PER DETAIL 7/A4-2 W8x28 LINTEL W/ 5/16" PLATE


M. PROVIDE #5 @ 48" O.C. VERT. & HORIZONTAL JOINT REINFORCING

PER PLAN NOTES FOR ENTIRE WALL, TYP. N. (2) L3 1/2x3 1/2x5/16

P. W12x30 W/ 5/16" PLATE

WALL TYPES SCHEDULE


	#	ASSEMBLY DESCRIPTION	HR	NOTES			
	3A	2x4 WOOD STUDS @ 16" O.C. 5/8" GYP BD	RATING: 0 HR UL FILE # N/A	FULL HEIGHT PARTITION, TERMINATE GYPSUM BOARD @ UNDERSIDE OF JOISTS. ASSEMBLY THICKNESS = 4 3/4"			
	3B	2x4 WOOD STUDS @ 16" O.C. -5/8" GYP BD -3" SOUND BATT	RATING: 0 HR UL FILE # N/A	FULL HEIGHT PARTITION, TERMINATE GYPSUM BOARD @ UNDERSIDE OF JOISTS. ASSEMBLY THICKNESS = 4 3/4"			
•	3C	2x4 WOOD STUDS @ 16" O.C. -5/8" GYP BD -3" SOUND BATT	RATING: 0 HR UL FILE # N/A	FULL HEIGHT PARTITION, TERMINATE GYPSUM BOARD @ BOTTOM OF DECK. ASSEMBLY THICKNESS = 4 3/4"			

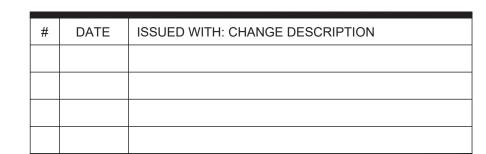

10 E. AUBURN ROAD ROCHESTER HILLS, MI 48307





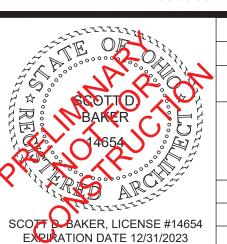


SCALE: 3/16" = 1'-0" (U.N.O.) SHEET # / DESCRIPTION FLOOR PLAN

DATE: 08.28.2023 PRELIMINARY DESIGN SBA STUDIOS PROJECT # 2023-166


FRAME ELEVATIONS

DOOR ELEVATIONS

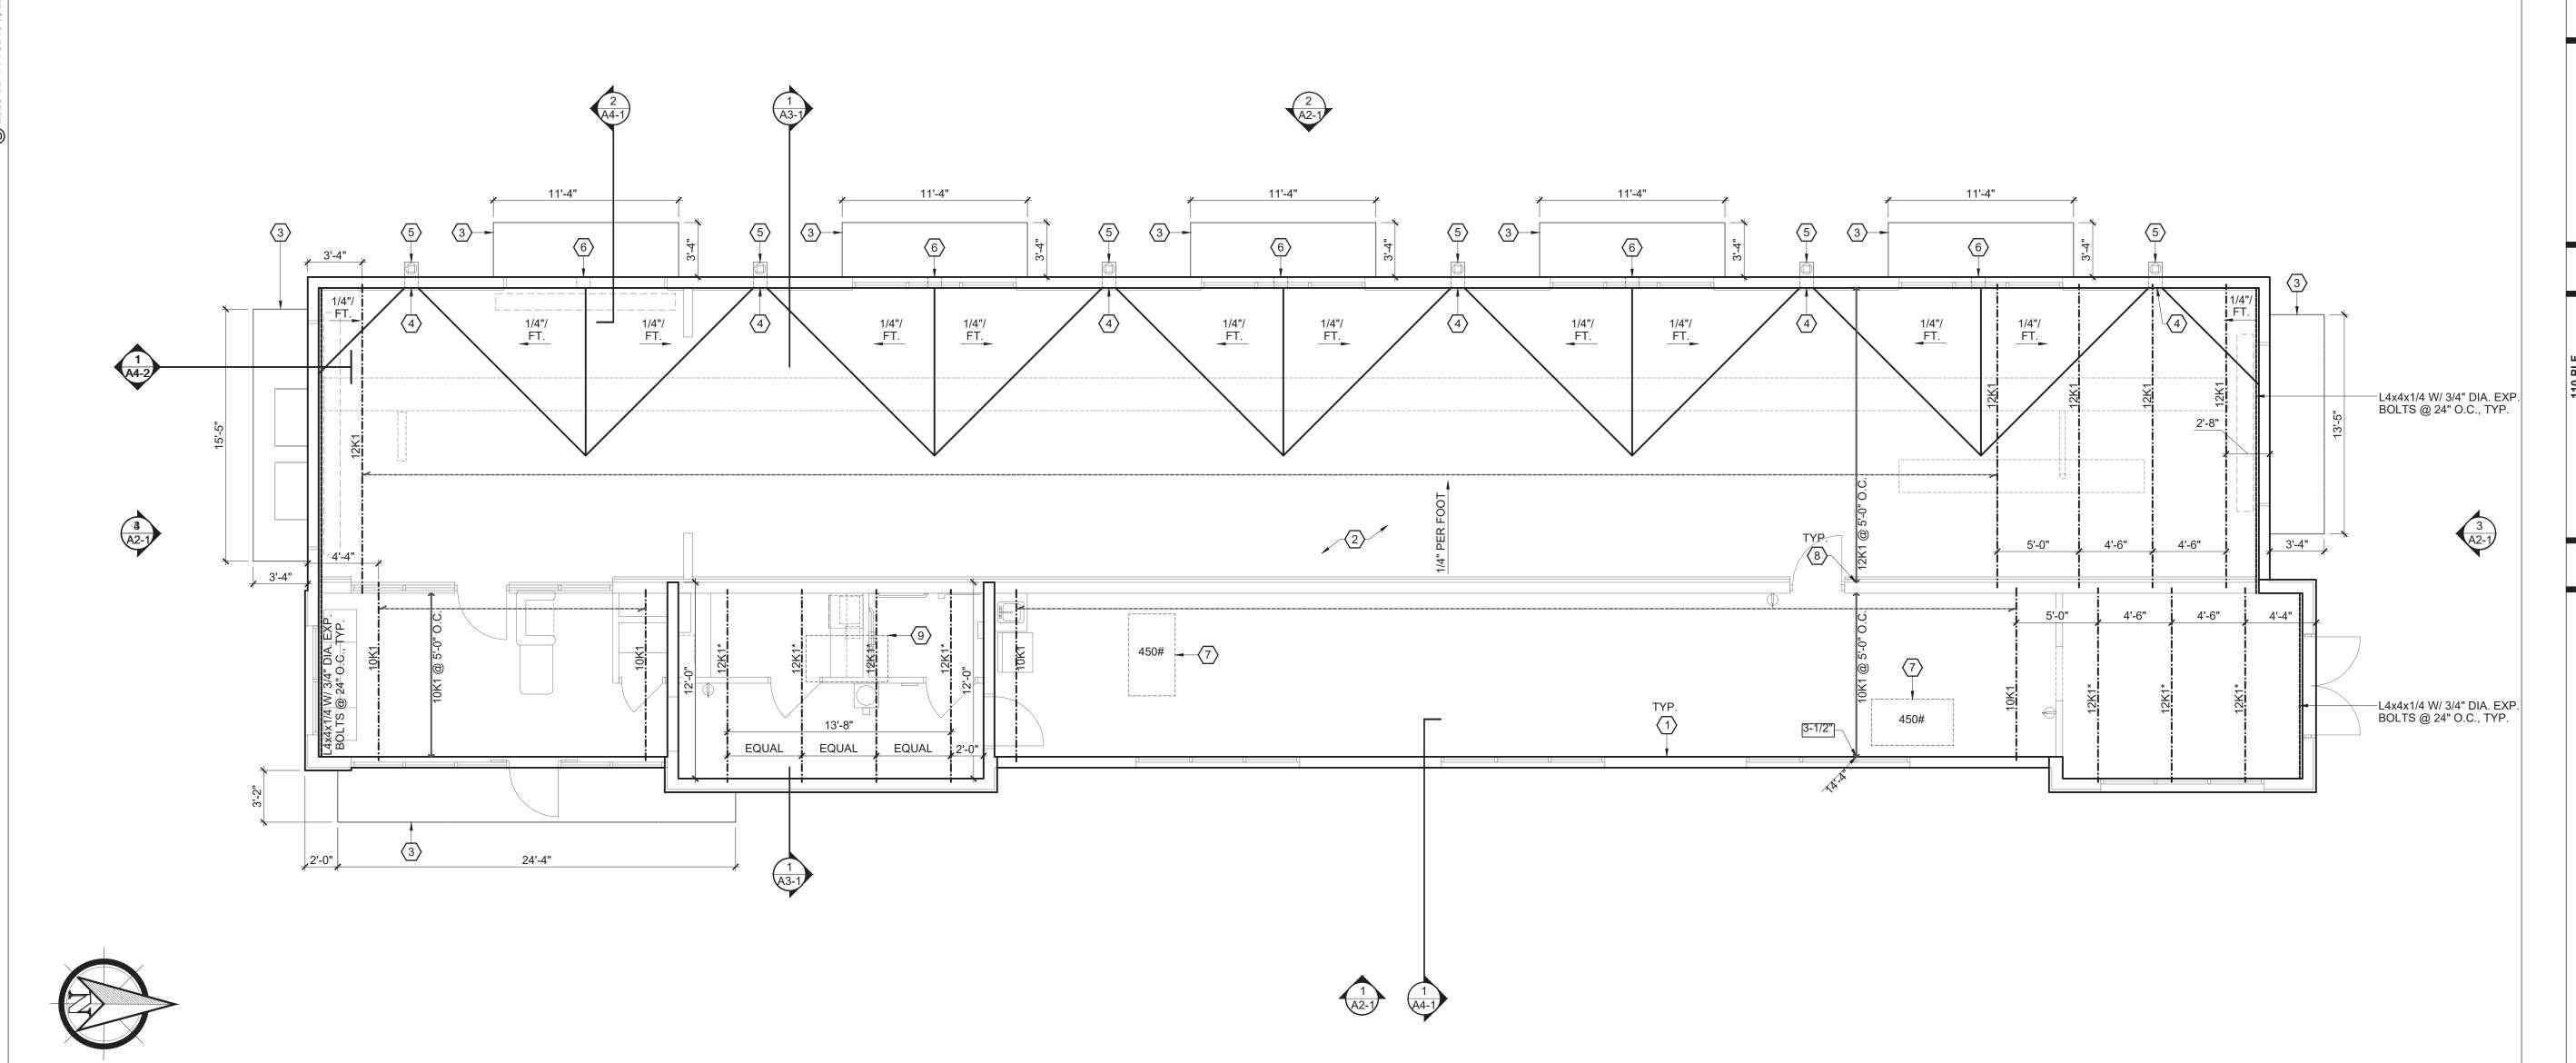



OVERFLOW SCUPPER DETAIL

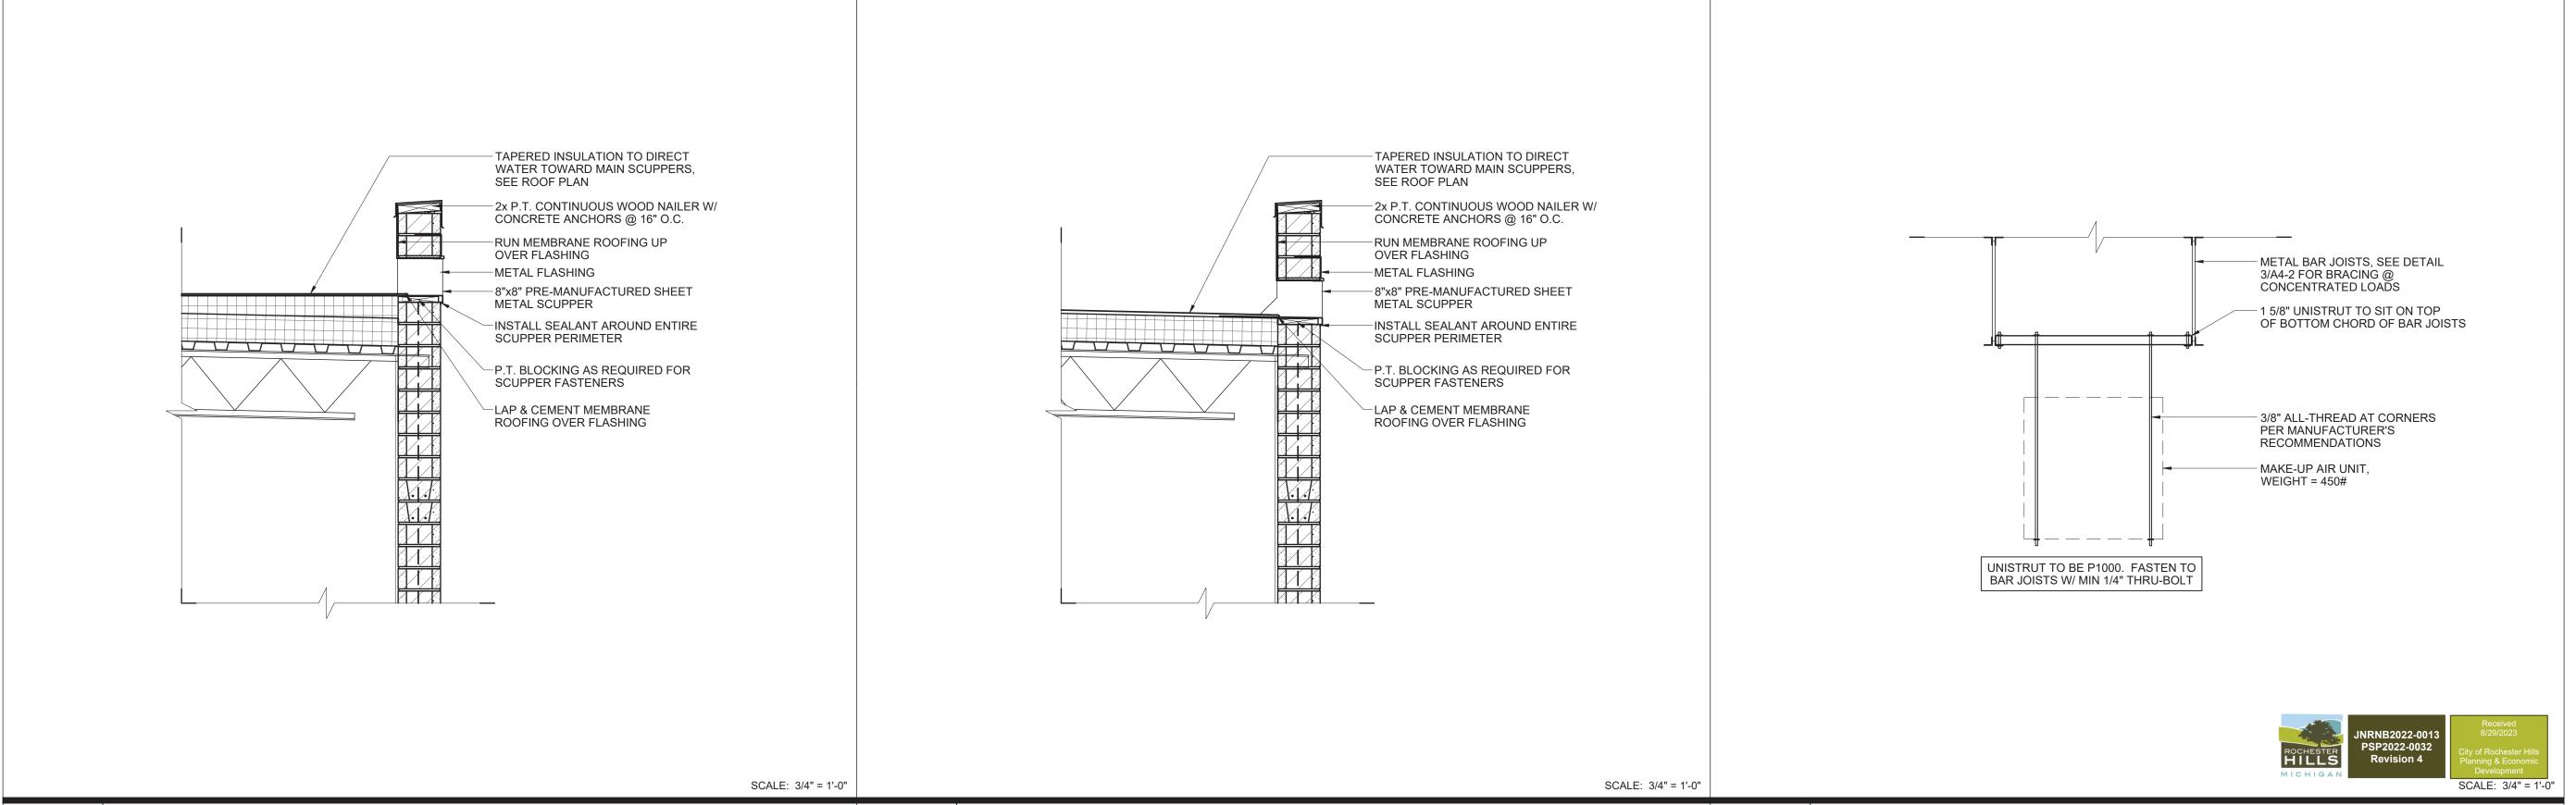


SCUPPER DETAIL

ROOF PLAN CODED NOTES

- 1. MASONRY PARAPET WALL 2. STANDARD UL CLASS A FM/1-90 FULLY ADHERED SINGLE PLY MEMBRANE ROOFING ON RIGID INSULATION, SLOPE TOWARDS
- 3. PREFABRICATED CANOPY INSTALLED PER MANUFACTURER'S
- INSTRUCTONS 4. DRAINAGE SCUPPER THROUGH PARAPET WALL
- 5. PRE-MANUFACTURED COLLECTION BOXES W/ 5" DOWNSPOUTS 6. EMERGENCY OVERFLOW SCUPPER
- 7. MAKE-UP AIR UNIT BELOW, SEE SUPPORT DETAIL 1/A1-2
- 8. PROVIDE 3-3/4" DEEP BEARING PLATES @ INTERIOR BEARING WALL LOCATIONS
- 9. ROOFTOP CONDENSING UNIT.

LOAD DIAGRAM @ JOISTS NOTED*

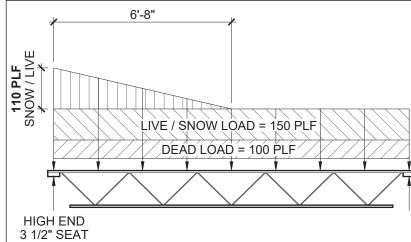

ROOF FRAMING NOTES

A. DESIGN ROOF LIVE LOADS = 25 PSF PLUS THE EFFECTS OF DRIFTING SNOW PER ASCE. 8PSF NET WIND UPLIFT.

- B. ROOF CONSTRUCTION: 1-1/2" 20 GA, GALVANIZED STEEL ROOF
- DECK, U.N.O. C. ELEVATIONS SHOWN INDICATE THE FOLLOWING:
- AT JOIST: JOIST BEARING EL. (U.N.O.) AT BEAMS: TOP OF BEAM EL. (U.N.O.) WORKPOINTS AT SLOPING MEMBERS ARE AT CENTERLINES OF COLUMNS, OR SUPPORTING BEAMS & AT INSIDE FACE OF
- D. JOISTS TO HAVE STANDARD 2-1/2" DEEP BEARING SEATS EXCEPT WHERE SHOWN THUS: 3-1/2"
- E. JOIST MANUFACTURER TO DESIGN JOISTS FOR THE LOADS SHOWN ON ROOF PLAN & IN THE JOIST LOAD DIAGRAM ON THIS
- F. SEE DETAILS 5/A4-2 FOR TOP SUPPORT OF NON-LOAD BEARING
- G. SEE SHEET A8-1 FOR STRUCTURAL NOTES. H. SEE SHEET A4-2 FOR TYPICAL JOIST DETAILS.

CMU WALLS.

DATE	ISSUED WITH: CHANGE DESCRIPTION
	DATE

10 E. AUBURN ROAD ROCHESTER HILLS, MI 48307






SCALE: 3/16" = 1'-0" (U.N.O.) SHEET # / DESCRIPTION

ROOF PLAN


DATE: 08.28.2023

PRELIMINARY DESIGN


SBA STUDIOS PROJECT # 2023-166

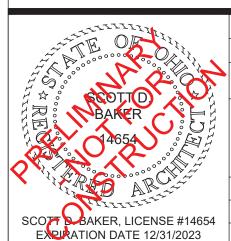


MAKE-UP AIR UNIT SUPPORT

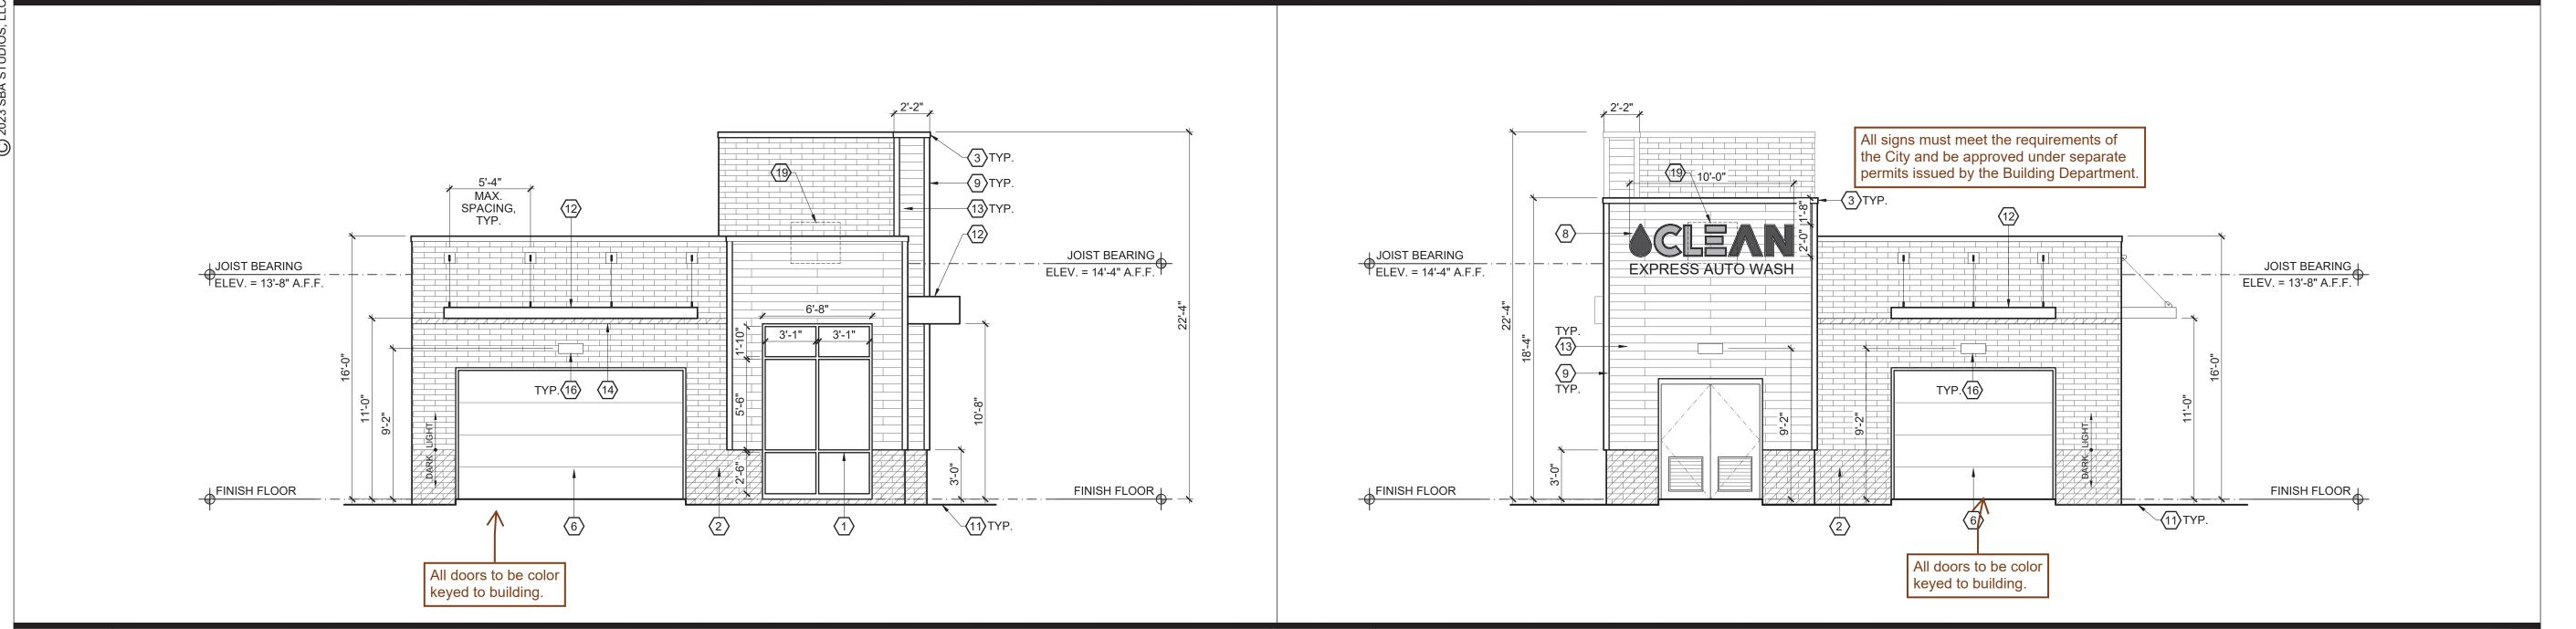

NORTH ELEVATION

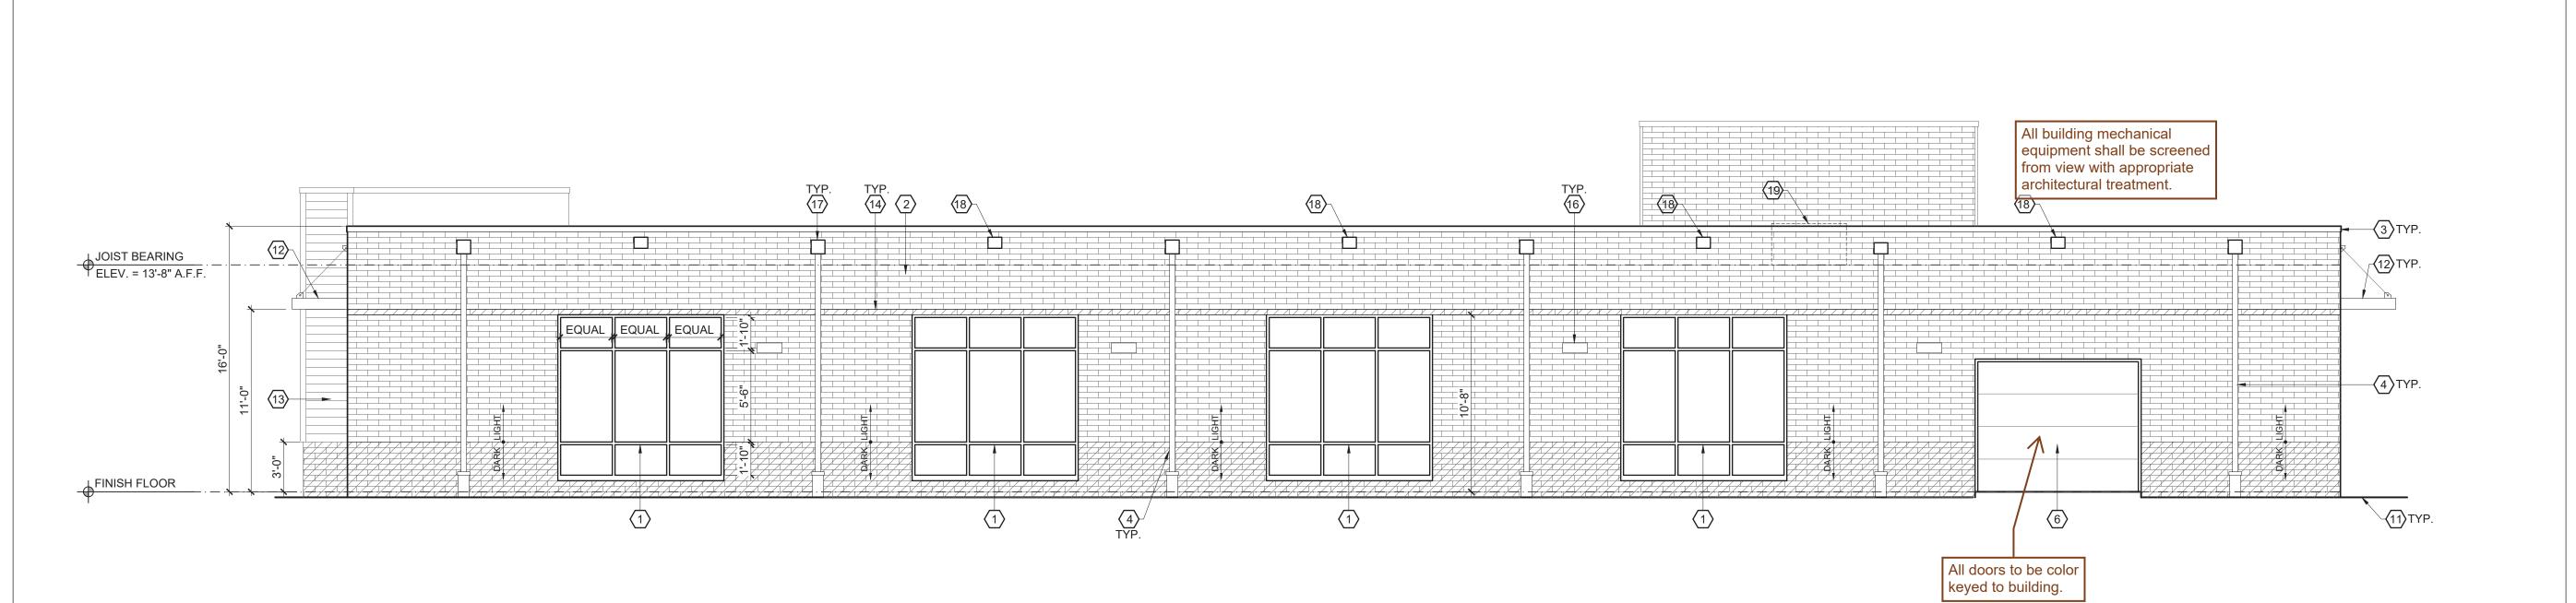

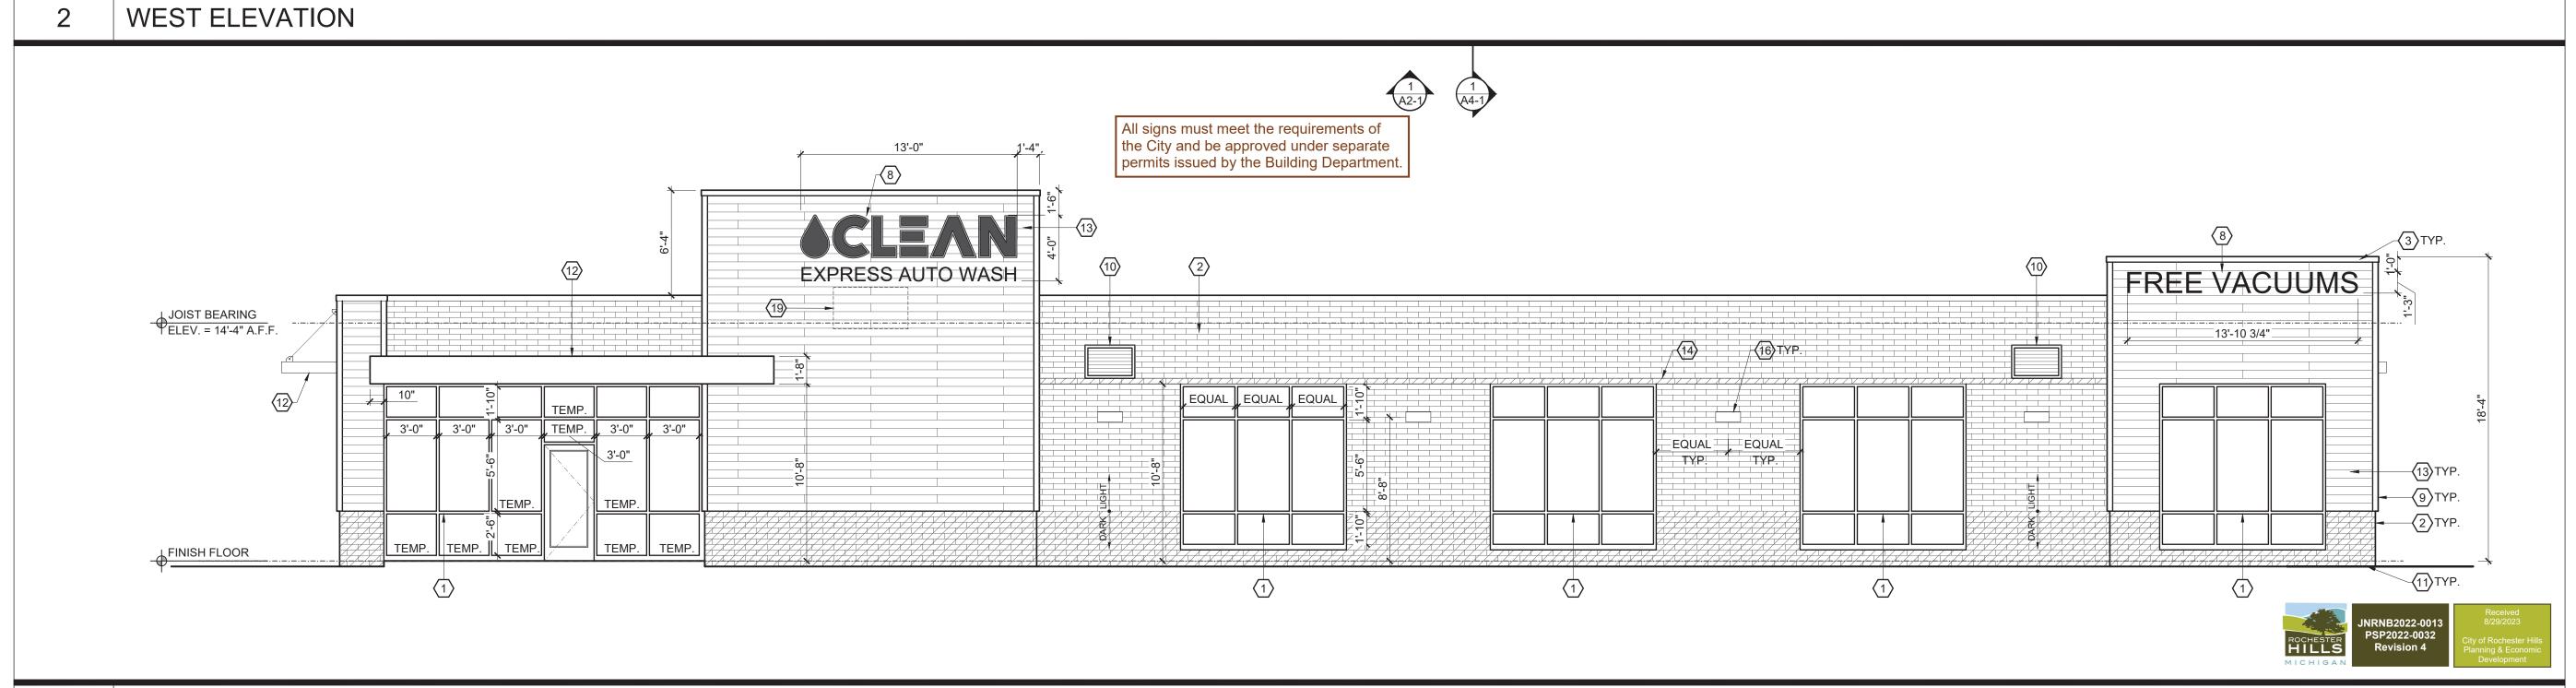

ELEVATION CODED NOTES

. ALUMINUM STOREFRONT GLAZING SYSTEM. MANUFACTURER TO DESIGN FOR WIND LOAD REQUIREMENTS PER CODE

2. QUIK-BRIK CMU CONSTRUCTION, SEE MATERIALS LEGEND.

INSTALL CONTROL JOINTS PER MANUFACTURER'S WRITTEN INSTALLATION INSTRUCTIONS

3. CONTINUOUS METAL COPING, TYP.

4. 4" METAL DOWNSPOUT

5. NOT USED6. OVERHEAD DOOR 7. NOT USED

8. SIGNAGE PROVIDED BY OWNER. ALL SIGNS TO BE SUBMITTED AND APPROVED UNDER SEPARATE PERMITS ISSUED BY THE

BUILDING DEPARTMENT.

9. 1x4 COMPOSITE CORNER TRIM, TYP. 10. 36"x24" METAL WALL LOUVER W/ 2" FRAME, SEE HVAC DRAWINGS.

LOCATE SUCH THAT OPENING IS NOT DIRECTLY BENEATH A

ROOF JOIST 11. GRADE, COORDINATE W/ CIVIL DRAWINGS.

12. PRE-MANUFACTURED ALUMINUM AWNING. INSTALL PER MANUFACTURER'S INSTRUCTIONS.

13. NICHIHA FIBER CEMENT AWP181 HORIZONTAL SIDING.

14. MASONRY BAND IN DARK FINISH TO MATCH BASE OF WALL


15. NOT USED

16. DECORATIVE LIGHT FIXTURE

17. SCUPPER & DOWNSPOUT COLLECTION BOX 18. EMERGENCY OVERFLOW SCUPPER

19. CONDENSING UNIT BEHIND TALL PARAPET WALL.

ELEVATION MATERIAL LEGEND

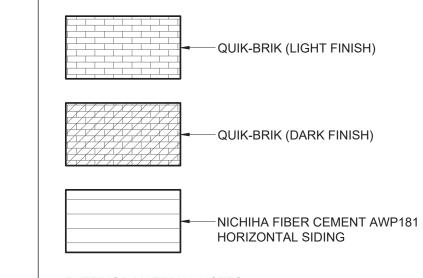

EXTERIOR MATERIAL NOTES:

1. COLOR OF METAL COPING TO MATCH STOREFRONT SYSTEM

#	DATE ISSUED WITH: CHANGE DESCRIPTION						

10 E. AUBURN ROAD ROCHESTER HILLS, MI 48307






SCALE: 3/16" = 1'-0"

DATE: 08.28.2023



SOUTH ELEVATION

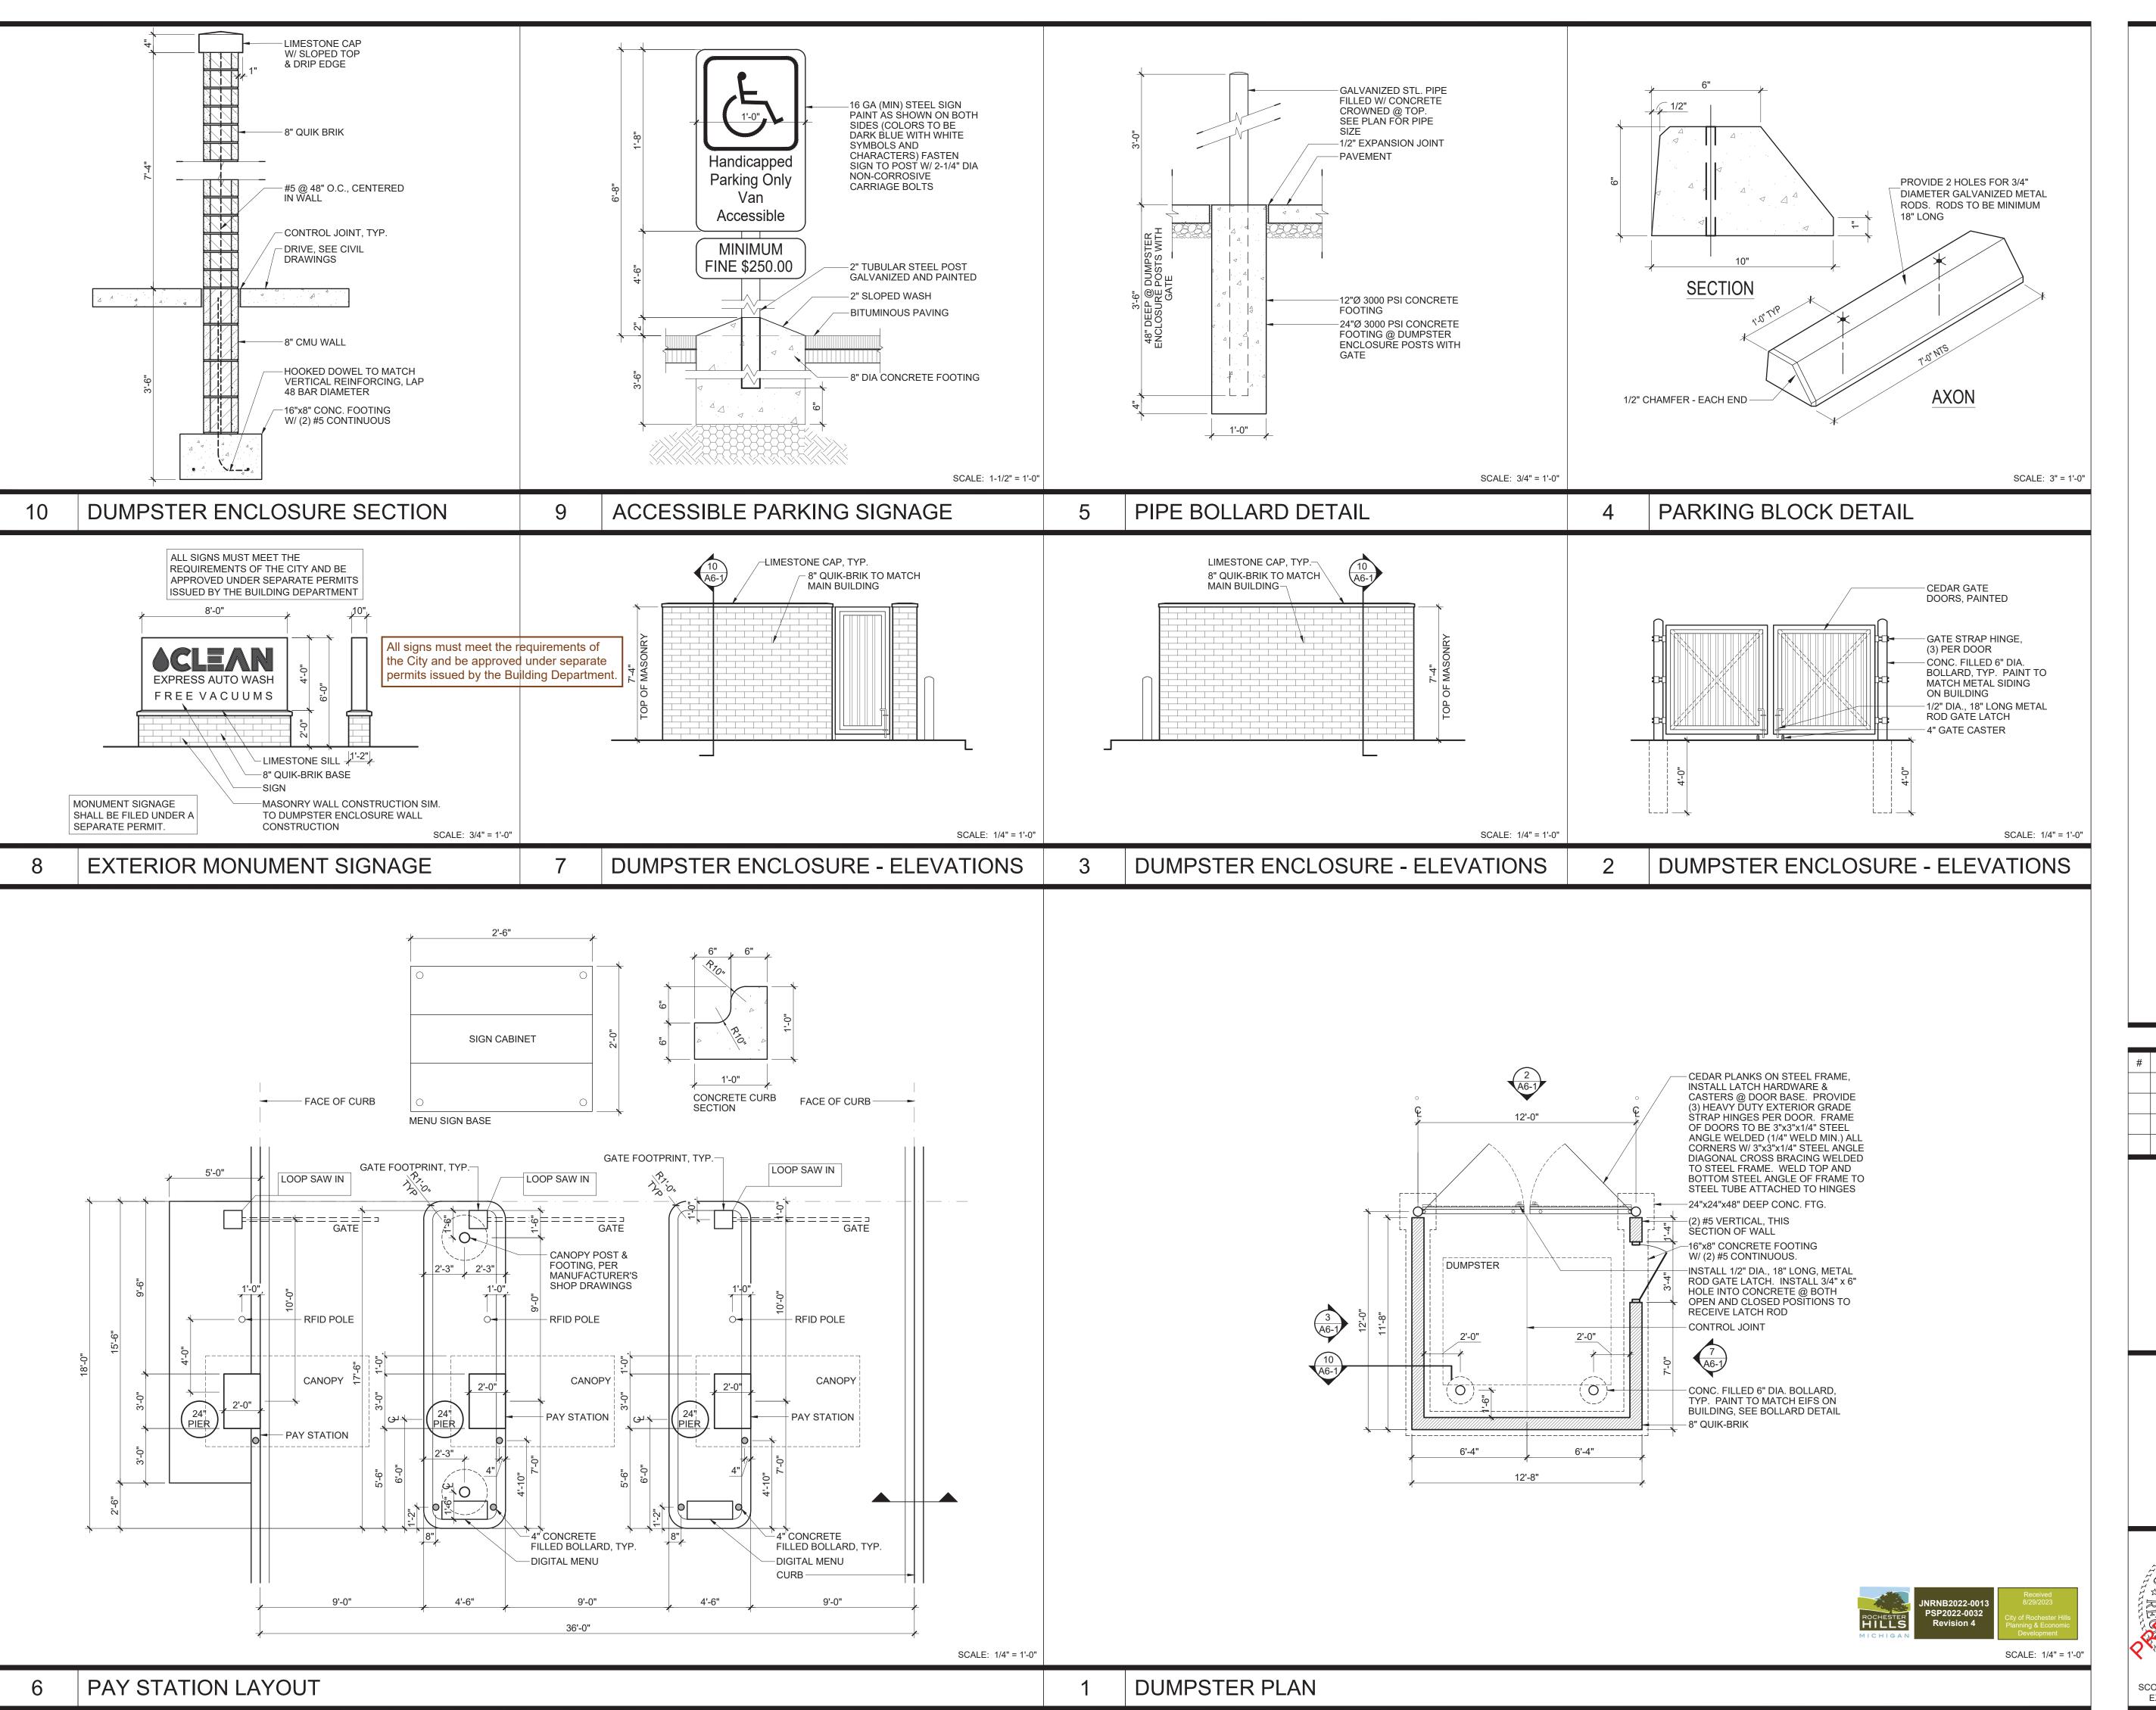

DATE ISSUED WITH: CHANGE DESCRIPTION

10 E. AUBURN ROAD ROCHESTER HILLS, MI 48307





SCALE: VARIES

SHEET # / DESCRIPTION

SITE DETAILS

DATE: 07.17.2023 PRELIMINARY DESIGN




Schedule											
Symbol	Label	QTY	Manufacturer	Catalog	Description	Number Lamps	Lamp Output	LLF	Input Power		
	GN1	6	BOCK LIGHTING	RA12-LED17	LED GOOSENECK FIXTURE	1	900	0.94	17.607		
	PL5	2	Lithonia Lighting	DSX0 LED P4 30K 70CRI T5M	D-Series Size 0 Area Luminaire P4 Performance Package 3000K CCT 70 CRI Type 5 Medium	1	11152	0.94	93.04		
	PL-BLC	1	Lithonia Lighting	DSX0 LED P4 30K 70CRI BLC3	D-Series Size 0 Area Luminaire P4 Performance Package 3000K CCT 70 CRI Type 3 Extreme Backlight Control	1	7768	0.94	93.04		

Statistics									
Description	Symbol	Avg	Max	Min	Max/Min	Avg/Min			
PROPERTY LINE - CULVERS	+	0.0 fc	0.1 fc	0.0 fc	N/A	N/A			
PROPERTY LINE - PENNZOIL	+	0.0 fc	0.1 fc	0.0 fc	N/A	N/A			
PROPERTY LINE - PERIMETER	+	0.1 fc	0.3 fc	0.0 fc	N/A	N/A			
VACUUM & PARKING SPACES	+	1.2 fc	2.4 fc	0.4 fc	6.0:1	3.0:1			
DRIVING LANES	+	1.2 fc	3.2 fc	0.4 fc	8.0:1	3.0:1			

Note

- 1. POLE LIGHTS MOUNTED AT 17' AFG
- 2. 15' POLE ON A 2' POLE BASE
- 3. GOOSENECK WALL SCONCES MOUNTED AT 10' AFG

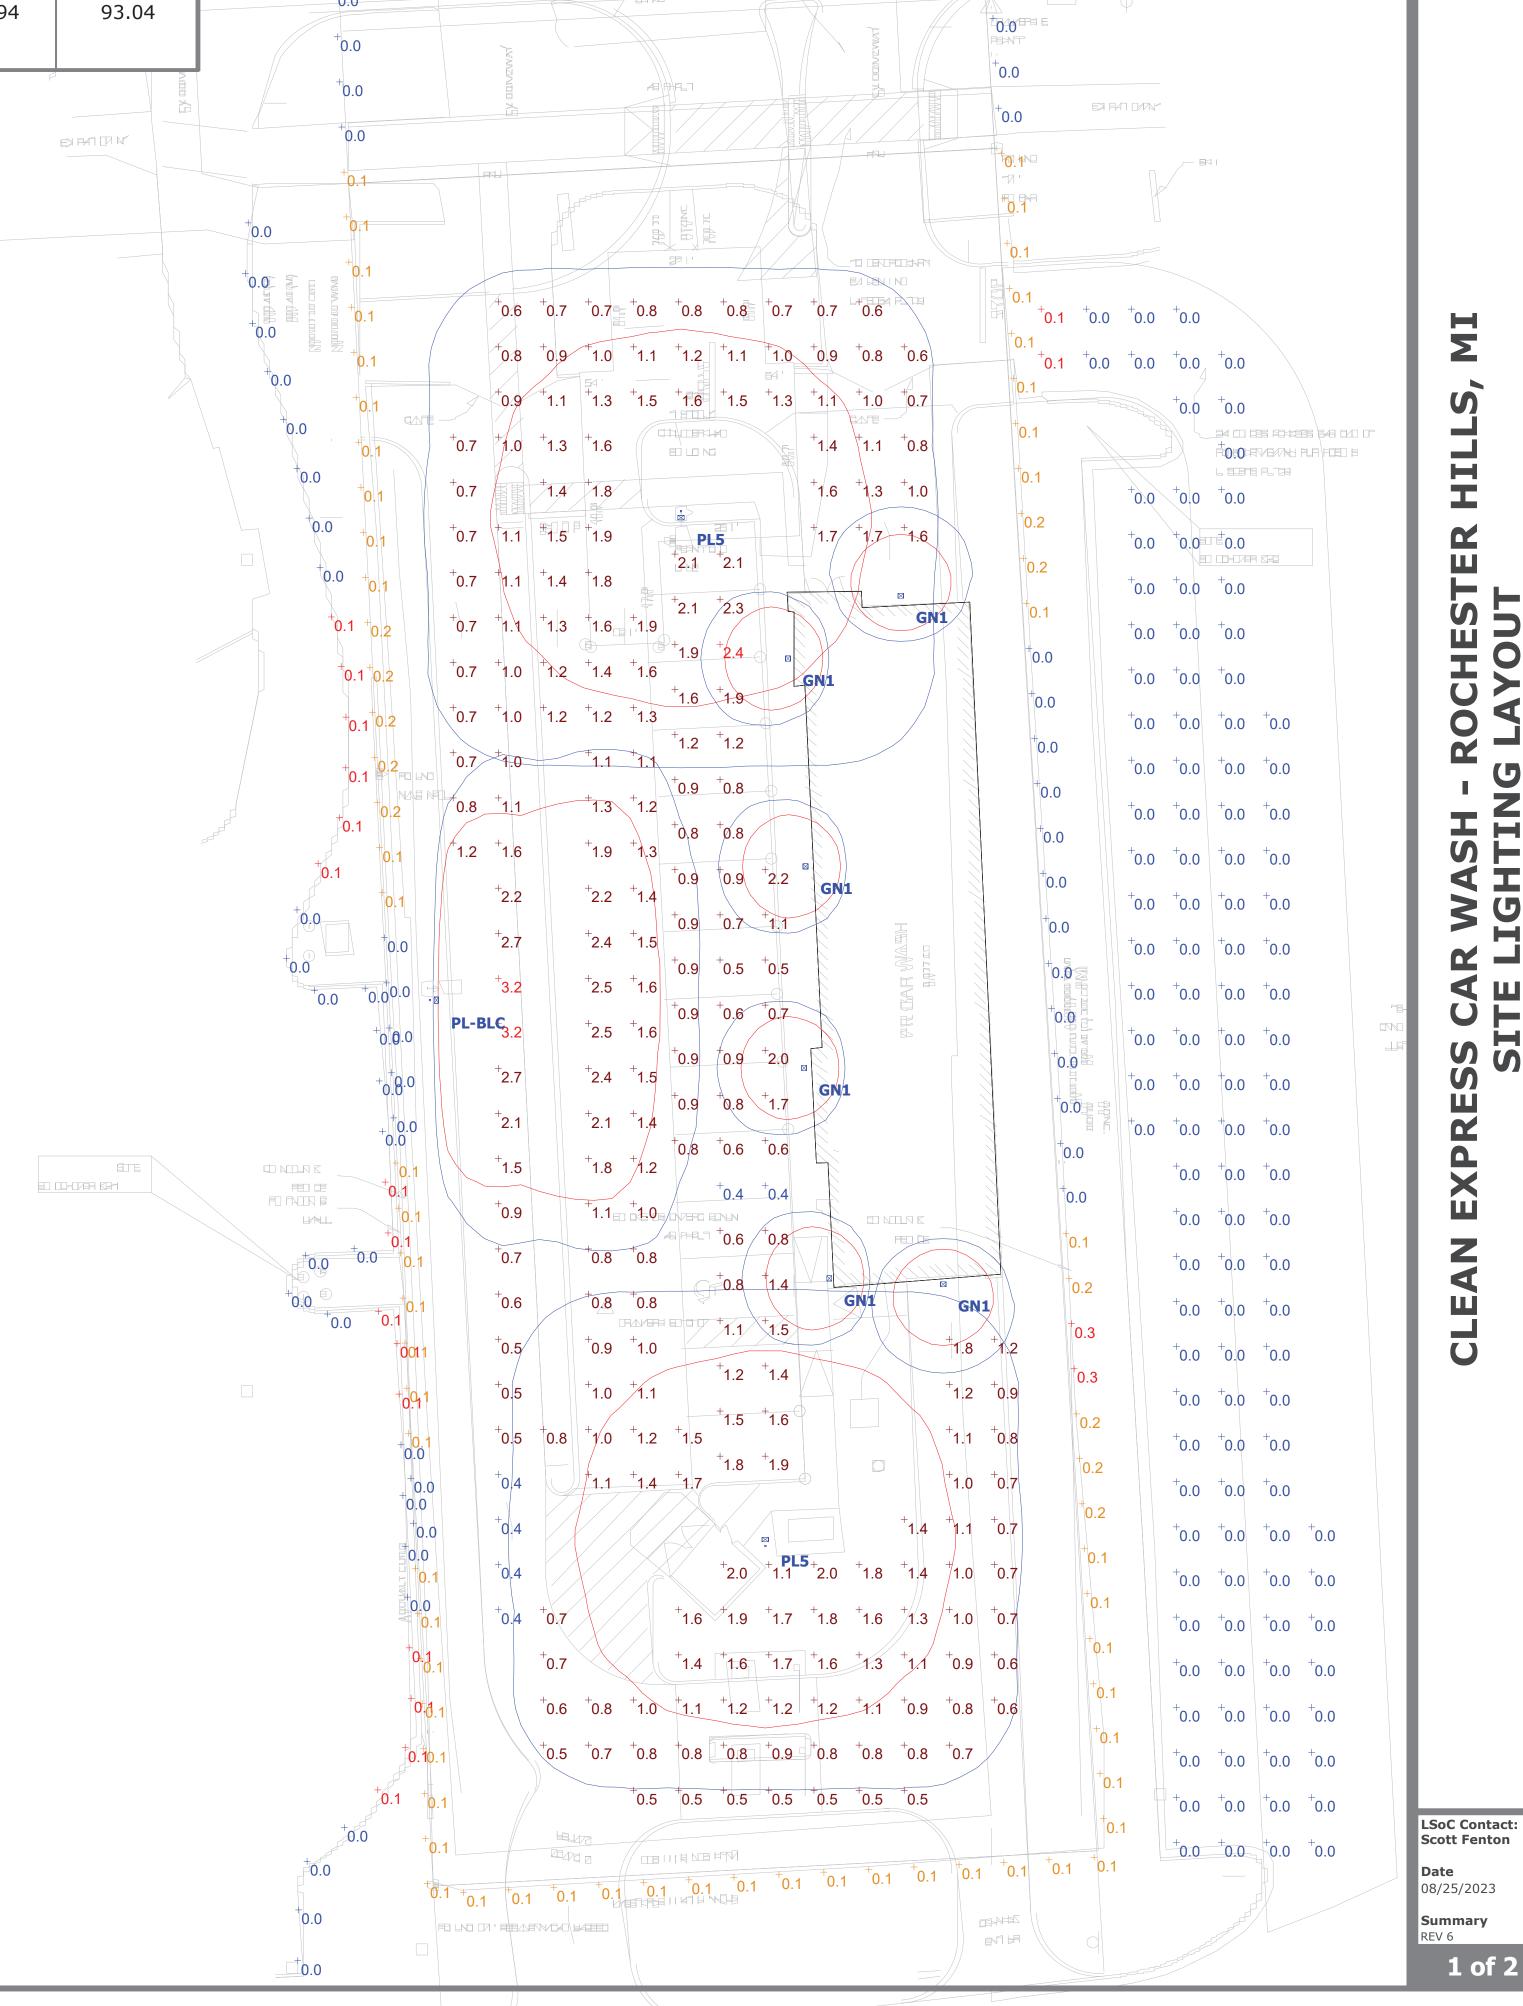

PA BLED D-

LIGHTING SYSTEMS

HILLS,


ROCHESTER G LAYOUT

SS CAR WASH - I SITE LIGHTING

EXPRES

CLEAN

1 of 2

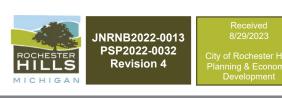

Statistics

Description	Symbol	Avg	Max	Min	Max/Min	Avg/Min
PROPERTY LINE - CULVERS	+	0.0 fc	0.1 fc	0.0 fc	N/A	N/A
PROPERTY LINE - PENNZOIL	+	0.0 fc	0.1 fc	0.0 fc	N/A	N/A
PROPERTY LINE - PERIMETER	+	0.1 fc	0.3 fc	0.0 fc	N/A	N/A
VACUUM & PARKING SPACES	+	1.2 fc	2.4 fc	0.4 fc	6.0:1	3.0:1
DRIVING LANES	+	1.2 fc	3.2 fc	0.4 fc	8.0:1	3.0:1

Note

1. POLE LIGHTS MOUNTED AT 17' AFG


2. 15' POLE ON A 2' POLE BASE

3. GOOSENECK WALL SCONCES MOUNTED AT 10' AFG

mumumumumumum


districts shall incorporate automatic timers and shall be turned off between the hours of midnight and sunrise, except for lighting necessary for security purposes or accessory to a use that continues after midnight. Security lighting shall, to the extent practical, uses sensors and dim or turn off when there is no activity on

Clarify comment. Comment indicates gooseneck fixtures, detail of wall mounted lighting does not depict that type of fixture.

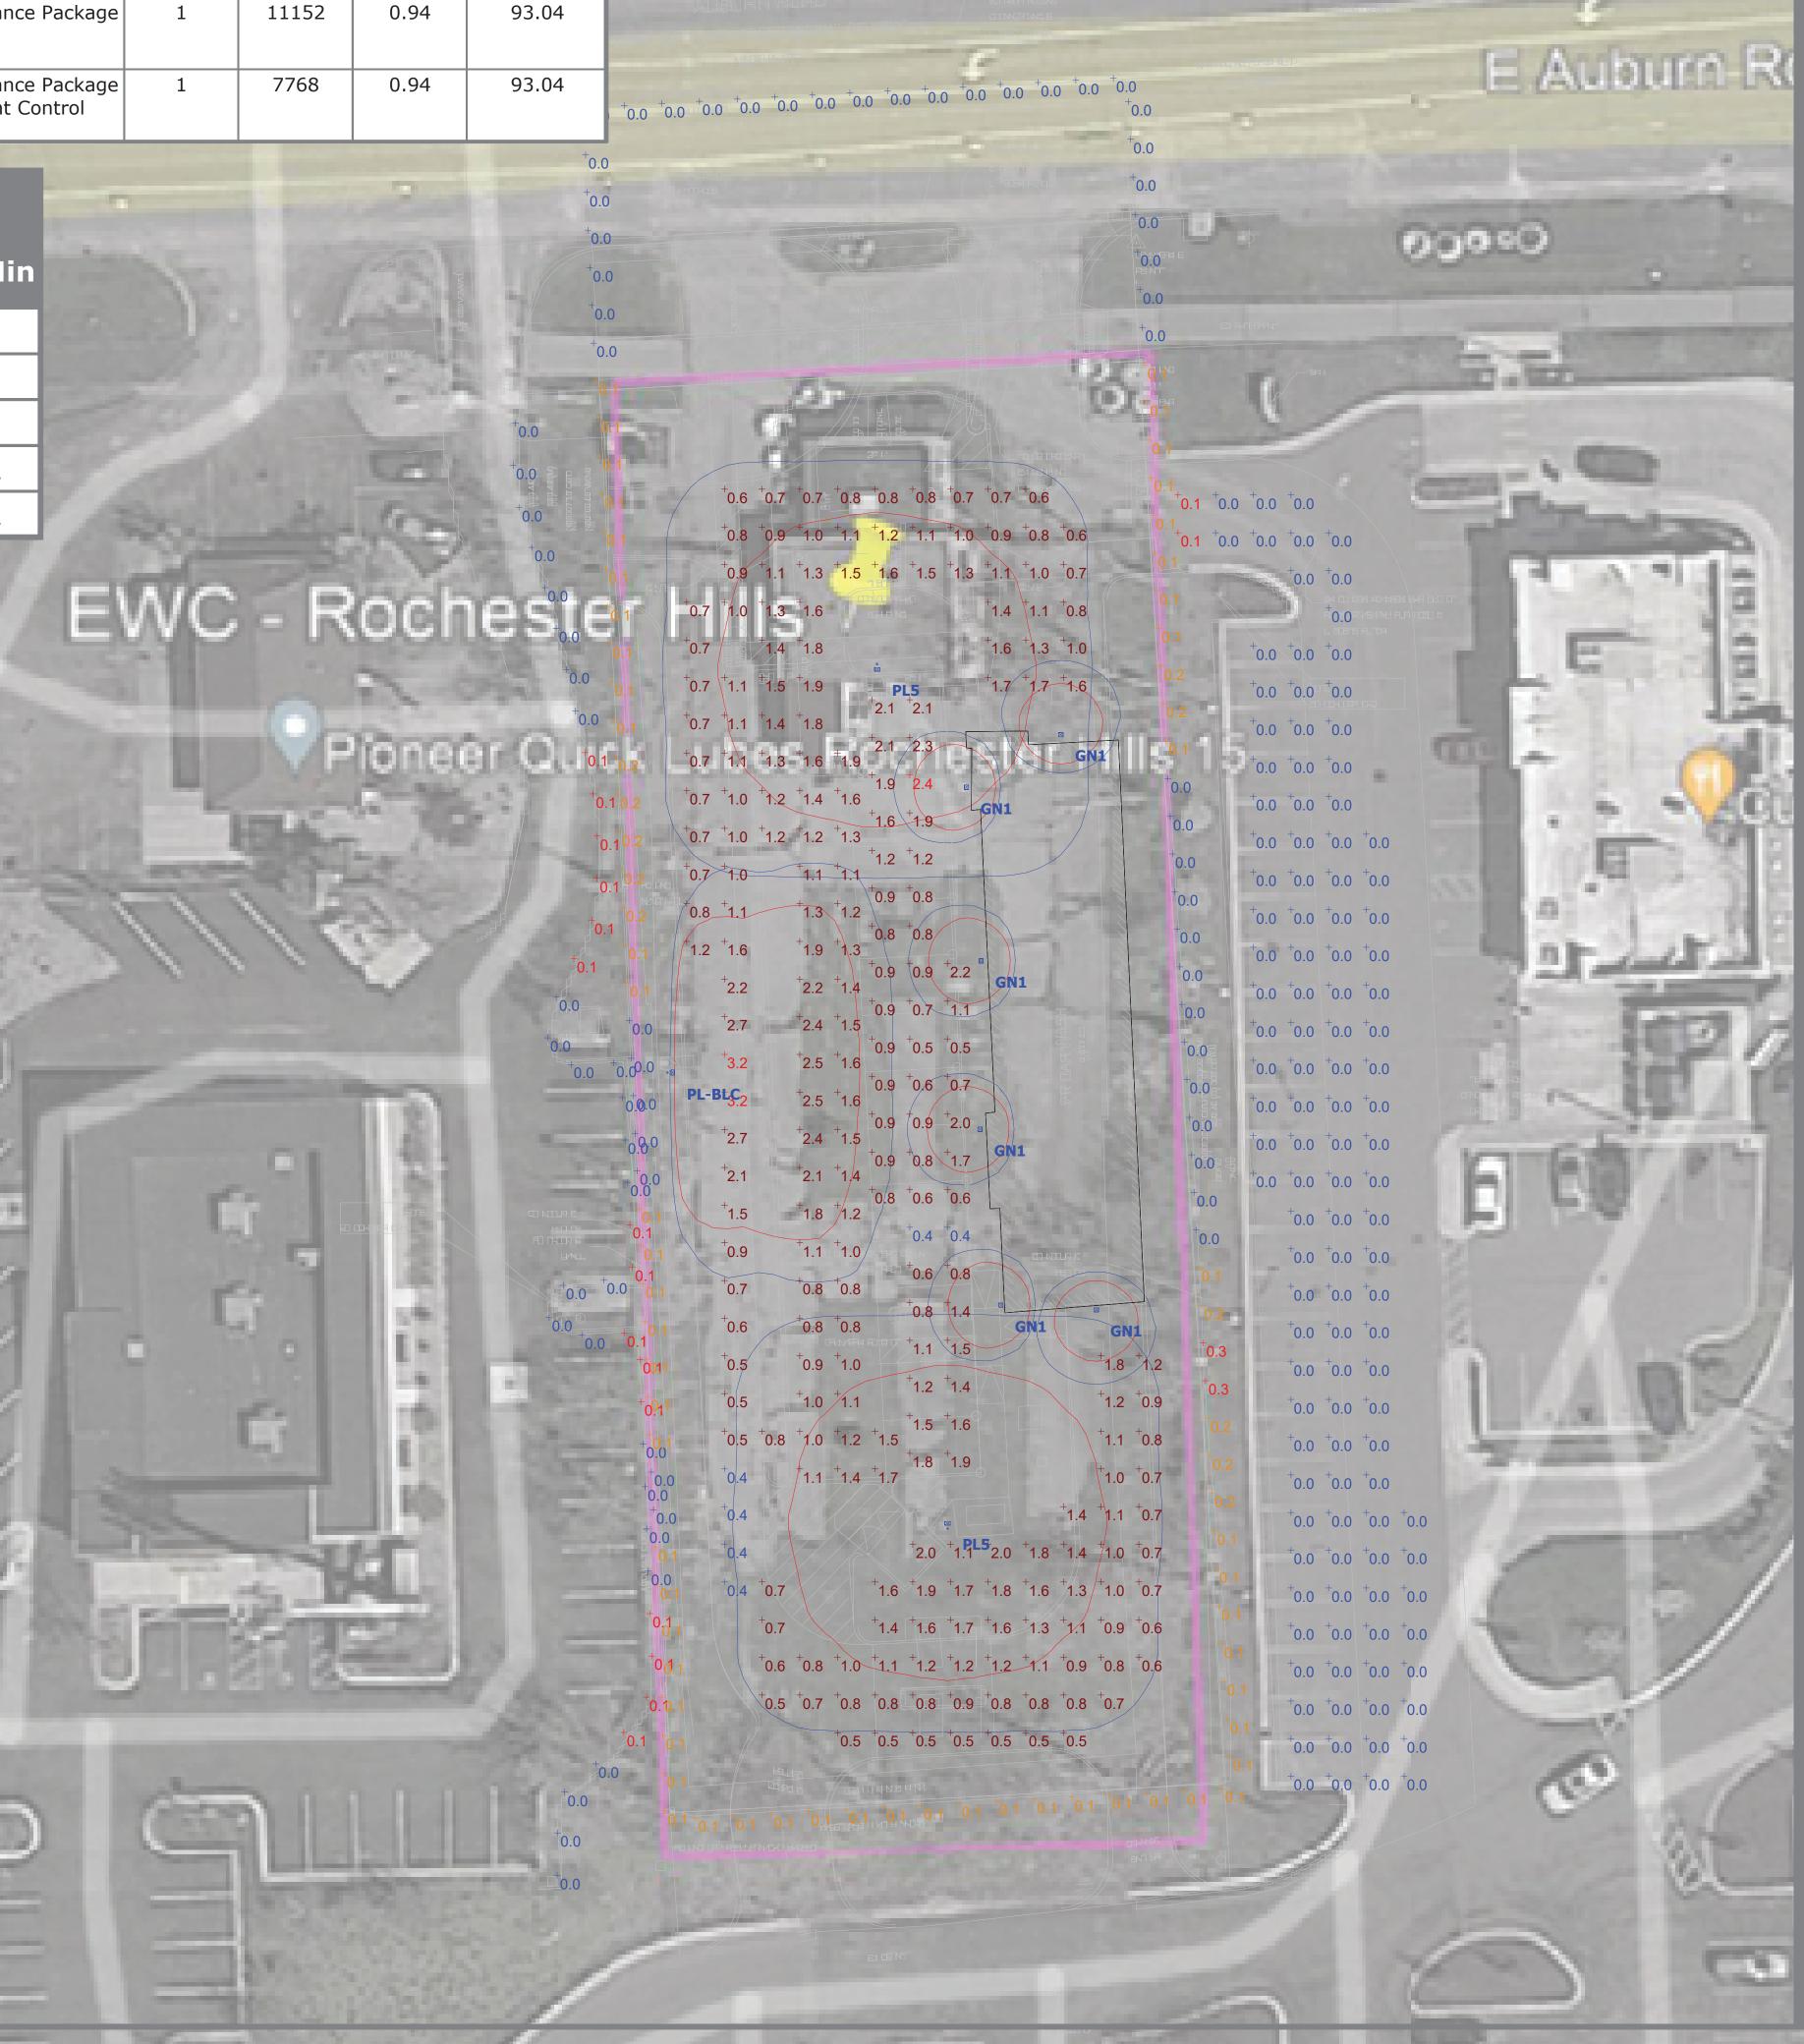





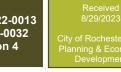

LIGHTING SYSTEMS

HILLS,


ROCHESTER | 3 LAYOUT


SS CAR WASH - I SITE LIGHTING


EXPRES

AN

CLE/

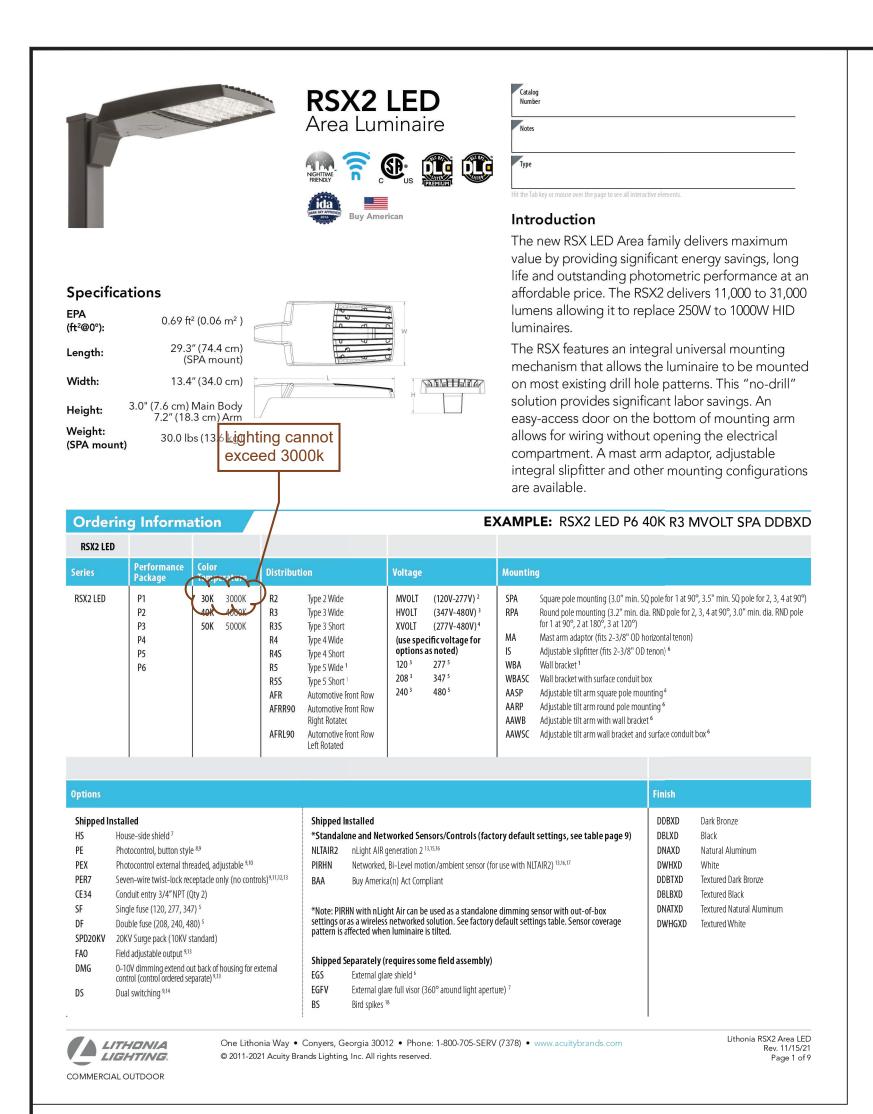

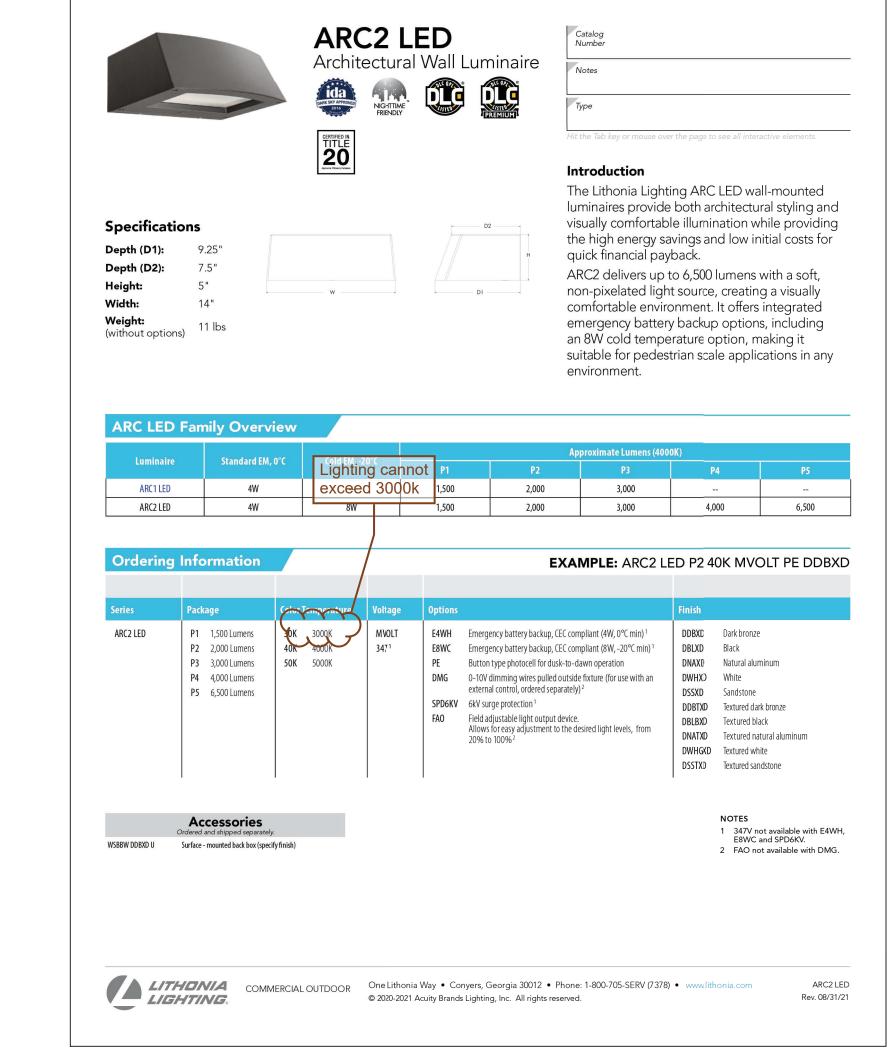

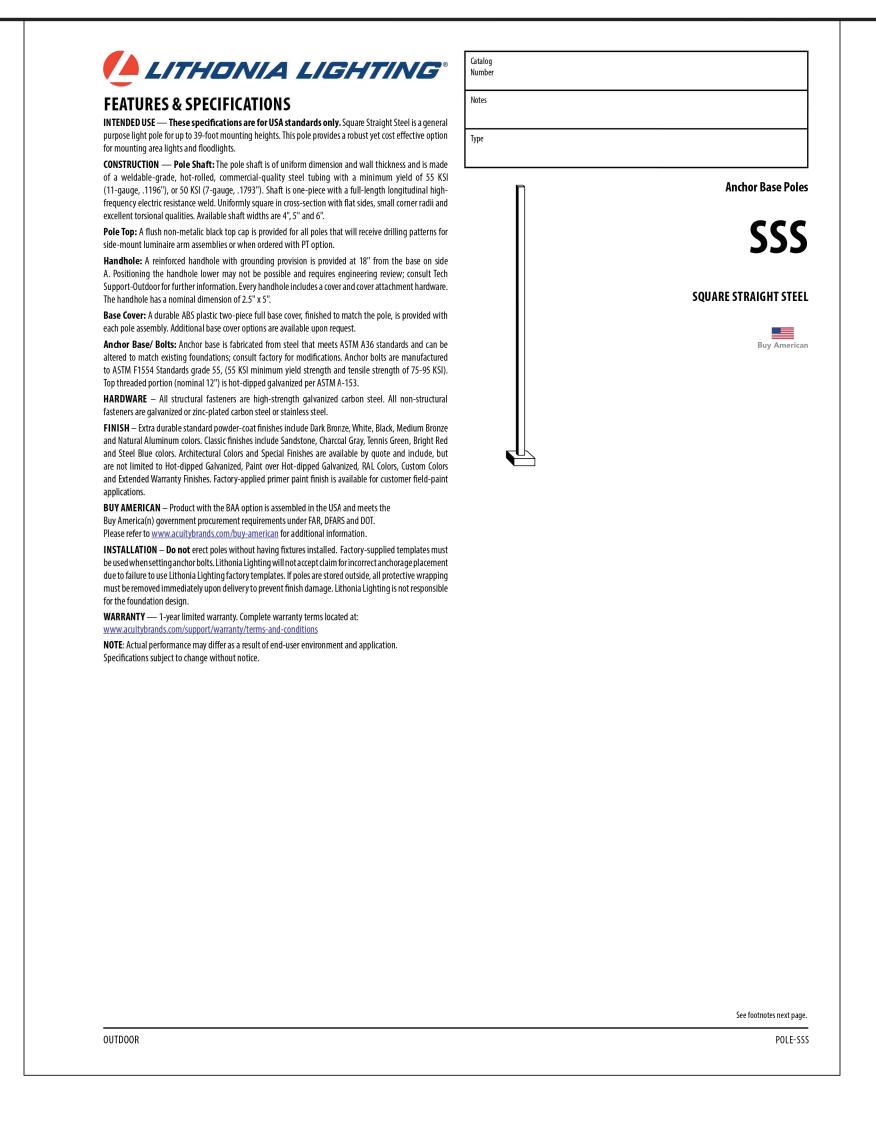

MICHIGAN
Utility Notification
CENTER

Know What's Below. Call Before You Dig.







SITE LIGHTING DETAILS

CLEAN EXPRESS CAR WASH

HON DRAWING

USED AS

0

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NO






EASI

WEST



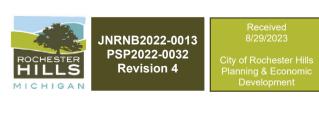




NORTH

SOUTH



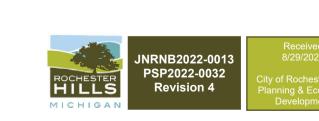

















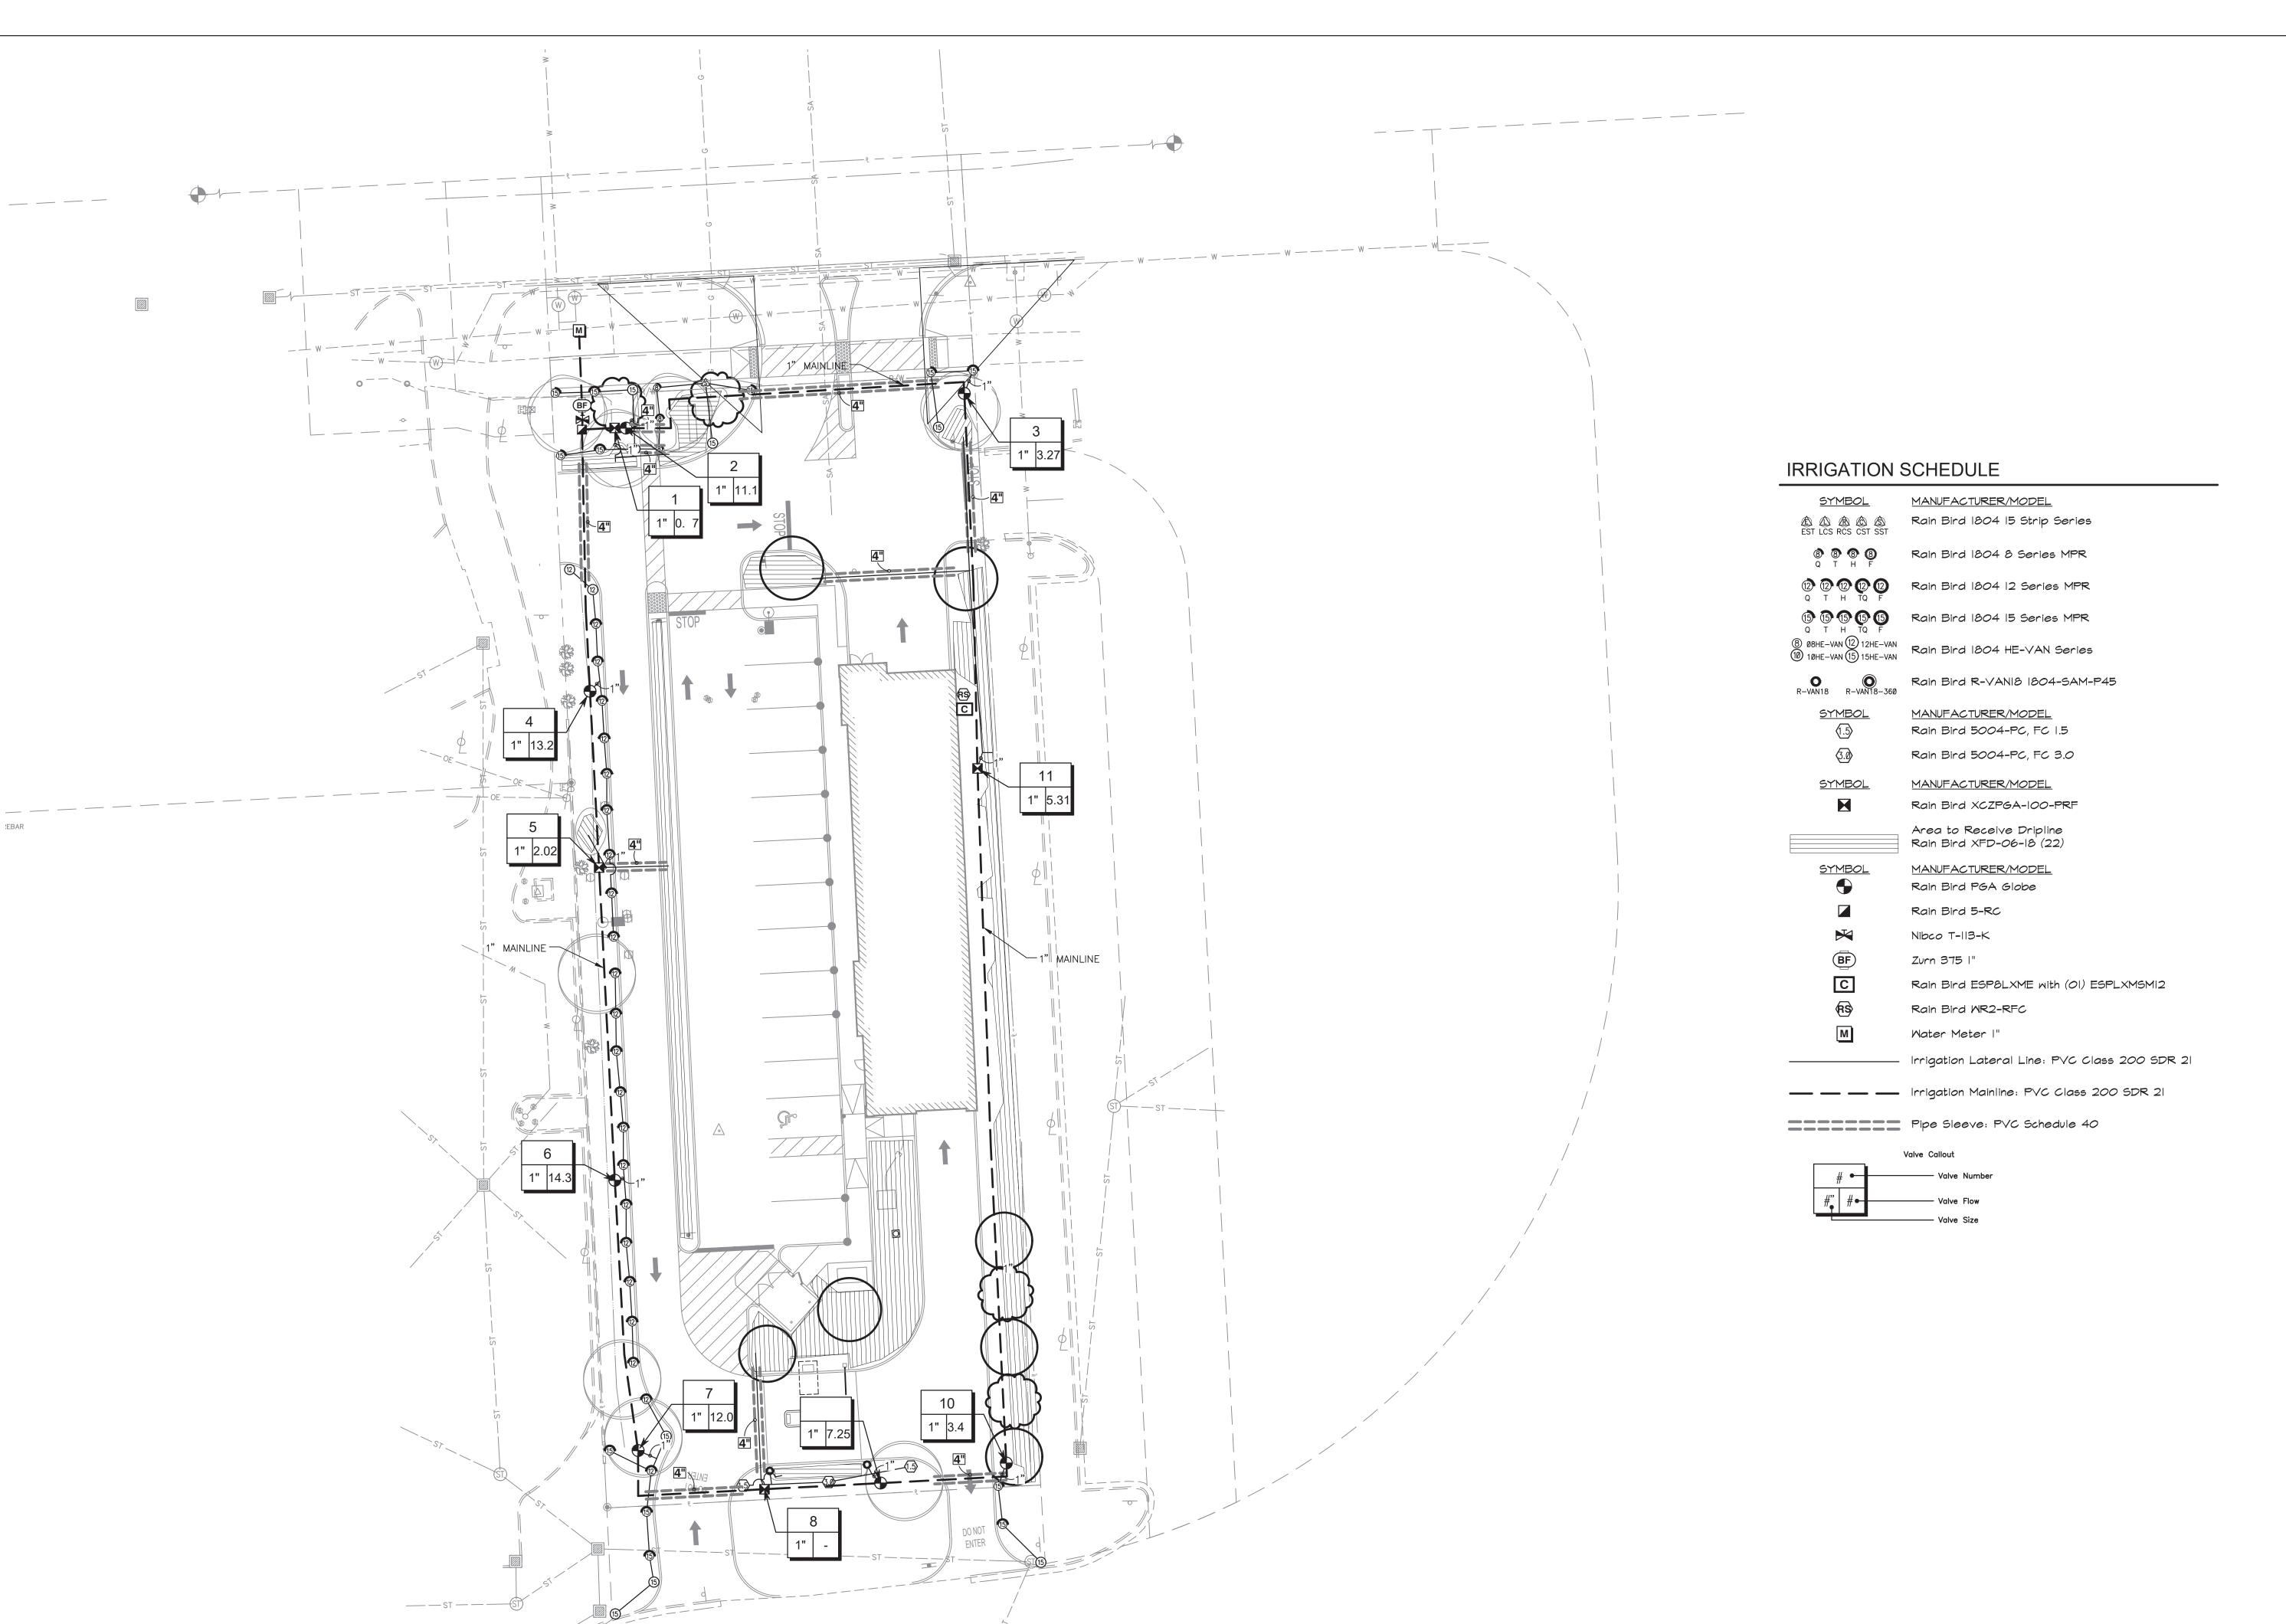

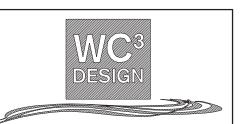

Irrigation Design & Consulting www.wc3design.com Tel: (844) 231-7042 Columbus, OH • Louisville, KY

Pittsburgh, PA



Revisions: Project Number:

Drawn by: Checked by:

DB Date: 8/24/2023

Sheet Number:

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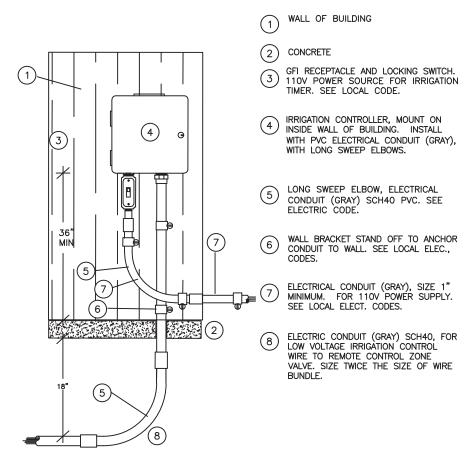


SCALE 1" 20


IRRIGATION NOTES

THESE NOTES ARE PRESENTED AS A "SUMMARY" OF THE WRITTEN SPECIFICATIONS ISSUED FOR THE PROJECT. REFER TO THE WRITTEN SPECIFICATIONS, IF INCLUDED, FOR ADDITIONAL DETAIL AND FULL PROJECT REQUIREMENTS.

- 1. THE IRRIGATION SYSTEM DESIGN IS BASED ON 60 STATIC PRESSURE (PSI) AND MAXIMUM FLOW OF 15 GALLONS PER MINUTE(GPM). THE IRRIGATION CONTRACTOR SHALL VERIFY THE PRESSURE AND FLOW PRIOR TO COMMENCEMENT OF CONSTRUCTION. REPORT TO THE OWNER OR OWNER'S REPRESENTATIVE ANY DIFFERENCES BETWEEN THE PRESSURE INDICATED AND THE ACTUAL PRESSURE READING AT THE POINT OF CONNECTION.
- 2. THE PIPE ROUTING SHOWN IS DIAGRAMMATIC ONLY. ALL PIPING, VALVES, HEADS, ETC SHOWN WITHIN PAVED AREAS ARE FOR DESIGN CLARIFICATION ONLY. PRESSURE LOSS CALCULATIONS ARE BASED ON THE PIPE ROUTING AS SHOWN. SIGNIFICANT DEVIATIONS FROM THE ROUTING SHOWN SHOULD BE AVOIDED.
- 3. DO NOT WILLINGLY INSTALL THE SPRINKLER SYSTEM AS SHOWN ON THE DRAWINGS WHEN IT IS OBVIOUS IN THE FIELD THAT OBSTRUCTIONS, GRADE DIFFERENCES, OR DIFFERENCES IN THE DIMENSIONS OF THE CONSTRUCTED AREAS EXIST THAT MIGHT NOT HAVE BEEN CONSIDERED IN THE IRRIGATION DESIGN OR CHANGES HAVE OCCURRED IN THE SITE PLAN. SUCH OBSTRUCTIONS OR DIFFERENCES SHOULD BE BROUGHT TO THE ATTENTION OF THE IRRIGATION DESIGNER AND THE GENERAL CONTRACTOR IMMEDIATELY. SHOULD THE IRRIGATION CONTRACTOR PROCEED WITH THE INSTALLATION WITHOUT NOTIFYING THE IRRIGATION DESIGNER AND THE GENERAL CONTRACTOR, THE IRRIGATION CONTRACTOR ASSUMES FULL RESPONSIBILITY FOR ANY AND ALL REVISIONS / RECONSTRUCTION NECESSARY.
- 4. IT IS THE RESPONSIBILITY OF THE IRRIGATION CONTRACTOR TO FAMILIARIZE HIMSELF / HERSELF WITH THE SITE, ALL GRADE DIFFERENCES, LOCATIONS OF WALLS, AND INSTALLED UTILITIES. COORDINATE WORK WITH THE OWNER OR GENERAL CONTRACTOR AND OTHER SUBCONTRACTORS FOR THE LOCATION AND INSTALLATION OF PIPE SLEEVES UNDERNEATH PAVEMENT AND THROUGH WALLS.
- 5. DUE TO THE SCALE OF THE DRAWING, IT IS NOT POSSIBLE TO INDICATE ALL OFFSETS, FITTINGS, JOINTS, ETC. WHICH MAY BE REQUIRED. THE IRRIGATION CONTRACTOR SHALL CAREFULLY INVESTIGATE THE STRUCTURAL AND FINISHED CONDITIONS AFFECTING ALL OF HIS/HER WORK AND PLAN HIS/HER WORK ACCORDINGLY, FURNISHING SUCH FITTINGS, ETC. AS MAY BE REQUIRED TO MEET SUCH CONDITIONS. ALL WORK SHALL BE INSTALLED IN SUCH A MANNER AS TO AVOID CONFLICTS BETWEEN IRRIGATION SYSTEM COMPONENTS, LANDSCAPE PLANTING, AND ARCHITECTURAL FEATURES.
- 6. FLUSH ALL LINES AND HEADS PRIOR TO INSTALLING NOZZLES. ADJUST NOZZLE SPRAY ARC AND RADIUS FOR OPTIMUM PERFORMANCE TO PREVENT OVERSPRAY ONTO PAVED SURFACES OR FACE OF BUILDING AS MUCH AS POSSIBLE TO FIT THE SITE CONDITIONS. THROTTLE FLOW CONTROL AT EACH VALVE FOR OPTIMUM OPERATING PRESSURE FOR EACH ZONE.
- 7. ALL SPRINKLER HEADS SHALL BE SET PERPENDICULAR TO FINISHED GRADE OF THE AREA TO BE IRRIGATED UNLESS OTHERWISE NOTED.
- 8. WHEN VERTICAL OBSTRUCTIONS (POLES, SIGNS, TREES, HYDRANTS, ETC) INTERFERE WITH THE SPRAY PATTERN OF THE HEADS SO AS TO PREVENT PROPER COVERAGE, THE CONTRACTOR SHALL FIELD ADJUST THE SPRINKLER SYSTEM BY INSTALLING A QUARTER, THIRD, OR HALF CIRCLE HEAD AT THE SIDES OF THE OBSTRUCTION SO AS TO PROVIDE PROPER COVERAGE. ALL ADJUSTMENTS SHALL BE MADE AT NO ADDITIONAL COST.
- 9. USE TEFLON TAPE ON ALL MALE PIPE THREADS ON PVC PIPE, SWING JOINTS, AND VALVE ASSEMBLIES.
- 10. INSTALL VALVE BOXES 18-INCHES FROM AND PERPENDICULAR TO WALKS, CURBS, BUILDING, OR LANDSCAPE FEATURES. AT MULTIPLE VALVE BOX GROUPS, EACH BOX SHALL BE INSTALLED A MINIMUM OF 12-INCHES APART.
- 11. ALL VALVES SHALL BE PLACED IN VALVE BOXES AS SHOWN IN THE DETAILS AND ALL ELECTRICAL CONNECTIONS SHALL BE SEALED WITH WATERPROOF CONNECTORS.
- 12. 120-VOLT ELECTRICAL POWER AT THE CONTROLLER SHALL BE PROVIDED BY OTHERS. IT IS THE RESPONSIBILITY OF THE IRRIGATION CONTRACTOR TO MAKE THE FINAL HOOK-UP FROM THE POWER PROVIDED TO THE CONTROLLER.
- 13. PROVIDE AS-BUILT DRAWINGS WITHIN 21 DAYS UPON COMPLETION OF THE IRRIGATION INSTALLATION.
- 14. THERE SHALL BE NO SUBSTITUTIONS OR CHANGES TO THE IRRIGATION DESIGN ALLOWED WITHOUT DIRECT, WRITTEN APPROVAL FROM THE IRRIGATION CONSULTANT OR THE LANDSCAPE ARCHITECT. CONTACT WC3 DESIGN FOR INFORMATION.
- 15. ALL SPRINKLERS, VALVES AND VALVE BOXES SHALL BE PLACED 5' AWAY FROM ANY RADIUS OF CURB AS SHOWN IN DETAILS.
- 16. IRRIGATION CONTRACTOR SHALL PROVIDE THE FIRST WINTERIZATION BLOW OUT. IN ADDITION, HE SHALL PROVIDE THE SPRING TURN ON . ALL NECESSARY HEAD ADJUSTMENTS SHALL BE MADE AT THAT TIME AND REPLACE OR REPAIR ANY WARRANTY ITEMS. THESE ITEMS SHALL BE INCLUDED WITH BID.
- 17. PROVIDE GROUNDING ALONG CONTROLLER WIRE RUN PER MANUFACTURES INSTALLATION RECOMENDATIONS.
- 18. IRRIGATION CONTRACTOR TO REPAIR OR REPLACE ANY EXISTING UTILITY, LOW VOLTAGE WIRE OR OTHER EXISTING EQUIPMENT DAMAGED DURING IRRIGATION INSTALLATION.




RAINBIRD ESP CONTROLLER

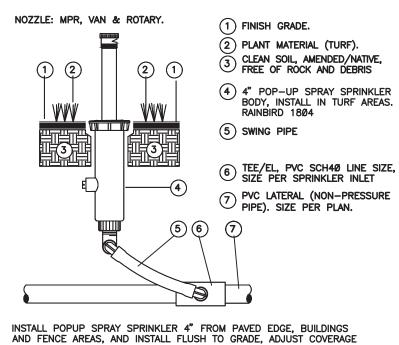

TO AVOID OVERSPRAY ONTO PAVED SURFACES, FENCES, BUILDINGS AND

USE ONLY TEFLON TAPE OR SEALANT ON ALL THREADED CONNECTIONS.




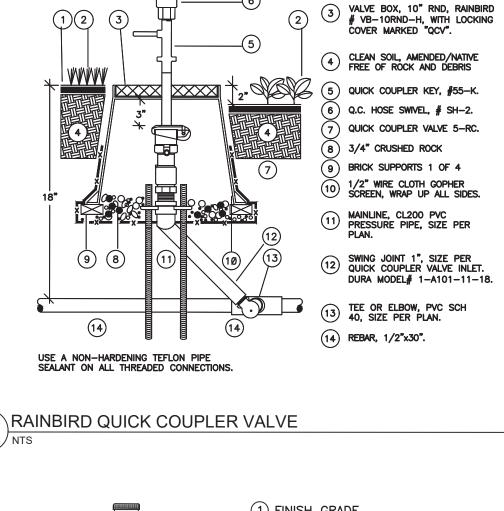

PLANT MATERIAL (TURF, 2) SHRUB OR GROUND COVER)


QCV RAINBIRD MODEL # 5-RC, KEY# 55-K, HOSE SWIVEL # SH-2


(1)(2)(3)

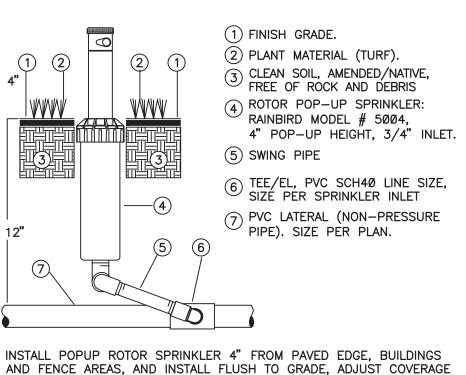


TO AVOID OVERSPRAY ONTO PAVED SURFACES, FENCES, BUILDINGS AND PARKING LOTS. USE ONLY TEFLON TAPE OR SEALANT ON ALL THREADED CONNECTIONS.




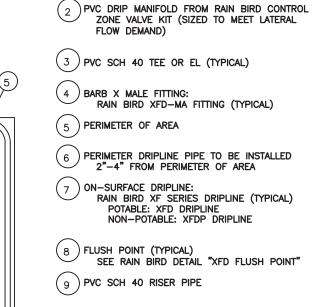

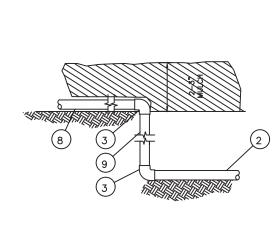

RAINBIRD XFD-.6 X 18" DRIP ZONE

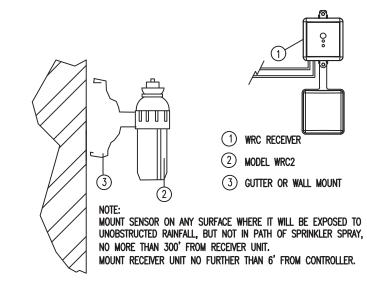

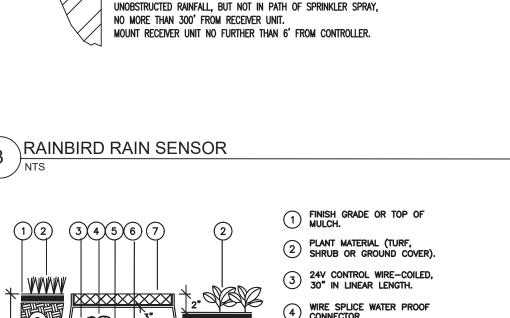


WIRE SPLICE WATER PROOF CONNECTOR. VALVE IDENTIFICATION TAG. REMOTE CONTROL VALVE.) VALVE BOX - 10" ROUND. 8) CLEAN COMPACTED BACKFILL. (17) (9) LATERAL LINE - CL 200 PVC. (10) ELBOW 45^-SCH40 PVC, 1 OF) BRICK SUPPORTS 1 OF 4. 2) 3/4" CRUSHED ROCK. MALE ADAPTER, SCH40 PVC, 1 OF 2.

(14) ELBOW 90^, SCH40 PVC.) TEE/ELBOW, SCH40 PVC. (16) MAINLINE, CL200 - SEE PLAN

NOTES:
INSTALL 45 DEGREE ELBOWS TO ACHIEVE CORRECT DEPTH. USE A
NON-HARDENING TEFLON PIPE SEALANT ON ALL THREADED CONNECTIONS.
MAINLINE DEPTH IS 18" COVER OVER "TOP" OF PVC PIPE.

RAINBIRD PGA ELECTRIC VALVE

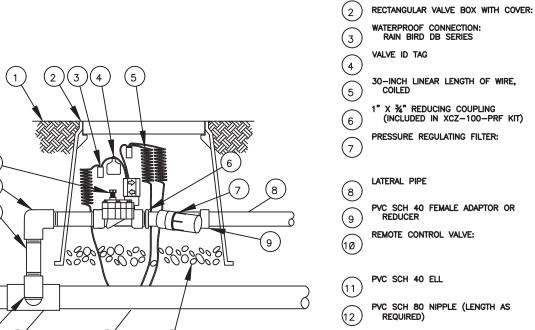

PRESSURE REGULATING FILTER: LATERAL PIPE PVC SCH 40 FEMALE ADAPTOR OR REDUCER REMOTE CONTROL VALVE: PVC SCH 40 ELL

1 FINISH GRADE

PVC SCH 80 NIPPLE (LENGTH AS REQUIRED) PVC SCH 80 NIPPLE (2-INCH LENGTH, HIDDEN) AND PVC SCH 40 ELL) PVC SCH 40 TEE OR ELL PVC MAINLINE

3-INCH MINIMUM DEPTH OF 3/4-INCH WASHED GRAVEL

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Project Number:

Drawn by:

DB

Date:

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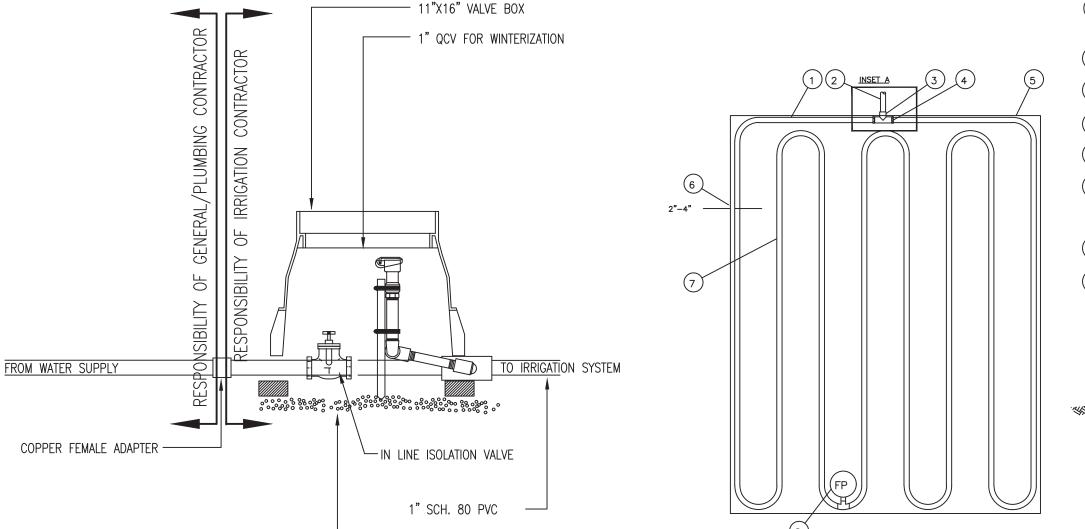
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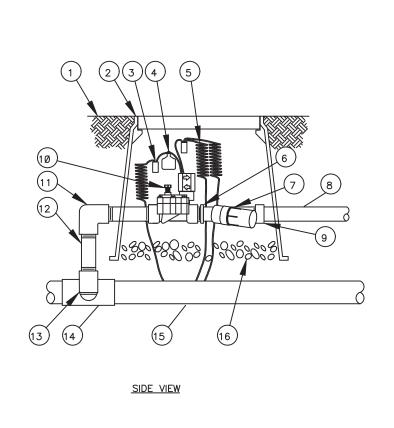
SECTION

SECTION



— 3" PEA GRAVEL

' POINT OF CONNECTION



SECTION

NOTE: IN PLANTERS THAT HAVE A SINGLE ROW OF PLANT MATERIAL A DRIP TUBE SHALL EXTEND ALONG EACH SIDE OF THE PLANT MATERIAL TO PROVIDE 2 DRIP LINES FOR THE

