
# NORTH HILL SHOPPING CENTER

1467 N. ROCHESTER ROAD
CITY OF ROCHESTER HILLS, OAKLAND COUNTY, MICHIGAN

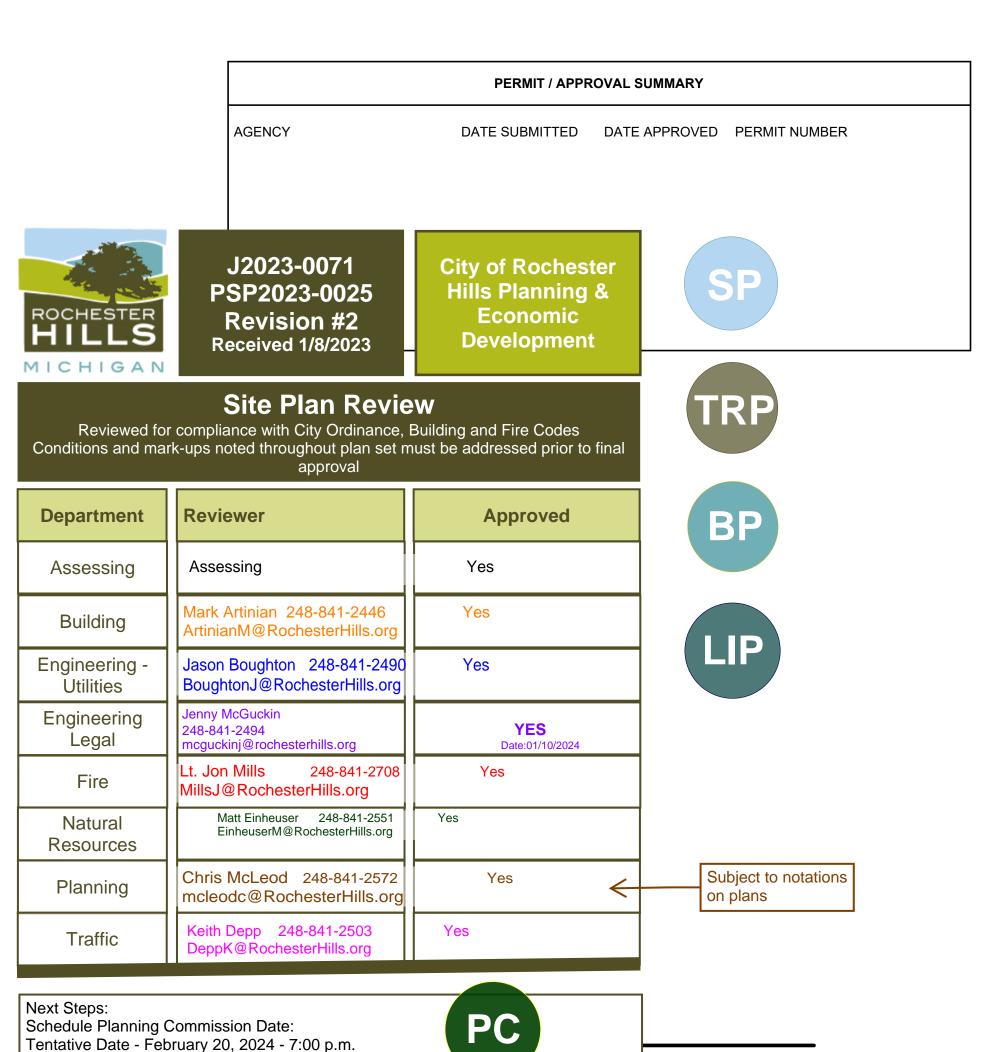

W. TIENKEN

SITE


WALTON BLVD.

AVON RD

AVON RD

LOCATION MAP

NO SCALE

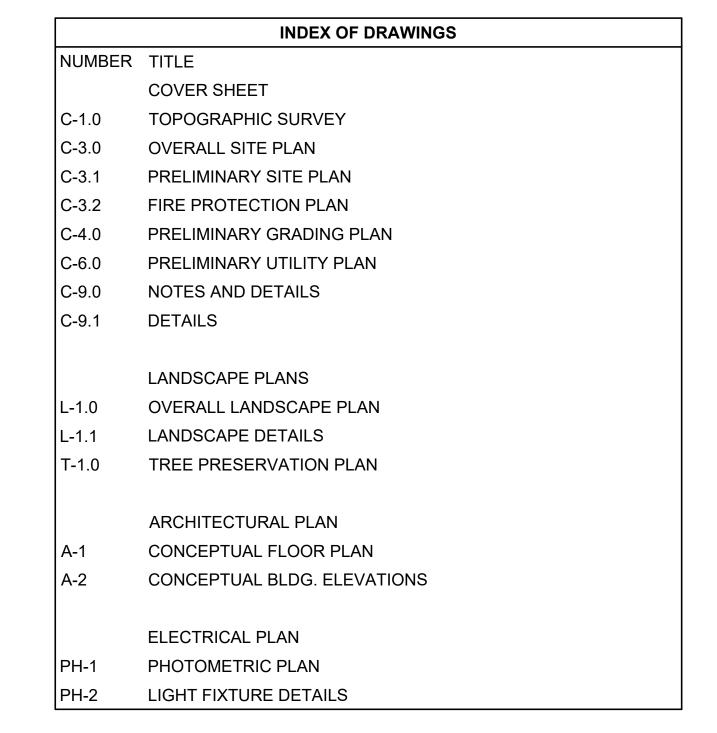

CIVIL ENGINEER

MARKUS MANAGEMENT GROUP 251 E. MERRILL - SUITE 205 BIRMINGHAM, MI 48009 CONTACT: DORAID MARKUS PHONE: 248.203.9090 EMAIL: DMARKUS@MARKUSLLC.COM

ARCHITECT


ROGVOY ARCHITECTS 32500 TELEGRAPH ROAD BINGHAM FARMS, MI 48025 CONTACT: MARK DRANE PHONE: 248.540.7700


EMAIL: MDRANE@ROGVOY.COM

PEA GROUP 1849 POND RUN AUBURN HILLS, MI 48326 CONTACT: JAMES P. BUTLER, PE PHONE: 844.813.2949 EMAIL: JBUTLER@PEAGROUP.COM


LANDSCAPE ARCHITECT

PEA GROUP
7927 NEMCO WAY, STE. 115
BRIGHTON, MI 48116
CONTACT: JANET EVANS, PLA
PHONE: 844.813.2949
EMAIL: JEVANS@PEAGROUP.COM

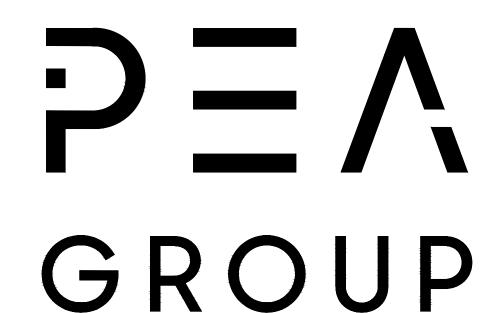

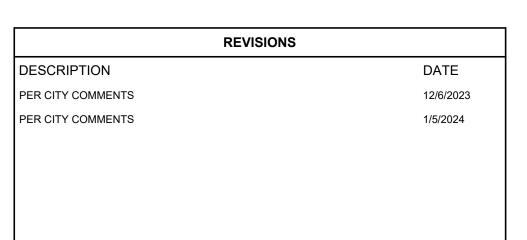




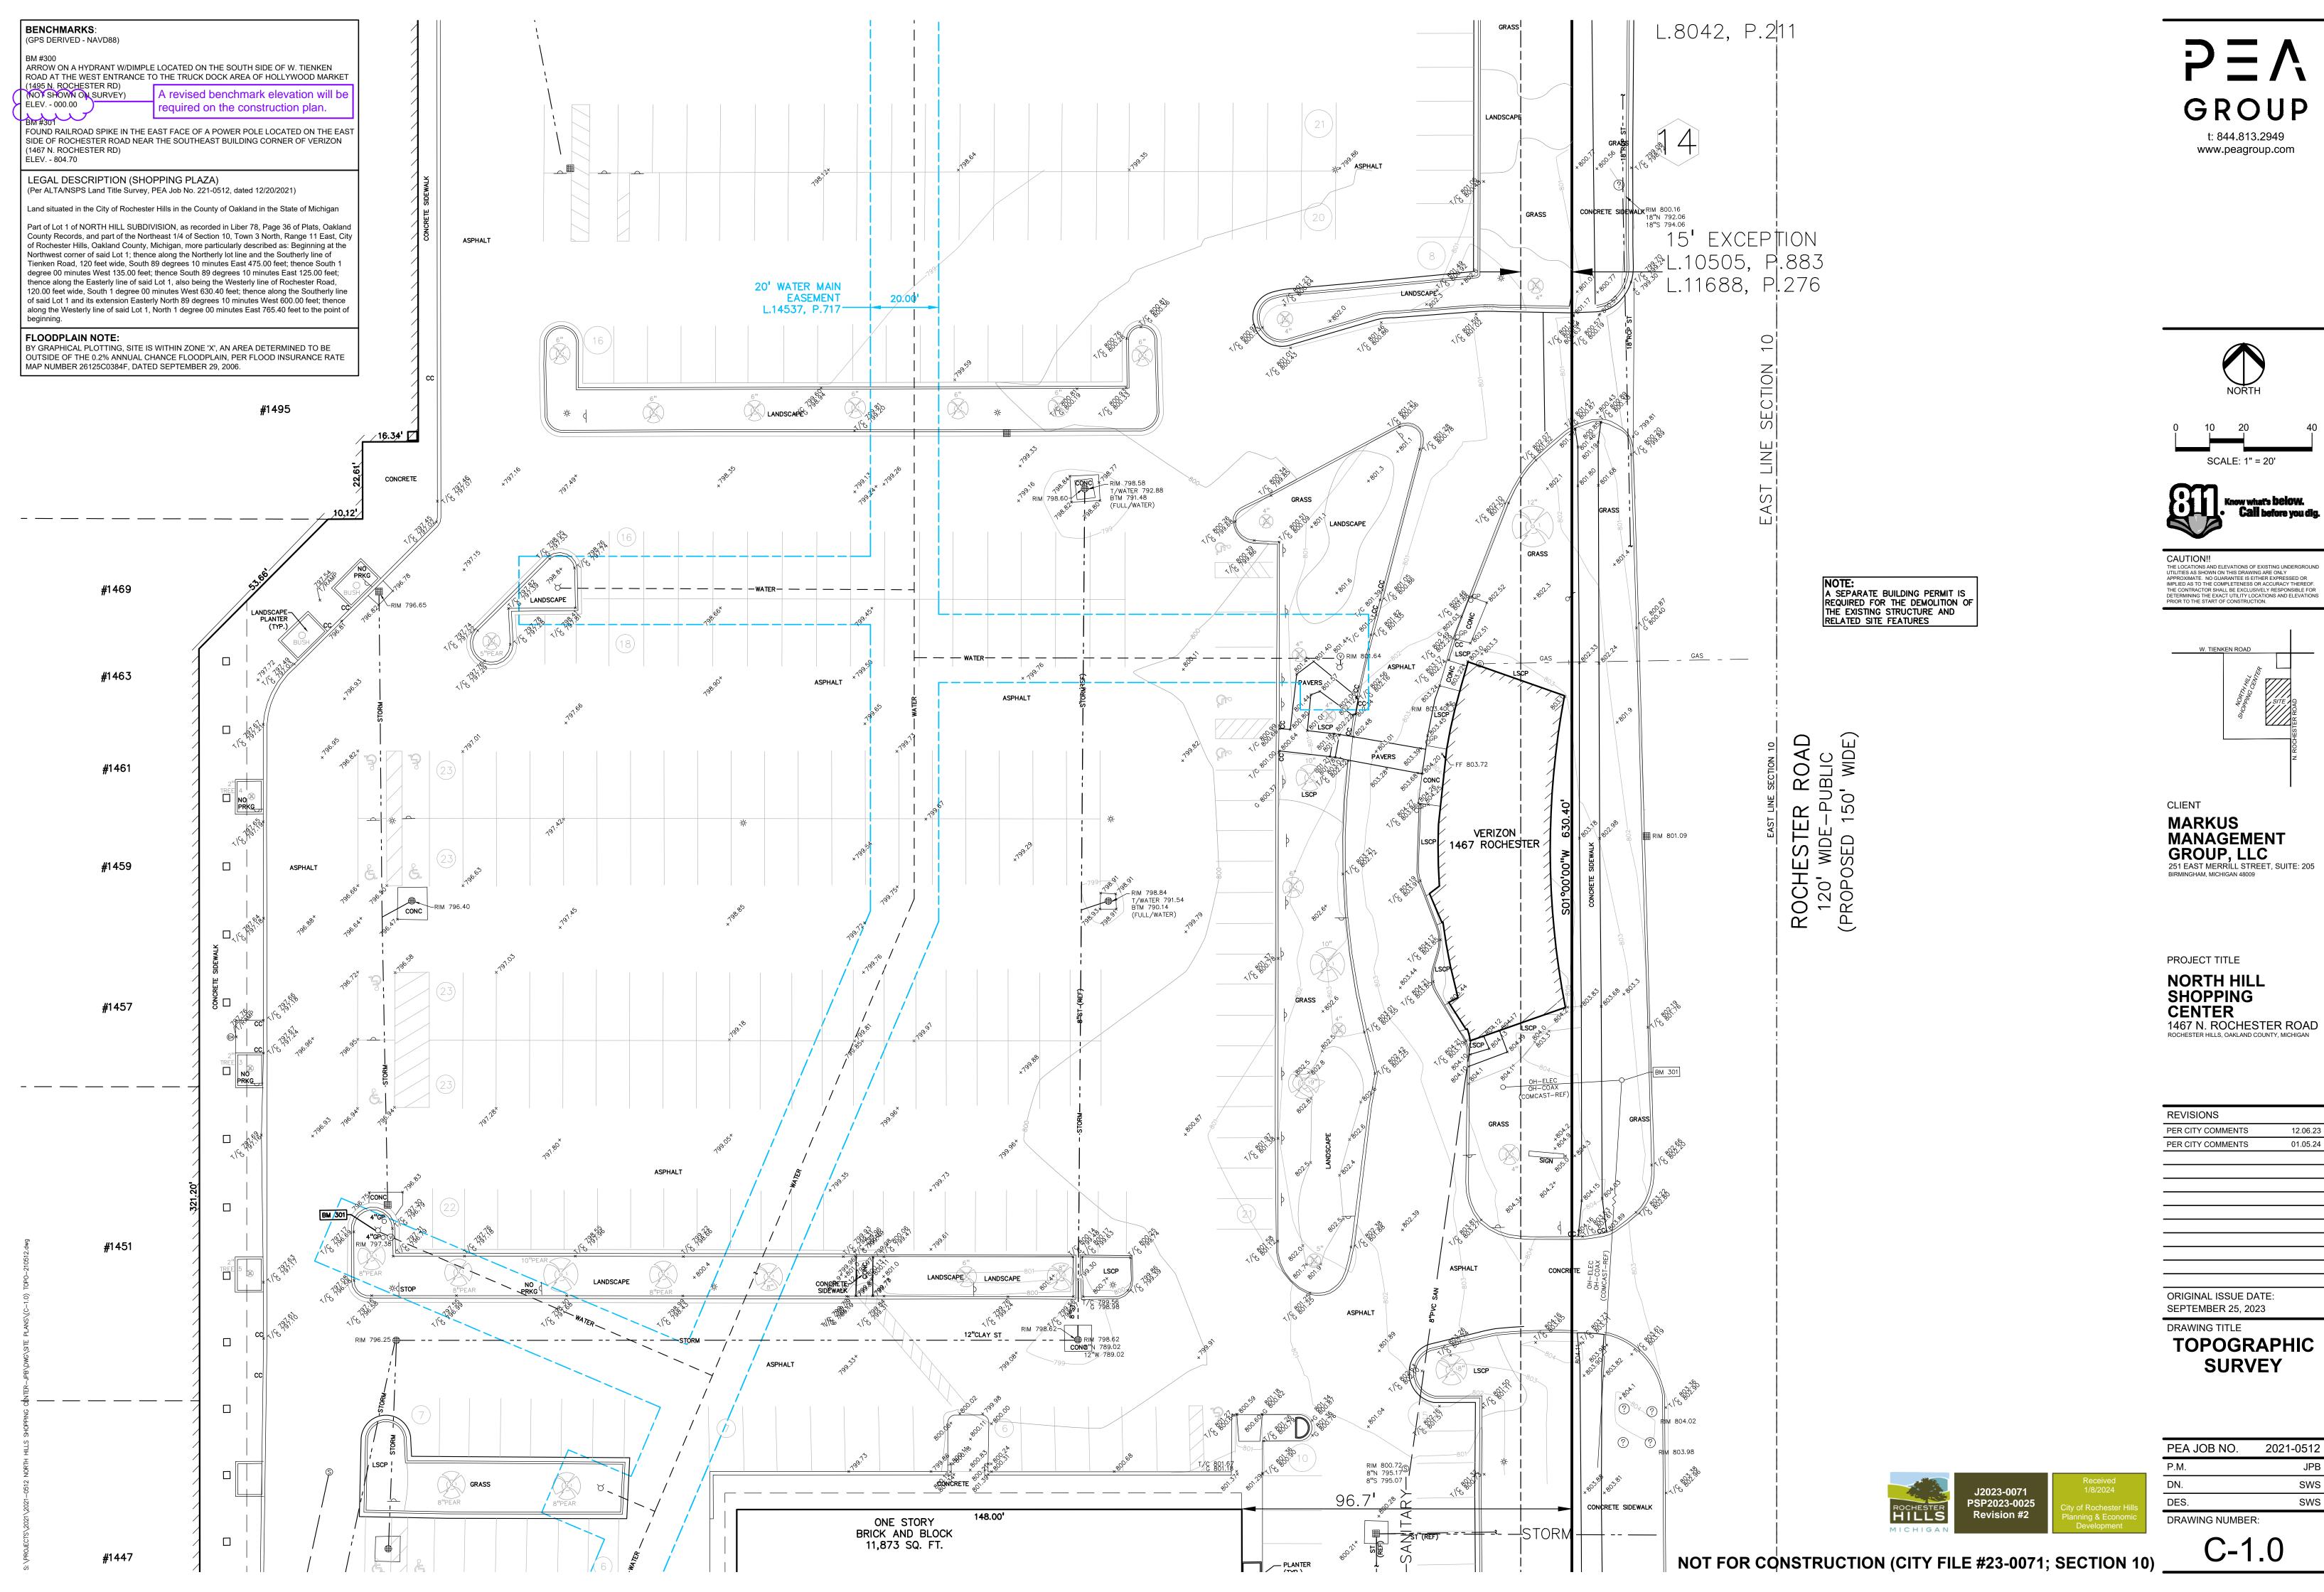




THE LOCATIONS AND ELEVATIONS OF EXISTING UNDERGROUND UTILITIES AS SHOWN ON THIS DRAWING ARE ONLY APPROXIMATE. NO GUARANTEE IS EITHER EXPRESSED OR IMPLIED AS TO THE COMPLETENESS OR ACCURACY THEREOF. THE CONTRACTOR SHALL BE EXCLUSIVELY RESPONSIBLE FOR DETERMINING THE EXACT UTILITY LOCATIONS AND ELEVATIONS PRIOR TO THE START OF CONSTRUCTION.

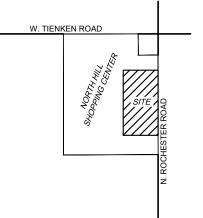



REVISIONS	
PER CITY COMMENTS	12.06.23
PER CITY COMMENTS	01.05.24

	PEA JOB NO.	2021-0512
	P.M.	JPB
Hills omic	DN.	SWS
	DES.	SWS
	DRAWING NUMBER:	

## BENCHMARKS: (GPS DERIVED - NAVD88) BM #300 ARROW ON A HYDRANT W/DIMPLE LOCATED ON THE SOUTH SIDE OF W. TIENKEN ROAD AT THE WEST ENTRANCE TO THE TRUCK DOCK AREA OF HOLLYWOOD MARKET (1495 N. ROCHESTER RD) (NOT SHOWN ON SURVEY) ELEV. - 000.00 BM #301 FOUND RAILROAD SPIKE IN THE EAST FACE OF A POWER POLE LOCATED ON THE EAST SIDE OF ROCHESTER ROAD NEAR THE SOUTHEAST BUILDING CORNER OF VERIZON (1467 N. ROCHESTER RD) ELEV. - 804.70 LEGAL DESCRIPTION (SHOPPING PLAZA) (Per ALTA/NSPS Land Title Survey, PEA Job No. 221-0512, dated 12/20/2021) Land situated in the City of Rochester Hills in the County of Oakland in the State of Michigan Part of Lot 1 of NORTH HILL SUBDIVISION, as recorded in Liber 78, Page 36 of Plats, Oakland County Records, and part of the Northeast 1/4 of Section 10, Town 3 North, Range 11 East, City of Rochester Hills, Oakland County, Michigan, more particularly described as: Beginning at the Northwest corner of said Lot 1; thence along the Northerly lot line and the Southerly line of Tienken Road, 120 feet wide, South 89 degrees 10 minutes East 475.00 feet; thence South 1 degree 00 minutes West 135.00 feet; thence South 89 degrees 10 minutes East 125.00 feet; thence along the Easterly line of said Lot 1, also being the Westerly line of Rochester Road, 120.00 feet wide, South 1 degree 00 minutes West 630.40 feet; thence along the Southerly line of said Lot 1 and its extension Easterly North 89 degrees 10 minutes West 600.00 feet; thence along the Westerly line of said Lot 1, North 1 degree 00 minutes East 765.40 feet to the point of FLOODPLAIN NOTE: BY GRAPHICAL PLOTTING, SITE IS WITHIN ZONE 'X', AN AREA DETERMINED TO BE OUTSIDE OF THE 0.2% ANNUAL CHANCE FLOODPLAIN, PER FLOOD INSURANCE RATE MAP NUMBER 26125C0384F, DATED SEPTEMBER 29, 2006.

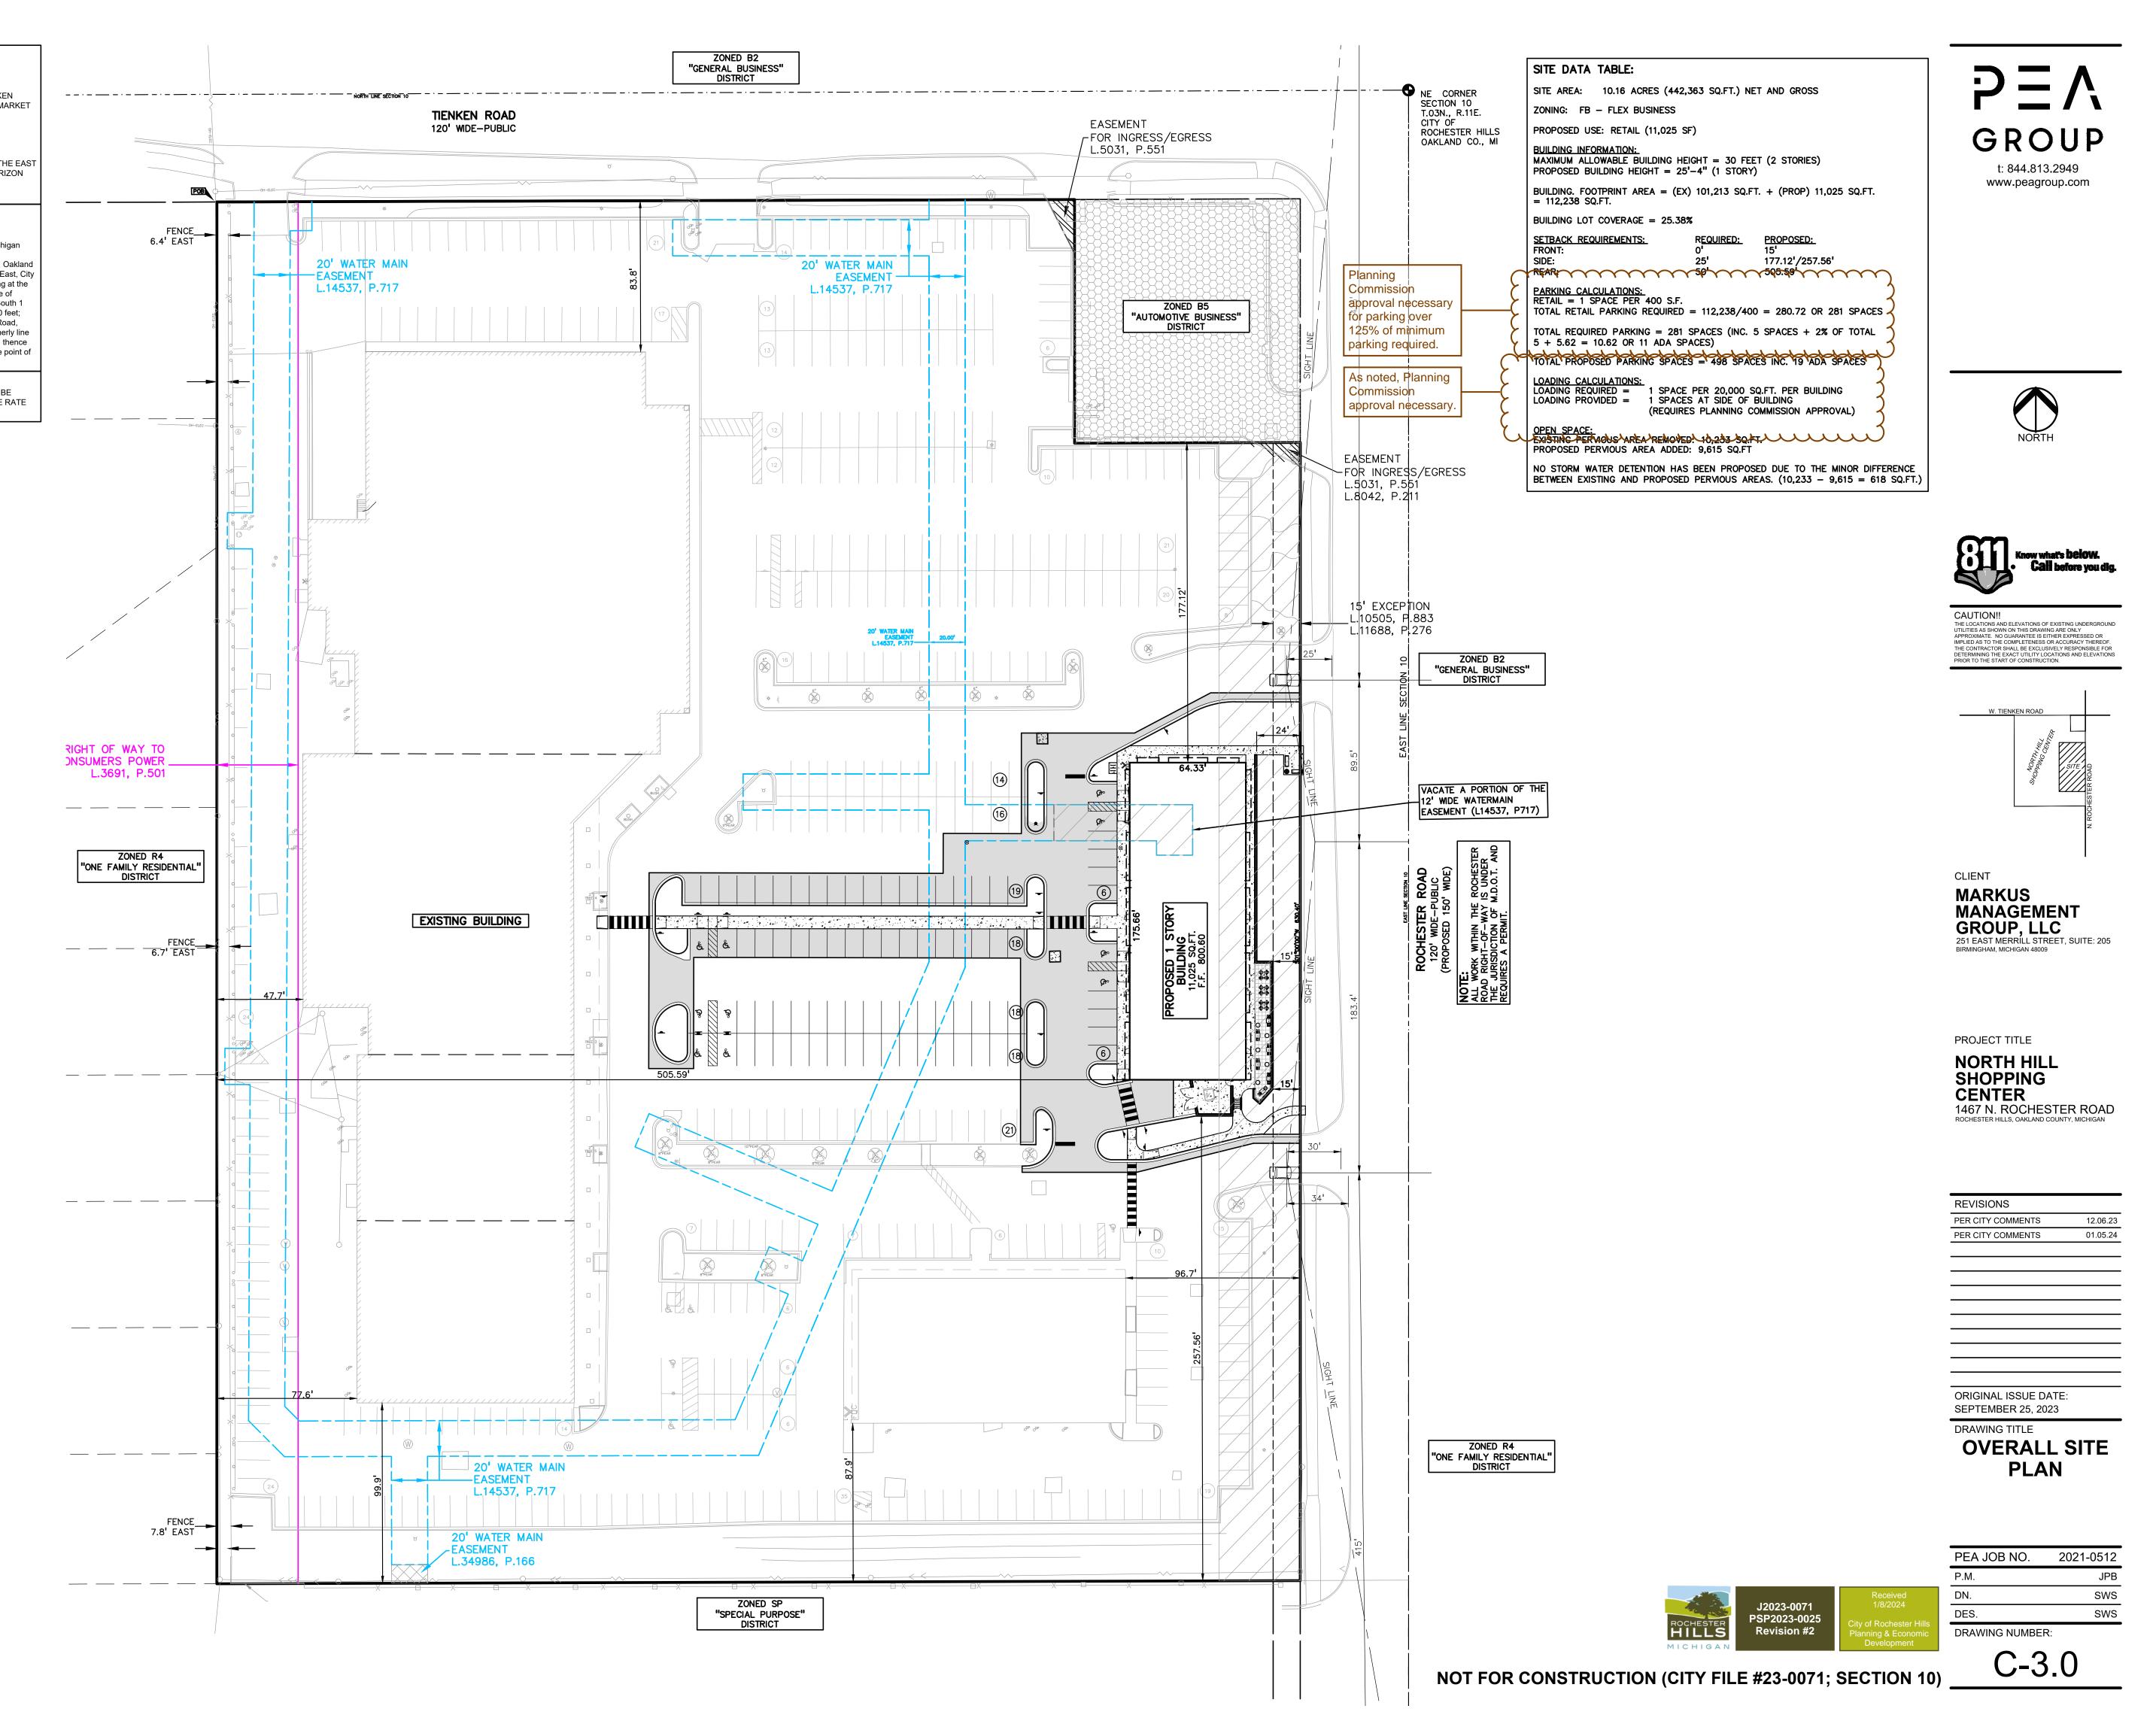

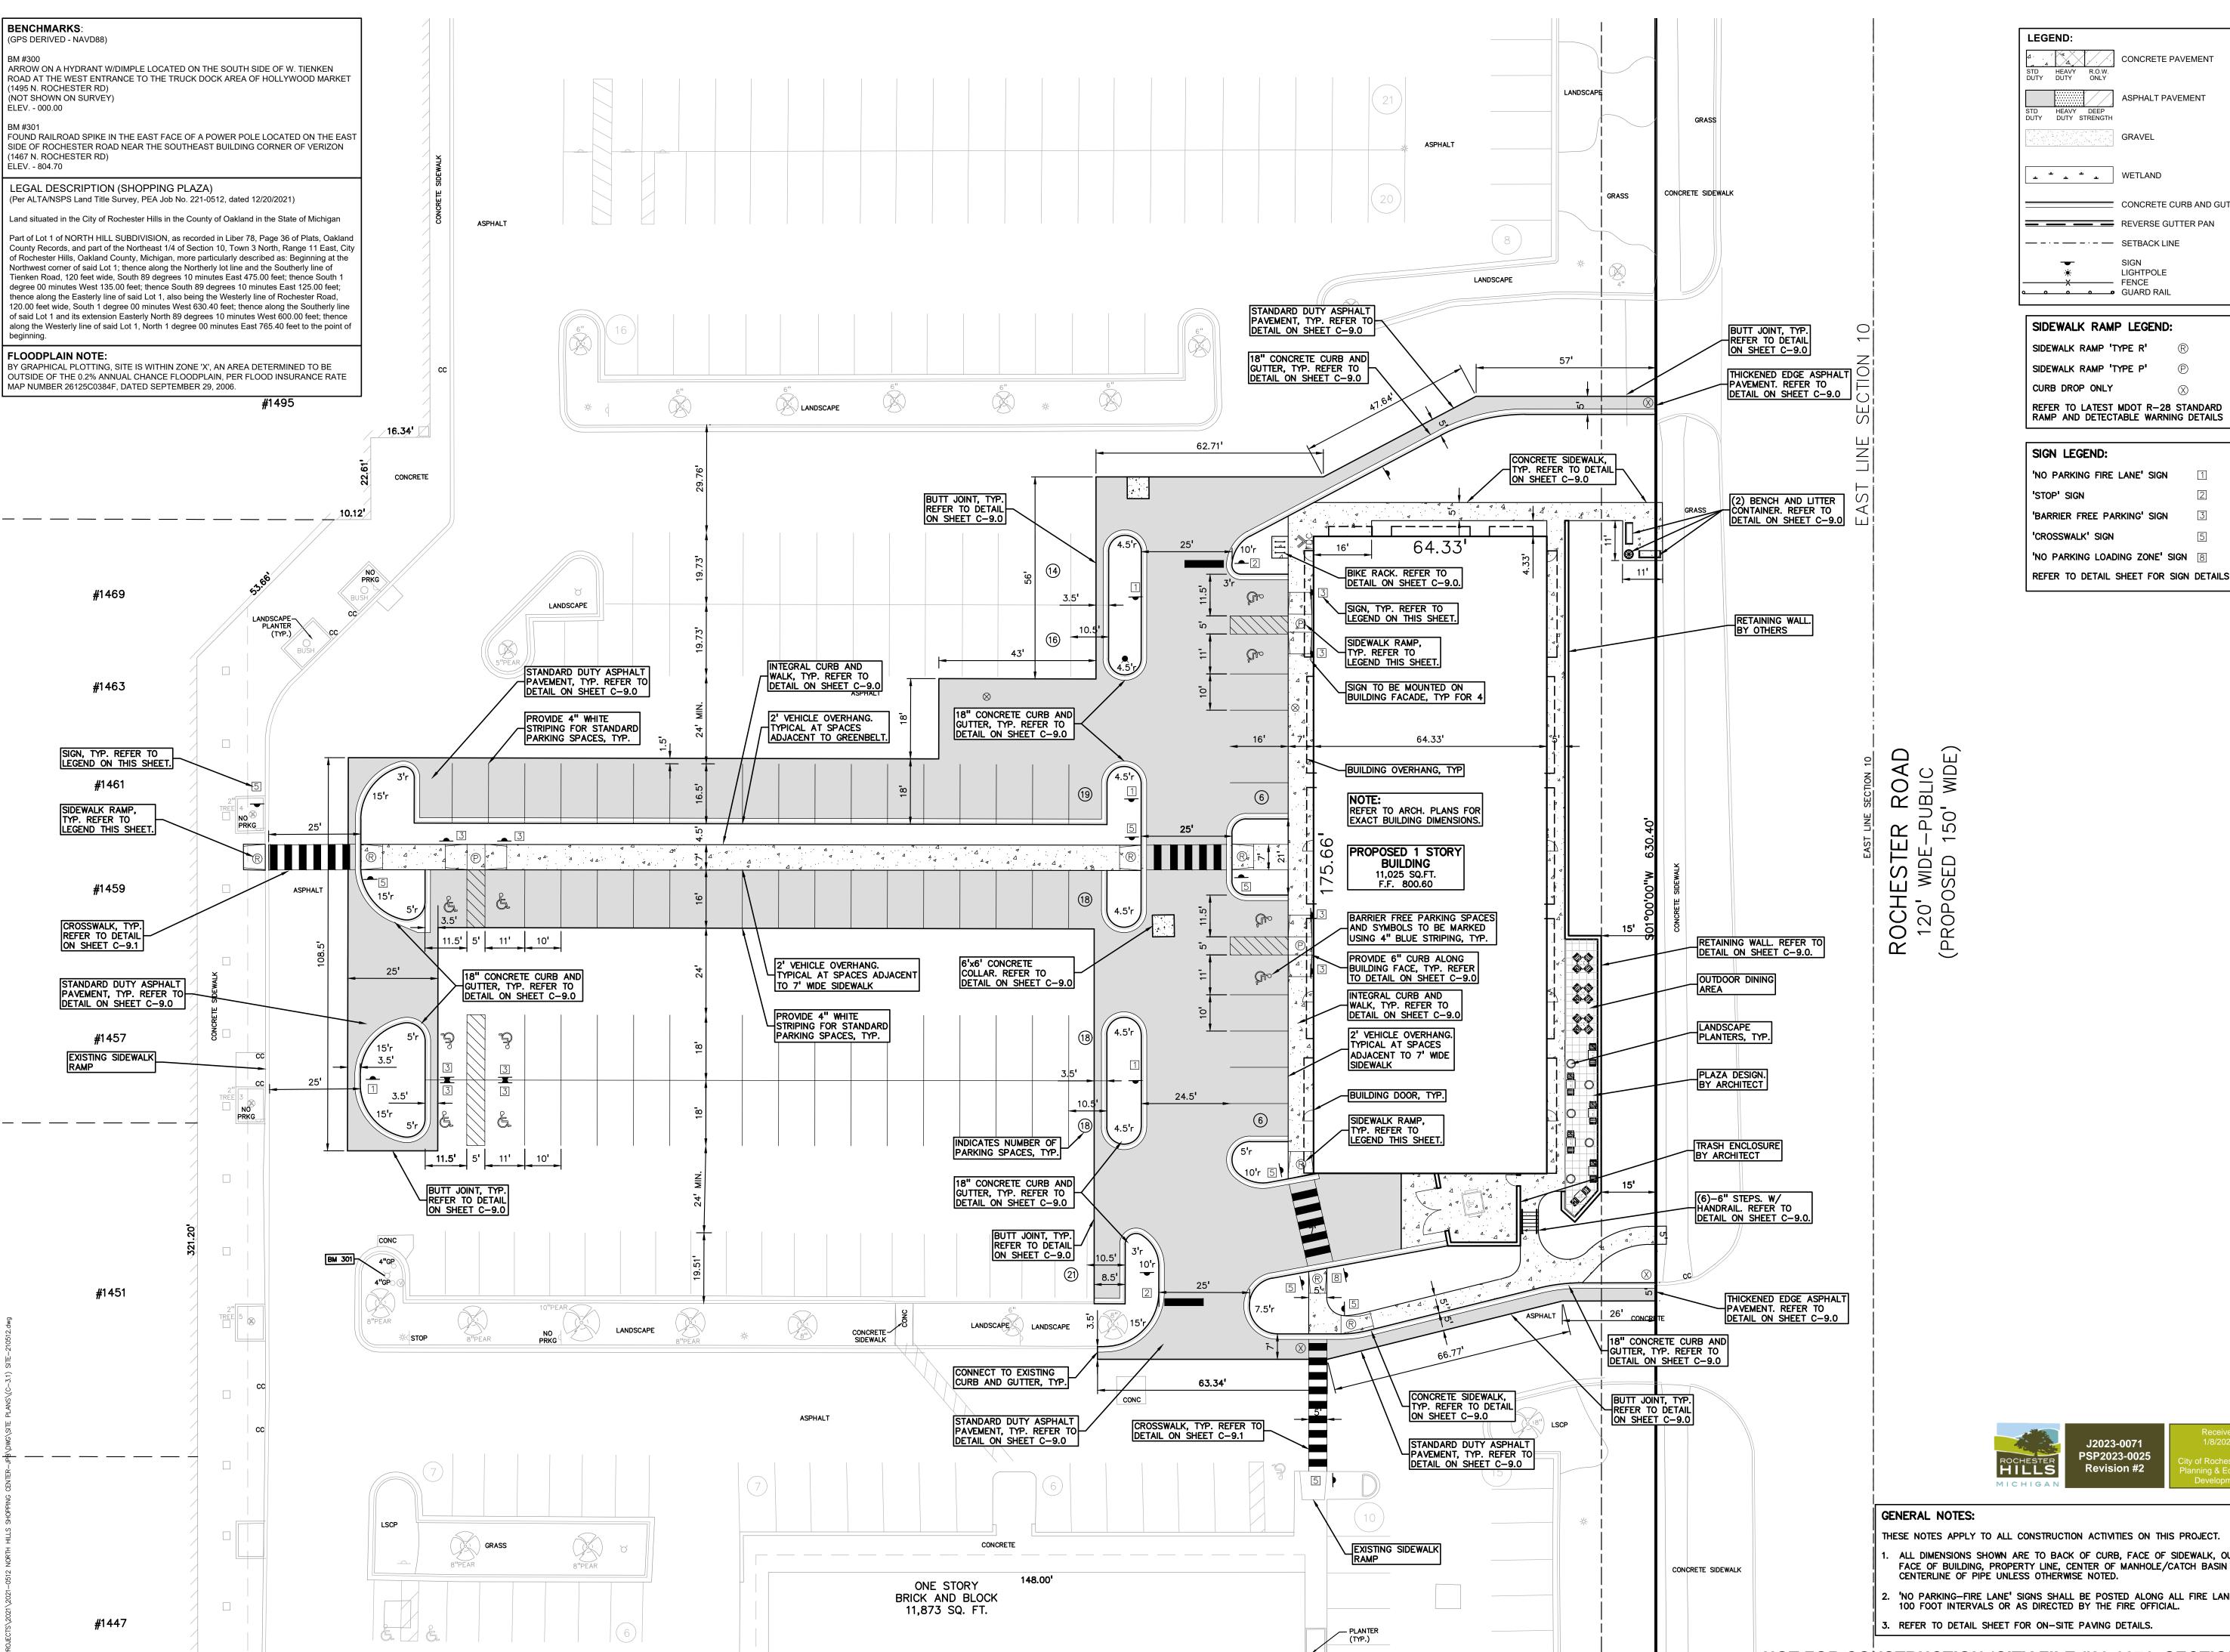

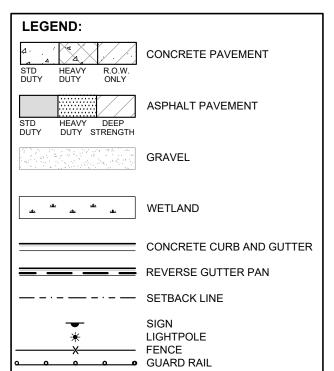

t: 844.813.2949 www.peagroup.com

SIDEWALK RAMP LEGEND: SIDEWALK RAMP 'TYPE R' SIDEWALK RAMP 'TYPE P' CURB DROP ONLY


SIGN LEGEND: 'NO PARKING FIRE LANE' SIGN 'BARRIER FREE PARKING' SIGN 'CROSSWALK' SIGN 'NO PARKING LOADING ZONE' SIGN 8



SCALE: 1" = 20'



CAUTION!! THE LOCATIONS AND ELEVATIONS OF EXISTING UNDERGROUN UTILITIES AS SHOWN ON THIS DRAWING ARE ONLY APPROXIMATE. NO GUARANTEE IS EITHER EXPRESSED OR IMPLIED AS TO THE COMPLETENESS OR ACCURACY THEREOI THE CONTRACTOR SHALL BE EXCLUSIVELY RESPONSIBLE FOR DETERMINING THE EXACT UTILITY LOCATIONS AND ELEVATIONS PRIOR TO THE START OF CONSTRUCTION.

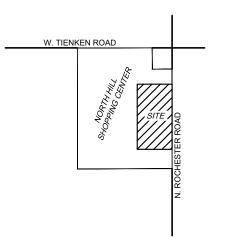

CLIENT

**MARKUS MANAGEMENT** GROUP, LLC 251 EAST MERRILL STREET, SUITE: 205 BIRMINGHAM, MICHIGAN 48009

PROJECT TITLE

**NORTH HILL SHOPPING** CENTER 1467 N. ROCHESTER ROAD

REVISIONS PER CITY COMMENTS 12.06.23 PER CITY COMMENTS 01.05.24

ORIGINAL ISSUE DATE:

**SEPTEMBER 25, 2023** DRAWING TITLE

**SITE PLAN** 




THESE NOTES APPLY TO ALL CONSTRUCTION ACTIVITIES ON THIS PROJECT.

ALL DIMENSIONS SHOWN ARE TO BACK OF CURB, FACE OF SIDEWALK, OUTSIDE FACE OF BUILDING, PROPERTY LINE, CENTER OF MANHOLE/CATCH BASIN OR CENTERLINE OF PIPE UNLESS OTHERWISE NOTED.


2. 'NO PARKING-FIRE LANE' SIGNS SHALL BE POSTED ALONG ALL FIRE LANES AT 100 FOOT INTERVALS OR AS DIRECTED BY THE FIRE OFFICIAL.


NOT FOR CONSTRUCTION (CITY FILE #23-0071; SECTION 10)

PEA JOB NO. 2021-0512 JPB SWS DES. SWS DRAWING NUMBER:

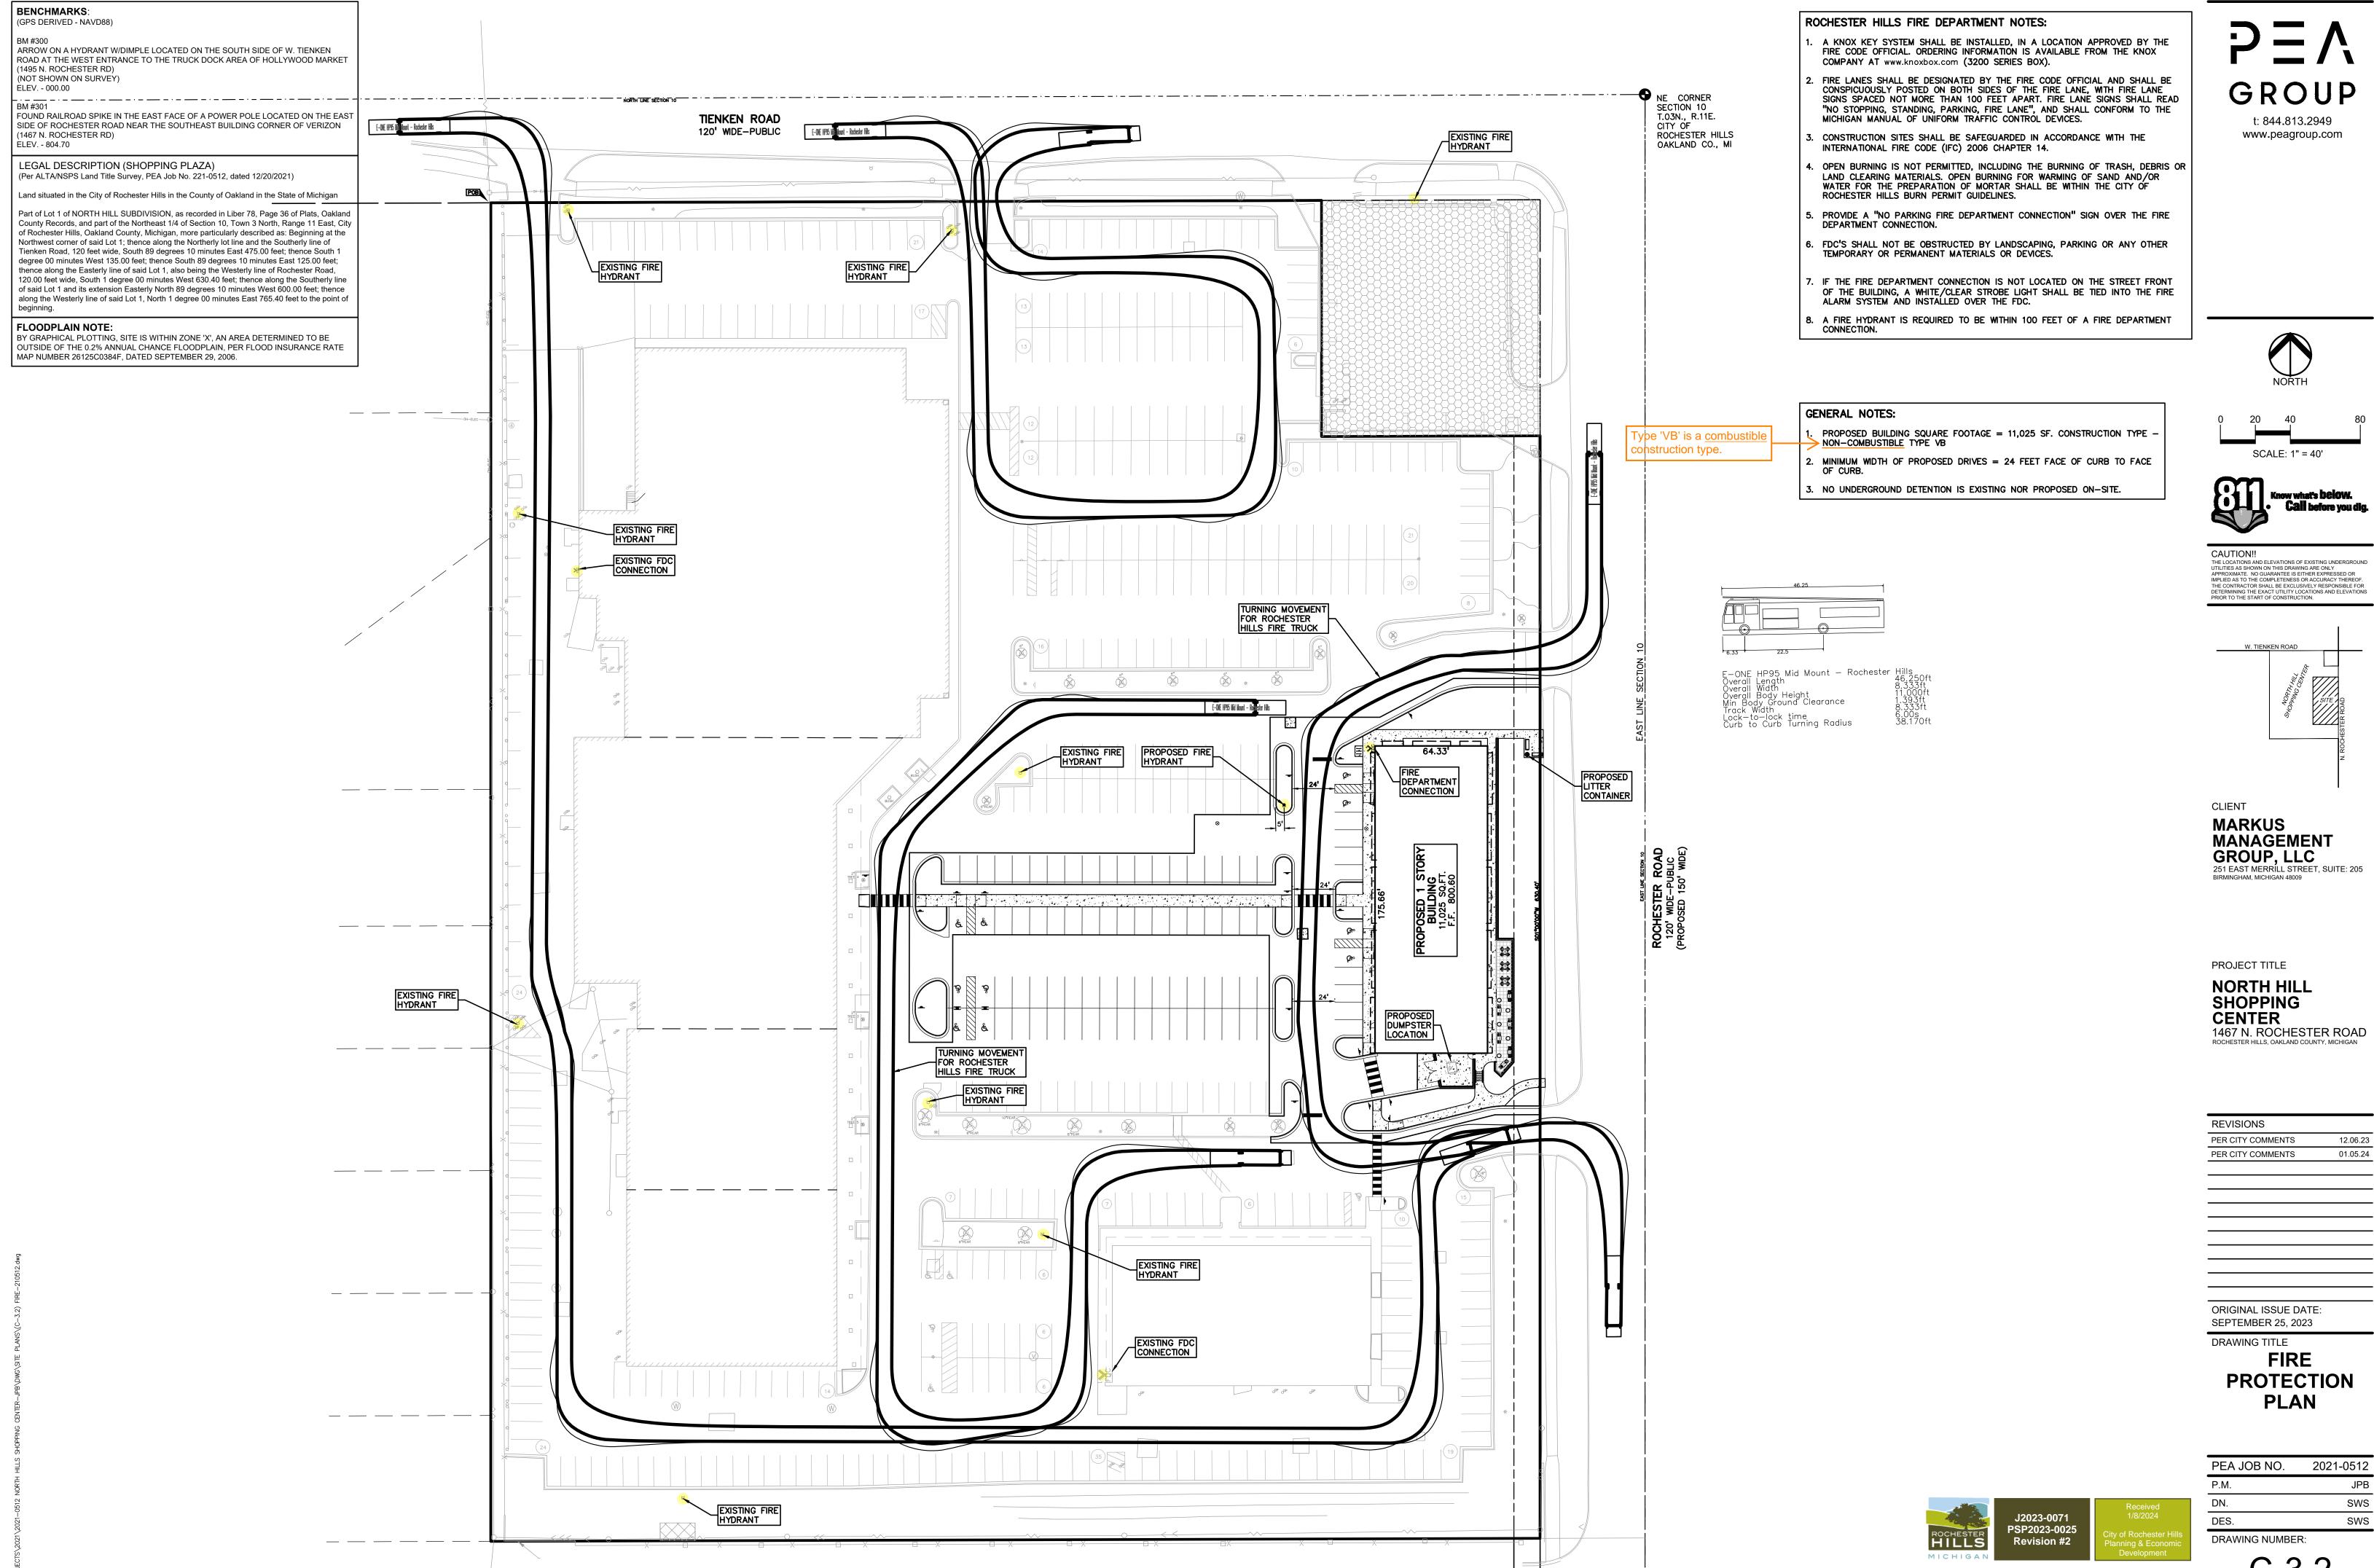

THE LOCATIONS AND ELEVATIONS OF EXISTING UNDERGROUND UTILITIES AS SHOWN ON THIS DRAWING ARE ONLY UTILITIES AS SHOWN ON THIS DRAWING ARE ONLY
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 EXISTING CONTOUR ——922—— PROPOSED CONTOUR

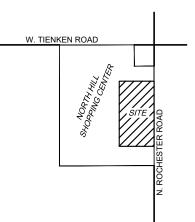PROPOSED REVERSE GUTTER PAN - — — — — PROPOSED RIDGE LINE

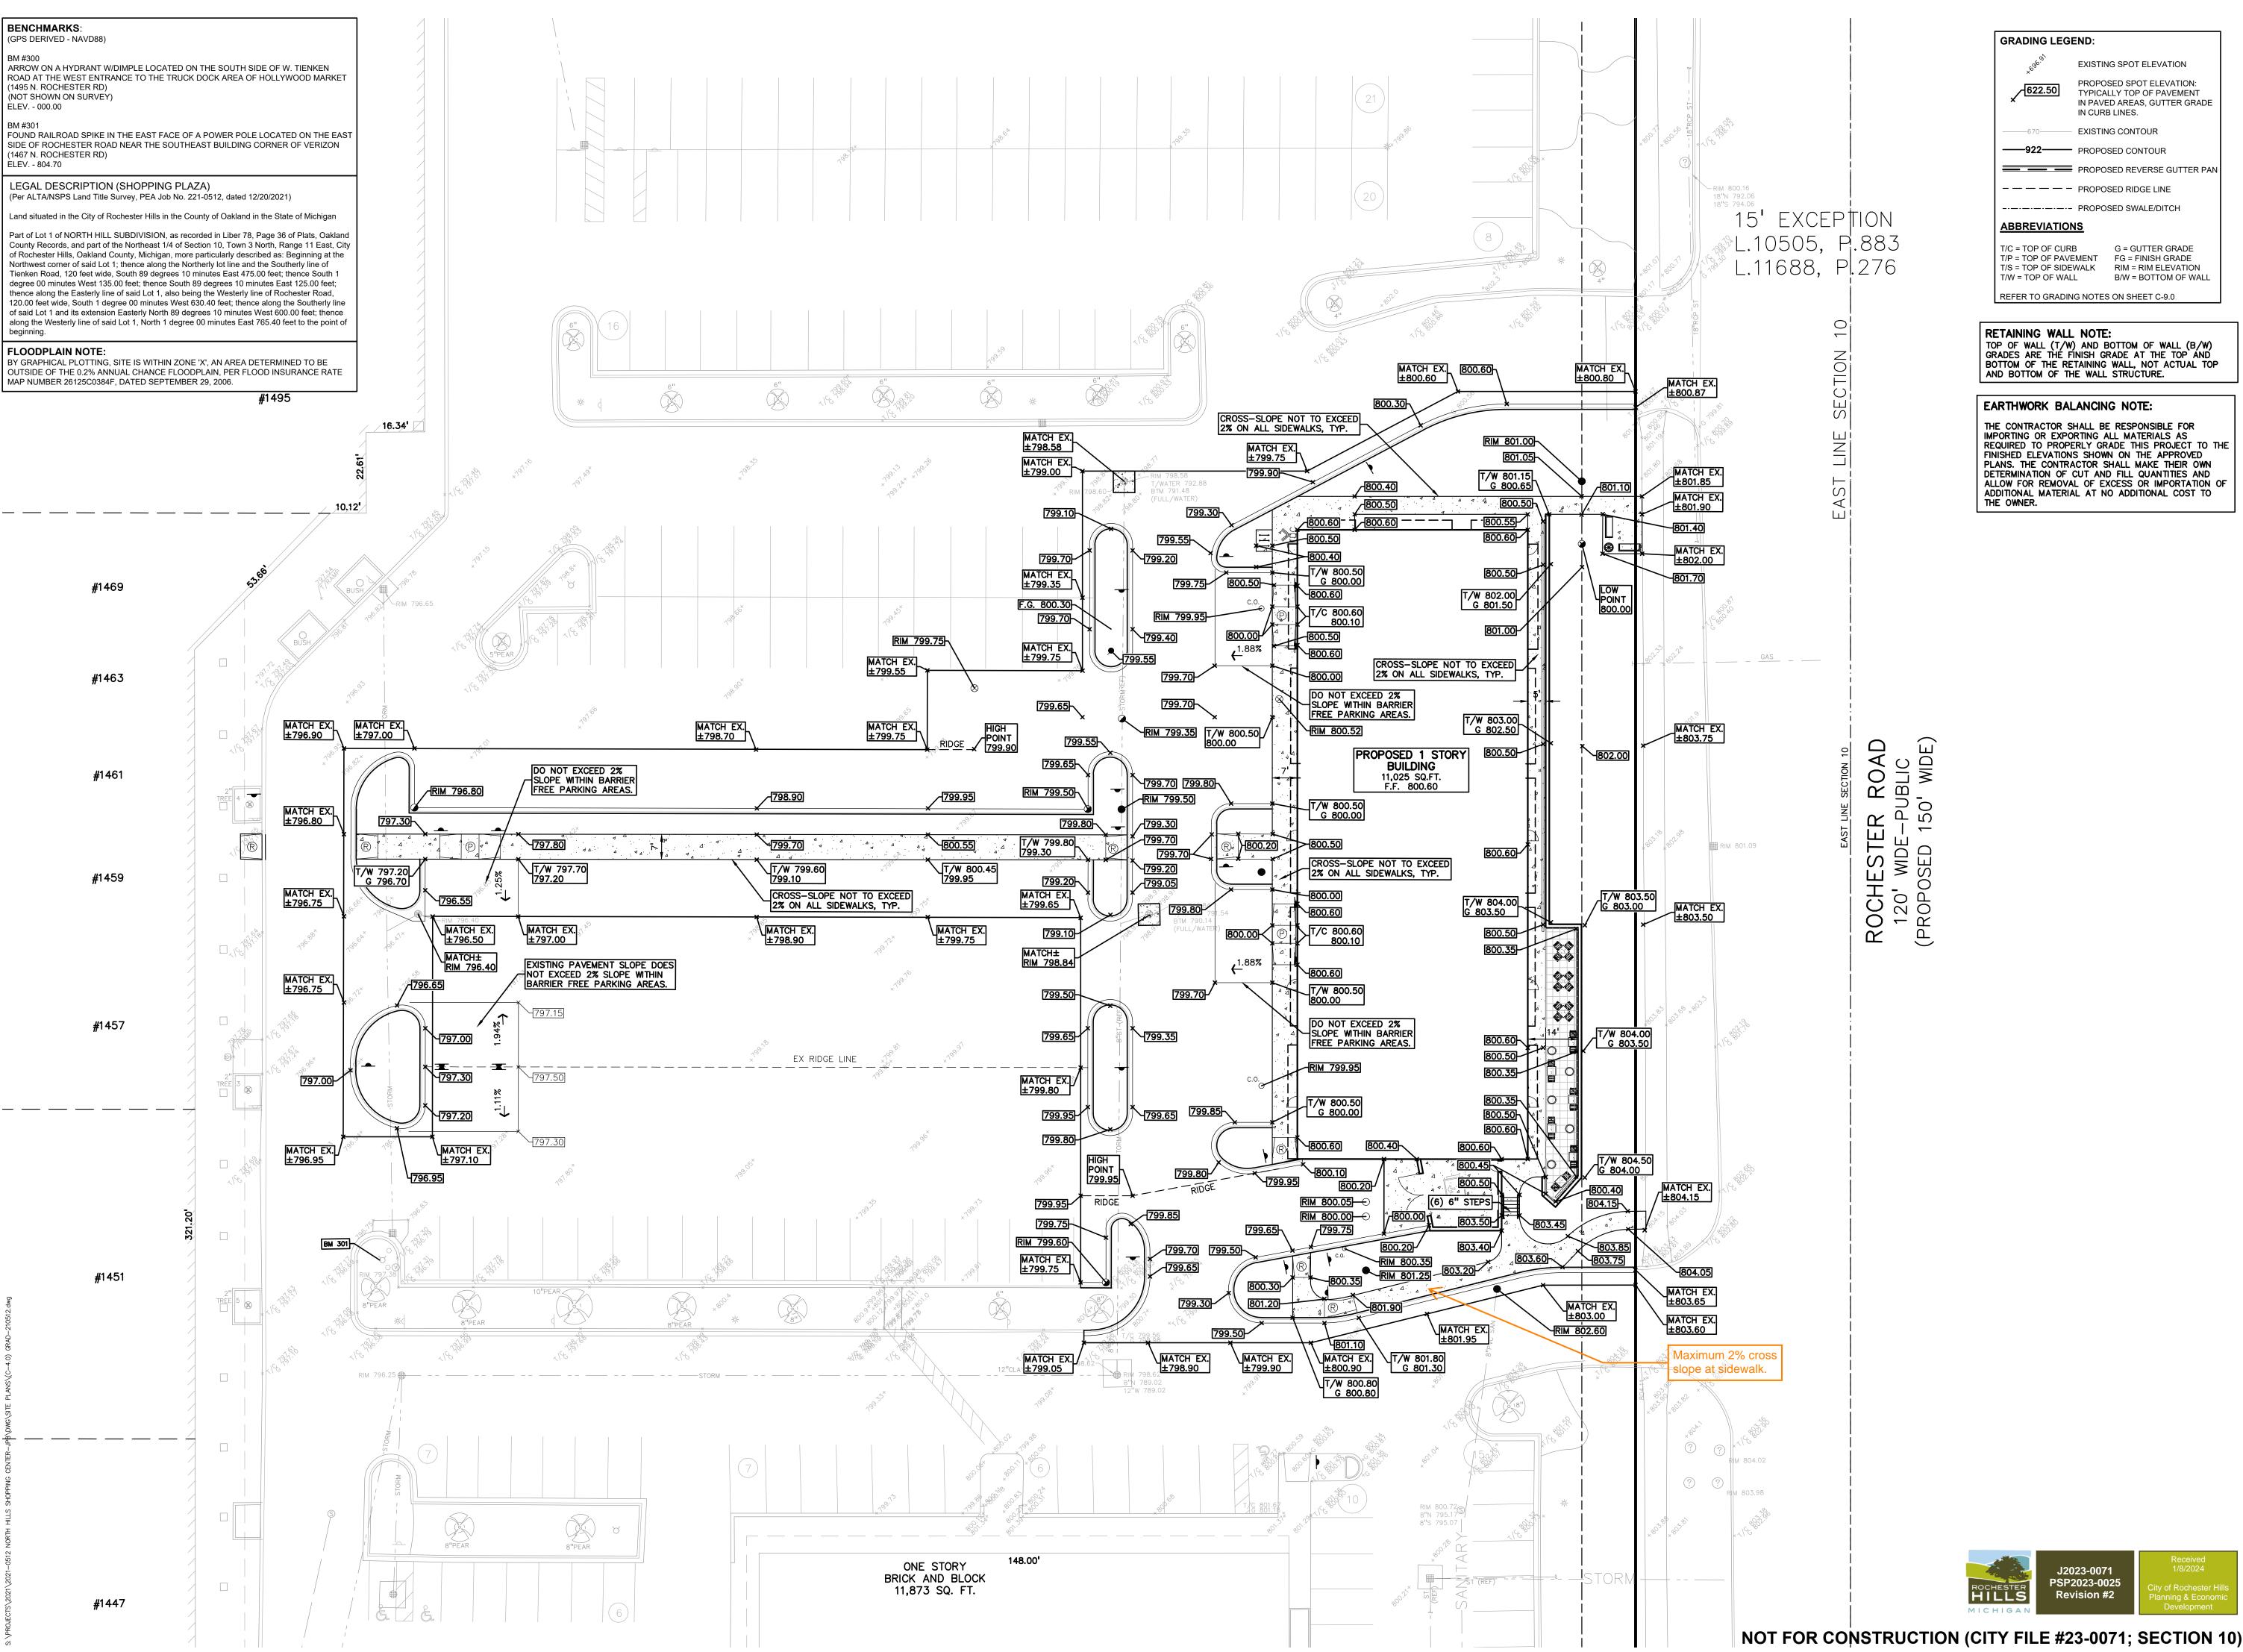G = GUTTER GRADE T/P = TOP OF PAVEMENT FG = FINISH GRADE T/S = TOP OF SIDEWALK RIM = RIM ELEVATION


REFER TO GRADING NOTES ON SHEET C-9.0.

TOP OF WALL (T/W) AND BOTTOM OF WALL (B/W) GRADES ARE THÉ FÍNISH GRADE AT THE TOP AND BOTTOM OF THE RETAINING WALL, NOT ACTUAL TOP

## EARTHWORK BALANCING NOTE:


THE CONTRACTOR SHALL BE RESPONSIBLE FOR IMPORTING OR EXPORTING ALL MATERIALS AS REQUIRED TO PROPERLY GRADE THIS PROJECT TO THE FINISHED ELEVATIONS SHOWN ON THE APPROVED PLANS. THE CONTRACTOR SHALL MAKE THEIR OWN DETERMINATION OF CUT AND FILL QUANTITIES AND ALLOW FOR REMOVAL OF EXCESS OR IMPORTATION OF ADDITIONAL MATERIAL AT NO ADDITIONAL COST TO



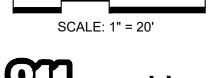



THE LOCATIONS AND ELEVATIONS OF EXISTING UNDERGROUN UTILITIES AS SHOWN ON THIS DRAWING ARE ONLY APPROXIMATE. NO GUARANTEE IS EITHER EXPRESSED OR IMPLIED AS TO THE COMPLETENESS OR ACCURACY THEREOF. THE CONTRACTOR SHALL BE EXCLUSIVELY RESPONSIBLE FOR DETERMINING THE PAGE THE CONTRACTOR SHALL BE EXCLUSIVELY RESPONSIBLE FOR DETERMINING THE PAGE DETERMINING THE EXACT UTILITY LOCATIONS AND ELEVATIONS PRIOR TO THE START OF CONSTRUCTION.

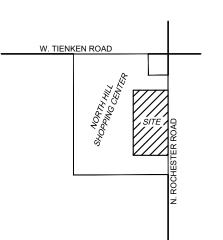

CLIENT

**MARKUS** MANAGEMENT GROUP, LLC 251 EAST MERRILL STREET, SUITE: 205 BIRMINGHAM MICHICAN 48000 BIRMINGHAM, MICHIGAN 48009

PROJECT TITLE


NORTH HILL SHOPPING CENTER 1467 N. ROCHESTER ROAD ROCHESTER HILLS, OAKLAND COUNTY, MICHIGAN

REVISIONS PER CITY COMMENTS PER CITY COMMENTS

ORIGINAL ISSUE DATE: **SEPTEMBER 25, 2023** 

DRAWING TITLE **PRELIMINARY GRADING PLAN** 

PEA JOB NO. 2021-0512 SWS SWS DES. DRAWING NUMBER:

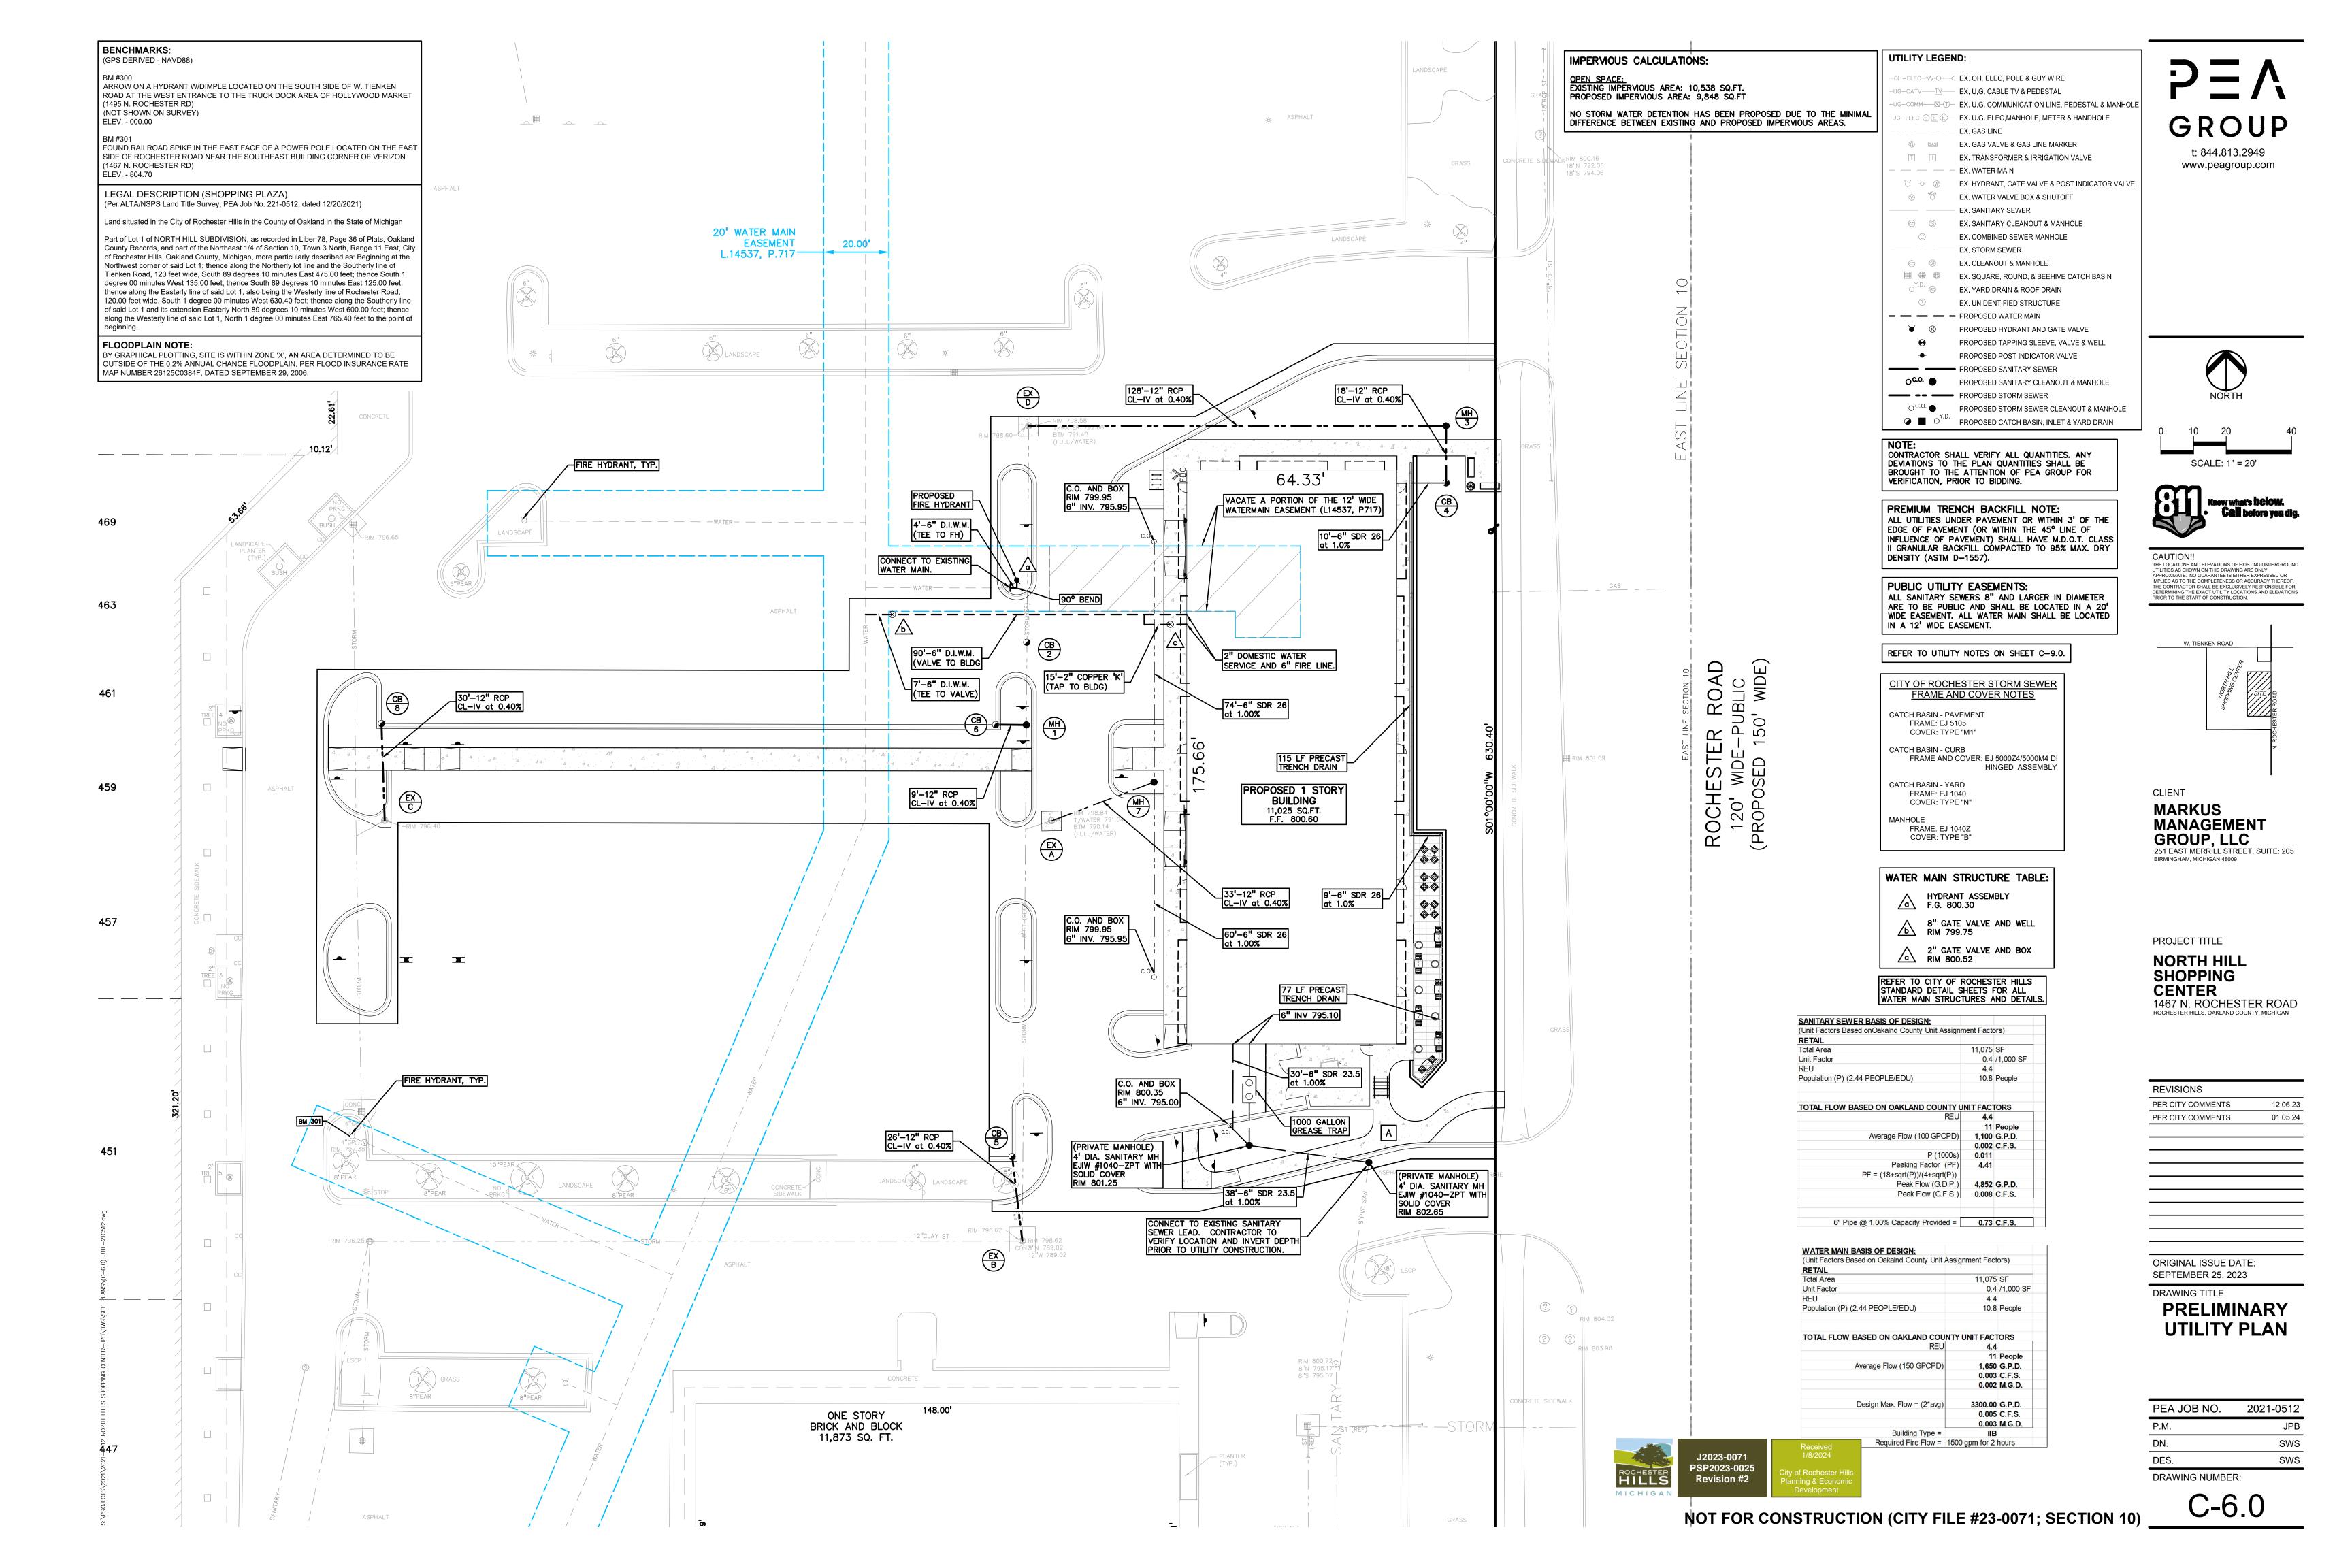

## **GENERAL NOTES:**

## THESE NOTES APPLY TO ALL CONSTRUCTION ACTIVITIES ON THIS PROJECT.

- ALL CONSTRUCTION, WORKMANSHIP AND MATERIALS SHALL BE IN ACCORDANCE WITH CURRENT OSHA, MDOT AND MUNICIPALITY STANDARDS AND REGULATIONS.
- THE CONTRACTOR SHALL NOTIFY THE CITY ENGINEER AND/OR THE AUTHORITY HAVING JURISDICTION 3 BUSINESS DAYS PRIOR TO THE BEGINNING OF CONSTRUCTION.
- THE CONTRACTOR MUST CONTACT THE ENGINEER SHOULD THEY ENCOUNTER ANY DESIGN ISSUES DURING CONSTRUCTION. IF THE CONTRACTOR MAKES DESIGN MODIFICATIONS WITHOUT THE WRITTEN DIRECTION OF THE DESIGN ENGINEER, THE CONTRACTOR DOES SO AT HIS OWN RISK.
- ALL NECESSARY PERMITS, TESTING, BONDS AND INSURANCES ETC., SHALL BE PAID FOR BY THE CONTRACTOR. THE OWNER SHALL PAY FOR ALL CITY INSPECTION FEES.
- THE CONTRACTOR SHALL NOTIFY THE APPROPRIATE 811/ONE CALL UTILITY LOCATING CENTER, THE CITY ENGINEER AND/OR THE AUTHORITY HAVING JURISDICTION 3 BUSINESS DAYS PRIOR TO THE BEGINNING OF CONSTRUCTION, IF NO NOTIFICATION IS GIVEN AND DAMAGE RESULTS, SAID DAMAGE WILL BE REPAIRED AT SOLE EXPENSE OF THE CONTRACTOR. IF EXISTING UTILITY LINES ARE ENCOUNTERED THAT CONFLICT IN LOCATION WITH NEW CONSTRUCTION, THE CONTRACTOR SHALL NOTIFY THE DESIGN ENGINEER SO THAT THE CONFLICT MAY BE RESOLVED.
- CONTRACTOR TO VERIFY THAT THE PLANS AND SPECIFICATIONS ARE THE VERY LATEST PLANS AND SPECIFICATIONS AND FURTHERMORE, VERIFY THAT THESE PLANS AND SPECIFICATIONS HAVE BEEN APPROVED. ALL ITEMS CONSTRUCTED BY THE CONTRACTOR PRIOR TO RECEIVING FINAL APPROVAL, HAVING TO BE ADJUSTED OR RE-DONE SHALL BE AT THE CONTRACTORS EXPENSE. SHOULD THE CONTRACTOR ENCOUNTER A CONFLICT BETWEEN THESE PLANS AND/OR SPECIFICATIONS, THEY SHALL SEEK CLARIFICATION IN WRITING FROM THE ENGINEER BEFORE COMMENCEMENT OF CONSTRUCTION. FAILURE TO DO SO SHALL BE AT SOLE EXPENSE TO THE CONTRACTOR.
- ANY WORK WITHIN THE STREET OR HIGHWAY RIGHTS-OF-WAY SHALL BE PERFORMED IN ACCORDANCE WITH THE REQUIREMENTS OF THE AGENCIES HAVING JURISDICTION AND SHALL NOT BEGIN UNTIL ALL NECESSARY PERMITS HAVE
- ALL PROPERTIES OR FACILITIES IN THE SURROUNDING AREAS, PUBLIC OR PRIVATE, DESTROYED OR OTHERWISE DISTURBED DUE TO CONSTRUCTION, SHALL BE REPLACED AND/OR RESTORED TO THE ORIGINAL CONDITION BY THE
- THE CONTRACTOR SHALL PROVIDE ALL NECESSARY BARRICADING, SIGNAGE, LIGHTS AND TRAFFIC CONTROL DEVICES TO PROTECT THE WORK AND SAFELY MAINTAIN TRAFFIC IN ACCORDANCE WITH LOCAL REQUIREMENTS AND THE MANUAL OF UNIFORM TRAFFIC CONTROL DEVICES (LATEST EDITION). THE DESIGN ENGINEER, OWNER, CITY AND STATE SHALL NOT BE HELD LIABLE FOR ANY CLAIMS RESULTING FROM ACCIDENTS OR DAMAGES CAUSED BY THE CONTRACTOR'S FAILURE TO COMPLY WITH TRAFFIC AND PUBLIC SAFETY REGULATIONS DURING THE CONSTRUCTION PERIOD.
- 10. IT SHALL BE THE RESPONSIBILITY OF THE CONTRACTOR TO ADJUST THE TOP OF ALL EXISTING AND PROPOSED STRUCTURES (MANHOLES, CATCH BASINS, INLETS, GATE WELLS ETC.) WITHIN GRADED AND /OR PAVED AREAS TO FINAL GRADE SHOWN ON THE PLANS. ALL SUCH ADJUSTMENTS SHALL BE INCIDENTAL TO THE JOB AND WILL NOT BE PAID FOR SEPARATELY.

## PAVING NOTES:

- IN AREAS WHERE NEW PAVEMENTS ARE BEING CONSTRUCTED, THE TOPSOIL AND SOIL CONTAINING ORGANIC MATTER SHALL BE REMOVED PRIOR TO PAVEMENT CONSTRUCTION.
- PROVIDE EXPANSION JOINTS AND JOINT SEALANT AT TWO "END-OF-RADIUS" LOCATIONS (OPPOSITE SIDES AT EACH LONG END) OF CONCRETE CURB ISLANDS.
- REFER TO ARCHITECTURAL PLANS FOR DETAILS OF FROST SLAB AT EXTERIOR BUILDING DOORS.
- CONSTRUCTION TRAFFIC SHOULD BE MINIMIZED ON THE NEW PAVEMENT. IF CONSTRUCTION TRAFFIC IS ANTICIPATED ON THE PAVEMENT STRUCTURE, THE INITIAL LIFT THICKNESS COULD BE INCREASED AND PLACEMENT OF THE FINAL LIFT COULD BE DELAYED UNTIL THE MAJORITY OF THE CONSTRUCTION ACTIVITIES HAVE BEEN COMPLETED. THIS ACTION WILL ALLOW REPAIR OF LOCALIZED FAILURE, IF ANY DOES OCCUR, AS WELL AS REDUCE LOAD DAMAGE ON THE
- CONCRETE PAVEMENT JOINTING UNLESS SHOWN OTHERWISE IN THE PLANS OR REQUIRED BY THE AUTHORITY HAVING JURISDICTION; 5.1. WHERE PROPOSED CONCRETE ABUTS A STRUCTURE PROVIDE A MINIMUM 1/2" EXPANSION JOINT WITH SEALANT, THE
- JOINT FILLER BOARD MUST BE AT LEAST THE FULL DEPTH OF THE CONCRETE AND HELD DOWN A 1/2 INCH TO ALLOW FOR SEALING 5.2. WHERE PROPOSED CONCRETE ABUTS EXISTING CONCRETE OR IN BETWEEN POURS OF PROPOSED CONCRETE (CONSTRUCTION JOINT) PROVIDE 5/8"DOWELS EVERY 30"CENTER TO CENTER HALF WAY ALONG THE THICKNESS OF
- THE PROPOSED PAVEMENT. ALTERNATE DOWELS SIZES AND SPACING MUST BE APPROVED THE ENGINEER PRIOR TO COMMENCING WORK AND VIA THE SUBMITTAL PROCESS. 5.3. WHERE PROPOSED CONCRETE ABUTS EXISTING OR PROPOSED SIDEWALK PROVIDE A MINIMUM 1/2" EXPANSION JOINT
- WITH SEALANT 5.4. WHERE PROPOSED CONCRETE ABUTS EXISTING OR PROPOSED CURBING PROVIDE A MINIMUM 1/2" EXPANSION JOINT
- WITH SEALANT 5.5. CONTROL, LONGITUDINAL AND/OR TRANSVERSE JOINTS SHALL BE PLACED TO PROVIDE PANELS WITHIN THE
- PAVEMENT AS SQUARE AS POSSIBLE WITH THE FOLLOWING MAXIMUM SPACING PARAMETERS; 5.5.1. 6-INCH THICK CONCRETE PAVEMENT: 12' X 12'
- 5.5.2. 8-INCH THICK CONCRETE PAVEMENT: 15' X 15'
- 5.6. IRREGULAR-SHAPED PANELS MAY REQUIRE THE USE OF REINFORCING MESH OR FIBER MESH AS DETERMINED BY IE ENGINEER. THE USE OF MESH MUST BE APPROVED THE ENGINEER PRIOR TO COMMENCING WORK AND VIA SUBMITTAL PROCESS.
- 5.7. IF A JOINT PLAN IS NOT PROVIDED IN THE PLANS, THE CONTRACTOR SHALL SUBMIT ONE TO THE ENGINEER FOR REVIEW PRIOR TO COMMENCING WORK AND VIA THE SUBMITTAL PROCESS.
- CONCRETE CURBING JOINTING UNLESS SHOWN OTHERWISE IN THE PLANS OR REQUIRED BY THE AUTHORITY HAVING JURISDICTION; 6.1. WHERE PROPOSED CONCRETE CURBING ABUTS A STRUCTURE PROVIDE A MINIMUM 1/2" EXPANSION JOINT WITH
- 6.2. WHERE PROPOSED CONCRETE ABUTS EXISTING OR PROPOSED SIDEWALK PROVIDE A MINIMUM 1/2" EXPANSION JOINT
- WITH SEALANT 6.3. WHERE PROPOSED CONCRETE ABUTS EXISTING CURBING PROVIDE A MINIMUM 1/2" EXPANSION JOINT WITH SEALANT
- 6.4. IN BETWEEN POURS OF PROPOSED CONCRETE CURBING (CONSTRUCTION JOINT) 6.4.1. CARRY THE REBAR CONTINUOUSLY BETWEEN POURS IF THE REBAR IS NOT LONG ENOUGH TO CARRY CONTINUOUSLY THEN TIE TWO PIECES OF REBAR PER THE
- LATEST MDOT SPECIFICATIONS 6.5. CONTROL JOINTS SHALL BE PLACED A MAXIMUM 10' CENTER TO CENTER AND AT ALL RADIUS RETURNS

## GENERAL GRADING AND EARTHWORK NOTES:

JOB.

## THESE NOTES APPLY TO ALL CONSTRUCTION ACTIVITIES ON THIS PROJECT

- CONTRACTOR TO FIELD VERIFY ALL EXISTING TREES AND BRUSH AND REMOVE ALL THAT ARE NECESSARY TO GRADE
- . ALL GRADES ARE TO TOP OF PAVEMENT UNLESS OTHERWISE NOTED.
- THE STAGING OF CONSTRUCTION ACTIVITIES SHALL OCCUR ONLY WITHIN THE SITE BOUNDARIES. ANY CONSTRUCTION ACTIVITIES OUTSIDE OF THE SITE BOUNDARIES SHALL BE AT THE SOLE RESPONSIBILITY AND RISK OF THE
- ALL SOIL EROSION AND SEDIMENTATION CONTROL MEASURES SHALL MEET THE REQUIREMENTS OF THE AUTHORIZED PUBLIC AGENCY OF JURISDICTION. AN EROSION CONTROL PERMIT MUST BE SECURED FROM OAKLAND COUNTY PRIOR
- ALL EARTHWORK AND GRADING OPERATIONS SHALL BE PERFORMED IN ACCORDANCE WITH THE SOILS INVESTIGATION AND REPORT AS PREPARED BY P.E.A. GROUP, DATED JUNE 3, 2021.
- REFER TO SOIL EROSION CONTROL PLAN FOR ADDITIONAL SOIL EROSION AND SEDIMENTATION CONTROL MEASURES AND NOTES (WILL BE PART OF FINAL SITE PLAN/ENGINEERING PLANS).
- . ALL SLOPES EXCEEDING 1:6 MUST BE STABILIZED BY SODDING OR BY PLACING A MULCH BLANKET PEGGED IN PLACE OVER SEED.
- ALL DISTURBED AREAS SHALL BE SEEDED AND MULCHED OR SODDED IN ACCORDANCE WITH THE LANDSCAPE PLANS. PROVIDE A MINIMUM OF 4" OF TOPSOIL IN THESE AREAS UNLESS OTHERWISE NOTED.
- . THE CONTRACTOR SHALL NOTE EXISTING UNDERGROUND UTILITIES WITHIN AND ADJACENT TO THE SITE. BACKFILL FOR EXISTING UTILITY TRENCHES SHALL BE EXAMINED CRITICALLY. ANY TRENCHES FOUND TO HAVE SOFT, UNSTABLE OR UNSUITABLE BACKFILL MATERIAL, IN THE OPINION OF THE THIRD PARTY TESTING COMPANY, THAT ARE TO BE WITHIN THE ZONE OF INFLUENCE OF PROPOSED BUILDINGS OR PAVEMENT SHALL BE COMPLETELY EXCAVATED AND BACKFILLED WITH SUITABLE MATERIAL.
- 10. ON-SITE FILL CAN BE USED IF THE SPECIFIED COMPACTION REQUIREMENTS CAN BE ACHIEVED. IF ON-SITE SOIL IS USED, IT SHOULD BE CLEAN AND FREE OF FROZEN SOIL, ORGANICS, OR OTHER DELETERIOUS MATERIALS.
- 1. THE FINAL SUBGRADE/EXISTING AGGREGATE BASE SHOULD BE THOROUGHLY PROOFROLLED USING A FULLY LOADED TANDEM AXLE TRUCK OR FRONT END LOADER UNDER THE OBSERVATION OF A GEOTECHNICAL/PAVEMENT ENGINEER. LOOSE OR YIELDING AREAS THAT CANNOT BE MECHANICALLY STABILIZED SHOULD BE REINFORCED USING GEOGRIDS OR
- 12. SUBGRADE UNDERCUTTING, INCLUDING BACKFILLING SHALL BE PERFORMED TO REPLACE MATERIALS SUSCEPTIBLE TO FROST HEAVING AND UNSTABLE SOIL CONDITIONS. ANY EXCAVATIONS THAT MAY BE REQUIRED BELOW THE TOPSOIL IN

REMOVED AND REPLACED WITH ENGINEERED FILL OR AS DICTATED BY FIELD CONDITIONS.

- FILL AREAS OR BELOW SUBGRADE IN CUT AREAS WILL BE CLASSIFIED AS SUBGRADE UNDERCUTTING. 13. SUBGRADE UNDERCUTTING SHALL BE PERFORMED WHERE NECESSARY AND THE EXCAVATED MATERIAL SHALL BECOME THE PROPERTY OF THE CONTRACTOR. ANY SUBGRADE UNDERCUTTING SHALL BE BACKFILLED AS RECOMMENDED IN
- THE GEOTECHNICAL ENGINEERING REPORT FOR THE PROJECT. 14. ANY SUB-GRADE WATERING REQUIRED TO ACHIEVE REQUIRED DENSITY SHALL BE CONSIDERED INCIDENTAL TO THE

## CONSTRUCTION MATERIAL SUBMITTALS

UNLESS REQUIRED OTHERWISE IN THE PROJECT SPECIFICATIONS, THE CONTRACTOR SHALL ONLY SUBMIT THE FOLLOWING CONSTRUCTION MATERIAL SUBMITTALS, AS APPLICABLE TO THE PLANS, FOR REVIEW BY THE ENGINEER. UNLESS APPROVED IN ADVANCE AND IN WRITING BY THE ENGINEER, ANY MATERIAL SUBMITTALS PROVIDED TO THE ENGINEER FOR REVIEW IN ADDITION TO THIS LIST SHALL BE RETURNED TO THE CONTRACTOR WITHOUT A REVIEW

- SOIL EROSION AND SEDIMENTATION CONTROL MEASURES
- UTILITY TRENCH BACKFILL MATERIAL WITH ALL MATERIAL DATA INCLUDED IN THE SUBMITTAL BEING DATED WITHIN 60 DAYS OF THE SUBMITTAL UNLESS APPROVED OTHERWISE BY THE ENGINEER
- RIP RAP MATERIAL WITH ALL MATERIAL DATA INCLUDED IN THE SUBMITTAL BEING DATED WITHIN 60 DAYS OF THE SUBMITTAL UNLESS APPROVED OTHERWISE BY THE ENGINEER
- STORM AND SANITARY SEWER PIPING INCLUDING JOINTS
- . STORM AND SANITARY SEWER STRUCTURES
- STORM AND SANITARY SEWER STRUCTURE FRAME AND COVERS INCLUDING CLEAN OUTS
- WATER DISTRIBUTION SYSTEM PIPING INCLUDING JOINTS
- B. WATER DISTRIBUTION SYSTEM STRUCTURES
- D. WATER DISTRIBUTION SYSTEM STRUCTURE FRAME AND COVERS
- 10. WATER DISTRIBUTION SYSTEM SHUT OFF BOXES
- 1. WATER DISTRIBUTION SYSTEM FIRE HYDRANTS 12. WATER DISTRIBUTION SYSTEM GATE VALVES
- 13. PAVEMENT AGGREGATE BASE MATERIAL WITH ALL MATERIAL DATA INCLUDED IN THE SUBMITTAL BEING DATED WITHIN 60 DAYS OF THE SUBMITTAL UNLESS APPROVED OTHERWISE BY THE ENGINEER
- 4. PAVEMENT UNDERDRAIN MATERIAL AND BACKFILL WITH ALL BACKFILL MATERIAL DATA INCLUDED IN THE SUBMITTAL BEING DATED WITHIN 60 DAYS OF THE SUBMITTAL UNLESS APPROVED OTHERWISE BY THE ENGINEER
- 15. PAVEMENT MIX DESIGNS SUBMITTED FOR REVIEW BY THE ENGINEER MUST FOLLOW THE CURRENT MDOT REVIEW CHECKLISTS AS SUMMARIZED BELOW AND ALL MATERIAL DATA INCLUDED IN THE SUBMITTAL BEING DATED WITHIN 60 DAYS OF THE SUBMITTAL UNLESS APPROVED OTHERWISE BY THE ENGINEER:
- •8.1. CONCRETE MIX DESIGN REVIEW CHECKLIST (FORM 2000) •8.2. SUPERPAVE MIX DESIGN CHECKLIST (FORM 1862)
- •8.3. MARSHALL MIX DESIGN CHECKLIST (FORM 1849)
- 16. SITE FENCING AND GATES INCLUDING FOOTINGS 17. SITE RAILINGS INCLUDING FOOTING OR EMBEDMENTS
- 18. ANY ITEMS SHOWN IN THE PLANS OR DETAIL SHEETS THAT SPECIFICALLY STATE FOR THE CONTRACTOR TO SUBMIT A SHOP DRAWING TO THE ENGINEER FOR REVIEW. THESE ITEMS INCLUDE, BUT ARE NOT LIMITED TO:
  - RETAINING WALL MATERIAL AND STRUCTURAL CALCULATIONS
  - TRENCH DRAIN MATERIAL AND SHOP DRAWING DEPICTING THE LAYOUT OF THE SYSTEM

RETURN HANDRAIL AND CONNECT TO POST

TYPICAL STAIRWAY HANDRAIL/GUARDRAIL DETAIL

2" O.D. GALV. STEEL HANDRAIL

PROVIDE MIN. 1-1/2" CLEARANCE BETWEEN GUARDRAIL AND

HANDRAIL. FINISH WITH ONE
COAT PRIMER & 2 FINISH COATS.
COLOR PER OWNER.

ANY SPECIALITY ITEMS SHOWN IN THE PLANS OR DETAIL SHEETS THAT SPECIFICALLY DO NOT STATE FOR THE CONTRACTOR SHALL SUBMIT A SHOP DRAWING TO THE ENGINEER FOR REVIEW BUT THE CONTRACTOR REQUESTS TO BE REVIEWED. THE CONTRACTOR'S REQUEST FOR REVIEW MUST BE IN WRITING AND APPROVED BY THE ENGINEER PRIOR TO SUBMITTING THE INFORMATION.

ADJACENT ASPHA

PROOF-ROLLED/COMPACTED

SUBGRADE OR ENGINEERED FILL COMPACTED TO 95% OF MAX. DRY UNIT WEIGHT PER ASTM D-1557.

PAVEMENT SECTION





CROSS-SLOPE OF SIDEWALK MUST NOT

4" MDOT CLASS II SAND BASE

COURSE COMPACTED TO 95% MAXIMUM DRY UNIT WEIGHT PER ASTM D-1557

4" MDOT CLASS II SAND

TAPER CURB TO 0" HEIGHT

USING 5' TRANSITION, TYP.

BASE COURSE COMPACTED \_\_/
TO 95% MAX. DRY UNIT

PROOF-ROLLED/COMPACTED SUBGRADE OR ENGINEERED FILL COMPACTED TO 95% OF

WEIGHT PER ASTM D-1557

PROVIDE 1" DEPTH SAWCUT CONTROL JOINTS AT INTERVALS EQUAL TO THE WIDTH OF THE

P1 6AA CONCRETE

PROOF-ROLLED/COMPACTED SUBGRADE OR ENGINEERED FILL COMPACTED TO 95% OF MAX. DRY UNIT WEIGHT PER ASTM D-1557.

ASPHALT PAVING

1" RADIUS

- EPOXY COATE

- FULL CURB HEIGHT (6"

- MANUFACTURER'S SPECIFICATIONS

MDOT 3500 PSI P1

\_\_\_\_3"ø

4'X6' CONC. PAD

BIKE RACK DETAIL

ADJACENT CONCRET

THICKNESS (TYP

COMPACTE

— GUTTER LINE

SIDEWALK (NOT TO EXCEED 8' INTERVAL)

2% MAX. CROSS SLOPE

CONCRETE SIDEWALK

CONTRACTION JOINTS TO BE T/4 DEEP. SPACED AT INTERVALS TO MATCH SIDEWALK

INTEGRAL CURB AND SIDEWALK

WIDTH (SAWCUT). 1/2-INCH PRE-MOLDED FILLER EXPANSION JOINTS WITH JOINT

**CURB END TRANSITION DETAIL** 

MANUFACTURERED BY

LANDSCAPE FORMS
MODEL: RING BIKE RACK

SEALANT SHALL BE PLACED ONLY WHERE SIDEWALK ABUTS A STRUCTURE.

AS INDICATED ON PLANS

6AA CONCRETE

2% MAX SLOPE

BENCH: 72" PLAINWELL, ALUMINUM LITTER CONTAINER: PLAINWELL, ALUMINUM BY: LANDSCAPE FORMS OR APPROVED EQUAL WITH SIDE OPEN LID AT 30"x38" HIGH PHONE: 800-521-2546 BY: LANDSCAPE FORMS OR APPROVED EQUAL PHONE: 800-521-2546 COLOR: TITANIUM OR SILVER, POWDER COATED,

OWNER TO SELECT/APPROVE COLOR COLOR: TITANIUM OR SILVER, POWDER COATED, QUANTITY: 2, QTY. TO BE APPROVED BY OWNER OWNER TO SELECT/APPROVE COLOR QUANTITY: 1, QTY. TO BE APPROVED BY OWNER

BENCH AND LITTER IMAGE DETAIL NOT TO SCALE

On site amenities, particularly those near

Gateway and Streetscape Master Plan.

https://www.rochesterhills.org/department

s/planning\_\_\_economic\_development/ga

NOTE: ROUT A 1" X 3/4" RESERVOIR

OLLARS USED AT MANHOLES, GATE WELLS

ETC. CAN UTILIZE THIS SAME DETAIL, EXCEPT THAT THE PAD GRADES SHOULD CONFORM TO THE SURROUNDING PAVEMEN GRADES, NOT PITCH TO THE STRUCTURE

CASTING AS SHOWN FOR CATCH BASINS

AROUND EDGES, POUR HOT RUBBER NON-SILICONE BASED SEALANT ALONG
ALL EDGES OF CONCRETE COLLAR

HEAVY DUTY CONCRETE

CTION. REFER TO

SAWCUT CONTRACTION JOINTS

NOTE: ROUT A 1" X 3/4" RESERVOIR AROUND EDGES. POUR HOT RUBBER

- NON-SILICONE BASED SEALANT ALONG ALL EDGES OF CONCRETE COLLAR ADJACENT TO ASPHALT PAVEMENT.

CROWN TOP OF WALL.

- PROPOSED PRECAST OR STAMPED

CONCRETE RETAINING WALL WITH NATURAL STONE TEXTURE, BOTH

-#4 BARS AT 18" O.C

-12" MIN. OVERLAP

W/FOOTING BARS., TYP.

PROPOSED CONCRETE FOOTING

WITH 4 - #5 BARS, CONTINUOUS EACH FACE

CONCRETE SCREEN WALL DETAIL

1 : 4 MAX.

EXTEND OVERLAP 12" MIN.

W/FOOTING BARS, TYP.

SIDES, PROVIDE EXPANSION JOINTS EVERY 30 L.F. ALONG WALL LENGTH

- IN CONCRETE COLLAR 1/4 DEPTH OF SLAB

the road right of way should be

consistent with the City's adopted

tewaysstreetscapesmasterplan.php

SLOPE TO PROVIDE POSITIVE DRAINAGE TOWARD CATCH BASIN,

FOR MANHOLE STRUCTURE)

(CONSTRUCT FLUSH WITH PAVEMENT

- COLLAR TO MATCH PAVEMENT ELEVATION

SECTION "A-A"

CONCRETE COLLAR DETAIL

4" PVC SLEEVE

AT 5' O.C. FOR— DRAINAGE

PROPOSED GRADE

PROVIDE #4 FOOTING BARS

" MIN. ABOVE FOOTING

EVERY 18" O.C. EXTEND

WHEN NOT ADDRESSED IN

THE GEOTECHNICAL INVESTIGATION OR THE

ARCHITECTURAL PLAN
PLACE ON NATURAL SOILS

CAPACITY OR DOCUMENTED

OF AT LEAST 1500 PSF NET ALLOWABLE BEARING

- HANDRAIL, TYP


TYPICAL HANDRAIL EMBEDMENT

CONTRACTOR TO PROVIDE SHOP DRAWINGS FOR

STAIRWAY AND HAINDRAIL AND FOUNDATION PRIOR TO CONSTRUCTION. CONTRACTOR IS RESPONSIBLE


OR DETERMINING SOIL CONDITIONS AT THE POLE


OCATIONS AND DESIGNING A SUITABLE FOUNDATIO

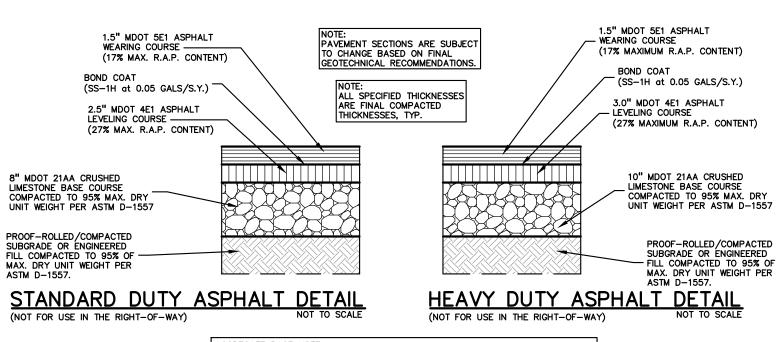

AGGREGATE BASE NOTE:
THIS PAVEMENT SECTION DESIGN ASSUMES THE USE OF MDOT 21AA CRUSHED
LIMESTONE BASE MATERIAL THAT MEETS THE REQUIREMENTS OF MDOT STANDARD
SPECIFICATION SECTION 902 FOR AGGREGATES. IF CRUSHED CONCRETE AGGREGATE BASE IS PROPOSED IN LIEU OF THE SPECIFIED CRUSHED LIMESTONE MATERIAL, PER GROUP WILL REQUIRE A MINIMUM 25% INCREASE IN BASE THICKNESS. HOWEVER, I TESTING DOCUMENTATION IS PROVIDED TO PEA GROUP THAT SHOWS THAT THE CRUSHED CONCRETE MATERIAL MEETS ALL REQUIREMENTS OF MDOT SPECIFICATION SECTION 902, THEN THE 25% INCREASE IN THICKNESS MAY BE REEVALUATED. ASPHALT MATERIAL NOTES

HOT-MIX ASPHALT MIXTURES UTILIZING RECYCLED ASPHALT PAVEMENT (RAP) MUST MEET MOOT SPECIAL PROVISION 12SP501(E). THE BINDER GRADE FOR THIS WORK IS PG64-28. IF ASPHALT MIXES CONTAINING RAP ARE TO BE SUPPLIED FOR THIS PROJECT, THE ASPHALT BINDER MUST BE REVISED PER MDOT 'TIER 1' OR 'TIER 2 REQUIREMENTS (RAP CONTENT UP TO 27% MAXIMUM). TIER 3 MIXES ARE NOT ACCEPTABLE ON THIS PROJECT. AN ASPHALT MIX DESIGN FOR ALL SPECIFIED MIXES SHOULD BE FORWARDED TO PEA GROUP FOR REVIEW PRIOR TO CONSTRUCTION

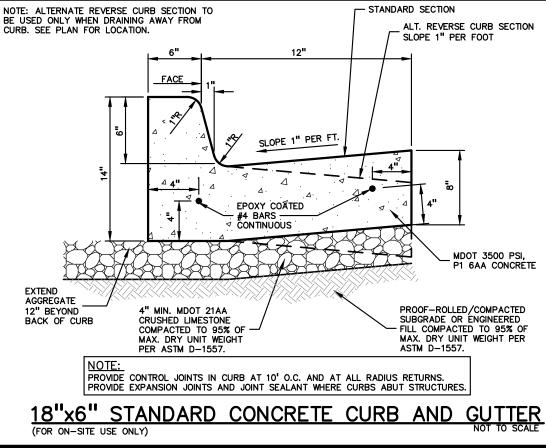

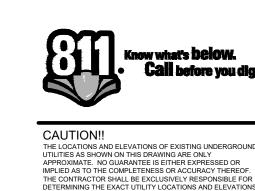



PRIOR TO THE START OF CONSTRUCTION.

**MARKUS** 

t: 844.813.2949


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**MANAGEMENT** GROUP, LLC 251 EAST MERRILL STREET, SUITE: 205 BIRMINGHAM, MICHIGAN 48009 PROJECT TITLE **NORTH HILL** SHOPPING **CENTER** THICKENED EDGE ASPHALT DETAIL

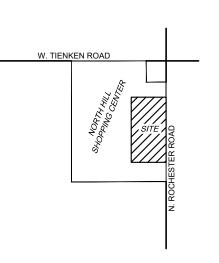1467 N. ROCHESTER ROAD **REVISIONS** PER CITY COMMENTS PER CITY COMMENTS

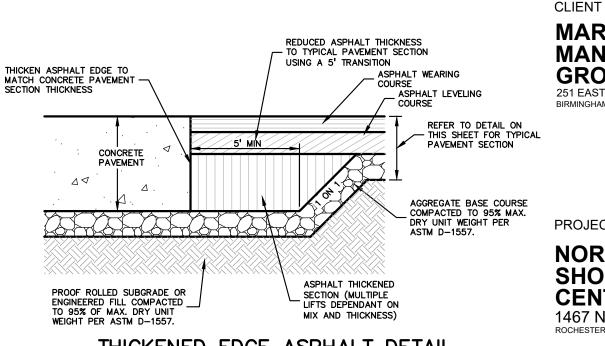

12 06 23 01.05.24 ORIGINAL ISSUE DATE: **SEPTEMBER 25, 2023** DRAWING TITLE

**NOTES AND DETAILS** 

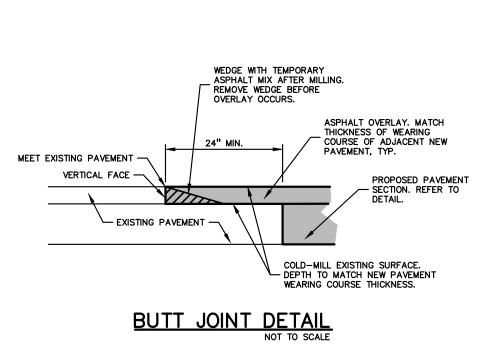





SWS DES. SWS DRAWING NUMBER:

2021-0512

JPB

PEA JOB NO.

NOT FOR CONSTRUCTION (CITY FILE #23-0071; SECTION 10)

## **GENERAL BARRIER FREE NOTES:**

DETAILS ON THIS SHEET.


THE FOLLOWING NOTES PROVIDE AN OUTLINE OF SOME OF THE REQUIREMENTS CONTAINED WITHIN THE "STANDARDS FOR ACCESSIBLE DESIGN - AMERICANS WITH DISABILITIES ACT 2010", AND "ACCESSIBLE AND USEABLE BUILDINGS AND FACILITIES", ICC/ANSI A117.1-2009. THE CONTRACTOR IS RESPONSIBLE FOR ALL OF THE REQUIREMENTS PRESENTED WITHIN THESE

- DOCUMENTS, WHICH ARE AVAILABLE IN FULL UPON REQUEST. 1. AN ACCESSIBLE ROUTE CONSISTS OF WALK SURFACES, CURB RAMPS AND RAMPS. AT LEAST ONE ACCESSIBLE ROUTE SHALL BE PROVIDED WITHIN THE SITE FROM ACCESSIBLE PARKING SPACES, ACCESSIBLE PASSENGER LOADING ZONES, PUBLIC STREETS AND SIDEWALKS, AND PUBLIC TRANSPORTATION STOPS TO THE BUILDING OR FACILITY ENTRANCE THEY SERVE.
- 2. THE RUNNING SLOPE OF ALL WALKING SURFACES SHALL NOT EXCEED 5% (1:20) AND THE CROSS-SLOPE SHALL NOT EXCEED 3. WALKING SURFACES MUST BE LEVEL WITH PERMITTED VERTICAL CHANGES IN LEVEL NOT TO EXCEED 1/4", OR BEVELED CHANGES IN LEVEL NOT TO EXCEED 1/2". REFER TO DETAIL ON THIS SHEET. ANY CHANGE IN LEVEL GREATER THAN 1/2"
- 4. TURNING SPACES ALONG ACCESSIBLE ROUTES MUST BE AT LEAST 5 FEET WIDE IN ALL DIRECTIONS AND NOT EXCEED 2% SLOPE (1:48) IN ANY DIRECTION.
- 5. ACCESSIBLE ROUTES WILL BE DESIGNED TO BE A MINIMUM OF 5 FEET WIDE. THE MINIMUM CLEAR WIDTH IS 3 FEET. 6. RAMPS ALONG ACCESSIBLE ROUTES WILL HAVE A RUNNING SLOPE GREATER THAN 5% (1:20) AND LESS THAN 8.3% (1:12).
- 7. THE CROSS-SLOPE OF RAMP RUNS SHALL NOT EXCEED 2% (1:48) 8. THE MINIMUM CLEAR WIDTH OF ANY RAMP IS 36 INCHES.
- 9. THE MAXIMUM RISE FOR ANY RAMP (NOT INCLUDING CURB RAMPS) SHALL NOT EXCEED 30 INCHES. LANDINGS ARE REQUIRED AT THE TOP AND BOTTOM OF EACH RAMP. LANDINGS SHALL HAVE A CROSS-SLOPE NOT EXCEEDING 2% (1:48), SHALL BE 5 FEET LONG AND AT LEAST AS WIDE AS THE RAMP CLEAR WIDTH. IF THERE IS A CHANGE OF DIRECTION AT A LANDING, THEN THE LANDING MUST BE AT LEAST 5 FEET WIDE AND 5 FEET LONG.
- 10. HANDRAILS ARE REQUIRED FOR ANY RAMP (NOT INCLUDING CURB RAMPS) WITH A RISE GREATER THAN 6 INCHES. ALL HANDRAILS ARE REQUIRED TO HAVE EDGE PROTECTION UNLESS ADJOINING ANOTHER ACCESS POINT OR IF THE VERTICAL DROP-OFF AT THE EDGE OF THE RAMP DOES NOT EXCEED 1/2" IN 10 FEET. EDGE PROTECTION CAN BE PROVIDED BY MEANS OF A 4" MIN. CURB OR BARRIER.
- 11. CURB RAMPS ALONG ACCESSIBLE ROUTES SHALL NOT BE STEEPER THAN 8.3% (1:12). APPROACHING SLOPES TO THE RAMP CANNOT EXCEED 5%, WHICH INCLUDES SIDEWALKS, PAVEMENT, GUTTERS ETC.
- 12. IF CURB RAMP SIDES ARE FLARED, THE FLARES SHALL NOT BE STEEPER THAN 10% (1:10)... 13. CURB RAMPS SHALL BE LOCATED OR PROTECTED TO PREVENT THEIR OBSTRUCTION BY PARKED VEHICLES.
- 14. HANDRAILS ARE NOT REQUIRED ON CURB RAMPS. 15. WHERE DETECTABLE WARNING IS REQUIRED AT CURB RAMPS, THE DETECTABLE WARNING SHALL BE 24" MINIMUM IN DEPTH AND SHALL EXTEND THE FULL WIDTH OF THE RAMP. THE DETECTABLE WARNING SHALL BE LOCATED SO THE EDGE NEAREST THE CURB IS 6 INCHES MINIMUM AND 8 INCHES MAXIMUM FROM THE CURB LINE.
- 16. FOR EVERY SIX OR FRACTION OF SIX ACCESSIBLE PARKING SPACES, ONE VAN ACCESSIBLE SPACE SHALL BE PROVIDED. 17. ACCESSIBLE PARKING SPACES SHALL BE LOCATED ON THE SHORTEST ACCESSIBLE ROUTE FROM PARKING TO A BUILDING
- 18. BARRIER FREE CAR PARKING SPACES SHALL BE A MINIMUM OF 11 FEET WIDE WITH AN ACCESS AISLE 5 FEET WIDE MINIMUM.
- 19. SURFACE SLOPES WITHIN THE PARKING SPACES AND AISLES SHALL NOT EXCEED 2% (1:48) 20. ACCESSIBLE AREAS INCLUDING PARKING SPACES, AISLES AND PATHWAYS, REQUIRE A MINIMUM VERTICAL CLEARANCE OF 98

18" WIDE WHITE CROSSWALK

STRIPING, 48" O.C., TYPICAL

21. ACCESSIBLE PARKING SPACES ARE REQUIRED TO BE IDENTIFIED BY SIGNS. THE SIGNS SHALL INCLUDE THE INTERNATIONAL SYMBOL OF ACCESSIBILITY. VAN PARKING SPACES ARE REQUIRED TO BE DESIGNATED AS "VAN ACCESSIBLE". REFER TO

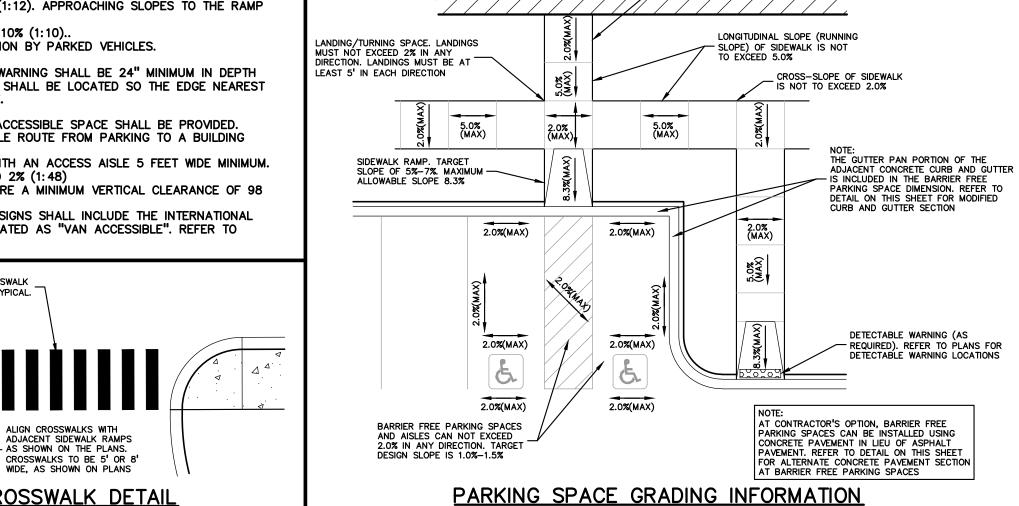

CONCRETE USED AT B.F. PARKING SPACES MAY BE

INTEGRALLY COLORED TO MATCH ADJACENT ASPHALT.

6" M.D.O.T. #21AA AGG. BASE COURSE COMPACTED TO 95%


BARRIER FREE PARKING SPACE

BUILDING

ALTERNATE CONCRETE PAVEMENT DETAIL

SIDEWALK NOT TO EXCEED - 2% SLOPE WITHIN 5' OF BUILDING ENTRANCES

COLOR: BLACK (AT THE OWNER'S DISCRETION)

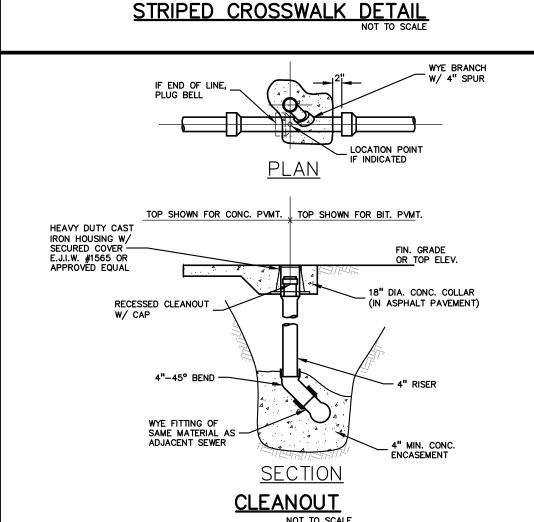








-6" M.D.O.T. 3500 PSI P1,


PROOF-ROLLED/COMPACTED SUBGRADE OR ENGINEERED FILL


COMPACTED TO 95% OF MAY DRY

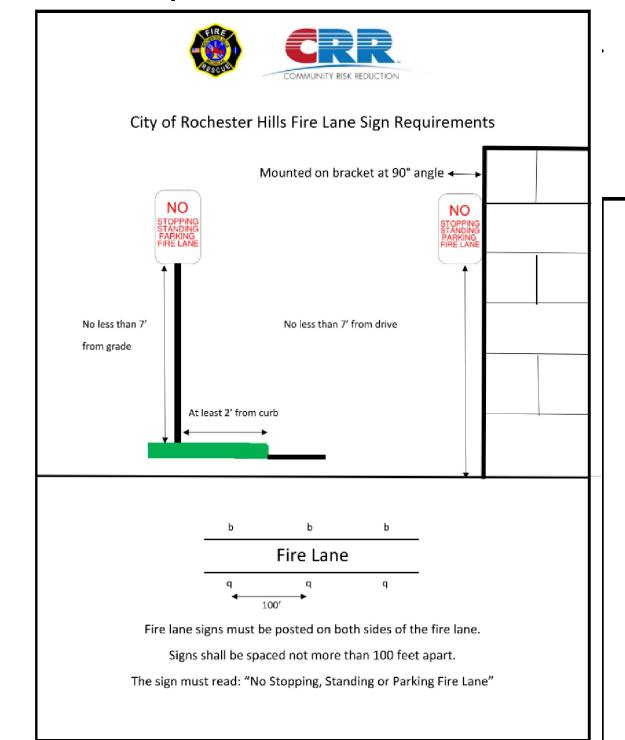


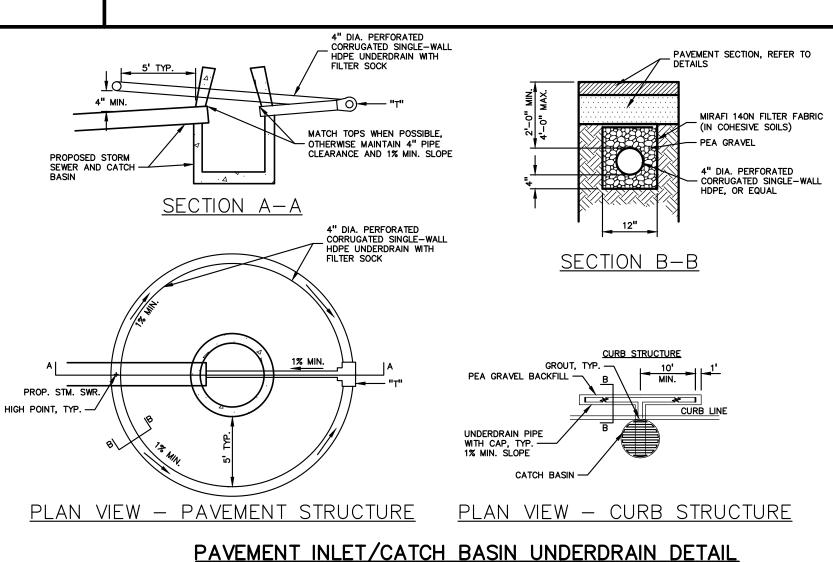

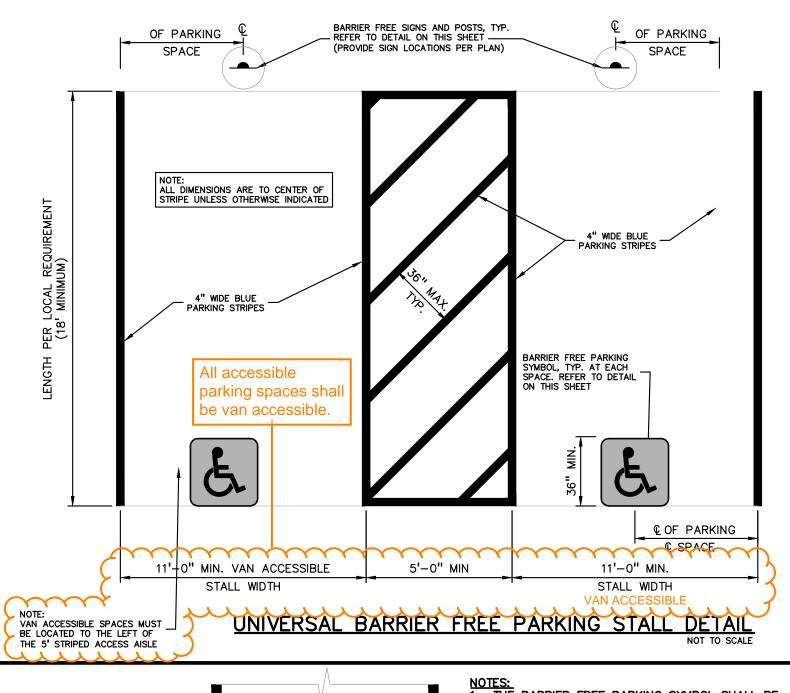


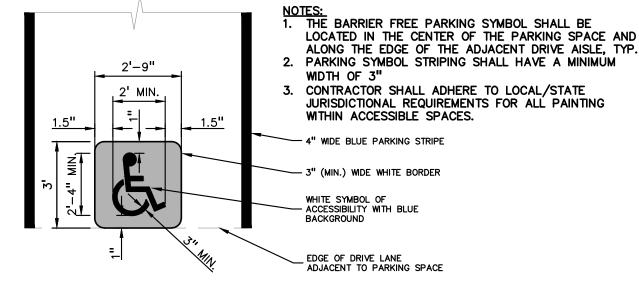

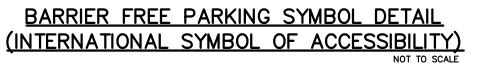

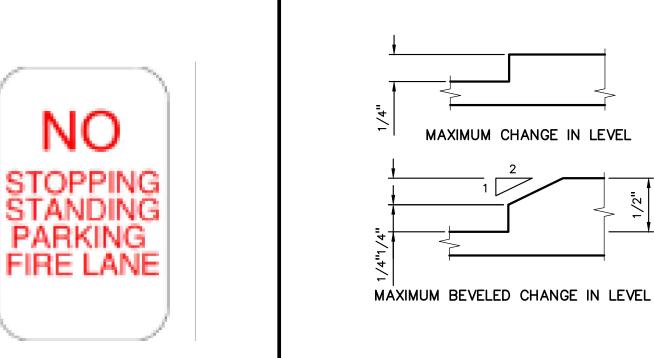


FIRE LANE SIGN DETAIL

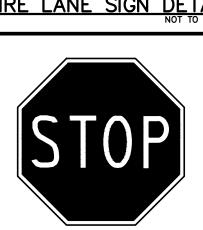

30" x 30"
WHITE ON RED REFLECTORIZED 7'-0" MOUNTING HEIGHT STOP SIGN DETAIL NOT TO SCALE



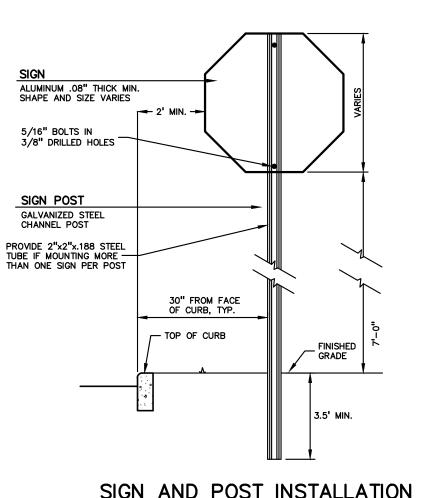


BARRIER FREE SURFACE CHANGE IN LEVEL TOLERANCE


SIGN AND POST INSTALLATION IN LANDSCAPED AREAS J2023-0071


BARRIER FREE SIGN NOTES:


- ONE SIGN IS REQUIRED AT EACH BARRIER FREE PARKING SPACE.
   ALL SIGNS SHALL COMPLY WITH THE LATEST STANDARDS OF THE MICHIGAN MANUAL
- OF UNIFORM TRAFFIC CONTROL DEVICES (MMUTCD). WHEN TWO BARRIER FREE PARKING SPACES ARE ADJACENT AND FACING EACH OTHER, TWO SIGNS ARE REQUIRED, BUT CAN BE MOUNTED ON THE SAME POST. 4. SIGN POSTS SHALL BE 2" NOM. SQUARE 14-GAUGE GALVANIZED STEEL TUBE WITH
- 7/16" HOLES AT 1" CENTERS. POSTS SHALL TELESCOPE INSIDE ANCHOR POSTS A MINIMUM OF 12". 5. ANCHOR POSTS SHALL BE 2.25" NOM. SQUARE 12-GAUGE GALVANIZED STEEL POST,
- A MINIMUM OF 3 FEET LONG. 6. IF THESE NOTES AND DETAILS CONFLICT WITH LOCAL CODES AND ORDINANCES, THE
- STRICTER REQUIREMENT SHOULD BE USED. 7. ALTERNATE MATERIALS MAY BE USED IF IN COMPLIANCE WITH A.D.A. GUIDELINES AND LOCAL REQUIREMENTS.

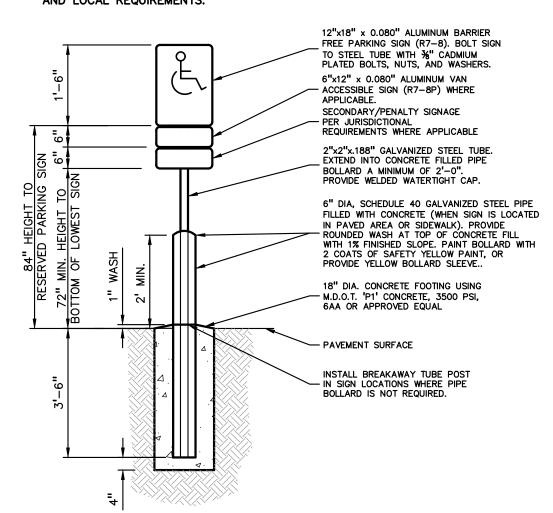


BARRIER FREE SIGN AND POST DETAIL

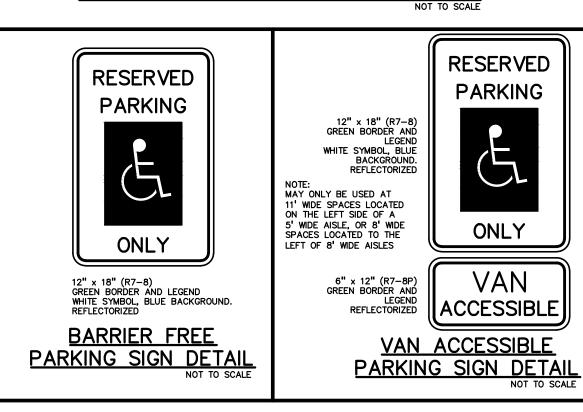


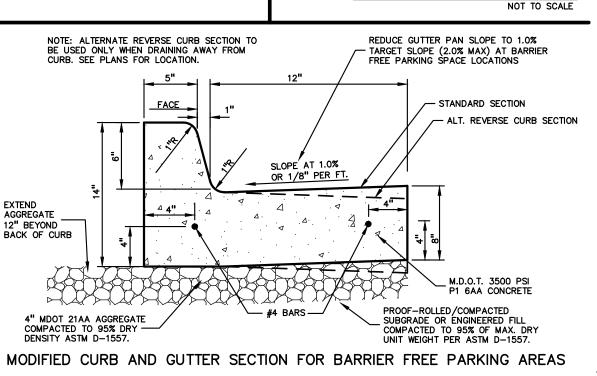

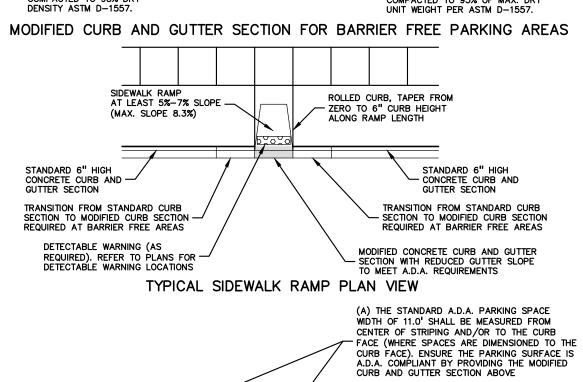

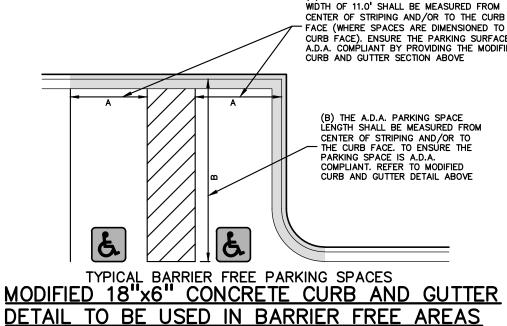

JPB SWS DES. SWS DRAWING NUMBER:

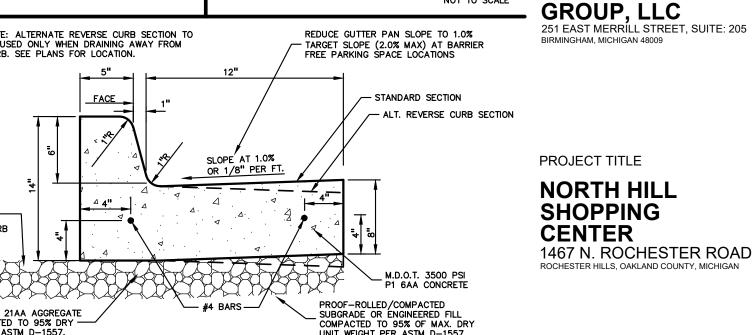

_,		
	REVISIONS	
	PER CITY COMMENTS	12.06.23
	PER CITY COMMENTS	01.05.24
N :		
•		
CE	ORIGINAL ISSUE DATE:	
DM JRB	SEPTEMBER 25, 2023	
TO THE FACE IS	DRAWING TITLE	
DIFIED		
	DETAILS	

t: 844.813.2949

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CAUTION!!

**MARKUS** 

**MANAGEMENT** 


THE LOCATIONS AND ELEVATIONS OF EXISTING UNDERGROUND UTILITIES AS SHOWN ON THIS DRAWING ARE ONLY

CONTRACTOR SHALL BE EXCLUSIVELY RESPONSIBLE FOR DETERMINING THE EXACT UTILITY LOCATIONS AND ELEVATIONS PRIOR TO THE START OF CONSTRUCTION.

APPROXIMATE. NO GUARANTEE IS EITHER EXPRESSED OR IMPLIED AS TO THE COMPLETENESS OR ACCURACY THEREOF


PEA JOB NO. 2021-0512

NOT FOR CONSTRUCTION (CITY FILE #23-0071; SECTION 10)

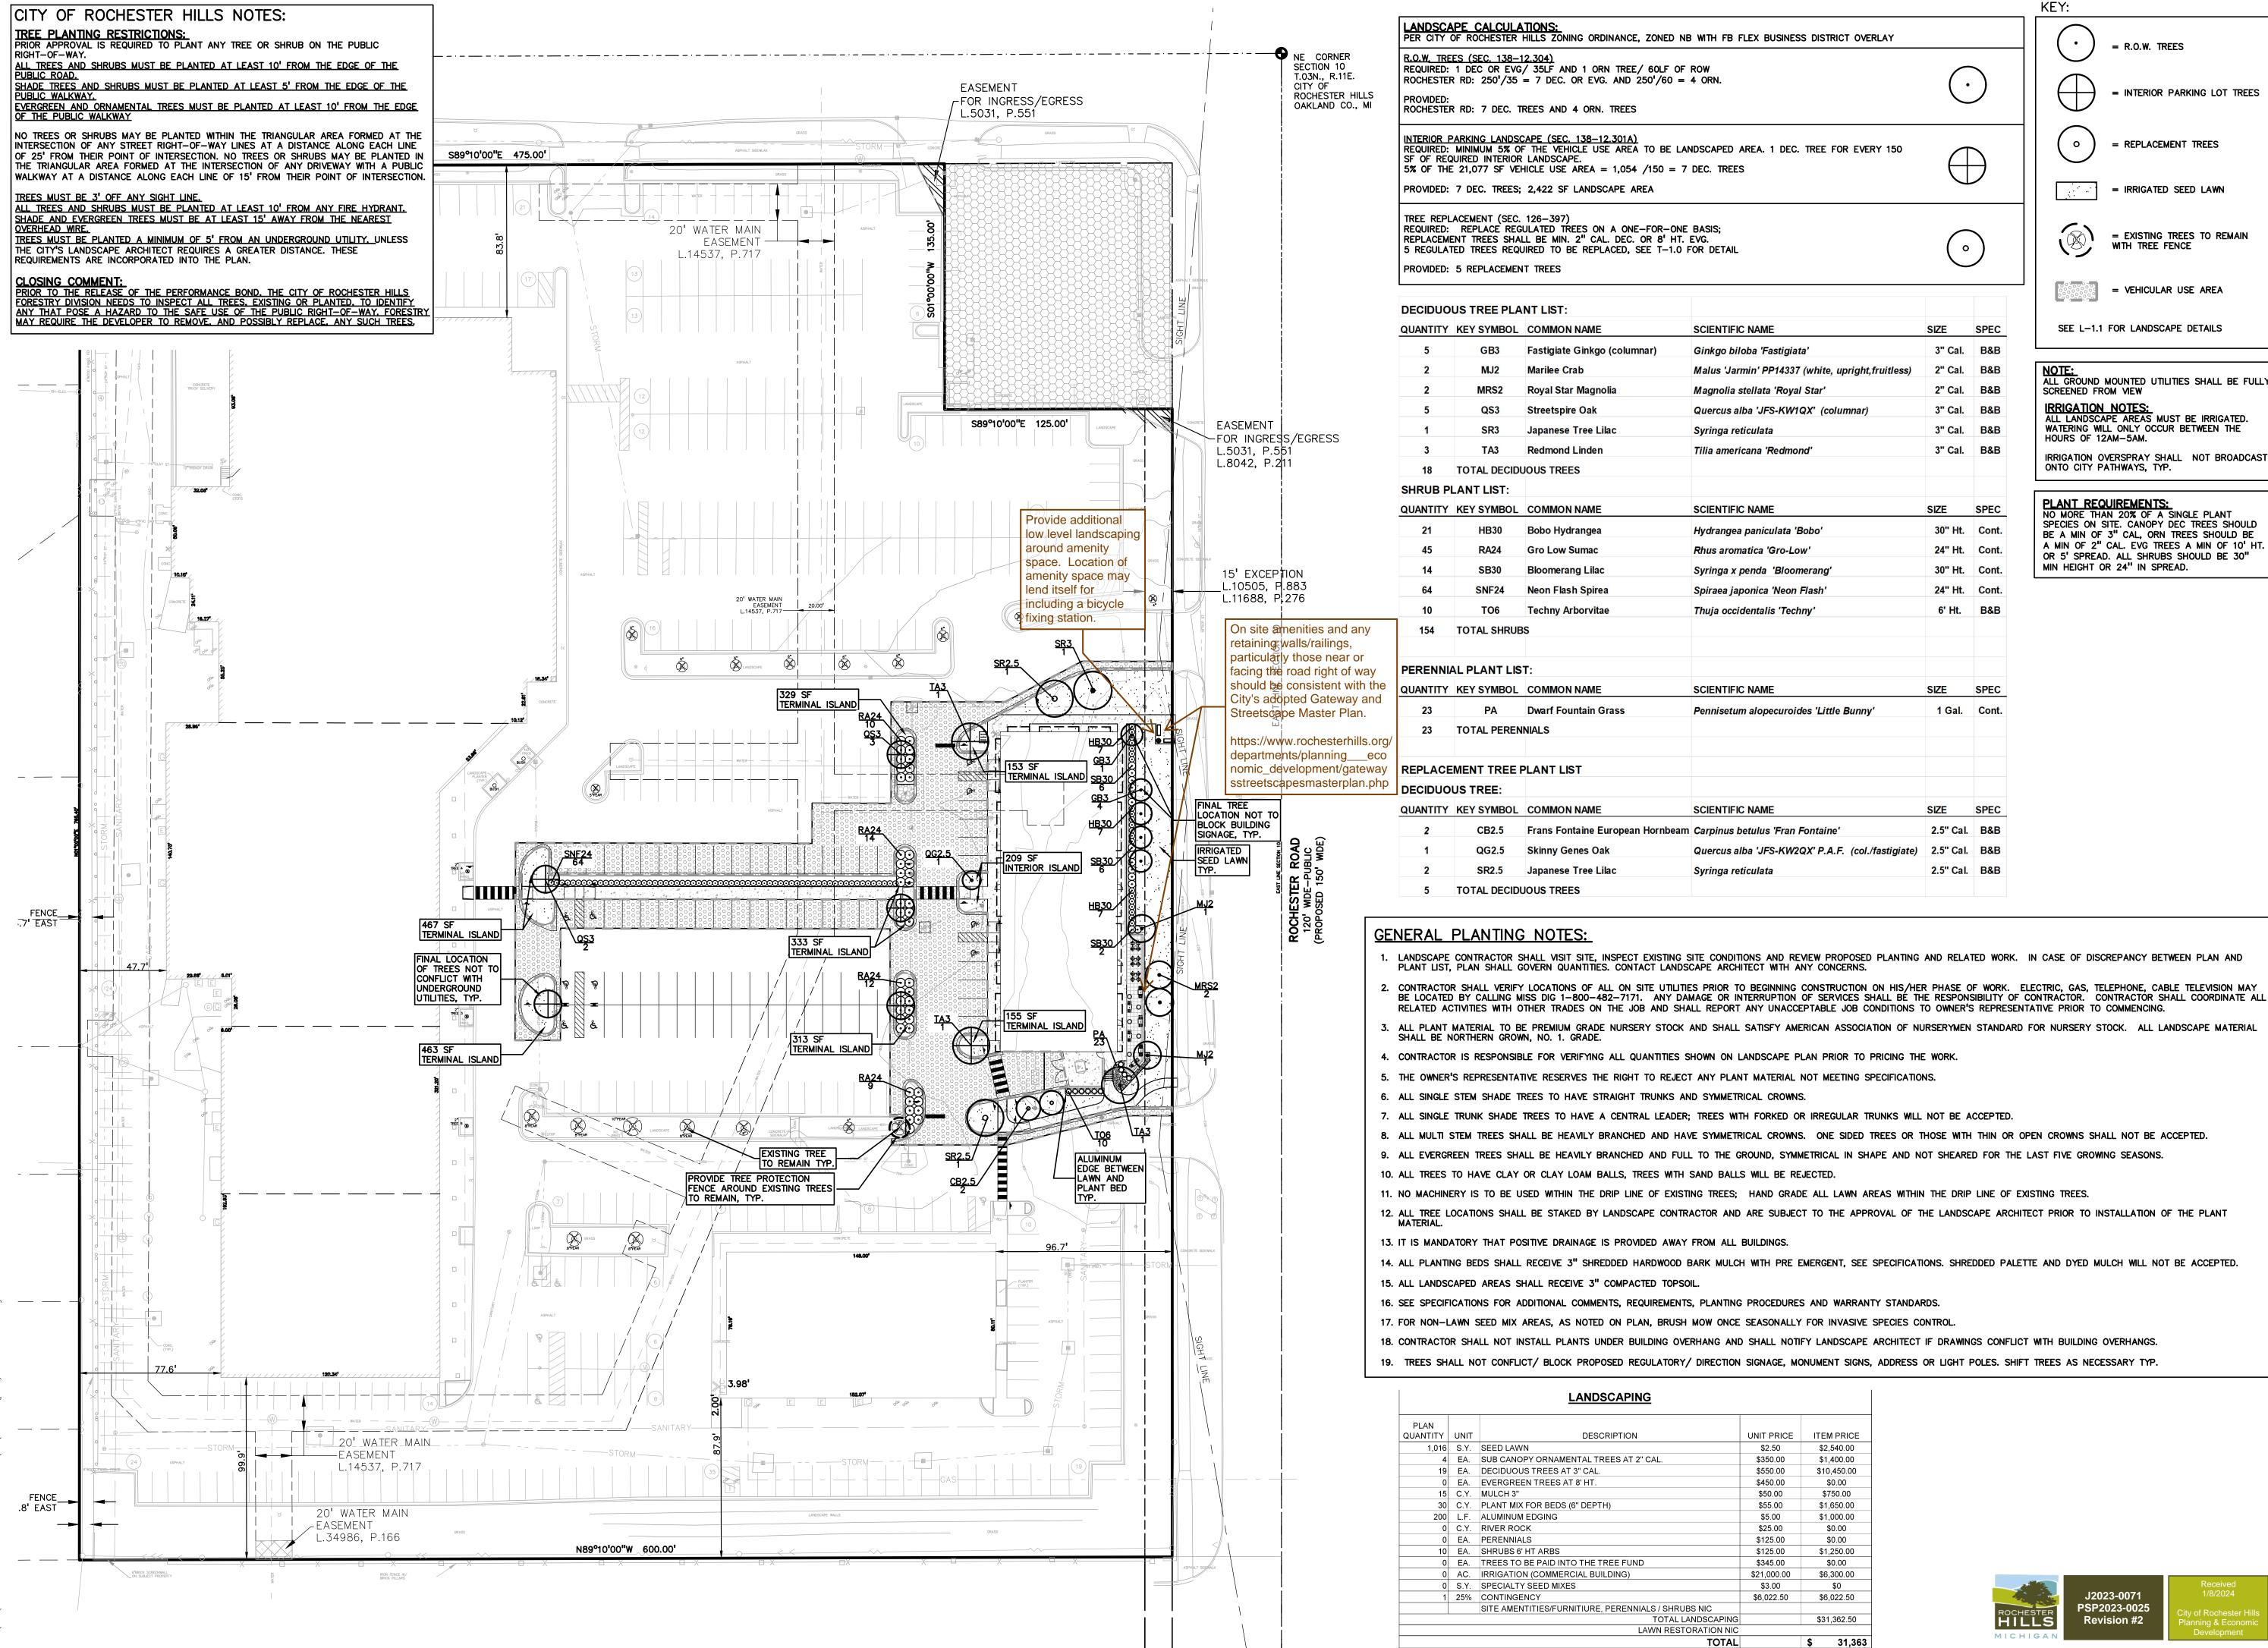



= REPLACEMENT TREES

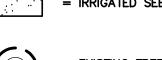

= EXISTING TREES TO REMAIN



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ILL GROUND MOUNTED UTILITIES SHALL BE FULL' ALL LANDSCAPE AREAS MUST BE IRRIGATED. WATERING WILL ONLY OCCUR BETWEEN THE

RRIGATION OVERSPRAY SHALL NOT BROADCAST


NO MORE THAN 20% OF A SINGLE PLANT SPECIES ON SITE. CANOPY DEC TREES SHOULD BE A MIN OF 3" CAL, ORN TREES SHOULD BE A MIN OF 2" CAL. EVG TREES A MIN OF 10' HT. OR 5' SPREAD. ALL SHRUBS SHOULD BE 30"



SCALE: 1" = 40'



CAUTION THE LOCATIONS AND ELEVATIONS OF EXISTING UNI UTILITIES AS SHOWN ON THIS DRAWING ARE ONLY APPROXIMATE. NO GUARANTEE IS EITHER EXPRESSED OR IMPLIED AS TO THE COMPLETENESS OR ACCURACY THEREOF THE CONTRACTOR SHALL BE EXCLUSIVELY RESPONSIBLE FOR DETERMINING THE EXACT UTILITY LOCATIONS AND ELEVATIONS PRIOR TO THE START OF CONSTRUCTION.

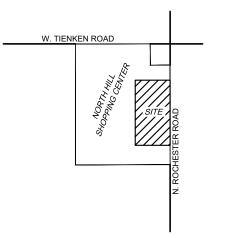

CLIENT

**MARKUS MANAGEMENT GROUP, LLC** 251 EAST MERRÍLL STREET, SUITE: 205 BIRMINGHAM, MICHIGAN 48009

PROJECT TITLE NORTH HILL SHOPPING CENTER 1467 N. ROCHESTER ROAD

REVISIONS PER CITY COMMENTS PER CITY COMMENTS 01.05.24

ORIGINAL ISSUE DATE **SEPTEMBER 25, 2023** DRAWING TITLE

> **OVERALL LANDSCAPE PLAN**

	PEA JOB NO.	2021
	P.M.	
Received 1/8/2024	DN.	
	DES.	
y of Rochester Hills anning & Economic	DRAWING NUMBE	R:

LINE OF PROTECTED TREES OPERATIONS TREE MEASURED AT 4.5' ABOVE GROUND EXISTING SOIL

TREE PROTECTION DETAIL

SCALE: 1'' = 3'-0''

TREE PROTECTION WILL BE ERECTED PRIOR TO START OF CONSTRUCTION ACTIVITIES AND SHALL REMAIN IN PLACE UNTIL CONSTRUCTION IS COMPLETE

NO PERSON MAY CONDUCT ANY ACTIVITY WITHIN THE DRIP LINE OF ANY TREE DESIGNATED TO REMAIN; INCLUDING, BUT NOT LIMITED TO PLACING SOLVENTS, BUILDING MATERIAL, CONSTRUCTION EQUIPMENT OR SOIL DEPOSITS WITHIN DRIP LINES

GRADE CHANGES MAY NOT OCCUR WITHIN THE DRIP

DURING CONSTRUCTION, NO PERSON SHALL ATTACH ANY DEVICE OR WIRE TO ANY REMAINING TREE

ALL UTILITY SERVICE REQUESTS MUST INCLUDE NOTIFICATION TO THE INSTALLER THAT PROTECTED TREES MUST BE AVOIDED. ALL TRENCHING SHALL OCCUR OUTSIDE OF THE PROTECTIVE FENCING

TREES LOCATED ON ADJACENT PROPERTY THAT MAY BE AFFECTED BY CONSTRUCTION ACTIVITIES MUST BE

TREES TO BE PRESERVED SHALL BE IDENTIFIED WITH FLAGGING PRIOR TO THE TREE CLEARING

PROVIDE FENCE AROUND CRITICAL ROOT ZONE OF

FENCE SHALL BE PLACED IN A CIRCLE WITH A MINIMUM RADIUS OF 1' PER 1" DIAMETER OF THE

4'HIGH PROTECTIVE FENCING WITH STEEL POSTS - 10' O.C.



GROUP

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CAUTION!! THE LOCATIONS AND ELEVATIONS OF EXISTING UNDERGROUND UTILITIES AS SHOWN ON THIS DRAWING ARE ONLY APPROXIMATE. NO GUARANTEE IS EITHER EXPRESSED OR IMPLIED AS TO THE COMPLETENESS OR ACCURACY THEREOF. THE CONTRACTOR SHALL BE EXCLUSIVELY RESPONSIBLE FOR DETERMINING THE EXACT UTILITY LOCATIONS AND ELEVATIONS PRIOR TO THE START OF CONSTRUCTION.

CLIENT

MARKUS

PROJECT TITLE

**NORTH HILL** 

**SHOPPING** 

CENTER

**MANAGEMENT** 

GROUP, LLC 251 EAST MERRILL STREET, SUITE: 205 BIRMINGHAM, MICHIGAN 48009

1467 N. ROCHESTER ROAD

12.06.23

01.05.24

ROCHESTER HILLS, OAKLAND COUNTY, MICHIGAN

PERMALOC ALUMINUM EDGING OR APPROVED EQUAL WITH BLACK FINISH BED MEDIA - COMPACTED SUBGRADE SPECIFICATIONS FOR LANDSCAPE BED EDGING: LANDSCAPE BED EDGING SHALL BE ALUMINUM AS MANUFACTURED BY PERMALOC 1.800.356.9660 8' OR 16' SECTIONS SHALL BE USED WITH ONE STAKE PER 38" OF


EDGING SHALL BE 3" THICK X 4" DEPTH WHEN ADJ. TO MULCH AND 경" THICK X 5 ½" DEPTH WHEN ADJ. TO ROCK, FINISH: BLACK DURAFLEX MEETING AAMA 2603

STAKE SHALL SECURELY ENGAGE EDGING AND SHALL BE ENTIRELY BELOW TOP SURFACE OF EDGING

EDGING SHALL HAVE A MINIMUM OF 2" OF INTERLOCKING OVERLAP BETWEEN SECTIONS

INSTALL AS PER MANUFACTURER'S SPECIFICATIONS WITH TOP OF EDGING  $\frac{1}{4}$ " - $\frac{1}{2}$ " ABOVE COMPACTED FINISH GRADE. FINISH GRADE TO BE COMPACTED ON BOTH SIDES OF EDGING TO MAINTAIN STABILITY

ALUMINUM EDGE DETAIL SCALE: 1/2'' = 1'-0''

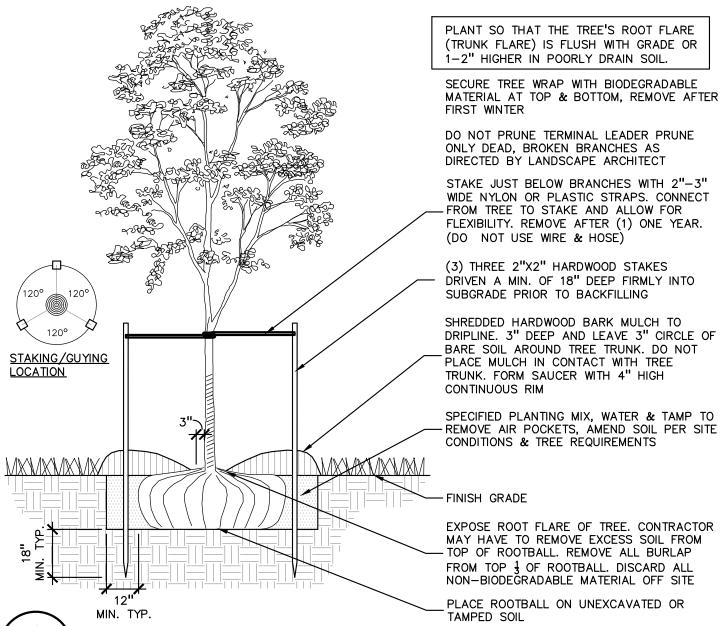

REVISIONS PER CITY COMMENTS PER CITY COMMENTS ORIGINAL ISSUE DATE: SEPTEMBER 25, 2023 DRAWING TITLE LANDSCAPE

> 2021-0512 PEA JOB NO. P.M. JPB DN. ΒZ DES. JLE DRAWING NUMBER:

**DETAILS** 

NOT FOR CONSTRUCTION (CITY FILE #23-0071; SECTION 10)

PLANT SO THAT TOP OF ROOT BALL IS FLUSH TO GRADE OR 1-2" HIGHER IF IN POORLY DRAINED SOILS DO NOT COVER TOP OF ROOTBALL WITH SOIL FORM SAUCER WITH 4" HIGH CONTINUOUS RIM

VARIES PER SPECIES SEE PLAN FOR QUANTITY

PLAN VIEW

SECTION VIEW

SCALE: 1'' = 2'-0''

PERENNIAL PLANTING DETAIL

SPECIES SEE PLAN FOR

QUANTITY

PLANT PERENNIALS EQUAL DISTANCE IN

ALL SPACING IS TO BE TRIANGULAR UNLESS NOTED OR GRAPHICALLY SHOWN

3" SHREDDED BARK MULCH. DO NOT

PILE MULCH AGAINST PLANT STEMS SHOVEL CUT EDGE OR ALUMINUM

EDGING AS INDICATED ON PLAN

- SPECIFIED PLANTING MIX

NOTE: REMOVE ALL CONTAINERS PRIOR

ALL DIRECTIONS

OTHERWISE

TO PLANTING

SHREDDED HARDWOOD BARK MULCH 3" DEEP AND LEAVE 3" CIRCLE OF BARE SOIL AROUND TRUNK. DO NOT PLACE MULCH IN CONTACT WITH TRUNK - FINISH GRADE SPECIFIED PLANTING MIX. WATER AND

TAMP TO REMOVE AIR POCKETS REMOVE ALL BURLAP FROM TOP 1 OF ROOTBALL. DISCARD ALL NON-BIODEGRADABLE MATERIAL OFF SITE VARIES ON CONTAINER \_ PLACE ROOTBALL ON UNEXCAVATED OR

SHRUB PLANTING DETAIL SCALE: 1'' = 2' - 0''


OR BALL SIZE

J2023-0071



SCALE: 1'' = 3'-0''

DECIDUOUS TREE PLANTING DETAIL

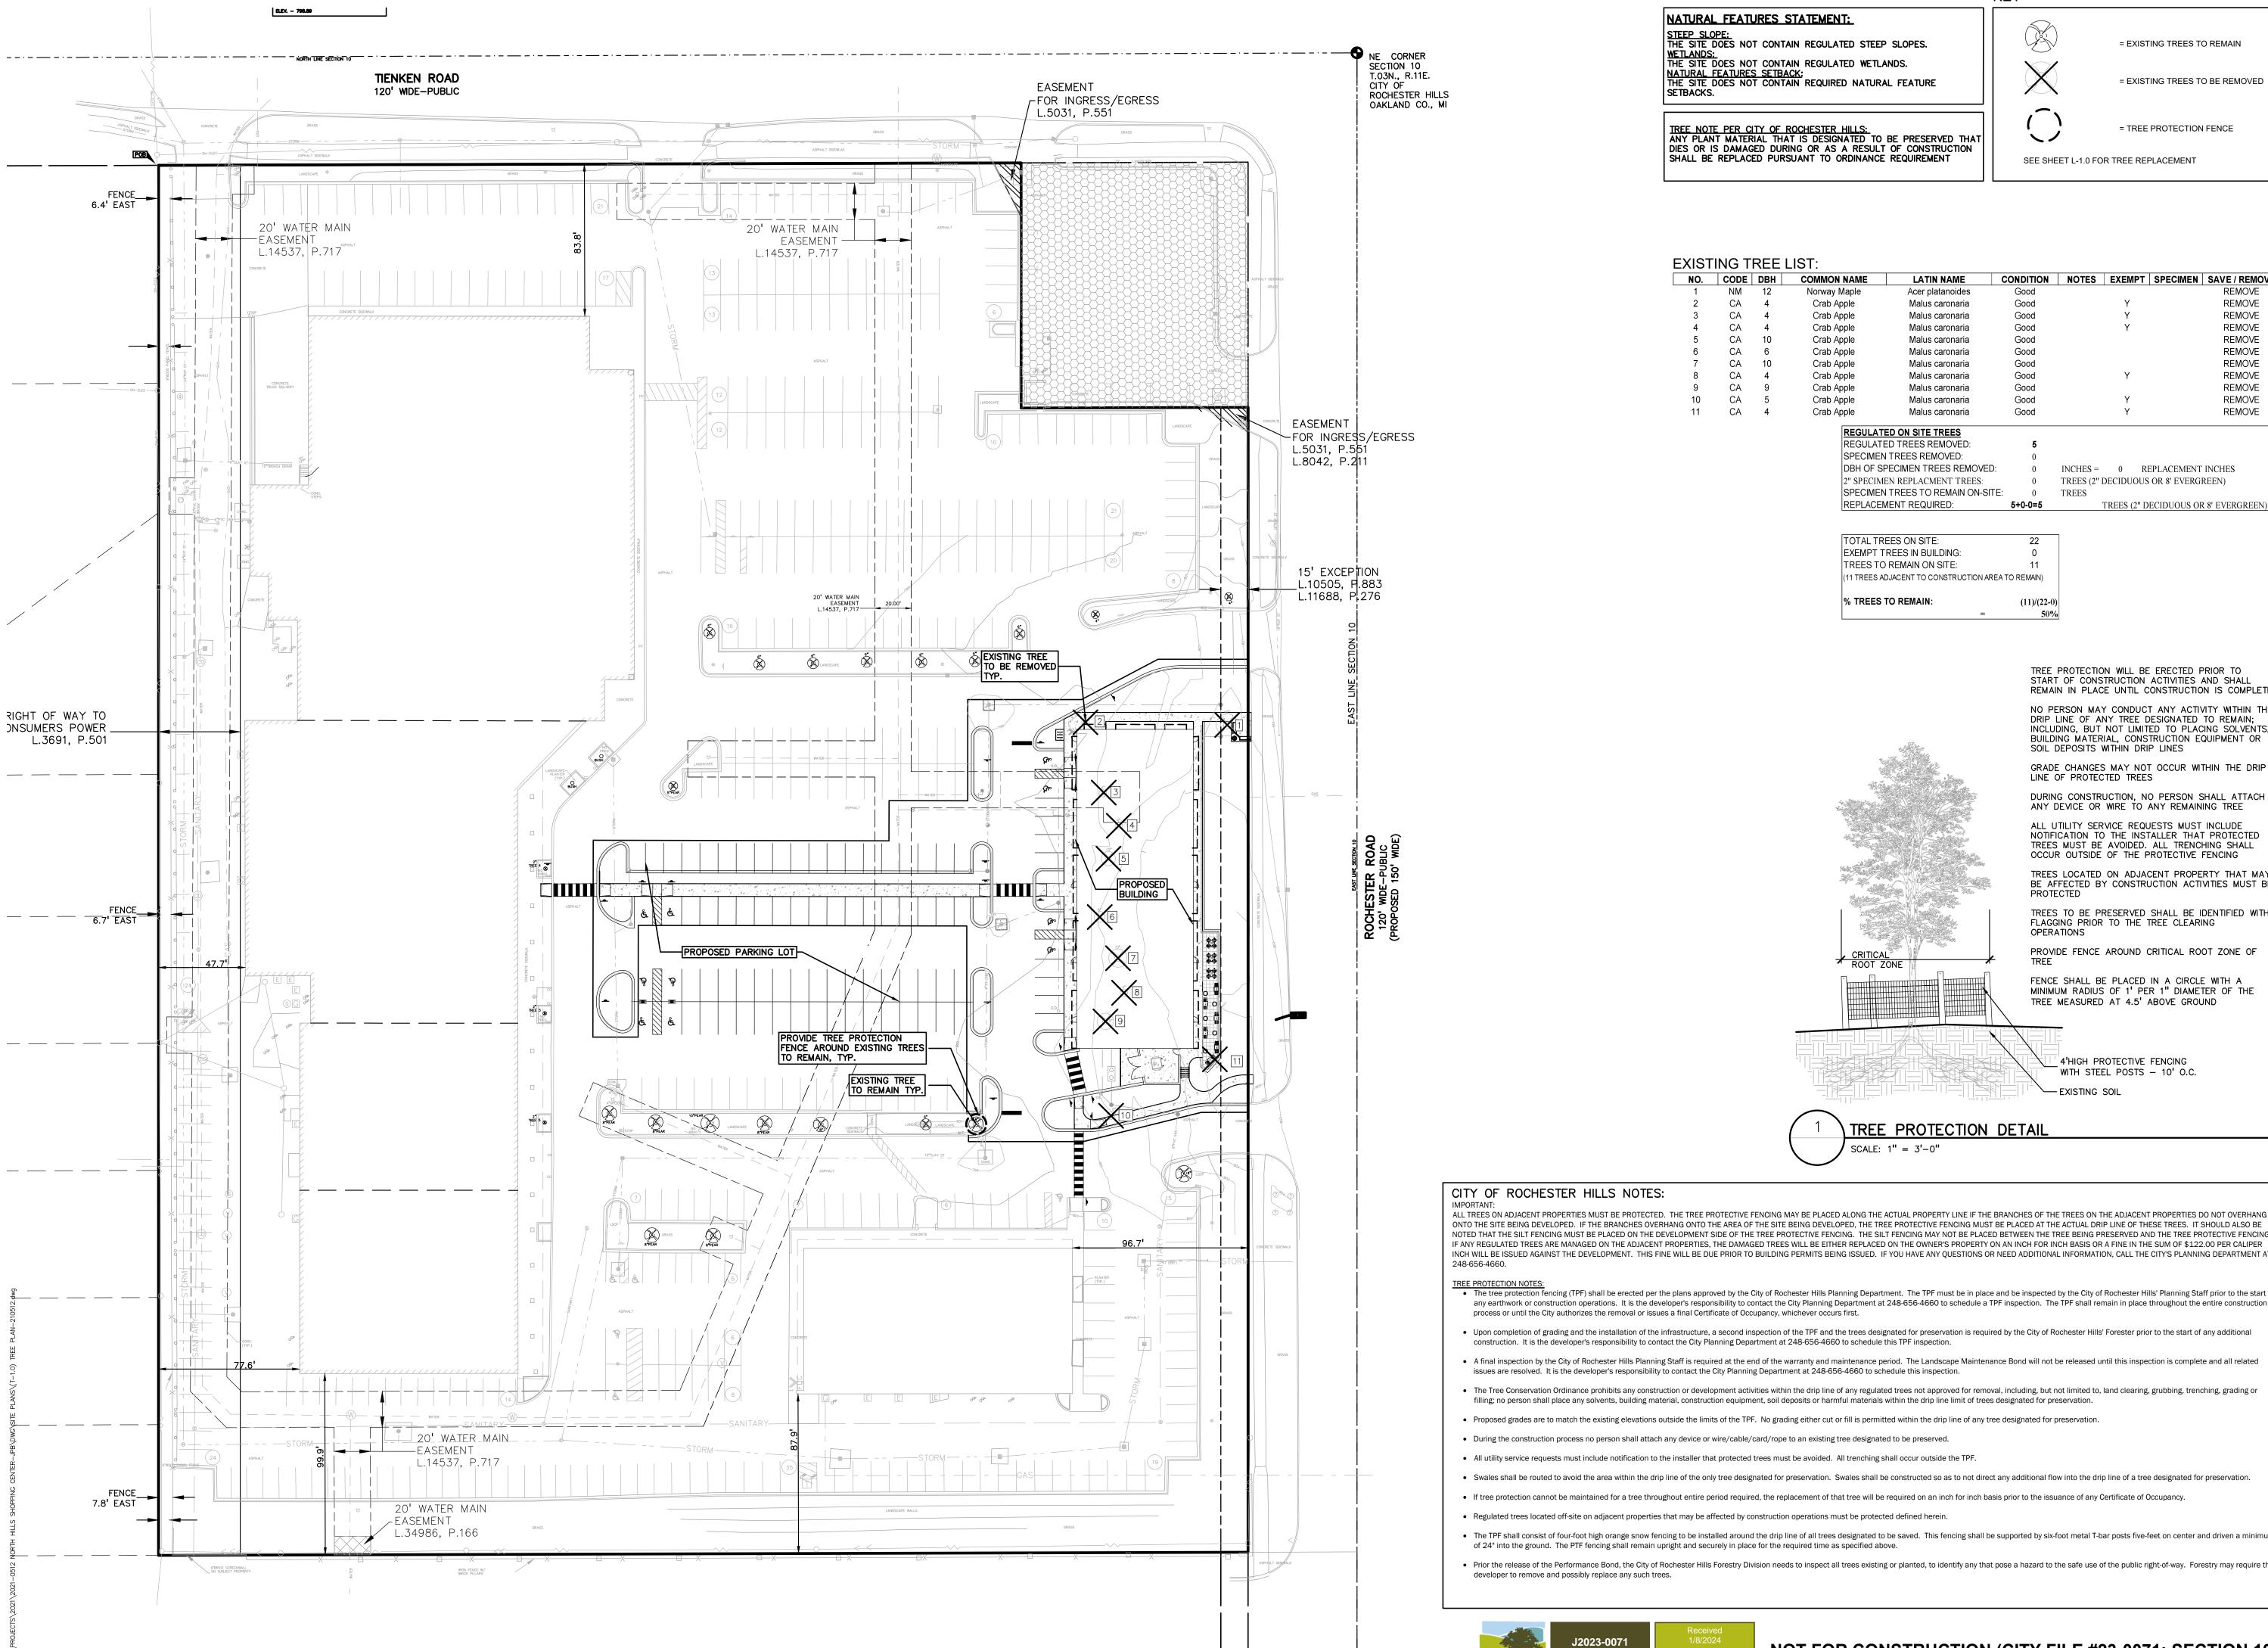

**NATURAL FEATURES STATEMENT:** 

**EXISTING TREE LIST:** 

CA

STEEP SLOPE: THE SITE DOES NOT CONTAIN REGULATED STEEP SLOPES. WETLANDS:
THE SITE DOES NOT CONTAIN REGULATED WETLANDS. NATURAL FEATURES SETBACK:
THE SITE DOES NOT CONTAIN REQUIRED NATURAL FEATURE

TREE NOTE PER CITY OF ROCHESTER HILLS:
ANY PLANT MATERIAL THAT IS DESIGNATED TO BE PRESERVED THAT DIES OR IS DAMAGED DURING OR AS A RESULT OF CONSTRUCTION SHALL BE REPLACED PURSUANT TO ORDINANCE REQUIREMENT

Crab Apple

= EXISTING TREES TO REMAIN = EXISTING TREES TO BE REMOVED

SEE SHEET L-1.0 FOR TREE REPLACEMENT

CONDITION NOTES EXEMPT SPECIMEN SAVE / REMOVE

KEY

Good

Good

Good

Good

Good

= TREE PROTECTION FENCE



www.peagroup.com







INCHES = 0 REPLACEMENT INCHES TREES (2" DECIDUOUS OR 8' EVERGREEN)

TREES (2" DECIDUOUS OR 8' EVERGREEN)

REMOVE

REMOVE

REMOVE

REMOVE

REMOVE

REMOVE

REMOVE

**REMOVE** 

REMOVE

REMOVE

TAL TREES ON SITE:	22	
EMPT TREES IN BUILDING:	0	
EES TO REMAIN ON SITE:	11	
REES ADJACENT TO CONSTRUCTION AREA TO REMAIN)		
REES TO REMAIN:	(11)/(22-0)	

LATIN NAME

Acer platanoides

Malus caronaria

REGULATED ON SITE TREES

SPECIMEN TREES REMOVED:


REPLACEMENT REQUIRED:

REGULATED TREES REMOVED:


DBH OF SPECIMEN TREES REMOVED:

SPECIMEN TREES TO REMAIN ON-SITE:

2" SPECIMEN REPLACMENT TREES:

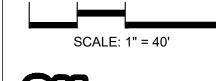



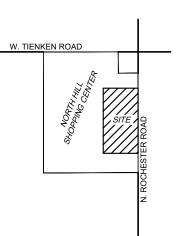

BUILDING MATERIAL, CONSTRUCTION EQUIPMENT OR SOIL DEPOSITS WITHIN DRIP LINES GRADE CHANGES MAY NOT OCCUR WITHIN THE DRIP LINE OF PROTECTED TREES

DURING CONSTRUCTION, NO PERSON SHALL ATTACH ANY DEVICE OR WIRE TO ANY REMAINING TREE ALL UTILITY SERVICE REQUESTS MUST INCLUDE

NOTIFICATION TO THE INSTALLER THAT PROTECTED

TREES MUST BE AVOIDED. ALL TRENCHING SHALL

TREE PROTECTION WILL BE ERECTED PRIOR TO START OF CONSTRUCTION ACTIVITIES AND SHALL REMAIN IN PLACE UNTIL CONSTRUCTION IS COMPLETE NO PERSON MAY CONDUCT ANY ACTIVITY WITHIN THE

DRIP LINE OF ANY TREE DESIGNATED TO REMAIN;

INCLUDING, BUT NOT LIMITED TO PLACING SOLVENTS,


OCCUR OUTSIDE OF THE PROTECTIVE FENCING TREES LOCATED ON ADJACENT PROPERTY THAT MAY BE AFFECTED BY CONSTRUCTION ACTIVITIES MUST BE

TREES TO BE PRESERVED SHALL BE IDENTIFIED WITH FLAGGING PRIOR TO THE TREE CLEARING

OPERATIONS PROVIDE FENCE AROUND CRITICAL ROOT ZONE OF

FENCE SHALL BE PLACED IN A CIRCLE WITH A MINIMUM RADIUS OF 1' PER 1" DIAMETER OF THE TREE MEASURED AT 4.5' ABOVE GROUND

> 4'HIGH PROTECTIVE FENCING WITH STEEL POSTS - 10' O.C.

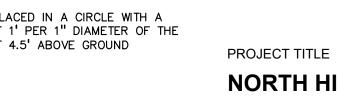

**NORTH HILL SHOPPING** CENTER 1467 N. ROCHESTER ROAD

REVISIONS

PER CITY COMMENTS

PER CITY COMMENTS

ORIGINAL ISSUE DATE:

**SEPTEMBER 25, 2023** 

DRAWING TITLE

CLIENT

**MARKUS** 

**MANAGEMENT** 

BIRMINGHAM, MICHIGAN 48009

TREE PROTECTION DETAIL

# CITY OF ROCHESTER HILLS NOTES:

ALL TREES ON ADJACENT PROPERTIES MUST BE PROTECTED. THE TREE PROTECTIVE FENCING MAY BE PLACED ALONG THE ACTUAL PROPERTY LINE IF THE BRANCHES OF THE TREES ON THE ADJACENT PROPERTIES DO NOT OVERHANG ONTO THE SITE BEING DEVELOPED. IF THE BRANCHES OVERHANG ONTO THE AREA OF THE SITE BEING DEVELOPED, THE TREE PROTECTIVE FENCING MUST BE PLACED AT THE ACTUAL DRIP LINE OF THESE TREES. IT SHOULD ALSO BE NOTED THAT THE SILT FENCING MUST BE PLACED ON THE DEVELOPMENT SIDE OF THE TREE PROTECTIVE FENCING. THE SILT FENCING MAY NOT BE PLACED BETWEEN THE TREE BEING PRESERVED AND THE TREE PROTECTIVE FENCING. IF ANY REGULATED TREES ARE MANAGED ON THE ADJACENT PROPERTIES, THE DAMAGED TREES WILL BE EITHER REPLACED ON THE OWNER'S PROPERTY ON AN INCH FOR INCH BASIS OR A FINE IN THE SUM OF \$122.00 PER CALIPER

• The tree protection fencing (TPF) shall be erected per the plans approved by the City of Rochester Hills Planning Department. The TPF must be in place and be inspected by the City of Rochester Hills' Planning Staff prior to the start of any earthwork or construction operations. It is the developer's responsibility to contact the City Planning Department at 248-656-4660 to schedule a TPF inspection. The TPF shall remain in place throughout the entire construction process or until the City authorizes the removal or issues a final Certificate of Occupancy, whichever occurs first.

- Upon completion of grading and the installation of the infrastructure, a second inspection of the TPF and the trees designated for preservation is required by the City of Rochester Hills' Forester prior to the start of any additional construction. It is the developer's responsibility to contact the City Planning Department at 248-656-4660 to schedule this TPF inspection.
- A final inspection by the City of Rochester Hills Planning Staff is required at the end of the warranty and maintenance period. The Landscape Maintenance Bond will not be released until this inspection is complete and all related issues are resolved. It is the developer's responsibility to contact the City Planning Department at 248-656-4660 to schedule this inspection.
- The Tree Conservation Ordinance prohibits any construction or development activities within the drip line of any regulated trees not approved for removal, including, but not limited to, land clearing, grubbing, trenching, grading or filling; no person shall place any solvents, building material, construction equipment, soil deposits or harmful materials within the drip line limit of trees designated for preservation.
- Proposed grades are to match the existing elevations outside the limits of the TPF. No grading either cut or fill is permitted within the drip line of any tree designated for preservation.
- During the construction process no person shall attach any device or wire/cable/card/rope to an existing tree designated to be preserved.
- All utility service requests must include notification to the installer that protected trees must be avoided. All trenching shall occur outside the TPF.
- Swales shall be routed to avoid the area within the drip line of the only tree designated for preservation. Swales shall be constructed so as to not direct any additional flow into the drip line of a tree designated for preservation.
- If tree protection cannot be maintained for a tree throughout entire period required, the replacement of that tree will be required on an inch for inch basis prior to the issuance of any Certificate of Occupancy.
- Regulated trees located off-site on adjacent properties that may be affected by construction operations must be protected defined herein.
- of 24" into the ground. The PTF fencing shall remain upright and securely in place for the required time as specified above. • Prior the release of the Performance Bond, the City of Rochester Hills Forestry Division needs to inspect all trees existing or planted, to identify any that pose a hazard to the safe use of the public right-of-way. Forestry may require the developer to remove and possibly replace any such trees.

PEA JOB NO. 2021-0512 DRAWING NUMBER:

**TREE** 


**PRESERVATION** 

**PLAN** 







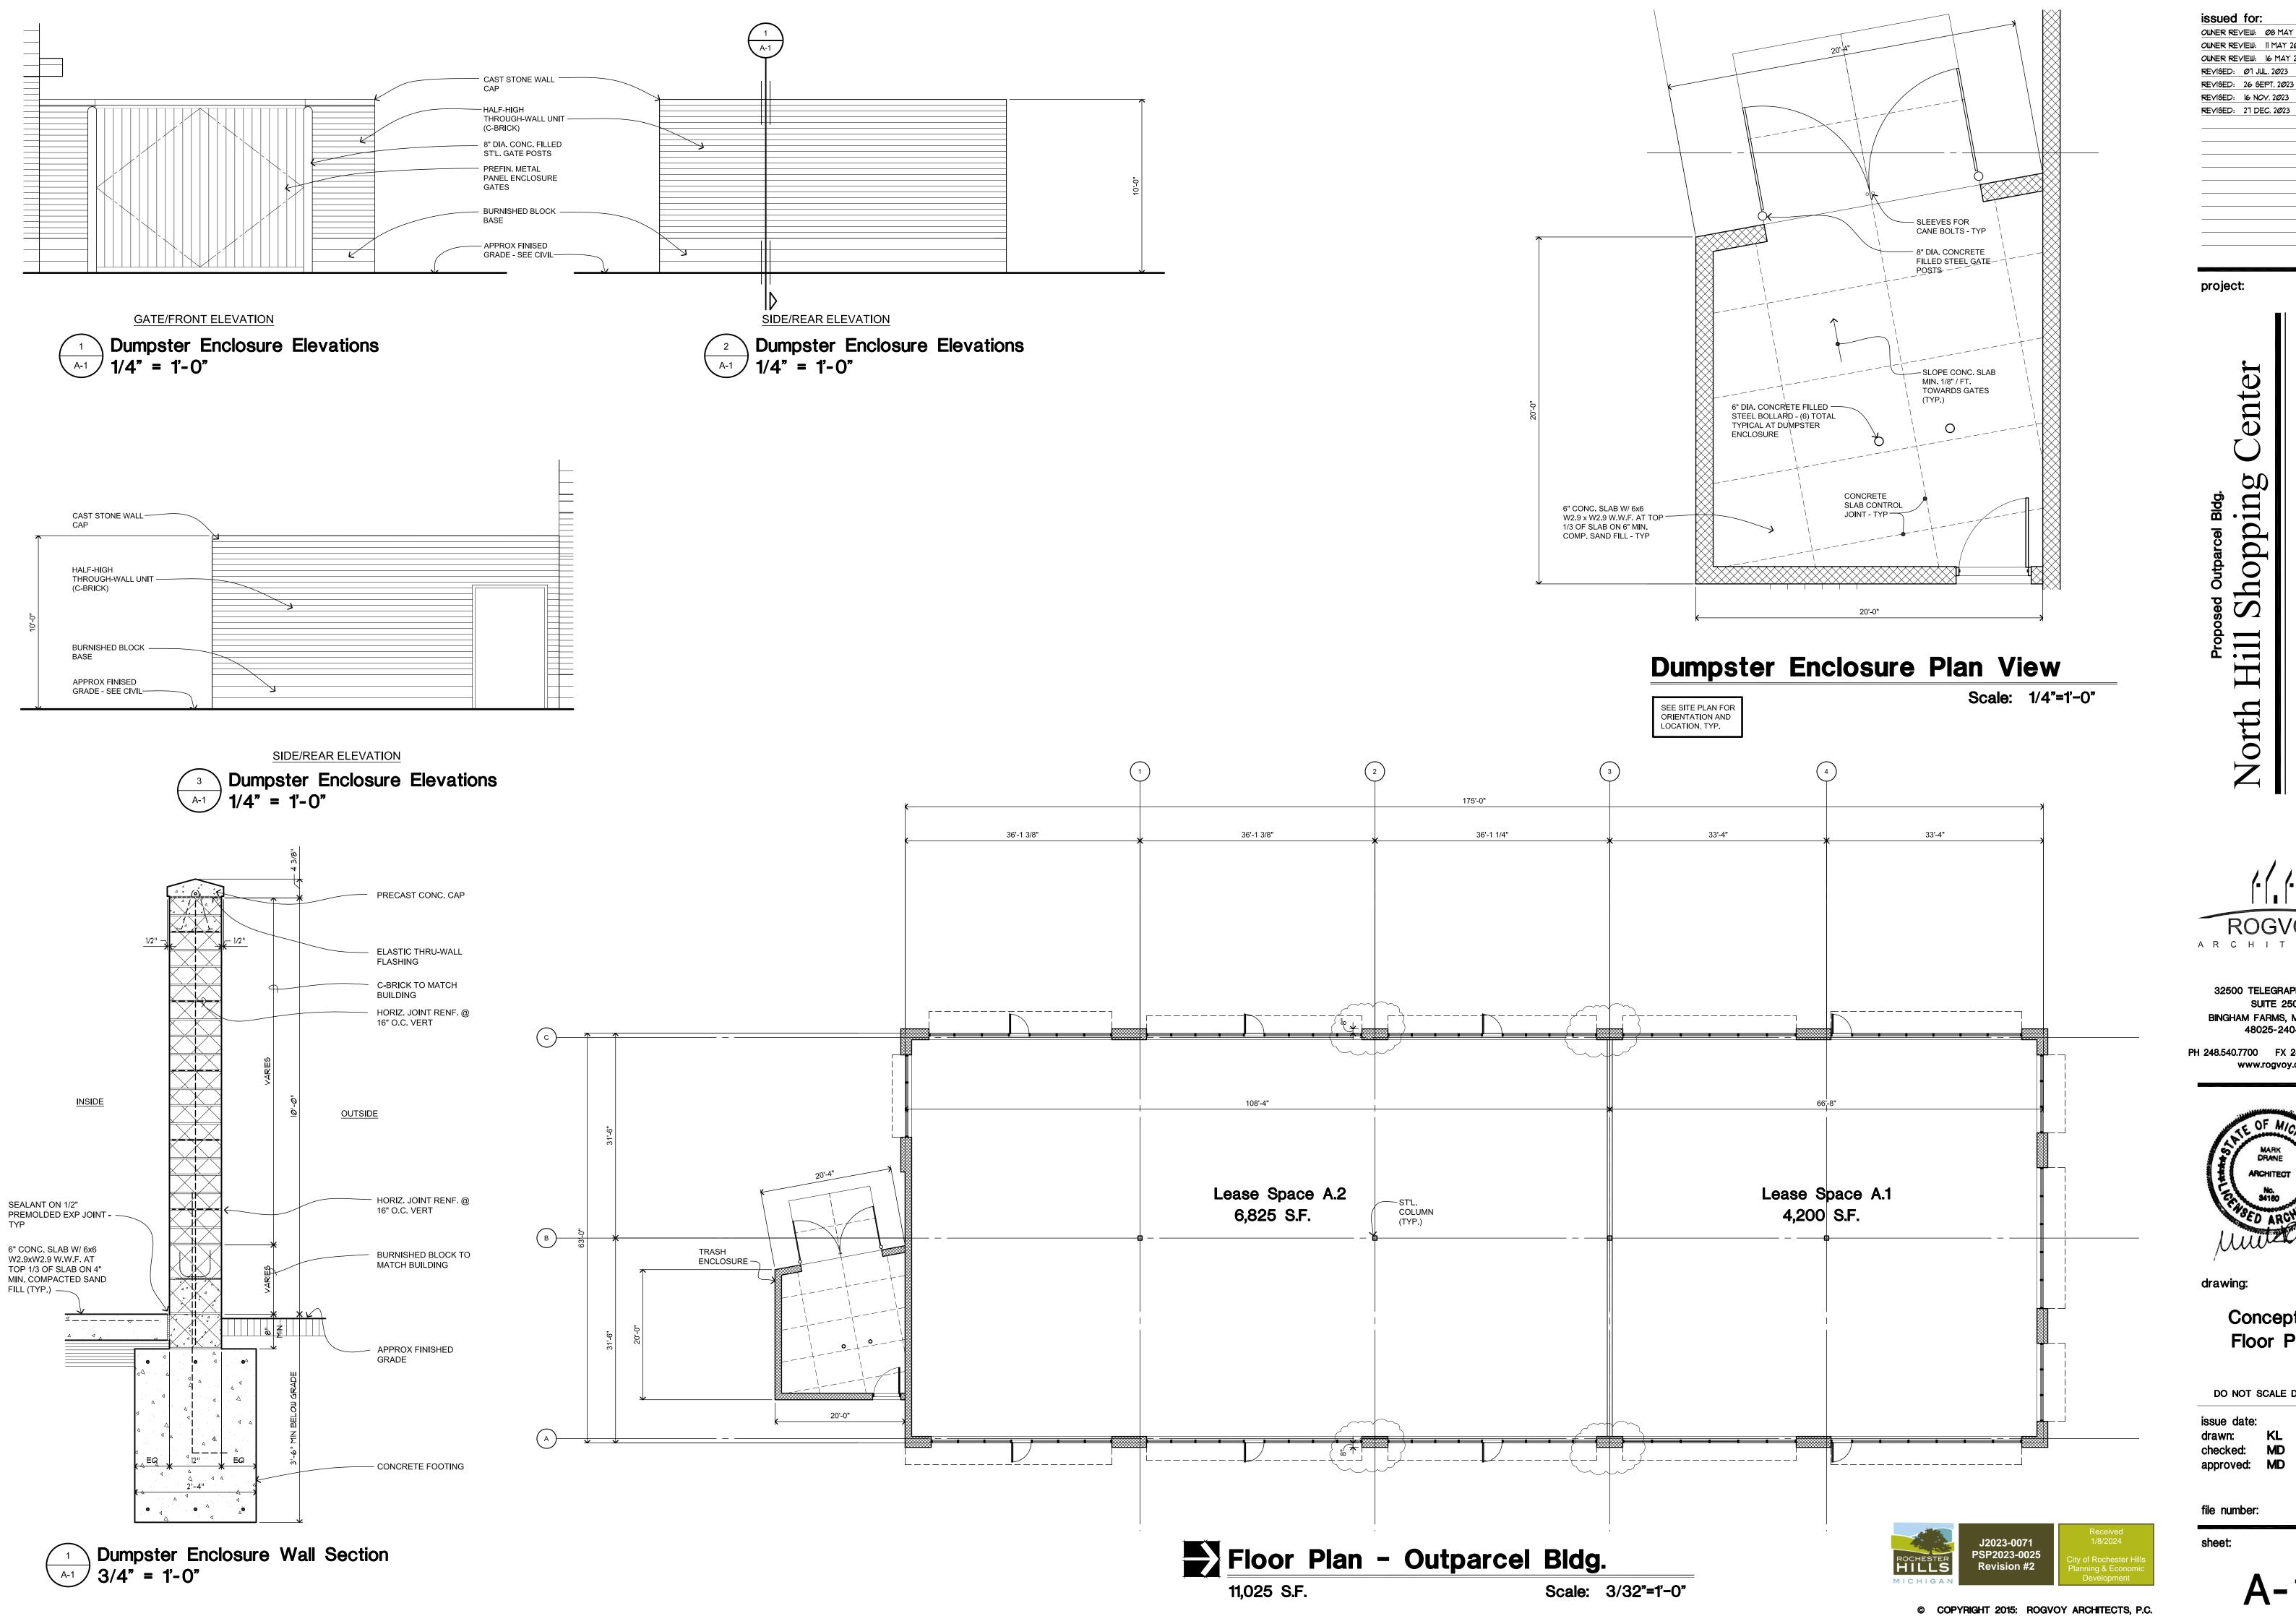

issued for: OWNER REVIEW: Ø8 MAY 2023 OWNER REVIEW: 11 MAY 2023 OWNER REVIEW: 16 MAY 2023 REVISED: 26 SEPT. 2023 REVISED: 16 NOV. 2023

project:

ARCHITECT \$

32500 TELEGRAPH ROAD SUITE 250 BINGHAM FARMS, MICHIGAN

PH 248.540.7700 FX 248.540.2710 www.rogvoy.com




drawing:


Conceptual Floor Plan

DO NOT SCALE DRAWING

issue date: drawn: checked: approved: MD

21036

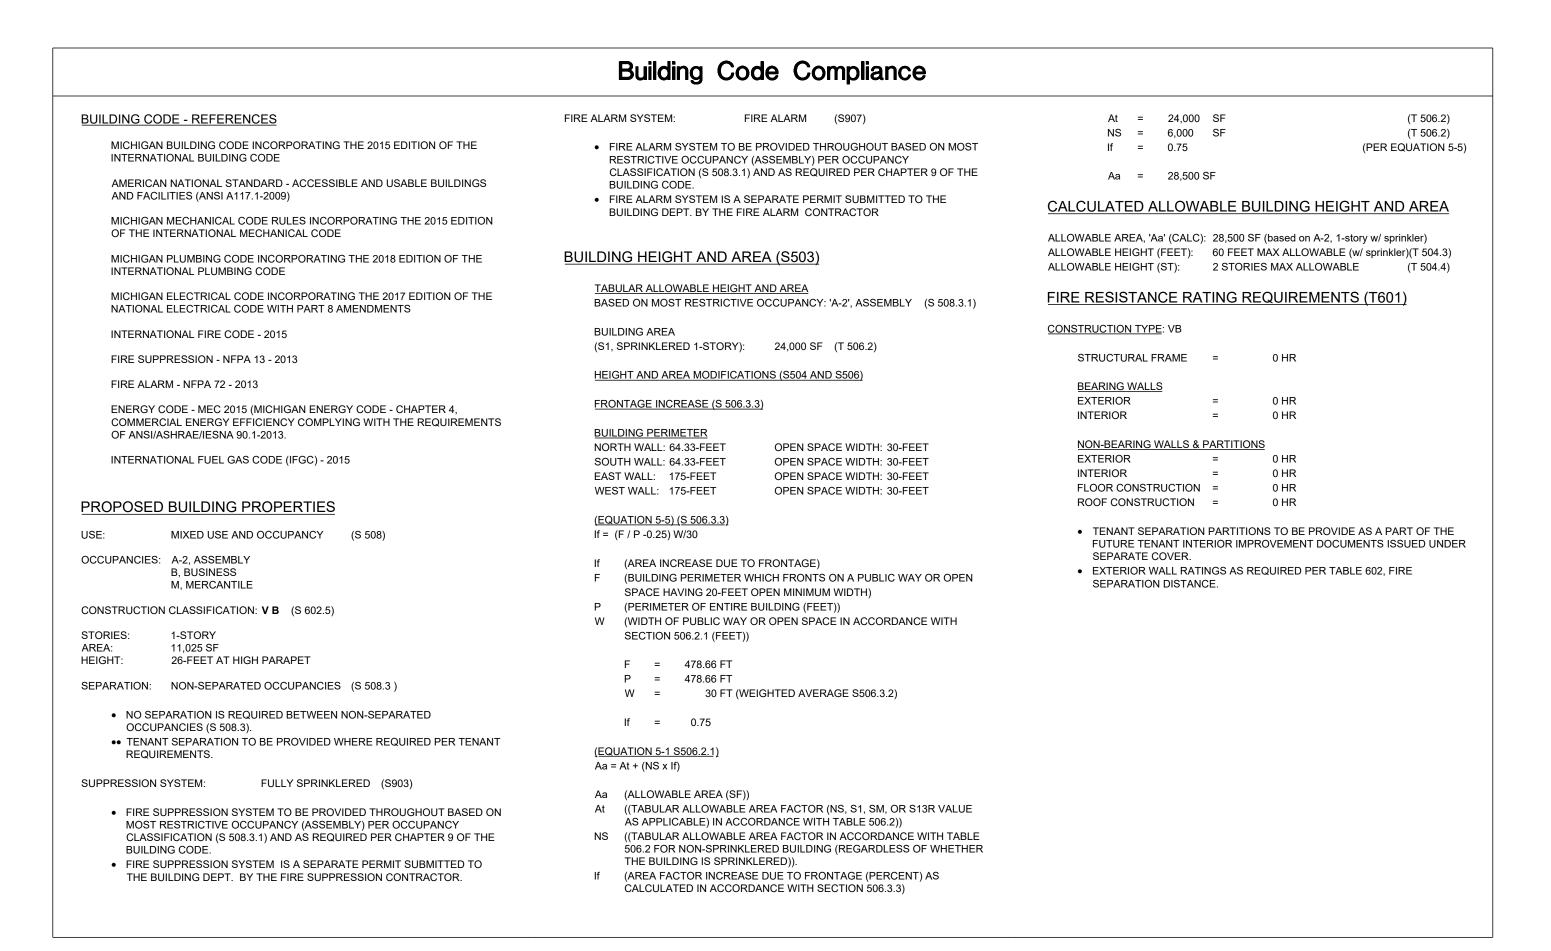

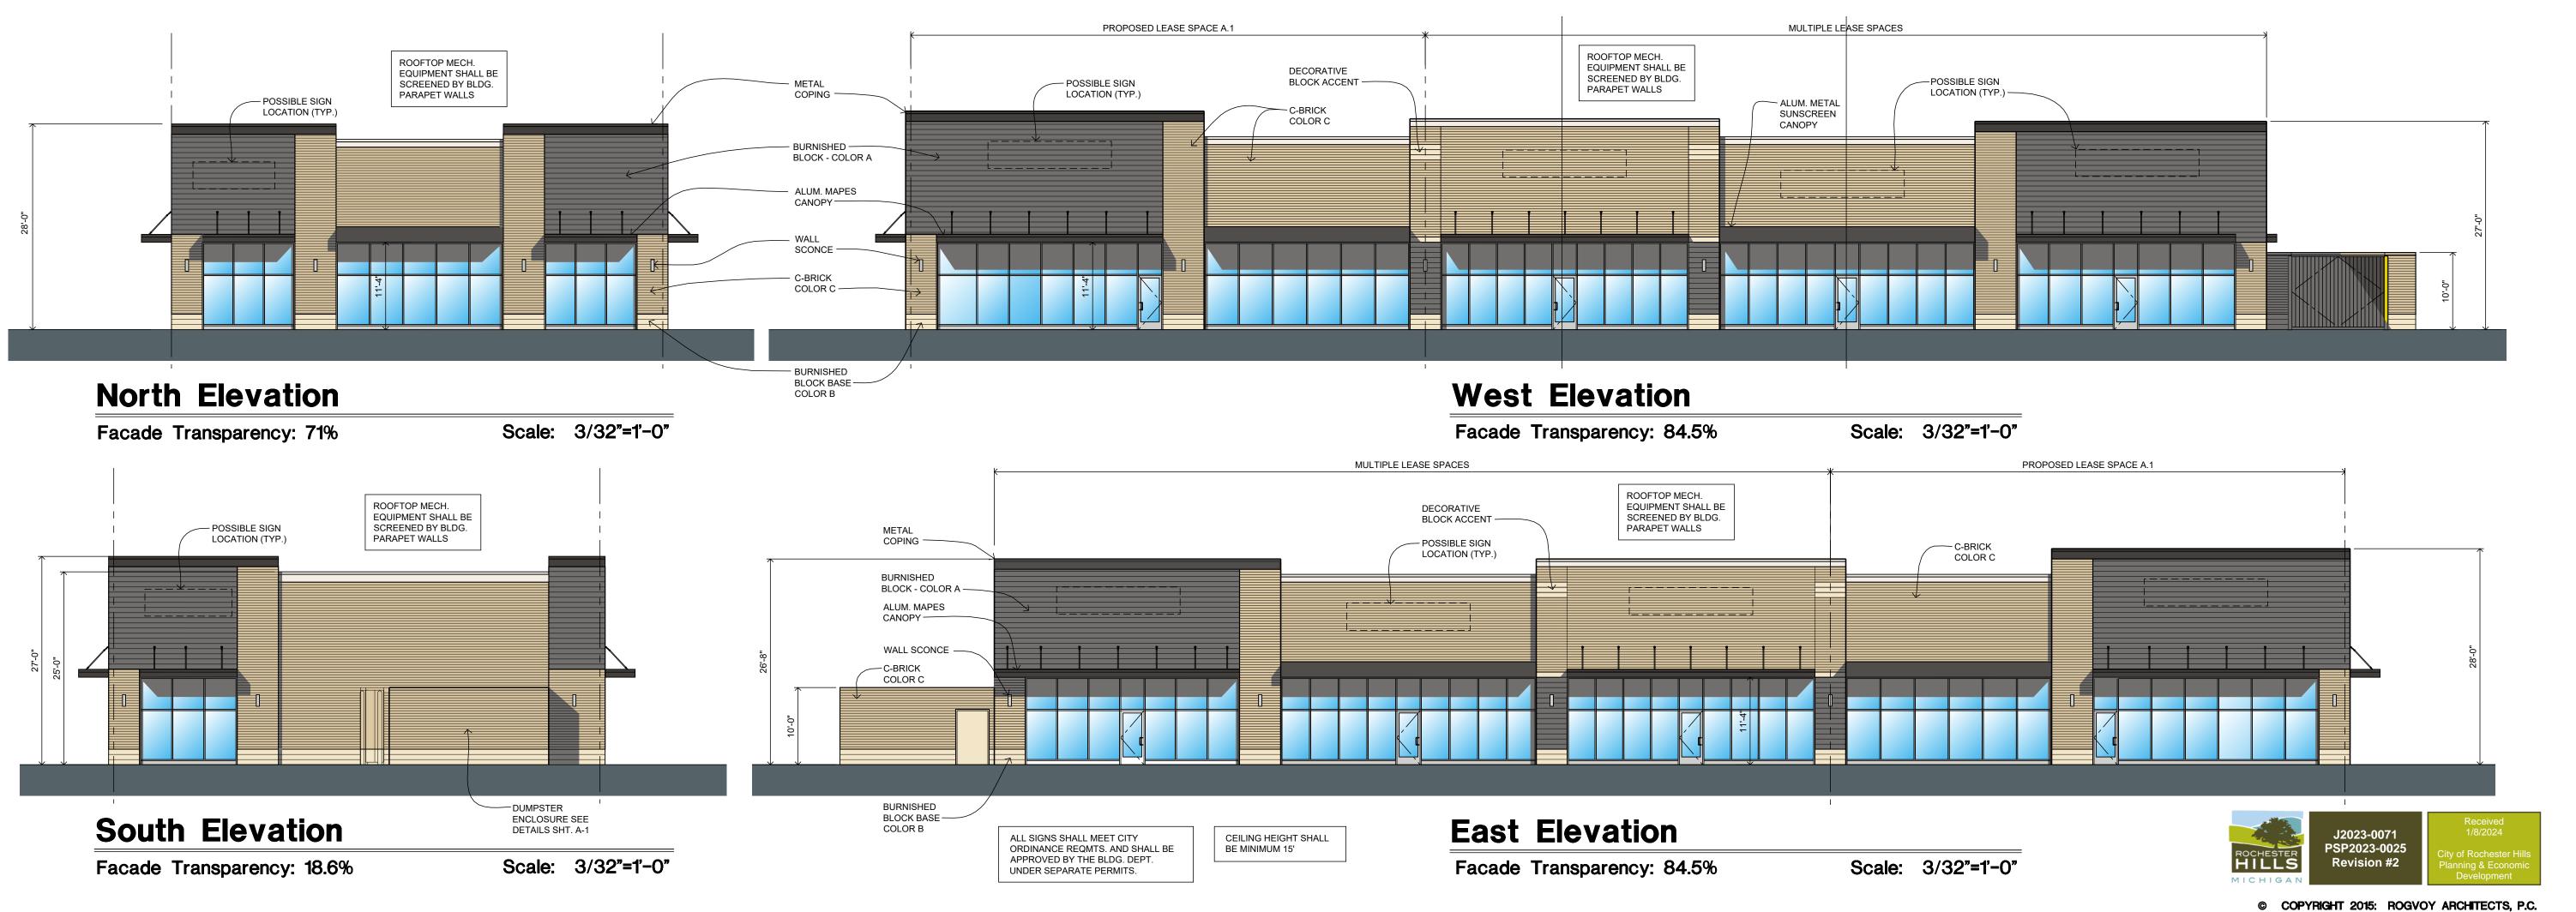

OWNER REVIEW II MAY 2023
OWNER REVIEW I6 MAY 2023
REVISED 01 JUL. 2023
REVISED 16 NOV. 2023
REVISED 21 DEC. 2023

PREVISED 21 DEC. 2023

issued for:

OWNER REVIEW Ø8 MAY 2023

orth Hill Shopping Center

ROGVOY
ARCHITECTS

32500 TELEGRAPH ROAD SUITE 250 BINGHAM FARMS, MICHIGAN 48025-2404

PH 248.540.7700 FX 248.540.2710 www.rogvoy.com



drawing:

Conceptual Bldg. Elevations

DO NOT SCALE DRAWING

MD

21036


issue date: drawn: KL checked: MD

le number:

sheet:

approved:


A-2

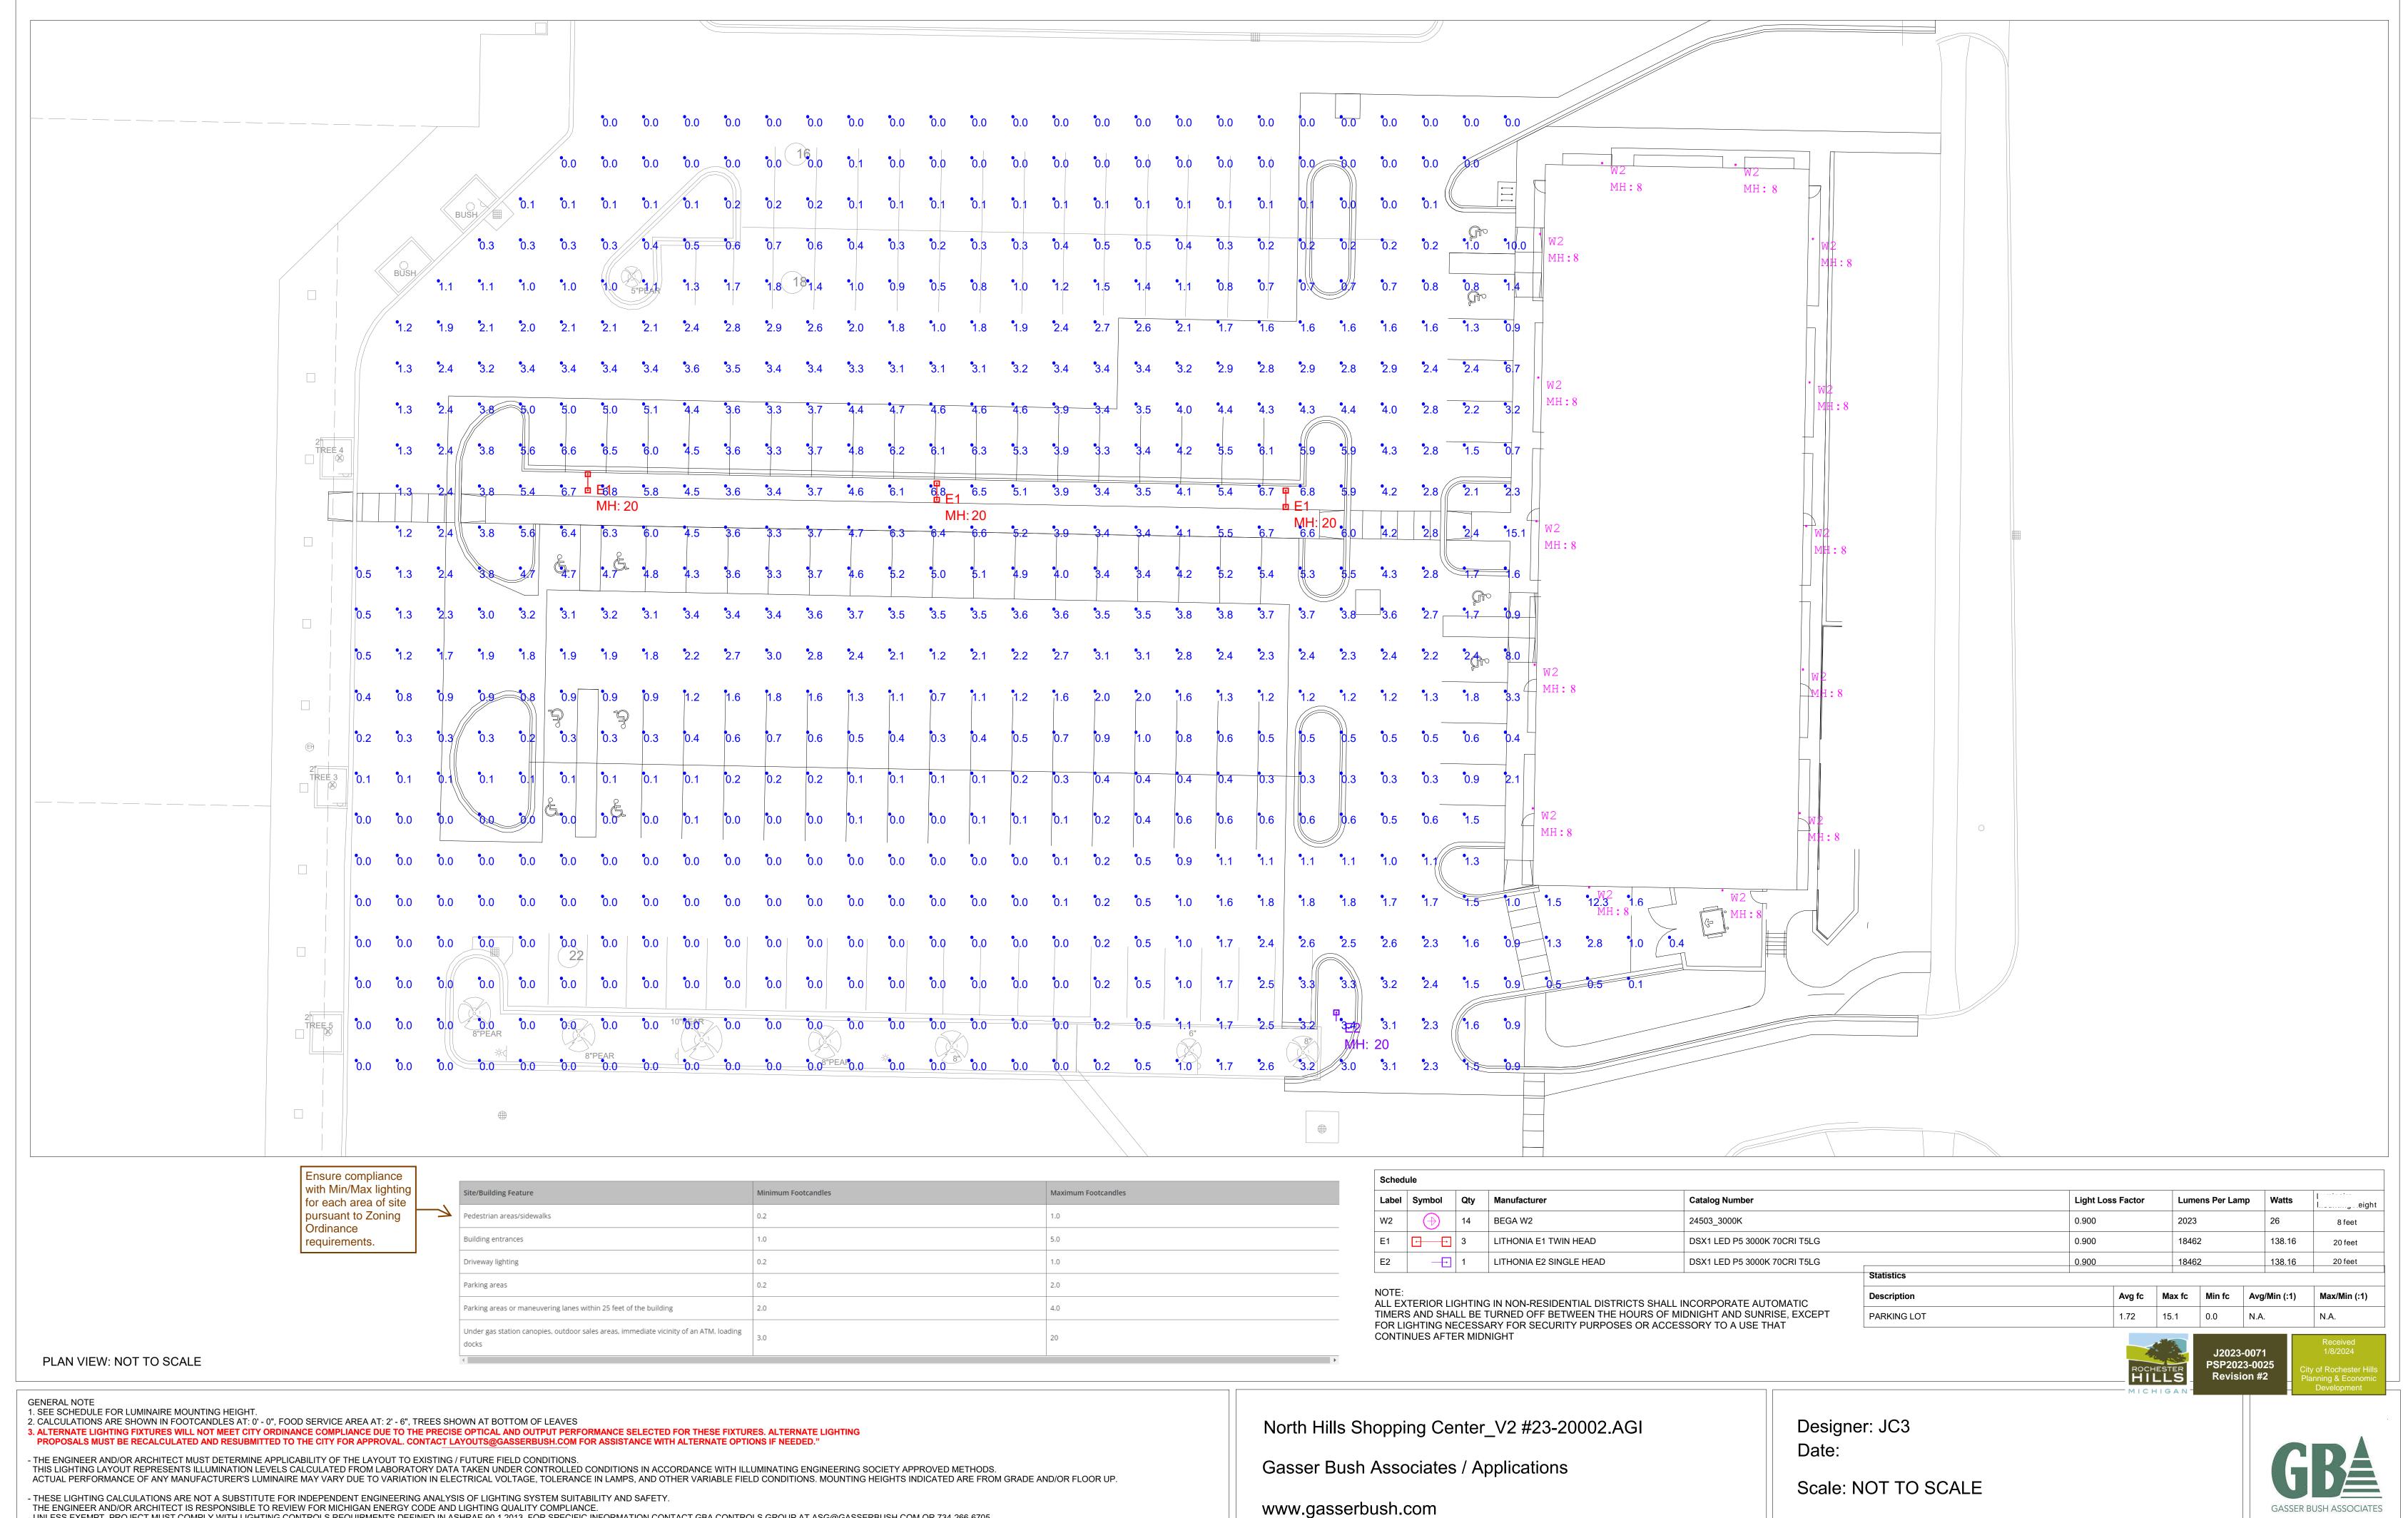

- UNLESS EXEMPT, PROJECT MUST COMPLY WITH LIGHTING CONTROLS REQUIRMENTS DEFINED IN ASHRAE 90.1 2013. FOR SPECIFIC INFORMATION CONTACT GBA CONTROLS GROUP AT ASG@GASSERBUSH.COM OR 734-266-6705. FOR ORDERING INQUIRIES CONTACT GASSER BUSH AT QUOTES@GASSERBUSH.COM OR 734-266-6705.


- THIS DRAWING WAS GENERATED FROM AN ELECTRONIC IMAGE FOR ESTIMATION PURPOSE ONLY. LAYOUT TO BE VERIFIED IN FIELD BY OTHERS - MOUNTING HEIGHT IS MEASURED FROM GRADE TO FACE OF FIXTURE. POLE HEIGHT SHOULD BE CALCULATED AS THE MOUNTING HEIGHT LESS BASE HEIGHT. PHOTOMETRIC PLAN



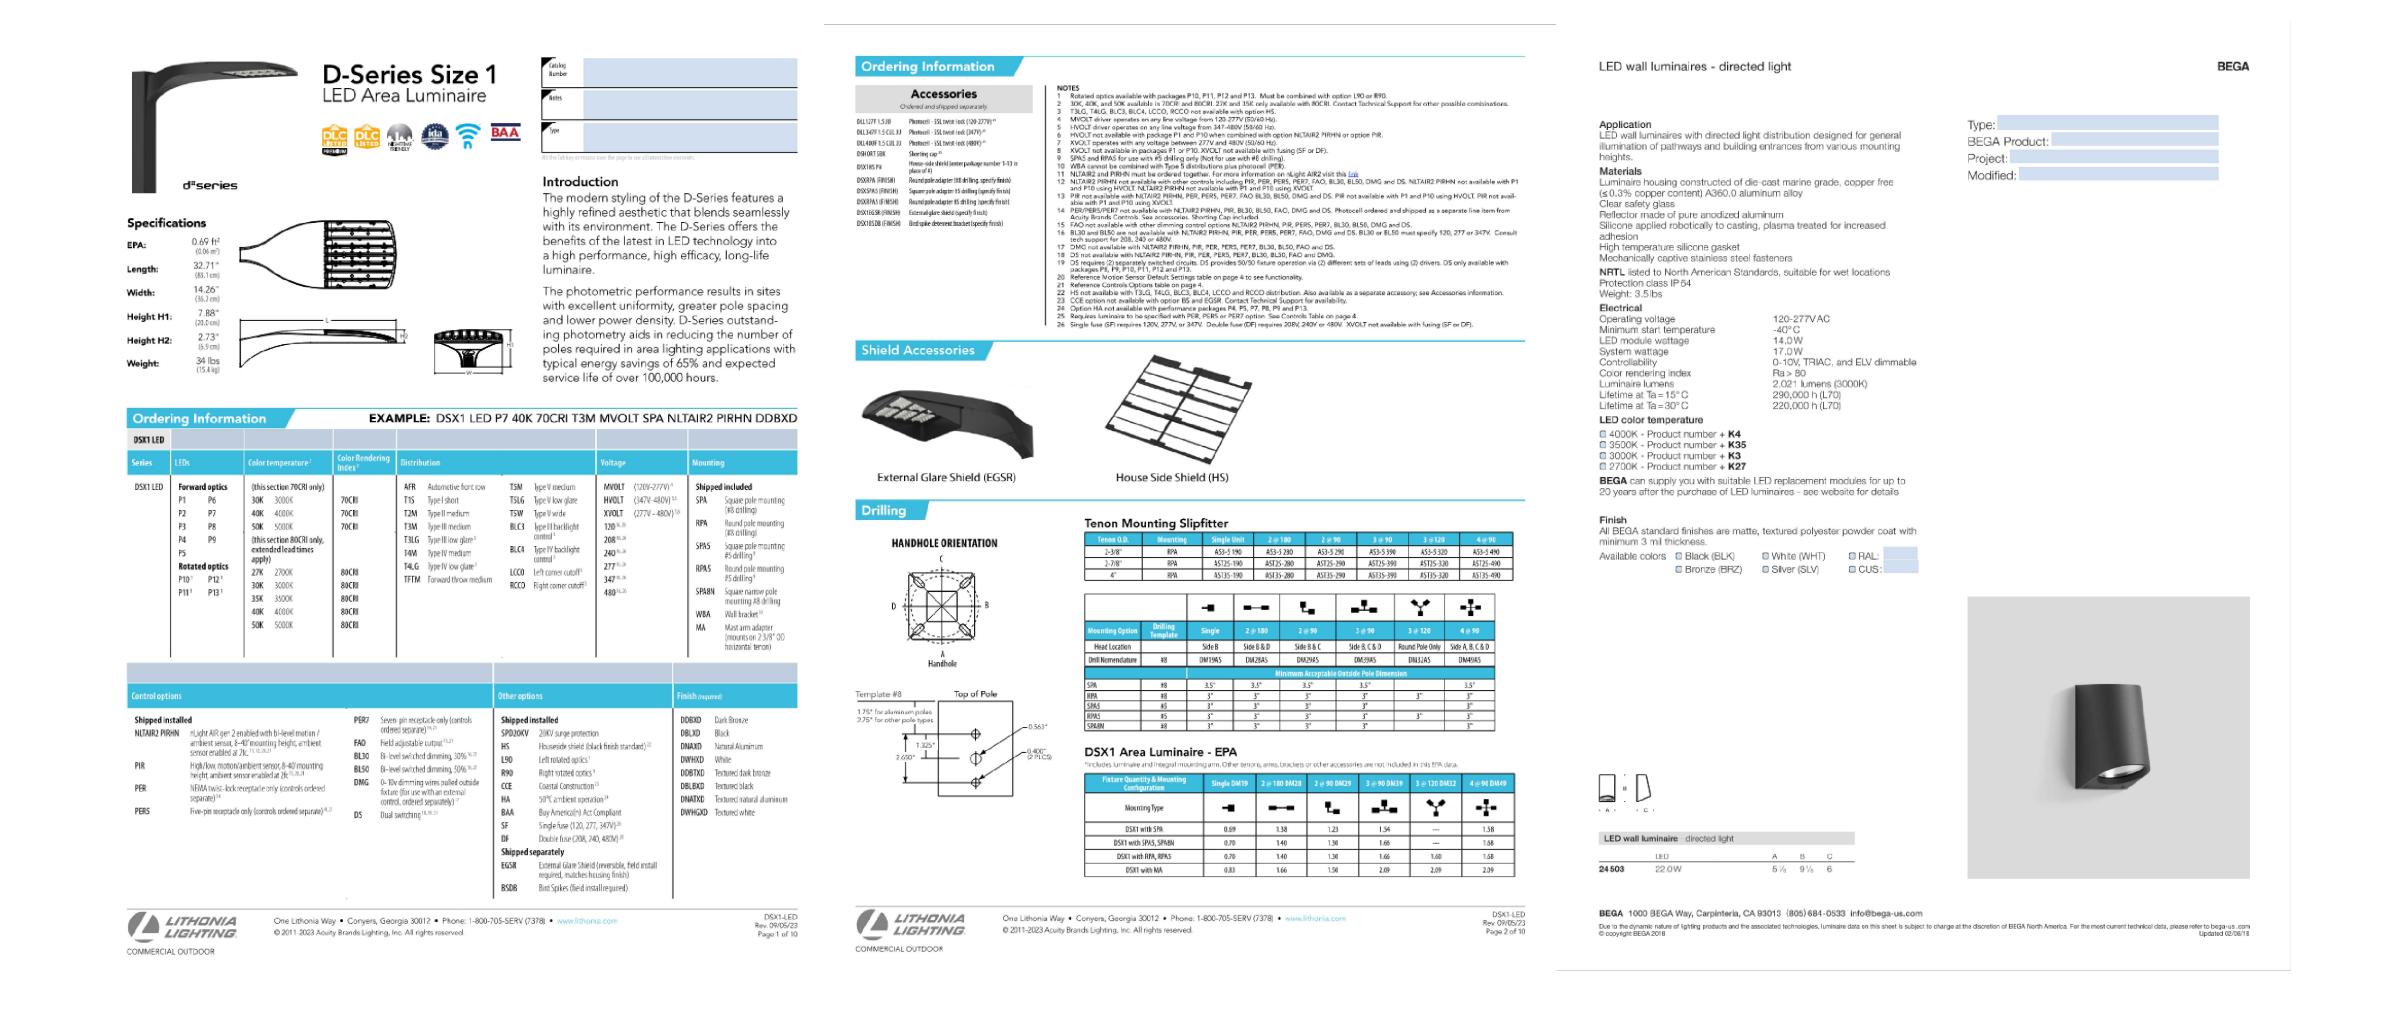



CAUTION!! THE LOCATIONS AND ELEVATIONS OF EXISTING UNDERGROUND UTILITIES AS SHOWN ON THIS DRAWING ARE ONLY APPROXIMATE. NO GUARANTEE IS EITHER EXPRESSED OR IMPLIED AS TO THE COMPLETENESS OR ACCURACY THEREOF. THE CONTRACTOR SHALL BE EXCLUSIVELY RESPONSIBLE FOR DETERMINING THE EXACT UTILITY LOCATIONS AND ELEVATIONS PRIOR TO THE START OF CONSTRUCTION.

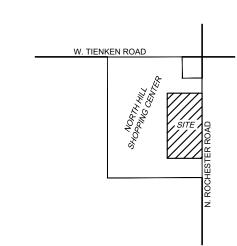

CLIENT

**MARKUS MANAGEMENT** GROUP, LLC 251 EAST MERRILL STREET, SUITE: 205 BIRMINGHAM, MICHIGAN 48009

PROJECT TITLE

**NORTH HILL** SHOPPING CENTER 1467 N. ROCHESTER ROAD

REVISIONS	
PER CITY COMMENTS	12.06.23
PER CITY COMMENTS	01.05.24

ORIGINAL ISSUE DATE: SEPTEMBER 25, 2023

DRAWING TITLE LIGHT FIXTURE

**DETAILS** 

	PEA JOB NO.	2021-051
	P.M.	JP
Received	DN.	SW
1/8/2024	DES.	SW
ity of Rochester Hills Planning & Economic	DRAWING NUMBER:	

## REVISED SITE PLAN.pdf Markup Summary

### **Building Department (7)**



Subject: Building Department

Page Label: 6 Author: Mark Artinian Date: 1/22/2024 12:30:01 PM

Status: Color: Layer: Space: Maximum 2% cross slope at sidewalk.



Subject: Building Department

Page Label: 9
Author: Mark Artinian

Date: 1/22/2024 12:37:27 PM

Status: Color: Layer: Space: **VAN ACCESSIBLE** 



Subject: Building Department

Page Label: 9
Author: Mark Artinian

**Date:** 1/22/2024 12:39:00 PM

Status: Color: Layer: Space: All accessible parking spaces shall be van accessible.

Mark Artinian 248-841-2446 ArtinianM@RochesterHills.org Subject: Building Department

Page Label: 1 Author: Mark Artinian Date: 1/22/2024 12:47:00 PM

Status: Color: Layer:

Space:

Mark Artinian 248-841-2446 ArtinianM@RochesterHills.org



Subject: Building Department

Page Label: 1 Author: Mark Artinian Date: 1/22/2024 12:47:33 PM

Status: Color: Layer: Space: Yes

GENERAL NOTES:

1. PROPOSED BUILDING SQ Page

2. MINIMUM WIDTH OF PRO OF CURB.

3. NO UNDERGROUND DETE

Subject: Building Department

Page Label: 5 Author: Mark Artinian Date: 1/22/2024 1:07:45 PM

Status: Color: Layer: Space:

Subject: Building Department Type 'VB' is a combustible construction type. Page Label: 5 Author: Mark Artinian Date: 1/22/2024 1:09:14 PM Status: Color: Layer: Space: Ellipse (1) Subject: Ellipse Page Label: 1 Author: C.McLeod Date: 1/23/2024 1:12:03 PM Status: Color: Layer: Space: **Engineering Department (1)** Subject: Engineering Department Page Label: 1 Author: Jason Boughton Date: 1/8/2024 1:36:03 PM Status: Color: Layer: Space: Fire Department (1) Subject: Fire Department Page Label: 1 Author: Jon Mills Date: 1/22/2024 8:31:32 AM Status: Color: Layer: Space: Group (20) Subject: Group City of Rochester Hills Planning & Economic Page Label: 1 Development Author: macdonaldj Date: 1/8/2024 1:03:06 PM Status: Color: Layer: Space: Subject: Group SP Page Label: 1 Author: C.McLeod Date: 1/22/2024 8:59:15 AM Status: Color:

Layer: Space:

TRP	Subject: Group Page Label: 1 Author: C.McLeod Date: 1/22/2024 8:59:19 AM Status: Color: ■ Layer: Space:	
ВР	Subject: Group Page Label: 1 Author: C.McLeod Date: 1/22/2024 9:00:01 AM Status: Color: Layer: Space:	
	Subject: Group Page Label: 1 Author: C.McLeod Date: 1/22/2024 9:01:54 AM Status: Color: Layer: Space:	LIP
TON (CITY FILE #22-4071; SECTION 16)	Subject: Group Page Label: 2 Author: C.McLeod Date: 1/23/2024 1:07:41 PM Status: Color: Layer: Space:	Received 1/8/2024  City of Rochester Hills Planning & Economic Development
TION (CITY FLE #23-4071; SECTION 16)	Subject: Group Page Label: 3 Author: C.McLeod Date: 1/23/2024 1:07:51 PM Status: Color: Layer: Space:	Received 1/8/2024  City of Rochester Hills Planning & Economic Development
TION (CITY FILE #23-4071; SECTION 10)	Subject: Group Page Label: 16 Author: C.McLeod Date: 1/23/2024 1:07:57 PM Status: Color: Layer: Space:	Received 1/8/2024  City of Rochester Hills Planning & Economic Development



Subject: Group Page Label: 15

Author: C.McLeod

Date: 1/23/2024 1:08:05 PM

Status: Color: Layer:

Space:

Received 1/8/2024

City of Rochester Hills Planning & Economic

Development



Subject: Group Page Label: 14 Author: C.McLeod

Date: 1/23/2024 1:08:11 PM

Status: Color: Layer: Space: Received 1/8/2024

City of Rochester Hills Planning & Economic

Development



Subject: Group Page Label: 13 Author: C.McLeod

Date: 1/23/2024 1:08:17 PM

Status: Color: Layer: Space: Received 1/8/2024

City of Rochester Hills Planning & Economic

Development



Subject: Group Page Label: 12 Author: C.McLeod

Date: 1/23/2024 1:08:23 PM

Status: Color: Layer: Space: Received 1/8/2024

City of Rochester Hills Planning & Economic

Development



Subject: Group
Page Label: 11
Author: C.McLeod
Pate: 1/22/2024 1:09:28 Pi

Date: 1/23/2024 1:08:28 PM

Status: Color: Layer: Space: Received 1/8/2024

City of Rochester Hills Planning & Economic

Development



Subject: Group Page Label: 10 Author: C.McLeod

Date: 1/23/2024 1:08:34 PM

Status: Color: Layer: Space: Received 1/8/2024

City of Rochester Hills Planning & Economic

Development

SON AND POST INSTALLATIO ULLANDSCRETE SEAS  FEMALES  FRANCE  F	Subject: Group Page Label: 9 Author: C.McLeod Date: 1/23/2024 1:08:38 PM Status: Color: Layer: Space:	Received 1/8/2024 City of Rochester Hills Planning & Economic Development
ION (CITY FILE #23-6071; SECTION 19)	Subject: Group Page Label: 8 Author: C.McLeod Date: 1/23/2024 1:08:44 PM Status: Color: Layer: Space:	Received 1/8/2024  City of Rochester Hills Planning & Economic Development
AND THE STREET OF THE STREET O	Subject: Group Page Label: 7 Author: C.McLeod Date: 1/23/2024 1:08:51 PM Status: Color: Layer: Space:	Received 1/8/2024  City of Rochester Hills Planning & Economic Development
TON (CITY PILE \$23-0071; SECTION 10)	Subject: Group Page Label: 6 Author: C.McLeod Date: 1/23/2024 1:08:56 PM Status: Color: Layer: Space:	Received 1/8/2024  City of Rochester Hills Planning & Economic Development
TION (CITY FILE #23-0071; SECTION 10)	Subject: Group Page Label: 5 Author: C.McLeod Date: 1/23/2024 1:09:02 PM Status: Color: Layer: Space:	Received 1/8/2024  City of Rochester Hills Planning & Economic Development
ABOURN AND AND AND AND AND AND AND AND AND AN	Subject: Group Page Label: 4 Author: C.McLeod Date: 1/23/2024 1:09:07 PM Status: Color: Layer: Space:	Received 1/8/2024  City of Rochester Hills Planning & Economic Development

### Highlight (13)



Subject: Highlight Page Label: 5
Author: Jon Mills

Date: 1/11/2024 3:49:47 PM

Status: Color: Layer: Space:



Subject: Highlight Page Label: 5 Author: Jon Mills

Date: 1/11/2024 3:49:50 PM

Status: Color: Layer: Space:



Subject: Highlight Page Label: 5
Author: Jon Mills

Date: 1/11/2024 3:49:57 PM

Status: Color: Layer: Space:



Subject: Highlight Page Label: 5 Author: Jon Mills

Date: 1/11/2024 3:50:08 PM

Status: Color: Layer: Space:



Subject: Highlight Page Label: 5 Author: Jon Mills

Date: 1/11/2024 3:50:15 PM

Status: Color: Layer: Space:



Subject: Highlight Page Label: 5 Author: Jon Mills

Date: 1/11/2024 3:50:35 PM


Status: Color: Layer: Space:



Subject: Highlight Page Label: 5
Author: Jon Mills

Date: 1/11/2024 3:50:39 PM

Status: Color: Layer: Space:

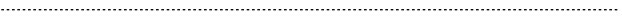




Subject: Highlight Page Label: 5 Author: Jon Mills

Date: 1/11/2024 3:51:00 PM

Status: Color: Layer: Space:

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Subject: Highlight Page Label: 5 Author: Jon Mills

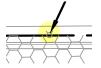Date: 1/11/2024 3:51:17 PM

Status: Color: Layer: Space:




Subject: Highlight Page Label: 5 Author: Jon Mills

Date: 1/11/2024 3:51:28 PM

Status: Color: Layer: Space:

.....

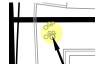

Subject: Highlight Page Label: 5 Author: Jon Mills

**Date:** 1/11/2024 3:51:30 PM

Status: Color: Layer: Space:

Subject: Highlight



Page Label: 5
Author: Jon Mills

Date: 1/11/2024 3:51:41 PM

Status: Color: Layer: Space:



Subject: Highlight Page Label: 5 Author: Jon Mills

Date: 1/11/2024 3:51:42 PM

Status: Color: Layer: Space:

#### Image (1)



Subject: Image Page Label: 15 Author: C.McLeod

Date: 1/22/2024 9:29:35 AM

Status: Color: Layer: Space:

## Jenny McGuckin - YES (1)

Subject: Jenny McGuckin - YES

Page Label: 1

Author: Jenny McGuckin Date: 1/10/2024 9:25:55 AM

Status: Color: Layer: Space:

### Natural Resouces (1)

Subject: Natural Resouces

Page Label: 1

Author: Matt Einheuser Date: 1/16/2024 11:20:17 AM

Status: Color: Layer: Space:

## Planning Department (12)



Subject: Planning Department

Page Label: 8 Author: C.McLeod Date: 1/22/2024 9:10:10 AM

Status: Color: Layer: Space:

On site amenities, particularly those near the road right of way should be consistent with the City's adopted Gateway and Streetscape Master Plan.

https://www.rochesterhills.org/departments/plannin \_\_economic\_development/gatewaysstreetscape

smasterplan.php



Subject: Planning Department

Page Label: 10 Author: C.McLeod

Date: 1/22/2024 9:13:23 AM

Status: Color: Layer: Space:

On site amenities and any retaining walls/railings, particularly those near or facing the road right of way should be consistent with the City's adopted Gateway and Streetscape Master Plan.

https://www.rochesterhills.org/departments/plannin g\_\_\_economic\_development/gatewaysstreetscape

smasterplan.php

Ensure compliance with Min/Max lighting for each area of site pursuant to Zoning Ordinance requirements.

Subject: Planning Department

Page Label: 15
Author: C.McLeod

Date: 1/22/2024 9:18:48 AM

Status: Color: ■ Layer: Space: Ensure compliance with Min/Max lighting for each area of site pursuant to Zoning Ordinance

requirements.



Subject: Planning Department

Page Label: 3
Author: C.McLeod

Date: 1/22/2024 9:25:24 AM

Status: Color: ■ Layer: Space: As noted, Planning Commission approval necessary.




Subject: Planning Department

Page Label: 3
Author: C.McLeod

Date: 1/22/2024 9:26:12 AM

Status: Color: Layer: Space: Planning Commission approval necessary for parking over 125% of minimum parking required.

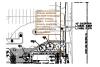

Subject: Planning Department

Page Label: 10 Author: C.McLeod

Date: 1/22/2024 9:27:57 AM

Status: Color: E Layer: Space: Provide additional low level landscaping around amenity space. Location of amenity space may lend itself for including a bicycle fixing station.

Chris McLeod 248-841-2572 mcleodc@RochesterHills.org Subject: Planning Department

Page Label: 1
Author: C.McLeod

Date: 1/22/2024 9:30:04 AM

DESIGN TEAM

Status: Color: Layer: Space:

Subject: Planning Department

Page Label: 1
Author: C.McLeod

Date: 1/22/2024 9:30:48 AM

Status: Color: ■ Layer: Space: Subject to notations on plans

Subject: Planning Department Assessing Yes Page Label: 1 Author: C.McLeod Date: 1/23/2024 1:06:35 PM Status: Color: Layer: Space: Subject: Planning Department Next Steps: Page Label: 1 Schedule Planning Commission Date: Author: C.McLeod Tentative Date - February 20, 2024 - 7:00 p.m. Date: 1/23/2024 1:14:01 PM Status: Color: Layer: Space: Subject: Planning Department PC Page Label: 1 Author: C.McLeod Date: 1/23/2024 1:11:44 PM CI Status: Color: Layer: Space: Subject: Planning Department Page Label: 1 Author: C.McLeod Date: 1/23/2024 1:13:42 PM Status: Color: Layer: Space: Survey/Legal (1) Subject: Survey/Legal A revised benchmark elevation will be required on Page Label: 2 the construction plan. Author: Jenny McGuckin Date: 1/10/2024 9:24:11 AM Status: Color: Layer: Space: Traffic (1) Subject: Traffic Page Label: 1 Author: Keith

Date: 1/23/2024 7:19:40 AM

Status: Color: Layer: Space: