

EXTERIOR RENDERING

1575 E HAMLIN ROAD
CITY FILE #23-0002
SECTION 24

	SECTION	ISSUE	CODE REQUIREMENT	ACTUAL PROVIDED	
901	FIRE PROTECTION SYSTEMS  GROUP B - SPRINKLER REQUIREMENTS	OCCUPANCY GROUP B - NO REQUIREMENTS	NOT REQUIRED FOR 'B' OCCUPANCY	COMPLIES ADDROVED ALITOMATIC SDDINIVLED SYSTEM	
03.2.9	GROUP S-1 - SPRINKLER REQUIREMENTS	AUTOMATIC SPRINKLER SYSTEM REQUIRED THROUGHOUT WITH	REQUIRED FOR 'S-1' OCCUPANCY	COMPLIES - APPROVED AUTOMATIC SPRINKLER SYSTEM PROVIDED THROUGHOUT ENTIRE DEVELOPMENT	
		OCCUPANCY 'S-1' WHEN ONE OF THE FOLLOWING CONDITIONS EXIST:			
		* FIRE AREA EXCEEDS 12,000 S.F.  * FIRE AREA IS LOCATED MORE THAN THREE (3) STORIES ABOVE THE			
		GRADE PLANE.  * THE COMBINED AREA OF ALL GROUP S-1 FIRE AREAS ON ALL FLOORS, INCLUDING ANY MEZZANINES, EXCEEDS 24,000 S.F.			
905	STANDPIPE SYSTEM	STANDPIPE SYSTEMS CLASS I, II, OR III REQUIREMENTS	CLASS I: REQUIRED IN EVERY REQUIRED STAIRWAY WITH HOSE CONNECTIONS AT EVERY INTERMEDIATE FLOOR	NOT REQUIRED	
			LANDING; SPECIFIC GROUP 'A' OCCUPANCIES; COVERED MALL BUILDINGS; UNDERGROUND BUILDINGS		
			CLASS II: RÉQUIRED IN GROUPS A-1 & A-2 WITH OCCUPANT LOADS OVER 1,000		
			CLASS III: REQUIRED BASED ON BUILDING HEIGHT: WHERE FLOOR LEVEL OF HIGHEST STORY IS > 30' FROM THE LOWEST LEVEL OF FIRE DEPT VEHICLE ACCESS. WHERE THE LOWEST		
			STORY IS LOCATED < 30' FROM THE HIGHEST LEVEL OF FIRE DEPT VEHICLE ACCESS.		
906	PORTABLE FIRE EXTINGUISHERS	REQUIRED LOCATIONS	PORTABLE FIRE EXTINGUISHERS REQUIRED IN ALL OCCUPANCY B (OFFICE) & OCCUPANCY S (STORAGE) AREAS.	APPROVED FIRE EXTINGUISHERS PROVIDED AT ALL REQUIRE AREAS	
			REFER TO MICHIGAN BUILDING CODE	AREAS	
907.2	FIRE ALARM SYSTEM	MANUAL, AUTOMATIC (OR BOTH) REQUIREMENTS FOR NEW CONSTRUCTION	GROUP 'B':  MANUAL SYSTEM REQUIRED FOR OCCUPANCIES OF 500 OR  MODE OR 100 DEPOSITS A POWE OR DELICATION OF THE LOWEST LEVEL.	GROUP 'B': NOT REQUIRED - EQUIPPED THROUGHOUT WITH AUTOMATIC	
			MORE OR 100 PERSONS ABOVE OR BELOW THE LOWEST LEVEL OF EXIT DISCHARGE.	SPRINKLER SYSTEM INSTALLED IN ACCORDANCE WITH SECTION 903.3.1.1.	
			MANUAL SYSTEM NOT REQUIRED IF EQUIPPED THROUGHOUT WITH AUTOMATIC SPRINKLER SYSTEM INSTALLED WITH	GROUP 'S-1': NO REQUIREMENTS	
			ACCORDANCE WITH SECTION 903.3.1.1 AND THE OCCUPANT NOTIFICATION APPLIANCES WILL ACTIVATE THROUGHOUT THE NOTIFICATION ZONES UPON SPRINKLER OVERFLOW.		
			GROUP 'S-1':		
007.4.2	MANUAL FIDE ALADMO	LOGATION, AND MOUNTING REQUIREMENTS	NO REQUIREMENTS		
907.4.2	MANUAL FIRE ALARMS	LOCATION AND MOUNTING REQUIREMENTS	'RED' MANUAL PULL ALARMS ARE REQUIRED WITHIN 5' OF ALL ENTRANCES/EXITS, SPACED A MAXIMUM OF 200' APART AND MOUNTED 42"-48" MEASURED VERTICALLY, FROM THE FLOOR	NOT REQUIRED - BUILDING 1 EQUIPPED THROUGHOUT WITH AUTOMATIC SPRINKLER SYSTEM INSTALLED IN ACCORDANCE WITH SECTION 903.3.1.1.	
007.5.2.2.3	VICIDI E AL ADAG	DECLIDED BY AN AND AND AND AND AND AND AND AND AND	LEVEL TO THE ACTIVATING HANDLE OR LEVER OF THE BOX.		
910	VISIBLE ALARMS  SMOKE AND HEAT VENTS	REQUIRED IN ALL PUBLIC & COMMON AREAS  REQUIRED LOCATIONS	REQUIRED IN OFFICE & THROUGH OUT STORAGE  OCCUPANCY GROUP B: NO REQUIREMENTS	PROVIDED - SEE ELECTRICAL DRAWINGS  GROUP B: NOT REQUIRED	
910	SWORE AND HEAT VENTS	REQUIRED LOCATIONS	OCCUPANCY GROUP S-1: REQUIRED WHEN UNDIVIDED OVER 50,000 S.F.	GROUP S-1: AREA DOES NOT EXCEED 50,000SF	
1003.1	MEANS OF EGRESS				
1003.2	CEILING HEIGHT	1003.2 - CEILING HEIGHT	THE MEANS OF EGRESS SHALL HAVE A CEILING HEIGHT OF NOT LESS THAN 7'-6"	COMPLIES	
TABLE	OCCUPANT LOAD	MAXIMUM FLOOR AREA ALLOWANCES PER OCCUPANT	BUSINESS - 100 SF/ OCCUPANT	795 / 100 = 8 PEOPLE	
1004.1.1			STORAGE (WAREHOUSES) - 500 SF/ OCCUPANT	87,573 / 500 = 176 PEOPLE	
			NOTE: GROSS AREA CALCULATIONS ARE FOR OCCUPIABLE AREA	TOTAL OCCUPANCY = <u>184</u> PEOPLE SEE SHEET EGRESS PLANS FOR ADDITIONAL INFORMATION	
1005.1	EGRESS WIDTH	SECTION 1005.1 - OTHER EGRESS COMPONENTS - 0.2 INCHES PER OCCUPANT	OTHER EGRESS COMPONENTS = 0.2 x 184 = 36.8"	REQUIREMENT MET - SEE EGRESS PLANS	
1007	ACCESSIBLE MEAN OF EGRESS	EGRESS FROM ACCESSIBLE SPACES	ACCESSIBLE SPACES SHALL BE PROVIDED WITH NOT LESS	ACCESSIBLE MEANS OF EGRESS ARE PROVIDED	
			THAN ONE ACCESSIBLE MEANS OF EGRESS. WHERE MORE THAT ONE MEANS OF EGRESS ARE REQUIRED BY SECTION 1015.1 OR 1021.1 FROM ANY ACCESSIBLE SPACE, EACH ACCESSIBLE PORTION OF THE SPACE SHALL BE SERVED BY NOT LESS THAN TWO ACCESSIBLE MEANS OF EGRESS.		
1007.3	ACCESSIBLE STAIRWAYS	MINIMUM ACCESSIBLE EGRESS STAIRWAY WIDTH	PROVIDE A CLEAR WIDTH OF 48" MINIMUM BETWEEN	NOT REQUIRED, BUT MINIMUM 48" CLEAR BETWEEN	
			HANDRAILS AND SHALL EITHER INCORPORATE AN AREA OF REFUGE WITHIN AN ENLARGED FLOOR-LEVEL LANDING.	HANDRAILS AND AREA OF REFUGE PROVIDED.  SEE EGRESS PLANS FOR MORE INFORMATION.	
			EXCEPTIONS: 1. THE CLEAR WIDTH OF 48 INCHES IS NOT REQUIRED IN BUILDINGS EQUIPPED THROUGHOUT WITH AN		
1007.6.1	AREAS OF REFUGE	AREA OF REFUGE SIZE	AUTOMATIC SPRINKLER SYSTEM.  EACH AREA OF REFUGE SHALL BE SIZED TO ACCOMMODATE	30" x 48" AREA OF REFUGE NOT REQUIRED	
100,1011			ONE WHEELCHAIR SPACE OF 30" BY 48" FOR EACH 200 OCCUPAN OR PORTION THEREOF, BASED ON THE OCCUPANT LOAD OF THE	ır 	
1007.6.3	AREAS OF REFUGE	TWO-WAY COMMUNICATION	AREA OF REFUGE AND AREAS SERVED BY THE AREA OF REFUGE AREAS OF REFUGE SHALL BE PROVIDED WITH A TWO-WAY	TWO-WAY COMMUNICATION SYSTEM PROVIDED AT	
10071015			COMMUNICATION SYSTEM COMPLYING WITH SECTION 1007.8.1 AND 1007.8.2		
1008.1.1	MEANS OF EGRESS DOORS	MINIMUM CLEAR WIDTH FOR EGRESS DOORS	MINIMUM: 32" WIDE	36" NOMINAL WIDE PROVIDED	
1008.1.2	SWING OF DOORS	SWING OF DOORS	DOORS SHALL SWING IN THE DIRECTION OF EGRESS TRAVEL WHERE SERVING A ROOM OR AREA CONTAINING AN OCCUPAN'	ALL EGRESS DOORS SWING IN DIRECTION OF TRAVEL	
	COLD TO VIDATELLO DE DEDEGGETTO A VIDA		LOAD OF 50 OR MORE PERSONS OR A GROUP H OCCUPANCY.	COMPLIES	
1014.3	COMMON PATH OF EGRESS TRAVEL	EXCEPTION #1 - MAX DISTANCE FOR S-1 OCCUPANCY	MAX. 100 FEET, WITH SPRINKLER SYSTEM	CONTELLS	
1015	EXIT & EXIT ACCESS DOORWAYS	TABLE 1015.1 - SPACES WITH ONE MEANS OF EGRESS	1 EXIT ALLOWED IF OCCUPANT LOAD IS < (B = 49; S-1 = 29)	OCCUPANCY S-1: TWO OR MORE EXITS PROVIDED OCCUPANCY B: ONE EXIT PROVIDED	
		1015.2.1 - TWO EXITS OR EXIT ACCESS DOORWAYS ARRANGEMENT EXCEPTION #2 (BUILDING EQUIPPED W/ AUTOMATIC SPRINKLER SYSTEM)	1/3 OF MAX. BUILDING DIAGONAL (W/ SPRINKLER)	COMPLIES (SEE EGRESS PLANS)	
		1015.2.2 - THREE OR MORE EXITS OR EXIT ACCESS DOORWAYS ARRANGEMENT	AT LEAST TWO EXITS DOORS OR EXIT ACCESS DOORWAY SHALL BE ARRANGE IN ACCORDANCE WITH THE PROVISION OF	COMPLIES (SEE EGRESS PLANS)	
1016	EXIT ACCESS TRAVEL DISTANCE	TABLE 1016.1 - EXIT ACCESS TRAVEL DISTANCE WITH SPRINKLER	SECTION 1015.2.1  B = 300 FT.	COMPLIES (SEE EGRESS PLANS)	
1018	CORRIDORS	SYSTEM  1018.2 - CORRIDOR WIDTH	S-1 = 250FT. 44" MIN.	COMPLIES (SEE EGRESS PLANS)	
1019	COMMIDORS	1910.2 - CORRIDOR WIDTH	36" MIN. W/ REQ'D OCCUPANT CAPACITY OF LESS THAN 50		
		1018.4 - MAXIMUM DEAD END CORRIDOR LENGTH	50'-0" MAX. (W/ SPRINKLER)	COMPLIES (SEE EGRESS PLANS)	
TABLE	MINIMUM NUMBER OF EXITS	OCCUPANT LOAD	FIRST FLOOR (1-500) = 2 MIN	COMPLIES (SEE EGRESS PLANS)	
1021.1			SECOND FLOOR (1-500) = 2 MIN THIRD FLOOR (1-500) = 2 MIN		
ABLE 505.1	MIN. ROOF COVERING CLASS	CLASS A, B OR C ROOF ASSEMBLIES PER CONSTRUCTION TYPE	CONSTRUCTION TYPE II-B - CLASS B (MODERATE FIRE-TEST EXPOSURE) REQUIRED	CLASS A WILL BE PROVIDED	
507.4	ROOF SLOPE	A L THONG	MIN. 1/4" PER 12" (2%)	4" SLOPE PROVIDED ON ALL NEW BUILDINGS	
<u>'LUM</u>	BING FIXTURE CALCU	ALTIONS			
		SELF-STORAGE OCCUPANCY:	1 PER 100 MALE AND FEMALE SELF-STORA	FIXTURES FOR NEW AGE	
		SELF-STORAGE (USE S-1) BUILDINGS 176 OCCUPA FRONT OFFICE (USE B) - 795 GSF / 100 8 OCCUPA TOTAL 184 OCCUPA	(1 WC AND 1 LAVATORY) 4 - UNISEX	FOILET ROOMS	
		ACTUAL EMPLOYEE COUNT 4 MAX	1 PER 1,000 PERSONS	ID 1 LAVATORY EACH) G FOUNTAINS -	
		ACTUAL EMILEOTEE COONT 4 MAX 5 EMPLOYEES	, i	DA COMPLIANT)	
			1 - SERVICE SINK 1 - SERVICE	SINK	

### BUILDING CODE DATA - MICHIGAN BUILDING CODE - 1575 E HAMLIN ROAD ROCHESTER HILLS

APPLICABLE CODES -BUILDING: MICHIGAN BUILDING CODE 2015 - EFFECTIVE APRIL 20, 2017REHAB: MICHIGAN REHABILITATION CODE FOR EXISTING BUILDINGS 2015 - EFFECTIVE DECEMBER 13, 2016 ACCESSIBILITY: ICC ANSI A117.1 - 2009MECHANICAL: MICHIGAN MECHANICAL CODE 2015 - EFFECTIVE APRIL 12, 2017ELECTRICAL: NEC 2017 STATE OF MICHIGAN ELECTRICAL CODE 2017 NATIONAL ELECTRICAL CODE WITH PART 8 AMENDMENTS - EFFECTIVE JANUARY 4, 2019PLUMBING: MICHIGAN PLUMBING CODE 2018 - EFFECTIVE SEPTEMBER 15, 2021ENERGY: MICHIGAN BUILDING CODE 2015 – CHAPTER 13 & MICHIGAN ENERGY CODE 2015 – CHAPTERS 1 THROUGH 6 & MICHIGAN ENERGY CODE, PART 10A. RULES - ANSI/ASHRAE/IES STANDARD 90.1-2013

	,	ALARM: NFPA		RENCED IN THE 2015 MICHIGAN BUILDING FIRE
	SECTION	ISSUE	CODE REQUIREMENT	ACTUAL PROVIDED
302	USE AND OCCUPANCY CLASSIFICATION		GROUP B, BUSINESS (OFFICE) - ACCESSORY USE GROUP S-1, MODERATE HAZARD STORAGE	GROUP B, BUSINESS (OFFICE) - ACCESSORY USE GROUP S-1, MODERATE HAZARD STORAGE
503	GENERAL BUILDING HEIGHTS AND AREAS			
ABLE 503	ALLOWABLE HEIGHT	HEIGHT & STORY LIMITATIONS BASED ON CONSTRUCTION TYPE II-B (SEE SECTION 503) AND THE MORE RESTRICTIVE OCCUPANCY (S-1 MODERATE	MAX. STORIES - 3 75' FOR FULLY SPRINKLER	NEW THREE STORY - 34-10" TOP OF PARAPET
		HAZARD STORAGE - SEE CHAPTER 9)	55' FOR NON SPRINKLER	
ABLE 503	ALLOWABLE BUILDING AREAS	AREA LIMITATIONS BASED ON CONSTRUCTION TYPE II-B (SEE SECTION 602) AND THE MORE RESTRICTIVE OCCUPANCY (S-1 MODERATE HAZARD STORAGE - SEE CHAPTER 9)	MAX. AREA (PER FLOOR) - 52,500 S.F.	*UTILIZE AREA MODIFICATION - SEE BELOW
504.2	BUILDING HEIGHT - AUTOMATIC SPRINKLER SYSTEM INCREASE	WHERE A BUILDING IS EQUIPPED THROUGHOUT WITH AN APPROVED AUTOMATIC SPRINKLER SYSTEMTHE MAXIMUM NUMBER OF STORIES IS INCREASED BY ONE	3 STORIES PERMITTED	THREE STORY BUILDINGS  * HEIGHT MODIFICATION BY SPRINKLER NOT NECESSARY/ NOT USED
506.3	BUILDING AREA - AUTOMATIC SPRINKLER SYSTEM INCREASE	AUTOMATIC SPRINKLER SYSTEM INCREASE (Is)	100% <1 STORY BLDGS.	
506.2.2	TABULAR BUILDING AREA	TABULAR BUILDING AREA BY OCCUPANCY, CONSTRUCTION TYPE AND SPRINKLER	B-OCCUPANCY FULLY SPRINKLERED = 92,000 SF  REQUIRE FRONTAGE BONUS-AREAS COMP TABULAR AREAS AS FOLLOWS:  BUILDING (B) - 795 SF	
				BUILDING 2 (S-1) - 29,191 SF
508.2	ACCESSORY OCCUPANCIES	ACCESSORY OCCUPANCIES ARE THOSE OCCUPANCIES THAT ARE ANCILLARY TO THE MAIN OCCUPANCY OF THE BUILDING OR PORTION THEREOF. ACCESSORY OCCUPANCIES SHALL COMPLY WITH THE PROVISIONS OF SECTIONS 508.2.1 THROUGH 508.2.5.3		MAIN OCCUPANCY: GROUP S-1, MODERATE HAZARD STORAG ACCESSORY OCCUPANCY: GROUP B, BUSINESS
508.2.1	ACCESSORY OCCUPANCIES AREA LIMITATIONS	AGGREGATE ACCESSORY OCCUPANCIES SHALL NOT OCCUPY MORE THAN 10 PERCENT OF THE BUILDING AREA OF THE STORY IN WHICH THEY ARE LOCATED AND SHALL NOT EXCEED THE TABULAR VALUES IN TABLE 503, WITHOUT BUILDING AREA INCREASES IN ACCORDANCE WITH SECTION 506 FOR SUCH ACCESSORY OCCUPANCIES.	MAXIMUM AREA (PER FLOOR) FOR GROUP B OCCUPANCY:  NOT REQUIRED	NOT PROVIDED
508.2.2	OCCUPANCY CLASSIFICATION	OCCUPANCY CLASSIFICATION OF ACCESSORY OCCUPANCIES	ACCESSORY OCCUPANCIES SHALL BE INDIVIDUALLY CLASSIFY IN ACCORDANCE WITH SECTION 302.1. THE REQUIREMENTS OF THIS CODE SHALL APPLY TO EACH PORTION OF THE BUILDING BASED ON THE OCCUPANCY CLASSIFICATION OF THAT SPACE.	COMPLIES
508.2.3	ALLOWABLE BUILDING AREA AND HEIGHT	ALLOWABLE BUILDING AREA AND HEIGHT FOR ACCESSORY OCCUPANCIES	THE ALLOWABLE BUILDING AREA AND HEIGHT OF THE BUILDING SHALL BE BASED ON THE ALLOWABLE BUILDING AREA AND HEIGHT FOR THE MAIN OCCUPANCY IN ACCORDANCE WITH SECTION 503.1.	COMPLIES
508.2.4	SEPARATION OF OCCUPANCIES	SEPARATION OF MAIN AND ACCESSORY OCCUPANCIES	NO SEPARATION IS REQUIRED BETWEEN ACCESSORY OCCUPANCIES AND THE MAIN OCCUPANCY	COMPLIES
602.2 ABLE 601	CONSTRUCTION CLASSIFICATION REQ'D. FIRE-RESISTANCE RATINGS FOR BUILDING ELEMENTS	CONSTRUCTION TYPE	ТҮРЕ ІІ-В	TYPE II-B - NEW
	TOR BOILDING ELEMENTS	STRUCTURAL FRAME	0 HOUR	0 HOUR
		BEARING WALLS		
		EXTERIOR INTERIOR	0 HOUR	0 HOUR
		INTERIOR  NON-BEARING WALLS	0 HOUR	0 HOUR
		EXTERIOR (PER TABLE 602)	SEE TABLE 602 BELOW	SEE TABLE 602 BELOW
		INTERIOR	0 HOUR	0 HOUR
		FLOOR CONSTRUCTION ROOF CONSTRUCTION	0 HOUR	0 HOUR
	FIRE-RESISTANCE RATING REQUIREMENTS FOR EXTERIOR WALLS BASED ON FIRE SEPARATION DISTANCE	TABLE 602  FIRE SEP. DIST < 5 FT = 2 HRS  FIRE SEP. DIST > 5 / < 10 FT 1 HR  FIRE SEP. DIST > 10 / < 30 FT 1 HRS  FIRE SEP. DIST > 30 FT 0 HRS	0 HOUR  N/A N/A APPLIES APPLIES	0 HOUR
				EAST WALL > 30 FT = 0 HRS
ABLE 705.8	MAX. AREA OF EXTERIOR WALL OPENINGS	FIRE SEPARATION DISTANCE		
	VALUES GIVEN ARE % OF THE AREA OF THE EXTERIOR WALL PER STORY UNPROTECTED	0-3 FT   >3-5 FT   >5-10 FT   >10-15 FT   >15-20 FT   >20-25 FT   >25-30 FT   >30 FT   N.P.   N.P.   10%   15%   25%   45%   70%   NO LIMIT		NORTH WALL= UNLIMITED SOUTH WALL= UNLIMITED WEST WALL= UNLIMITED EAST WALL= UNLIMITED
705.11	PARAPETS	N.P. 15% 25% 45% 75% NO LIMIT NO LIMIT PARAPET NOT REQUIRED WHERE THE WALL, DUE TO FIRE SEPARATION DISTANCE, IS NOT REQUIRED TO BE FIRE RESISTIVE OR IS PERMITTED UNPROTECTED OPENINGS OF AT LEAST 25%	PARAPET NOT REQUIRED @ NORTH, SOUTH, EAST & WEST WALLS	PARAPET PROVIDED ON NORTH, EAST AND WEST FACADES
706	FIRE WALLS	706.4 - FIRE RESISTANCE RATING	3 HRS MIN.	NOT REQUIRED/ NOT PROVIDED
708	SHAFT ENCLOSURES	708.4 - FIRE-RESISTANCE RATING	1 HR REQUIRED FOR ELEVATORS & SHAFTS	1 HOUR RATED WALLS PROVIDED
708.14.1	SHAFT ENCLOSURES	NEW ELEVATOR LOBBY	ELEVATOR LOBBY REQUIRED AT EACH FLOOR WHERE OPENING INTO A FIRE RESISTANCE RATED CORRIDOR, EXCEPT IN BUILDINGS LESS THAN 4 FLOORS THAT ARE PROTECTED THROUGHOUT W/AUTOMATIC SPRINKLER SYSTEM.	NOT REQUIRED
713.4.2.1	PENETRATIONS	PENETRATIONS OF NONFIRE-RESISTANT-RATED HORIZONTAL ASSEMBLIES	NON-COMBUSTIBLE PENETRATING ITEMS THAT CONNECT NOT MORE THAN THREE (3) STORIES ARE PERMITTED, PROVIDED THE ANNULAR SPACE IS FILLED TO RESIST THE FREE PASSAGE OF FLAME AND THE PRODUCTS OF COMBUSTION.	
713.4.1.3	PENETRATIONS	NEW DUCTS AND AIR TRANSFER OPENINGS	PENETRATIONS IN HORIZONTAL ASSEMBLIES BY DUCTS AND AIR TRANSFER OPENINGS SHALL COMPLY WITH SECTION 716	ANNULAR SPACE AROUND DUCTS SHALL BE FILLED WITH APPROVED NON-COMBUSTIBLE MATERIALS PER 713.4.2.1
ABLE 715.4 715.4.6.1	OPENING PROTECTIVE OPENING PROTECTIVE	NEW FIRE DOOR RATING IN HORIZONTAL ASSEMBLIES NEW FIRE DOOR GLAZING VISION PANEL	1 HR BARRIERS / SHAFT EXIT ENCLOSURES - 1 HR FIRE DOOR/SHUTTER REQ'D MAX 100 SQUARE INCHES, MAX. DIMENSION 10" ON EACH SIDE	COMPLIES
803	INTERIOR WALL AND CEILING			
BLE 803.9	INTERIOR WALL AND CEILING FINISH REQUIREMENTS - <u>SPRINKLERED</u>	EXITS ENCLOSURES AND EXIT PASSAGEWAYS: GROUP 'S-1' GROUP 'B'	CLASS 'C' CLASS 'B'	CLASS 'C' - PROVIDED CLASS 'B' - PROVIDED
	INDEXES- CLASS A: FLAME SPREAD 0-25; SMOKE-DEVELOPED 0-450	CORRIDORS: GROUP 'S-1' GROUP 'B'	CLASS 'C' CLASS 'C'	CLASS 'C' - PROVIDED CLASS 'C' - PROVIDED
	SMOKE-DEVELOPED 0-450 CLASS B: FLAME SPREAD 26-75; SMOKE-DEVELOPED 0-450 CLASS C: FLAME SPREAD 76-200; SMOKE-DEVELOPED 0-450	ROOMS & ENCLOSED SPACES: GROUP 'S-1' GROUP 'B'	CLASS 'C' CLASS 'C'	CLASS 'C' - PROVIDED CLASS 'C' - PROVIDED

#### CDK DEVELOPMENT, LLC

10570 SAVANNAH CT. HUNTLEY IL, 60142

### SOLID STEEL **STRUCTURES**

1257 BAUER ROAD

SOMERVILLE OH. 45064

#### FENN & ASSOCIATES , INC. 14933 COMMERCIAL DRIVE,

SHELBY TOWNSHIP MI. 48315

ENGINEERING SERVICE, INC., 1221 W. LAKEVIEW COURT | ROMEOVILLE, IL 60446 630-410-2344 IL DESIGN #184.006531


NO. DATE ISSUE DESCRIPTION

2 11-16-23 ISSUE FOR PC COMMENTS 1 08-15-22 ISSUE FOR PERMIT

#### 1575 E. HAMILIN **ROAD**

ROCHESTER HILLS, MICHIGAN 48307

CODE MATRIX

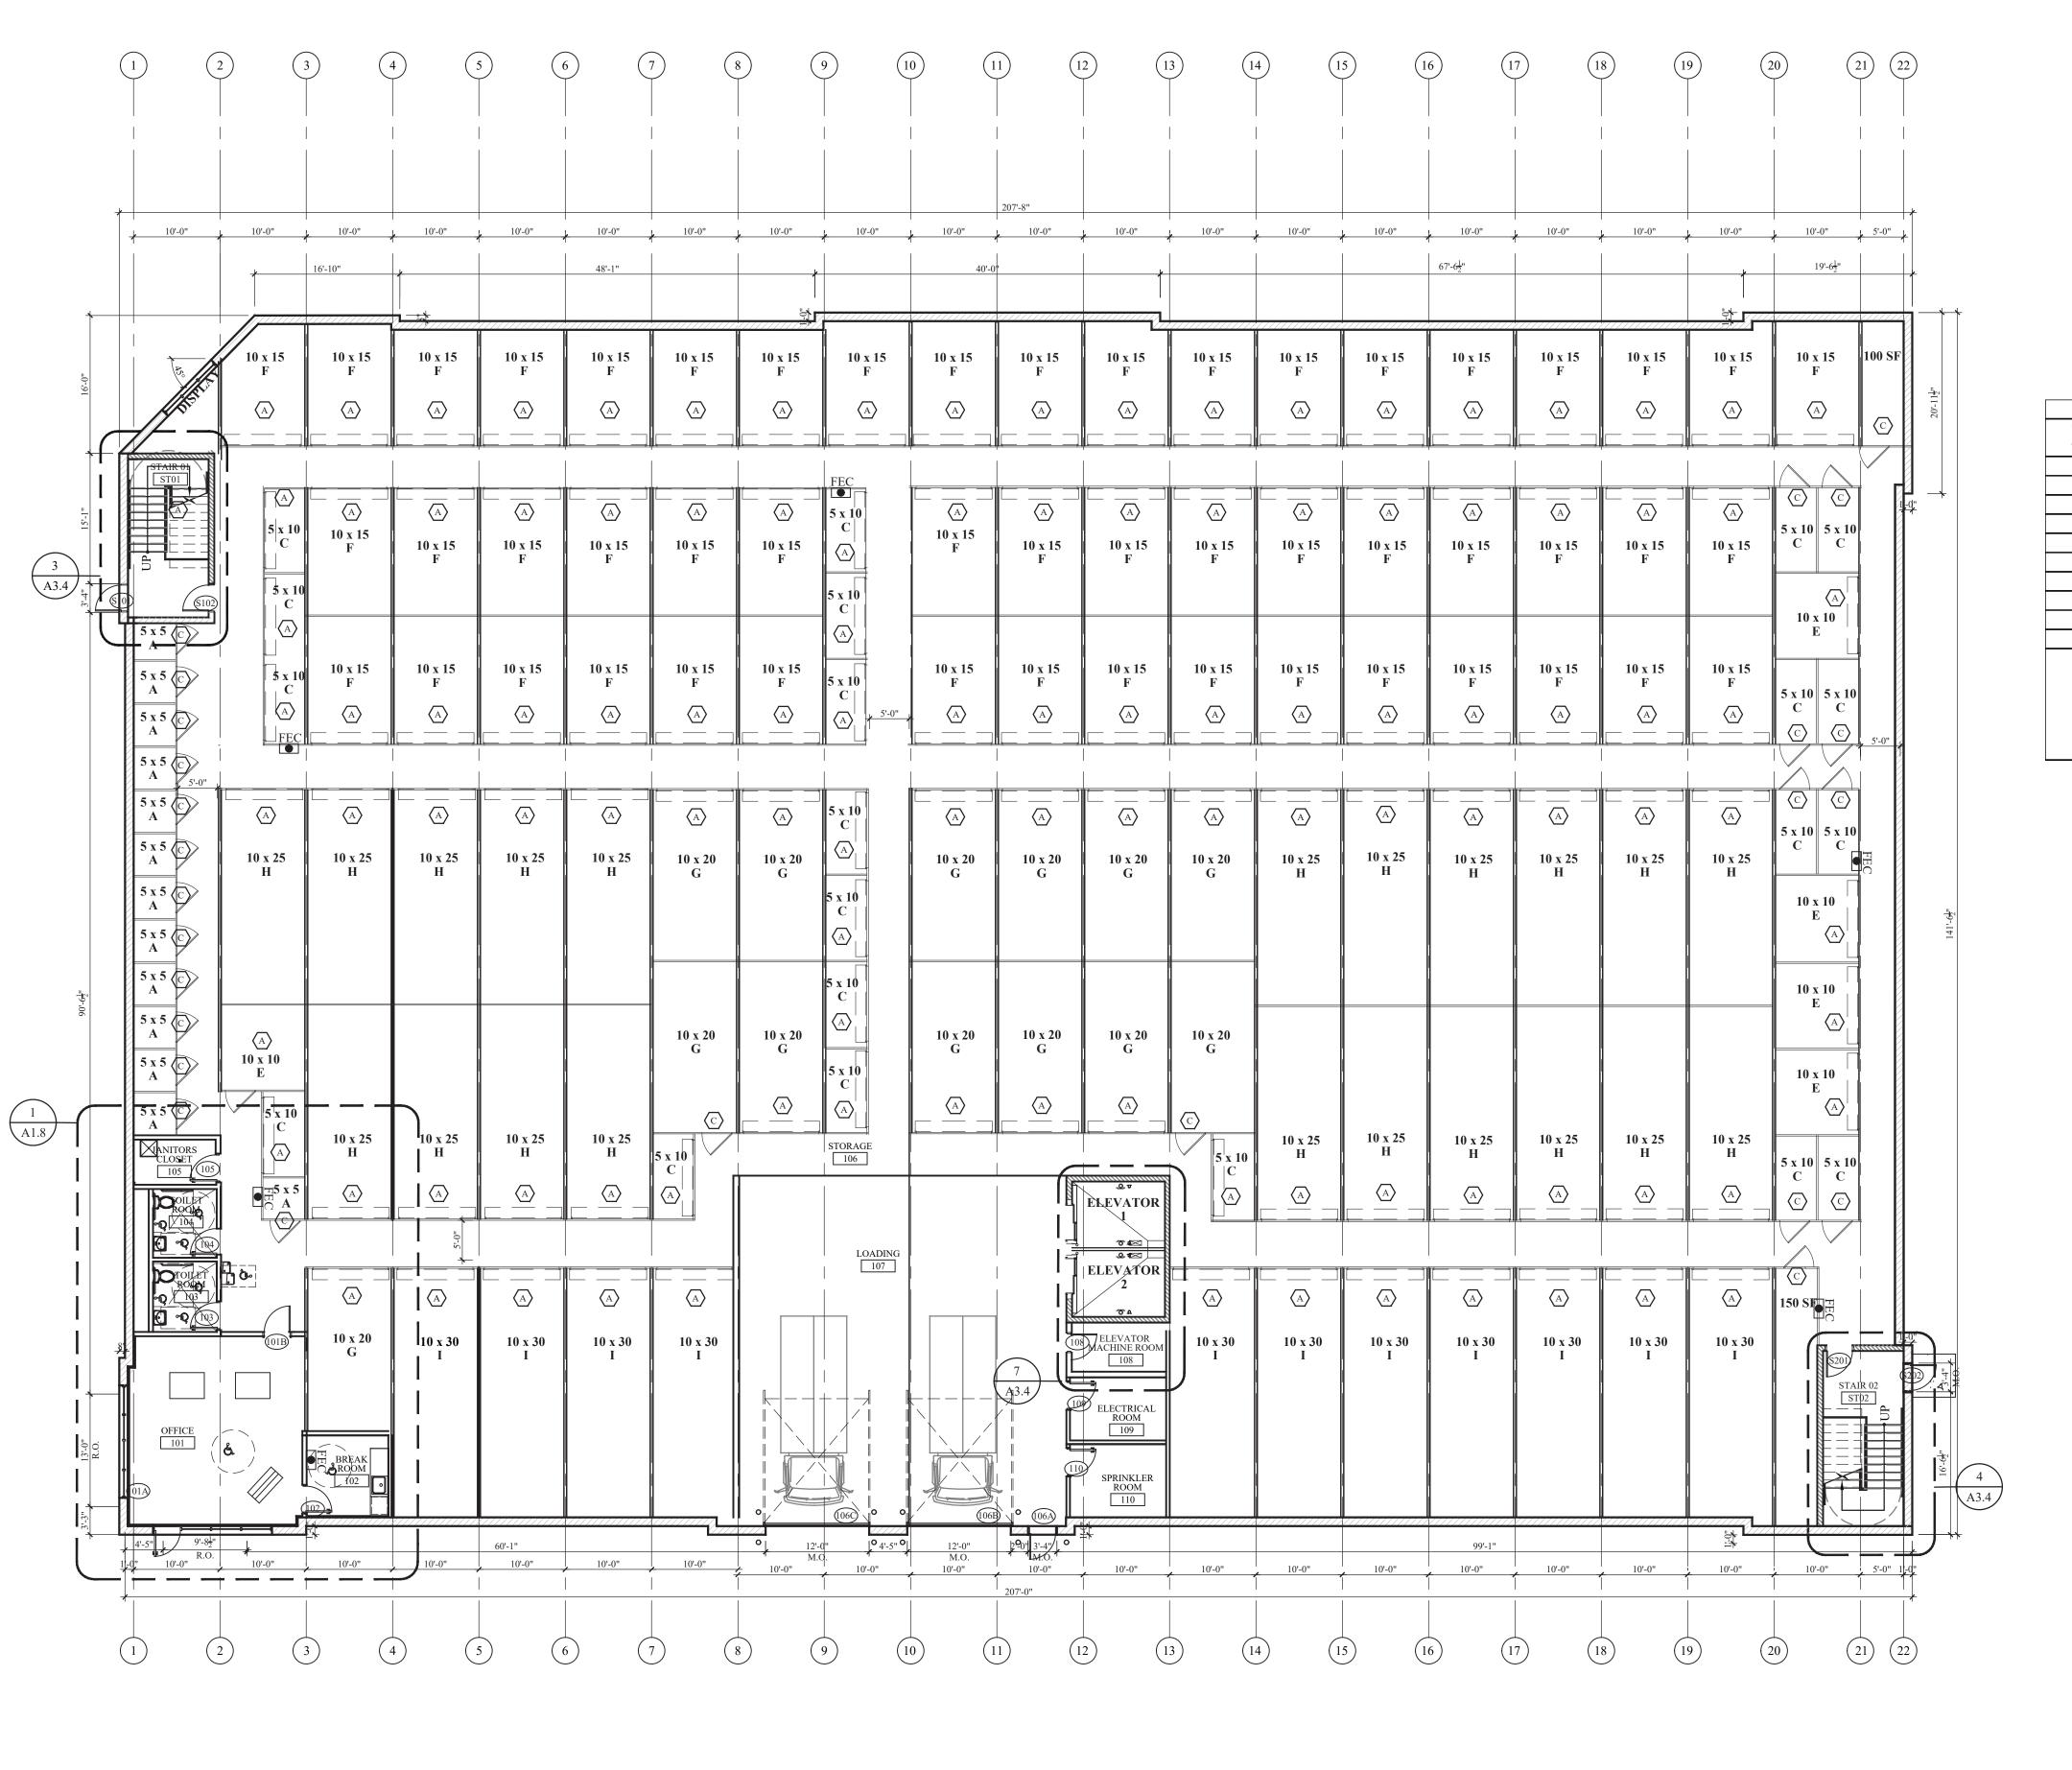

**GENERAL NOTES** 

A. DIMENSIONS ARE TO FINISHED SURFACE UNLESS OTHERWISE **INDICATED** 

B. REFER TO STORAGE UNIT DOOR SCHEDULE FOR STORAGE DOOR

SIZES  $\langle A \rangle \langle B \rangle \langle C \rangle \langle D \rangle$ C. SECURITY CAMERA

D. KEY PAD SECURITY CAMERA

 $\qquad \qquad \longrightarrow$ E. 360° SWIVEL SECURITY CAMERA F. KEY PAD

HKP G. INTERCOM

HIC H. ALL DOOR JAMBS TO BE LOCATED 4" PERPENDICULAR TO ADJACENT WALL TYP. U.N.O.

**UNIT MIX** Total Unit Size Total Unit W (short) L (long) Area (sf) # of Units | Area (sf) | % of Total | Per Type | Per Type 5 5 25 40 1000 7.2% 40 7.2% 7.5 37.5 58 2175 10.5% 58 10.5% 86 4300 15.6% 86 15.6% 5 10 50 10 75 2175 | 5.2% | 29 | 5.2% 10 100 118 | 11800 | 21.3% | 118 | 21.3% 15 150 122 18300 | 22.1% | 122 | 22.1% 20 200 56 11200 | 10.1% | 56 | 10.1% 25 250 33 8250 6.0% 33 6.0% 30 300 11 3300 | 2.0% | 11 | 2.0% Total 62,500 | 100.0% | 100.0%

Building Gross Sq Ft 87,573 Miscellaneous Storage Sq Ft 1,000 Actual Net Storage Sq Ft 63,500 72.51% Actual Rough Efficiency 114.8

Actual Average Unit Size Sq Ft

**CDK** 

Structural:

, INC.

DEVELOPMENT, LLC

FENN & ASSOCIATES

NEVILLE

ENGINEERING SERVICE, INC.

1221 W. LAKEVIEW COURT | ROMEOVILLE, IL 60446 630-410-2344 IL DESIGN #184.006531

10570 SAVANNAH CT.

SOLID STEEL

**STRUCTURES** 

SOMERVILLE OH. 45064

14933 COMMERCIAL DRIVE,

SHELBY TOWNSHIP MI. 48315

1257 BAUER ROAD

HUNTLEY IL, 60142

NO. DATE ISSUE DESCRIPTION

1 08-15-22 ISSUE FOR PERMIT

1575 E. HAMILIN **ROAD** 


ROCHESTER HILLS, MICHIGAN 48307

FIRST FLOOR PLAN

CITY FILE #23-0002

SECTION 24

FIRST FLOOR PLAN

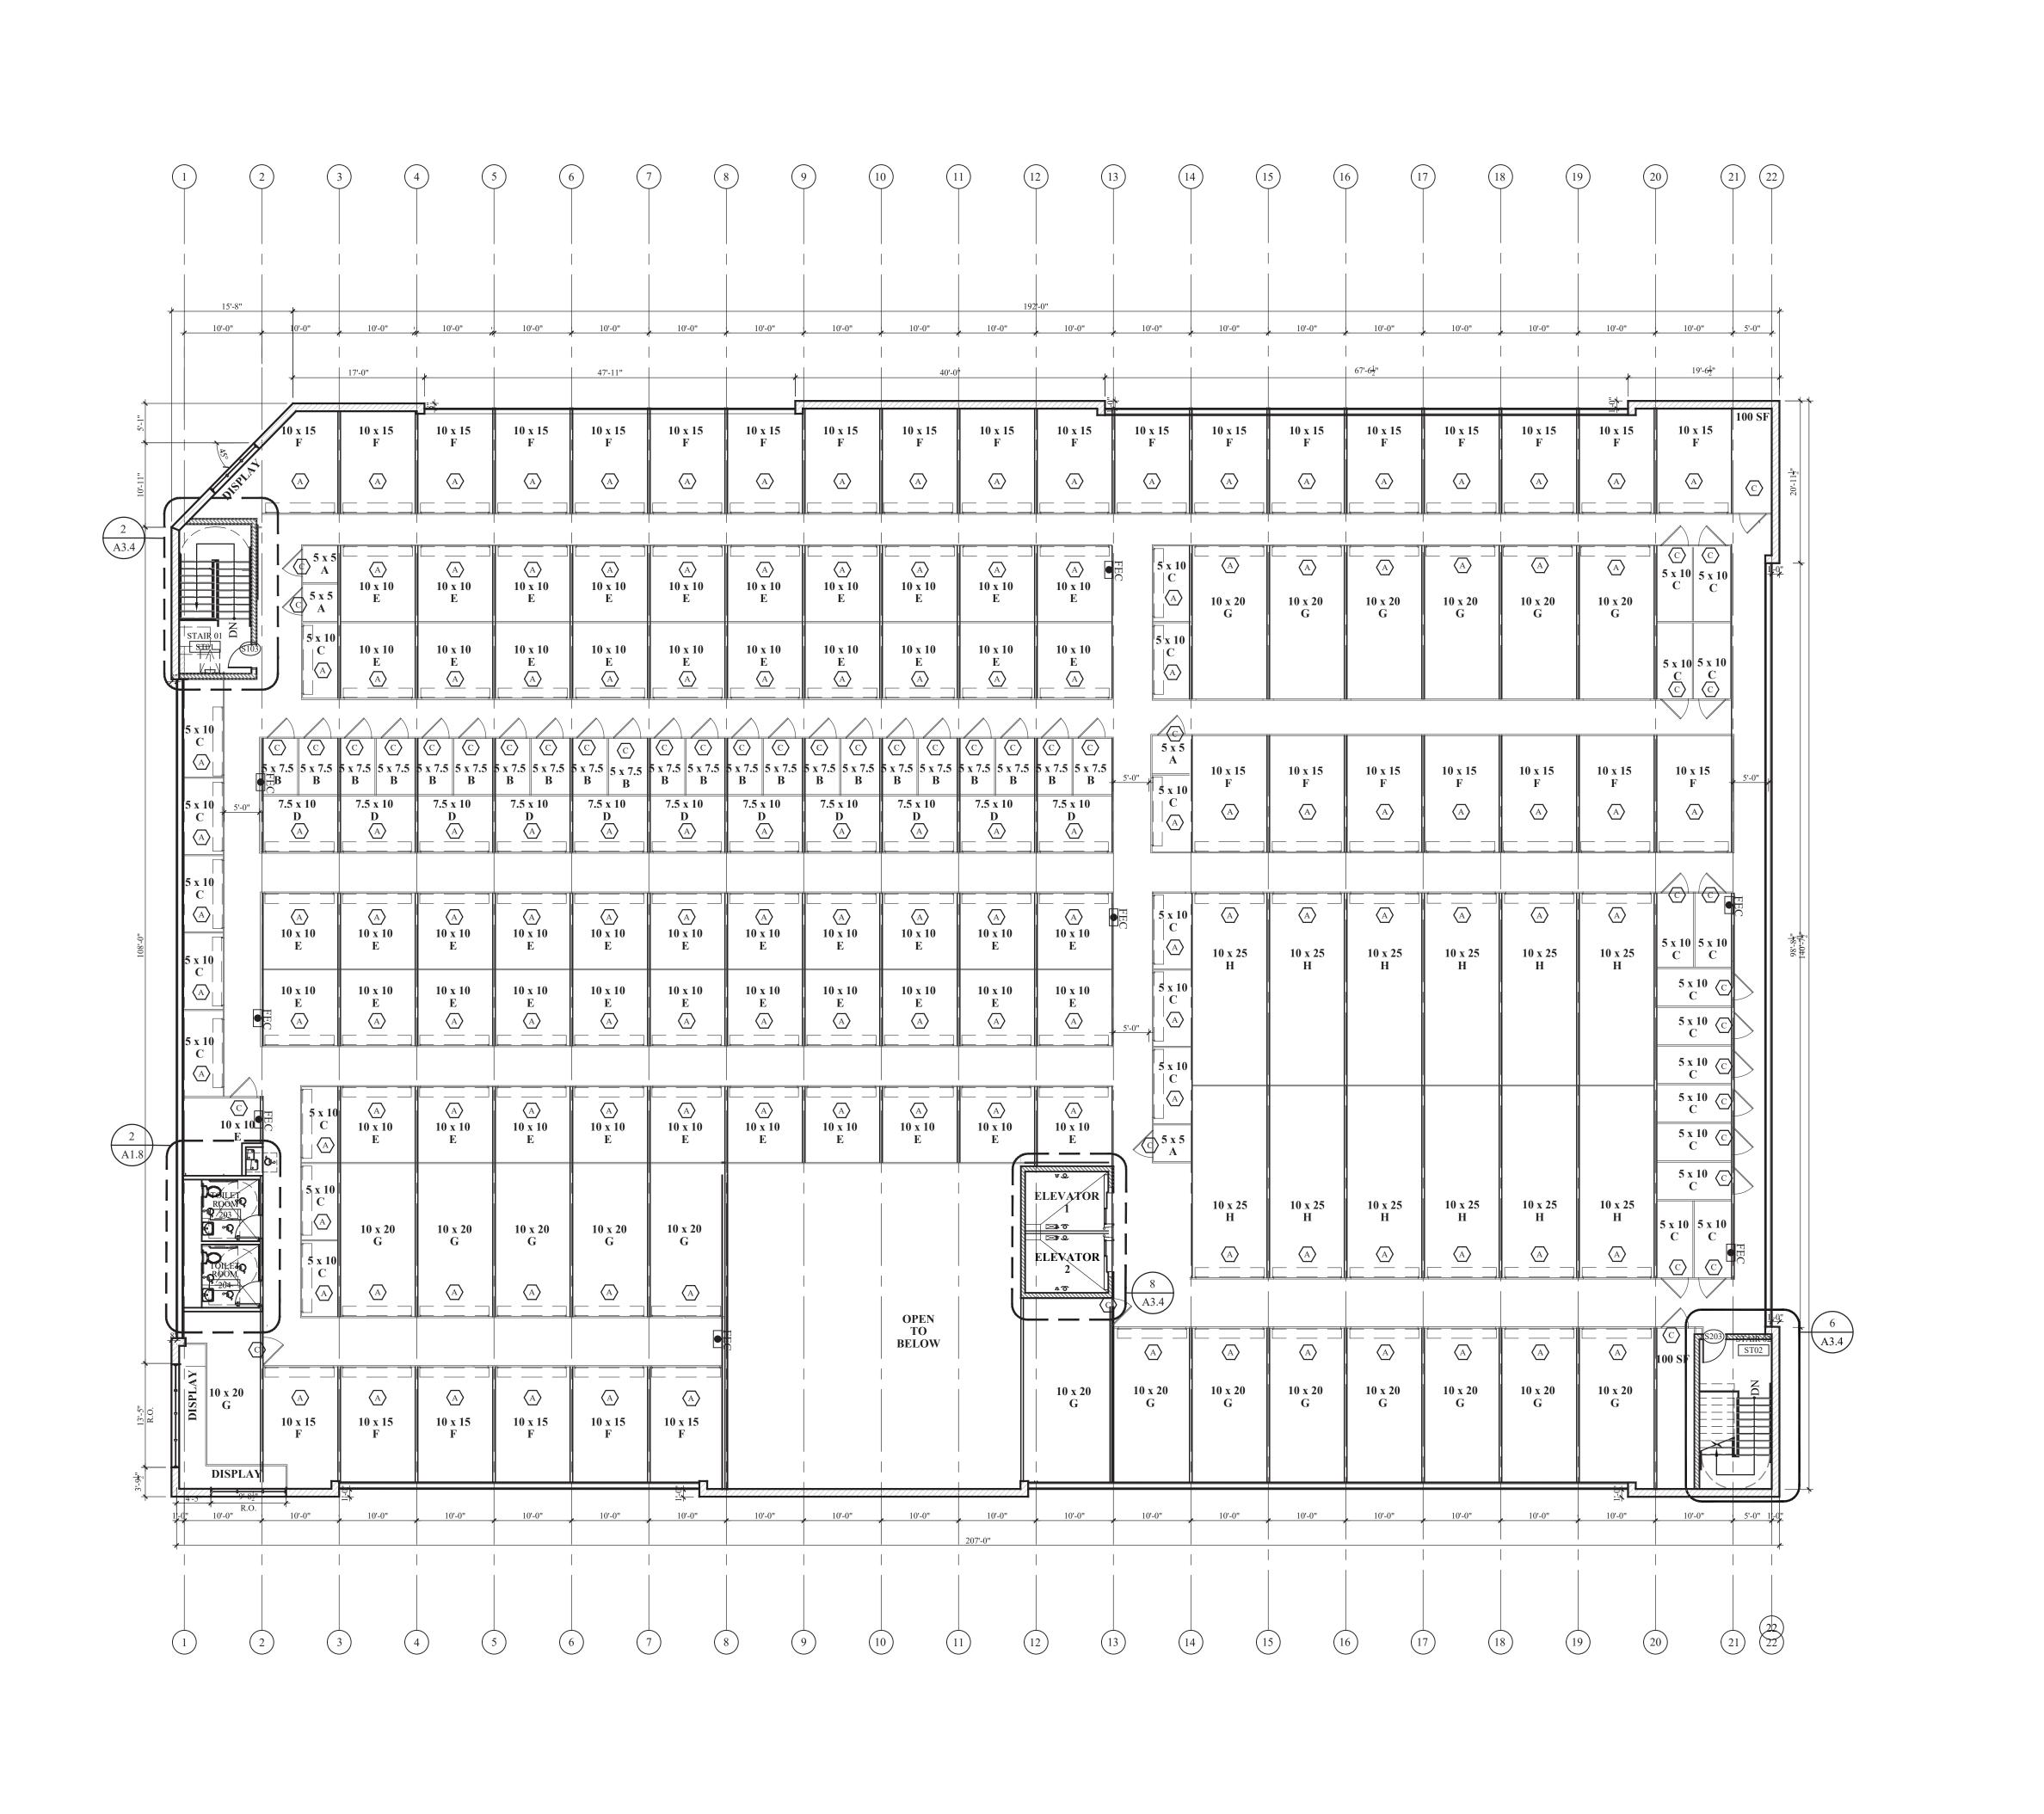

**GENERAL NOTES** 

A. DIMENSIONS ARE TO FINISHED SURFACE UNLESS OTHERWISE

B. REFER TO STORAGE UNIT DOOR

SCHEDULE FOR STORAGE DOOR SIZES  $\langle A \rangle \langle B \rangle \langle C \rangle \langle D \rangle$ C. SECURITY CAMERA

D. KEY PAD SECURITY CAMERA

E. 360° SWIVEL SECURITY CAMERA F. KEY PAD

HKP G. INTERCOM

H. ALL DOOR JAMBS TO BE LOCATED 4" PERPENDICULAR TO ADJACENT WALL TYP. U.N.O.

**CDK DEVELOPMENT, LLC** 

10570 SAVANNAH CT. HUNTLEY IL, 60142

Structural:

SOLID STEEL **STRUCTURES** 

1257 BAUER ROAD SOMERVILLE OH. 45064

|FENN & ASSOCIATES| , INC.

14933 COMMERCIAL DRIVE, SHELBY TOWNSHIP MI. 48315

> NEVILLE ENGINEERING SERVICE, INC. 1221 W. LAKEVIEW COURT | ROMEOVILLE, IL 60446 630-410-2344 IL DESIGN #184.006531

NO. DATE ISSUE DESCRIPTION

1 08-15-22 ISSUE FOR PERMIT

roject Name:

1575 E. HAMILIN **ROAD** 

ROCHESTER HILLS, MICHIGAN 48307


CITY FILE #23-0002

SECTION 24

NORTH

SECOND FLOOR PLAN

SECOND FLOOR PLAN

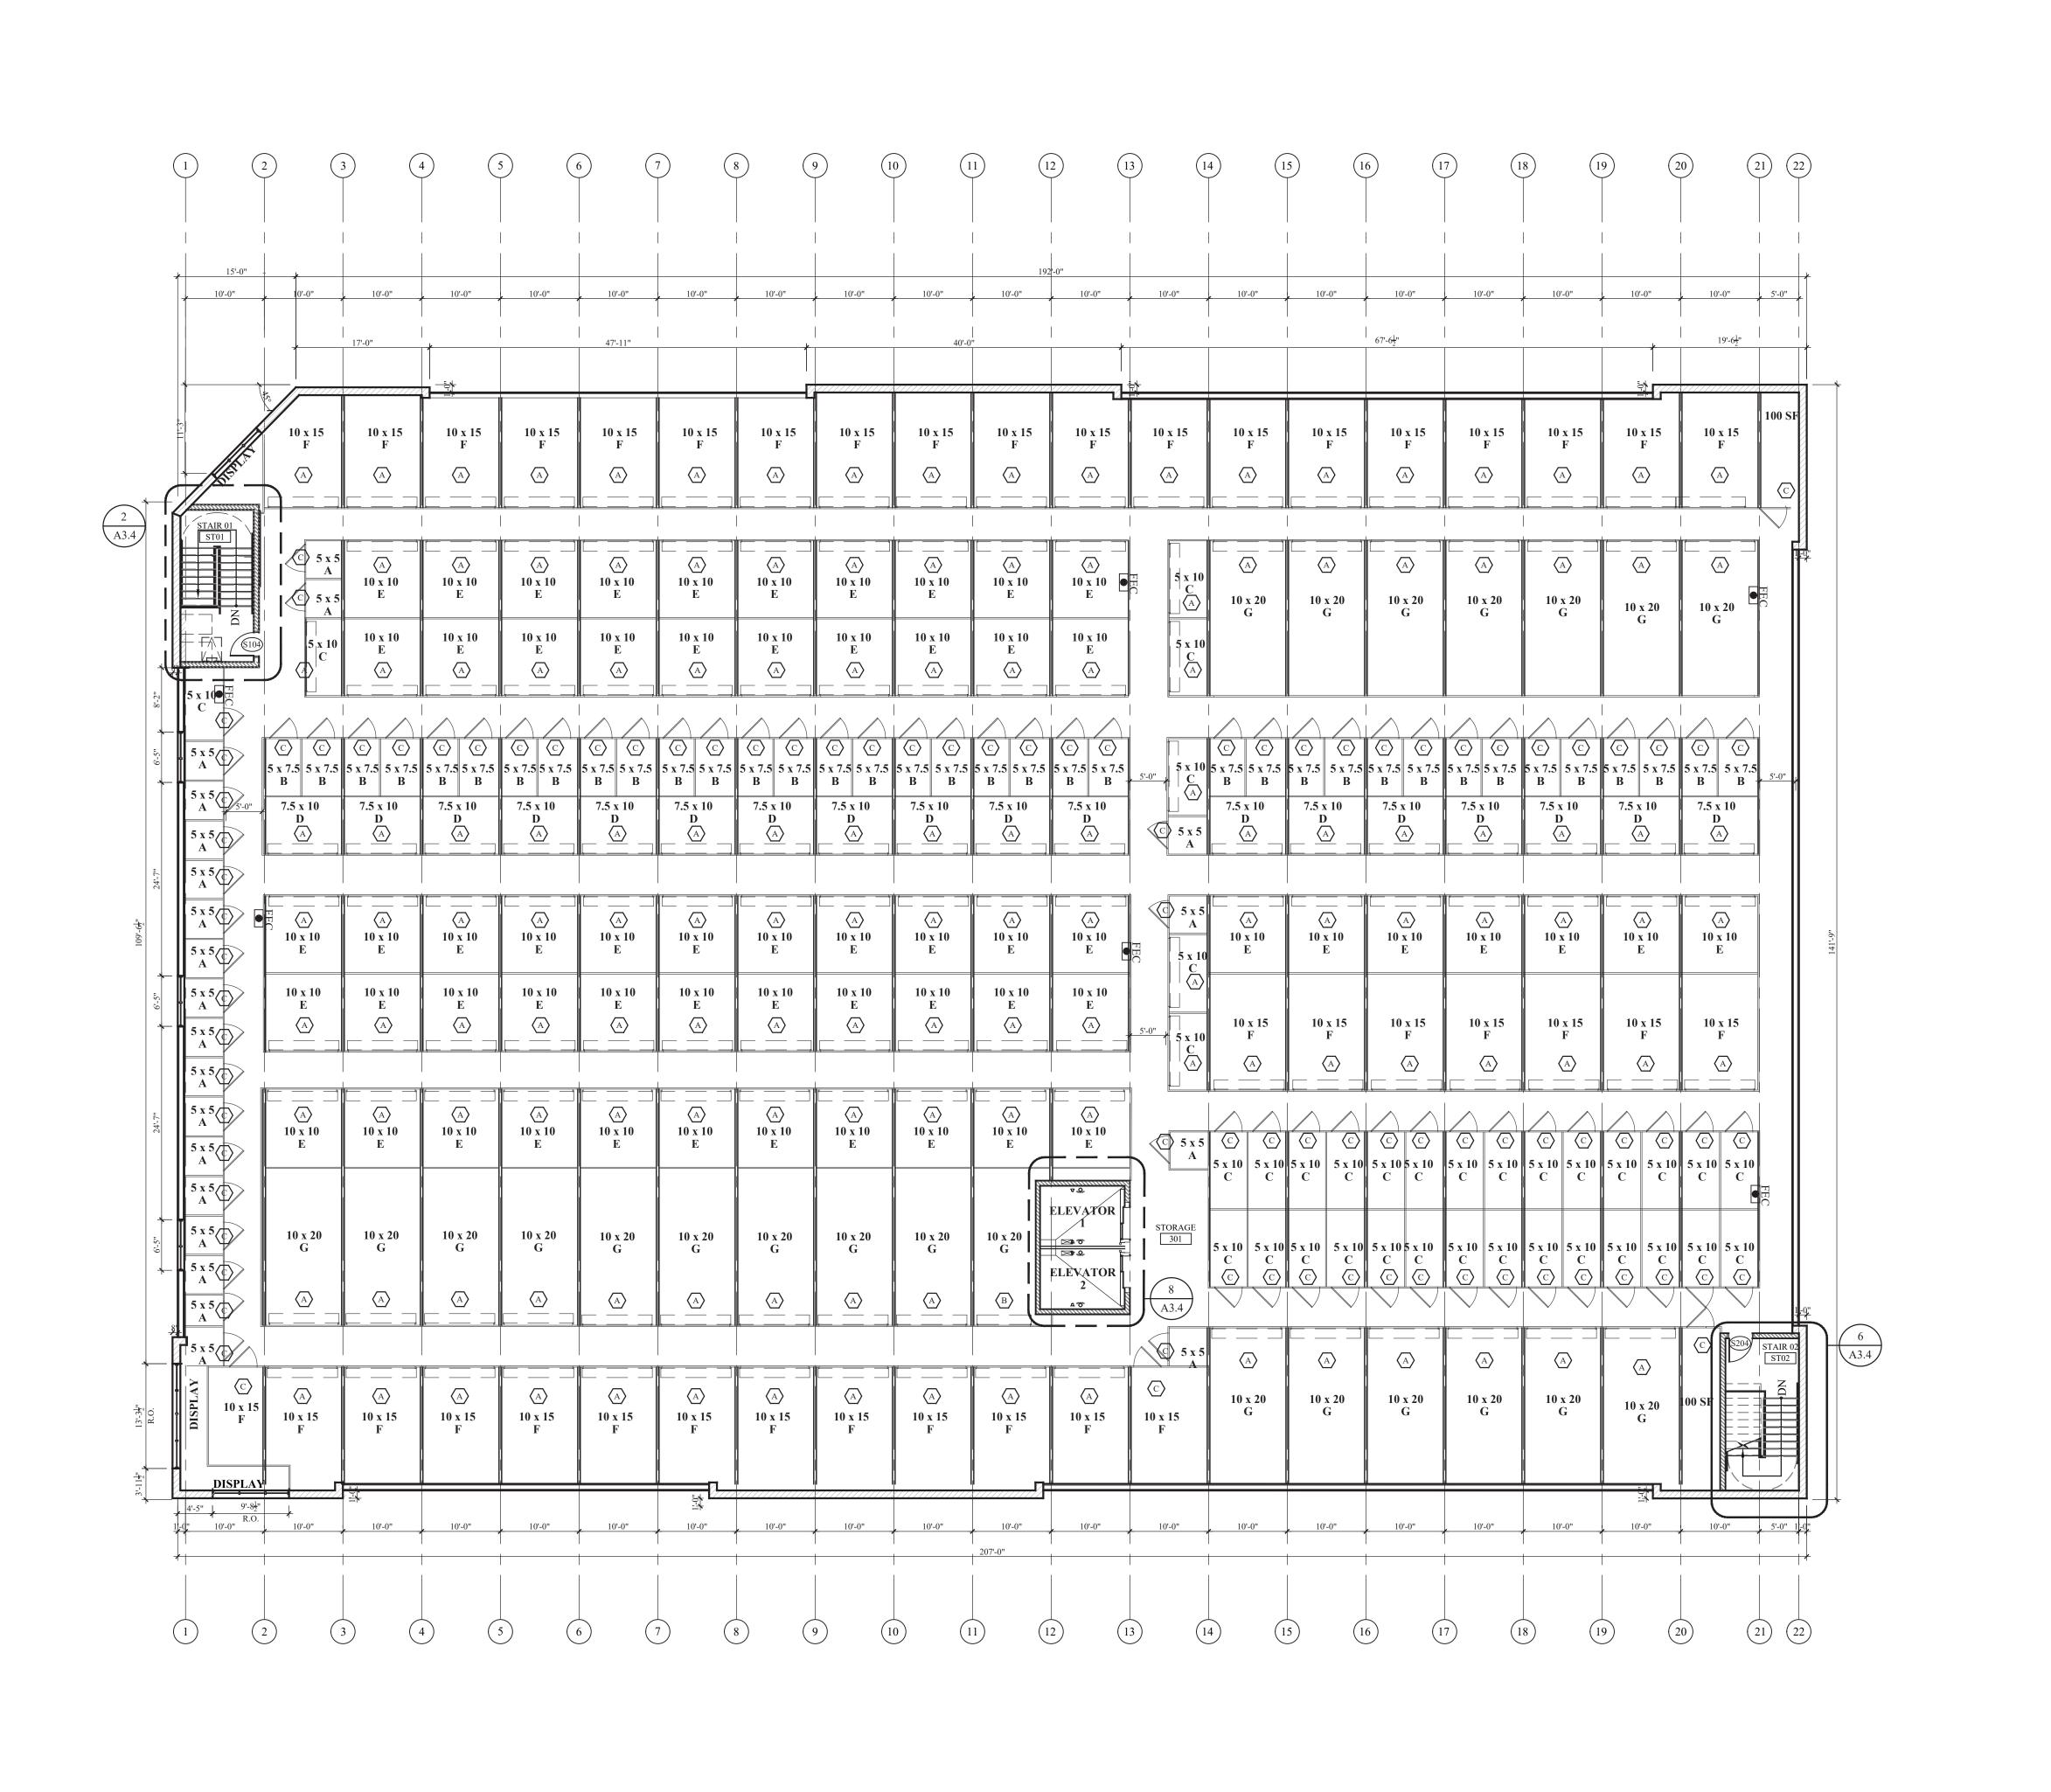

**GENERAL NOTES** 

A. DIMENSIONS ARE TO FINISHED SURFACE UNLESS OTHERWISE

B. REFER TO STORAGE UNIT DOOR SCHEDULE FOR STORAGE DOOR

SIZES  $\langle A \rangle \langle B \rangle \langle C \rangle \langle D \rangle$ C. SECURITY CAMERA

D. KEY PAD SECURITY CAMERA

E. 360° SWIVEL SECURITY CAMERA F. KEY PAD

HKP G. INTERCOM

H. ALL DOOR JAMBS TO BE LOCATED 4" PERPENDICULAR TO ADJACENT WALL TYP. U.N.O.

**CDK** 

**DEVELOPMENT, LLC** 10570 SAVANNAH CT.

HUNTLEY IL, 60142

Structural:

SOLID STEEL **STRUCTURES** 

1257 BAUER ROAD SOMERVILLE OH. 45064

|FENN & ASSOCIATES| , INC.

14933 COMMERCIAL DRIVE, SHELBY TOWNSHIP MI. 48315

> NEVILLE ENGINEERING SERVICE, INC. 1221 W. LAKEVIEW COURT | ROMEOVILLE, IL 60446 630-410-2344 IL DESIGN #184.006531

NO. DATE ISSUE DESCRIPTION

1 08-15-22 ISSUE FOR PERMIT

roject Name:

HAMLIN

CITY FILE #23-0002


**SECTION 24** 


1575 E. HAMILIN **ROAD** 


ROCHESTER HILLS, MICHIGAN 48307


THIRD FLOOR PLAN

THIRD FLOOR PLAN A1.3 SCALE: 3/32"=1'-0"

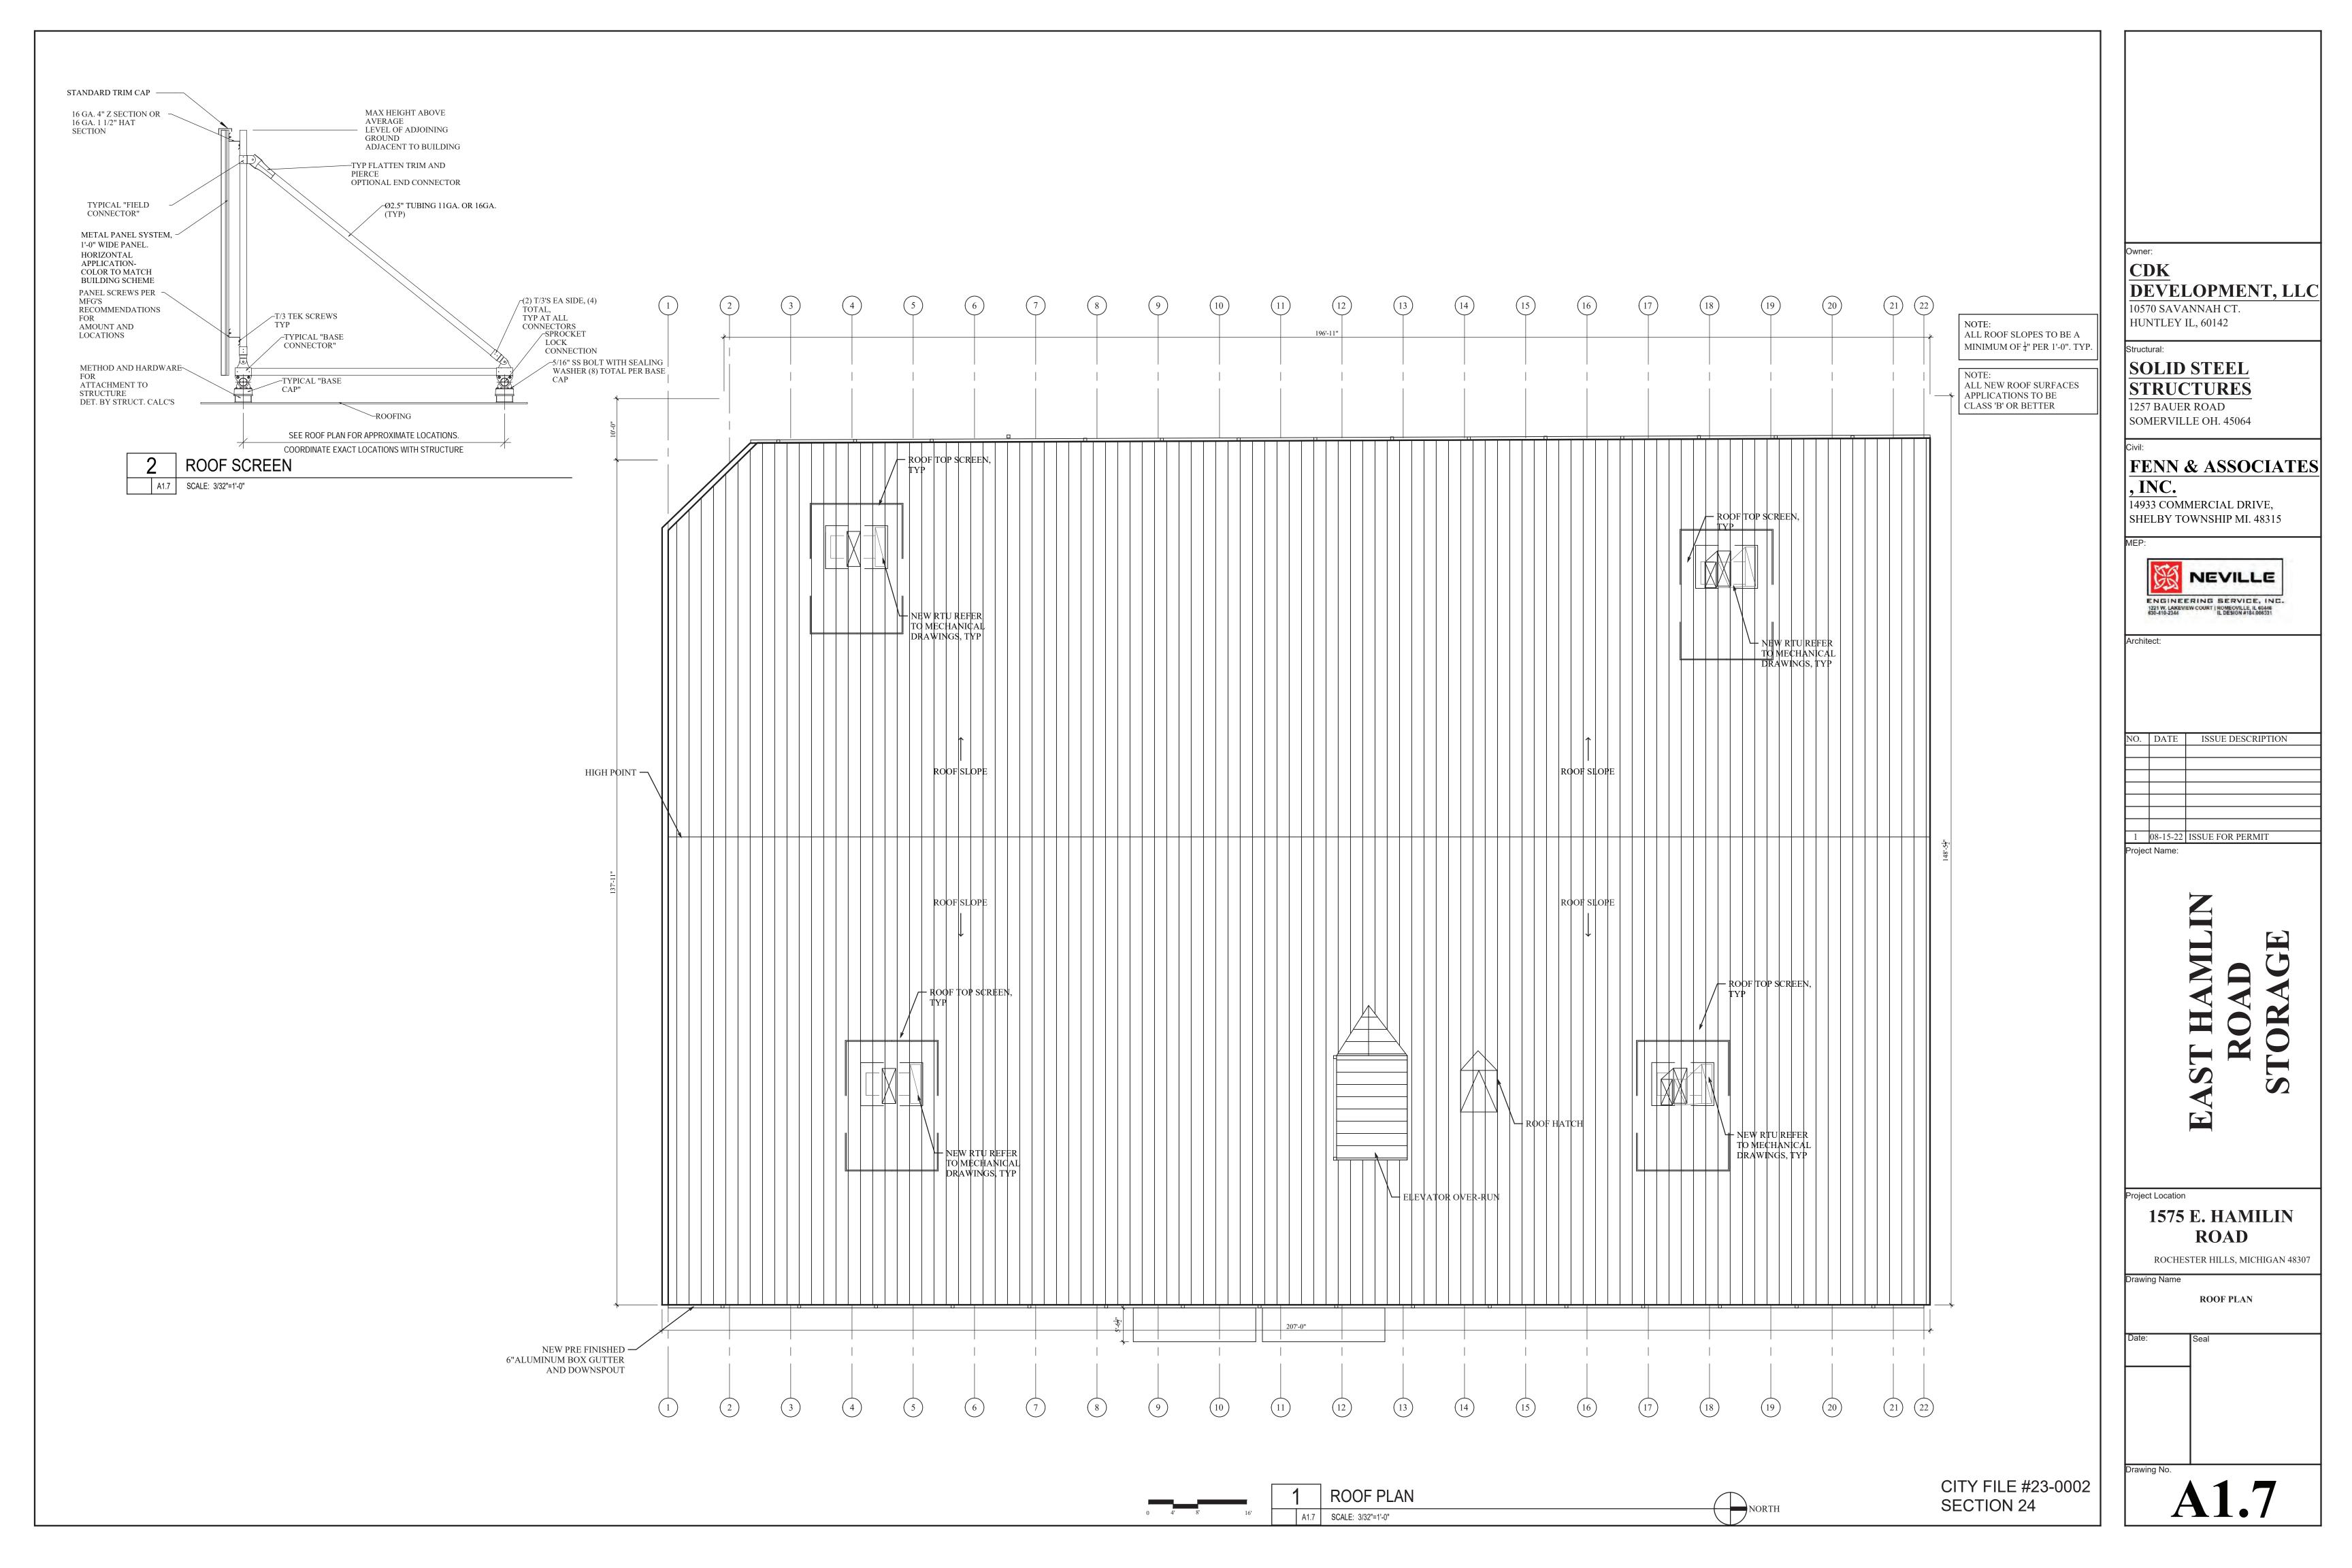

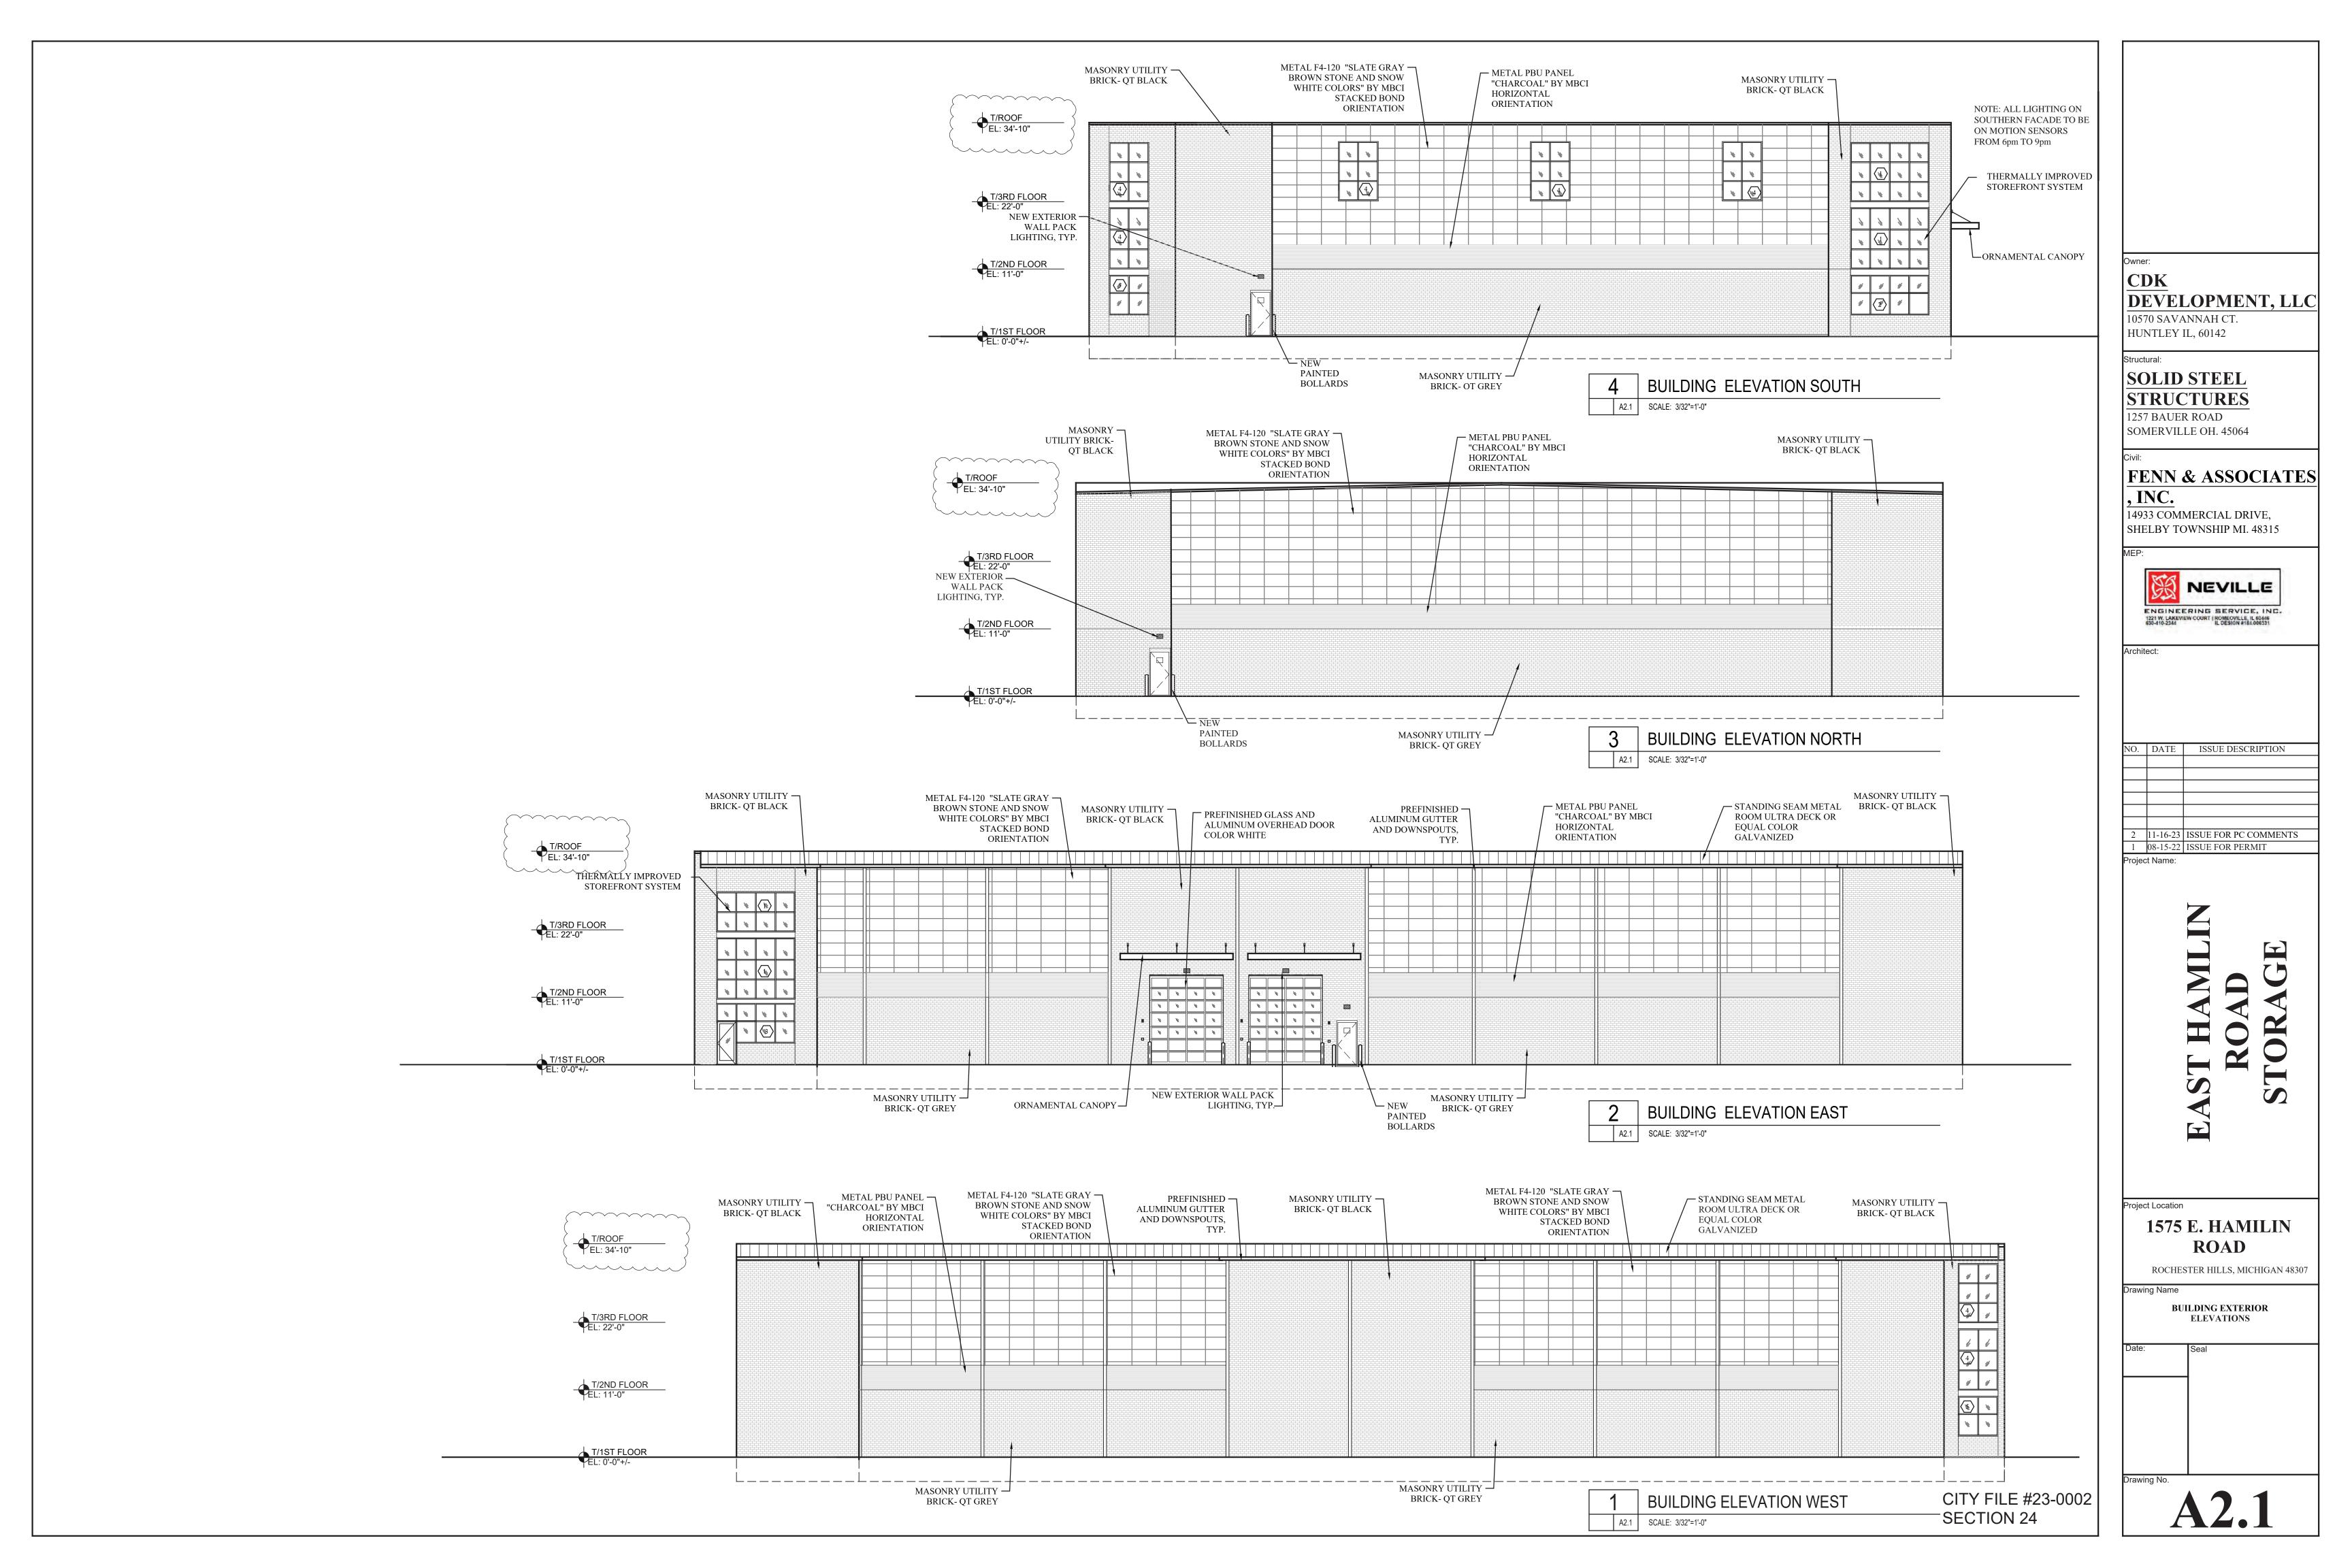

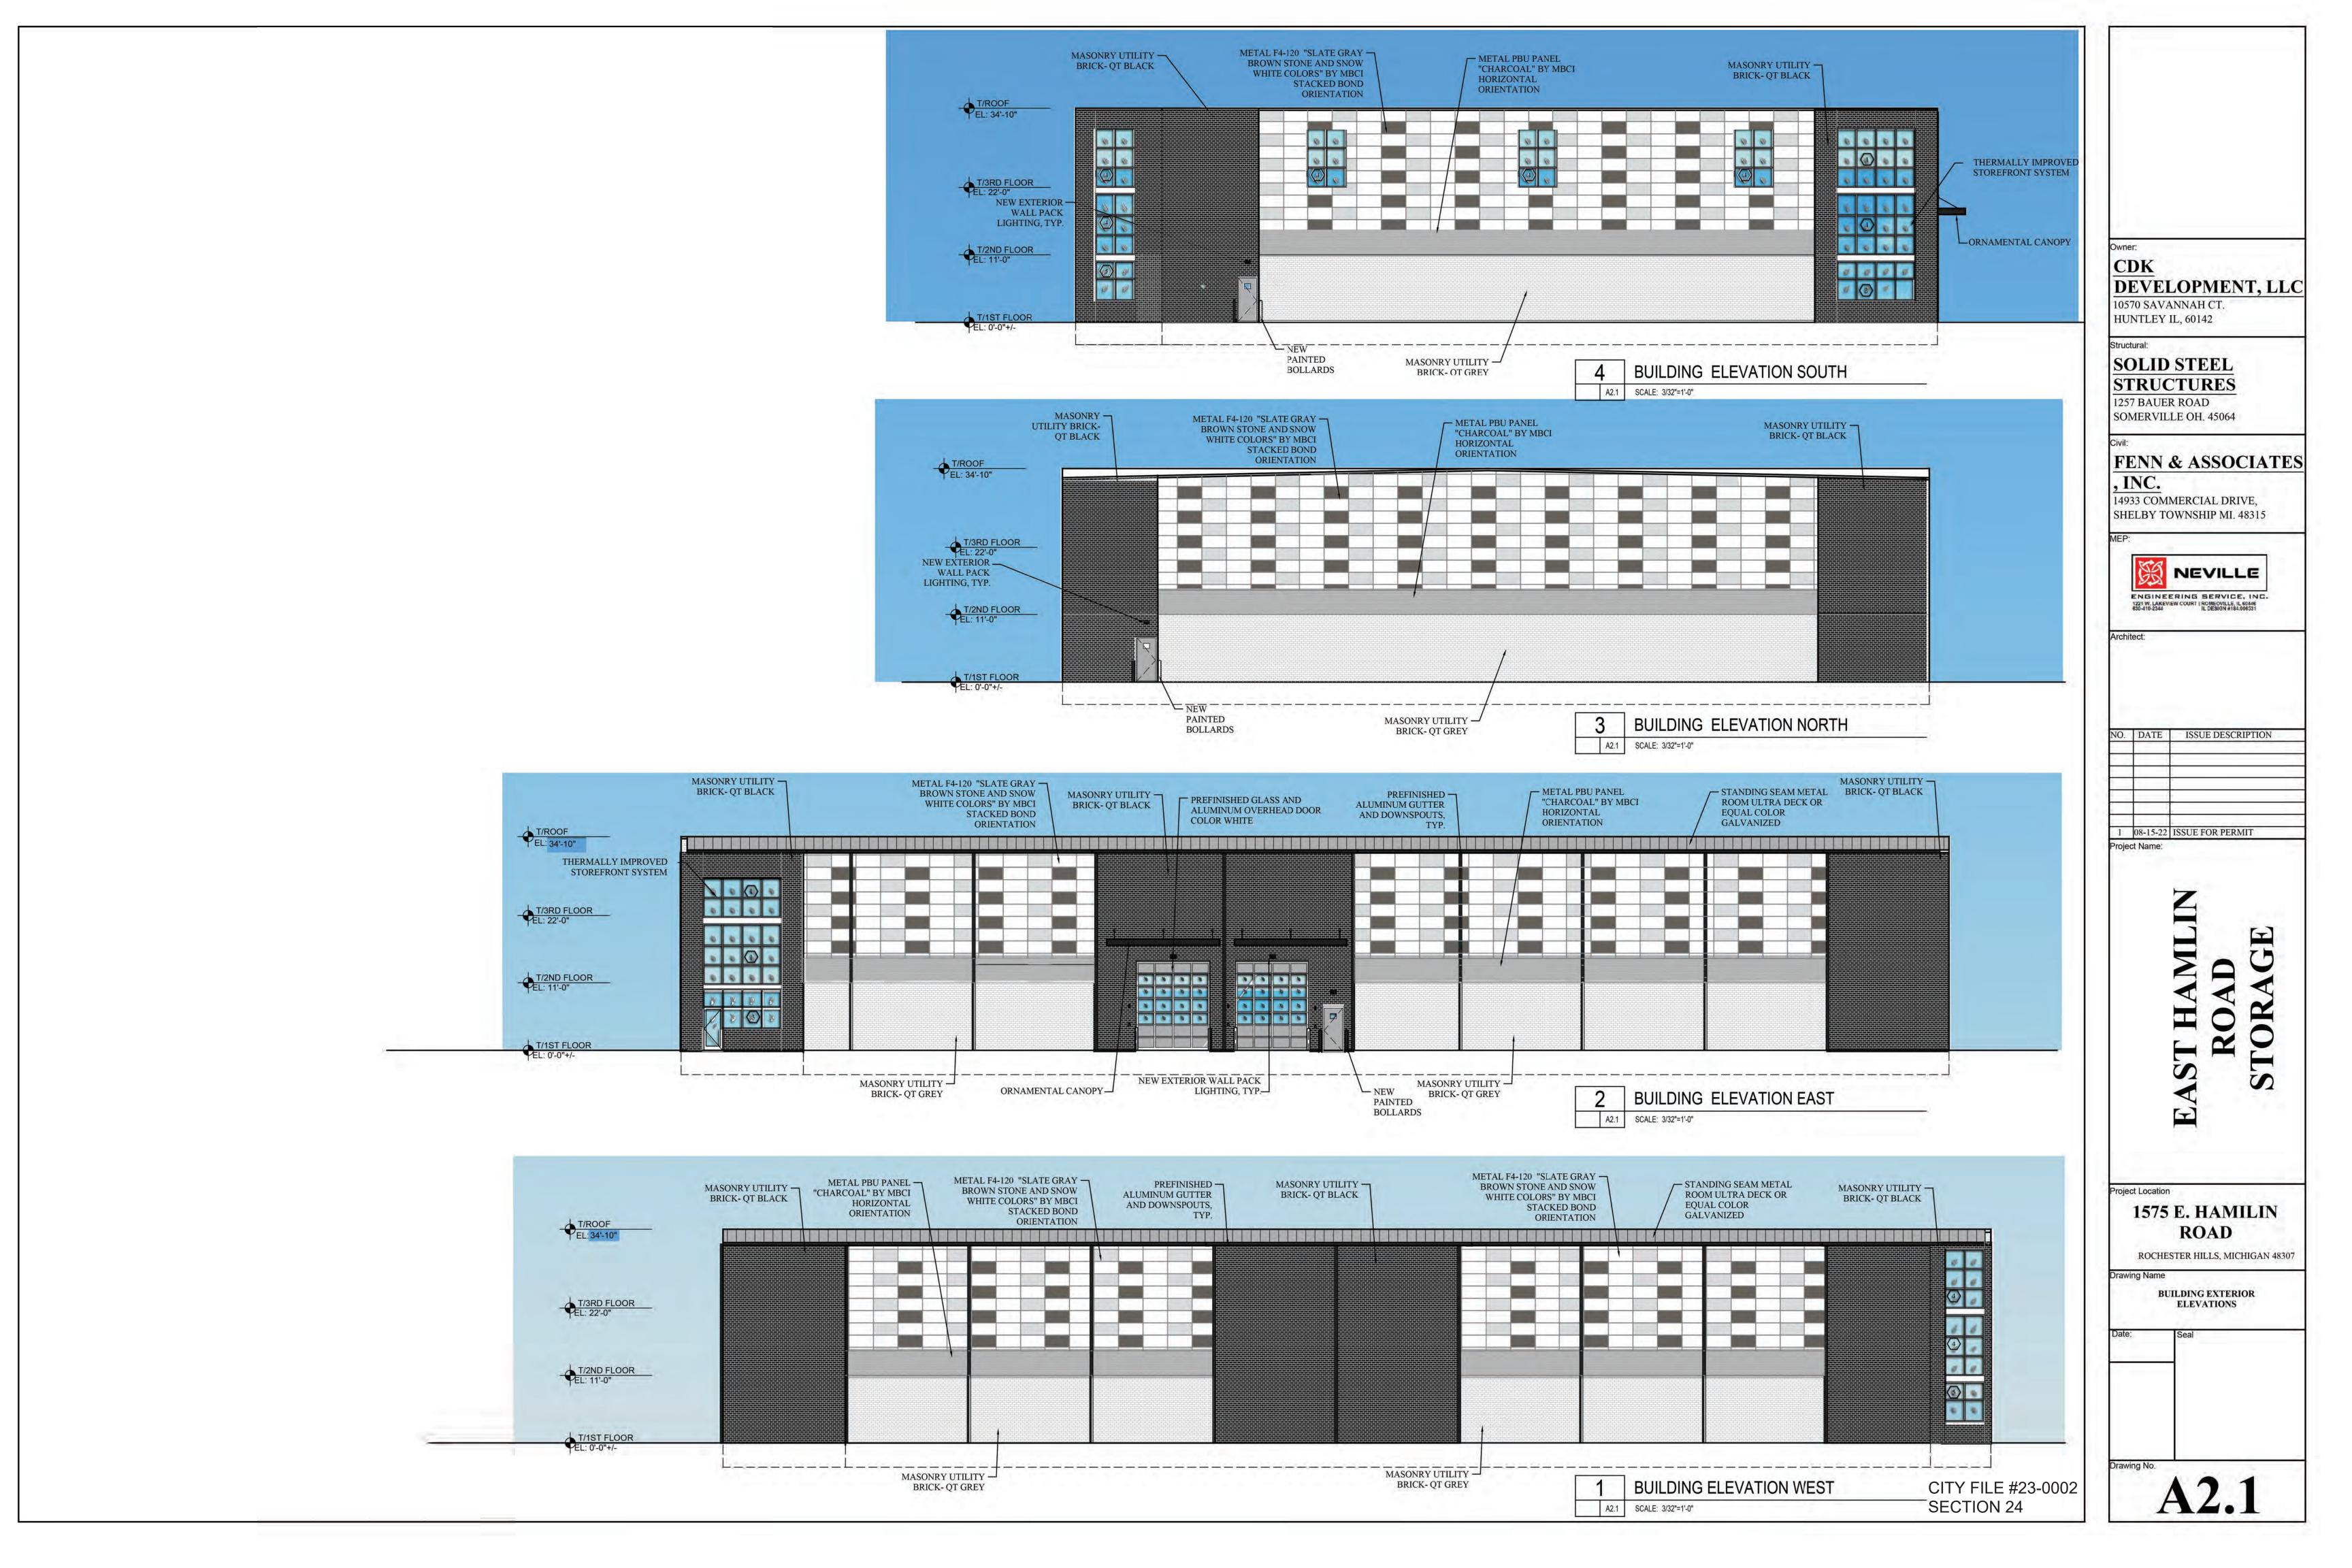

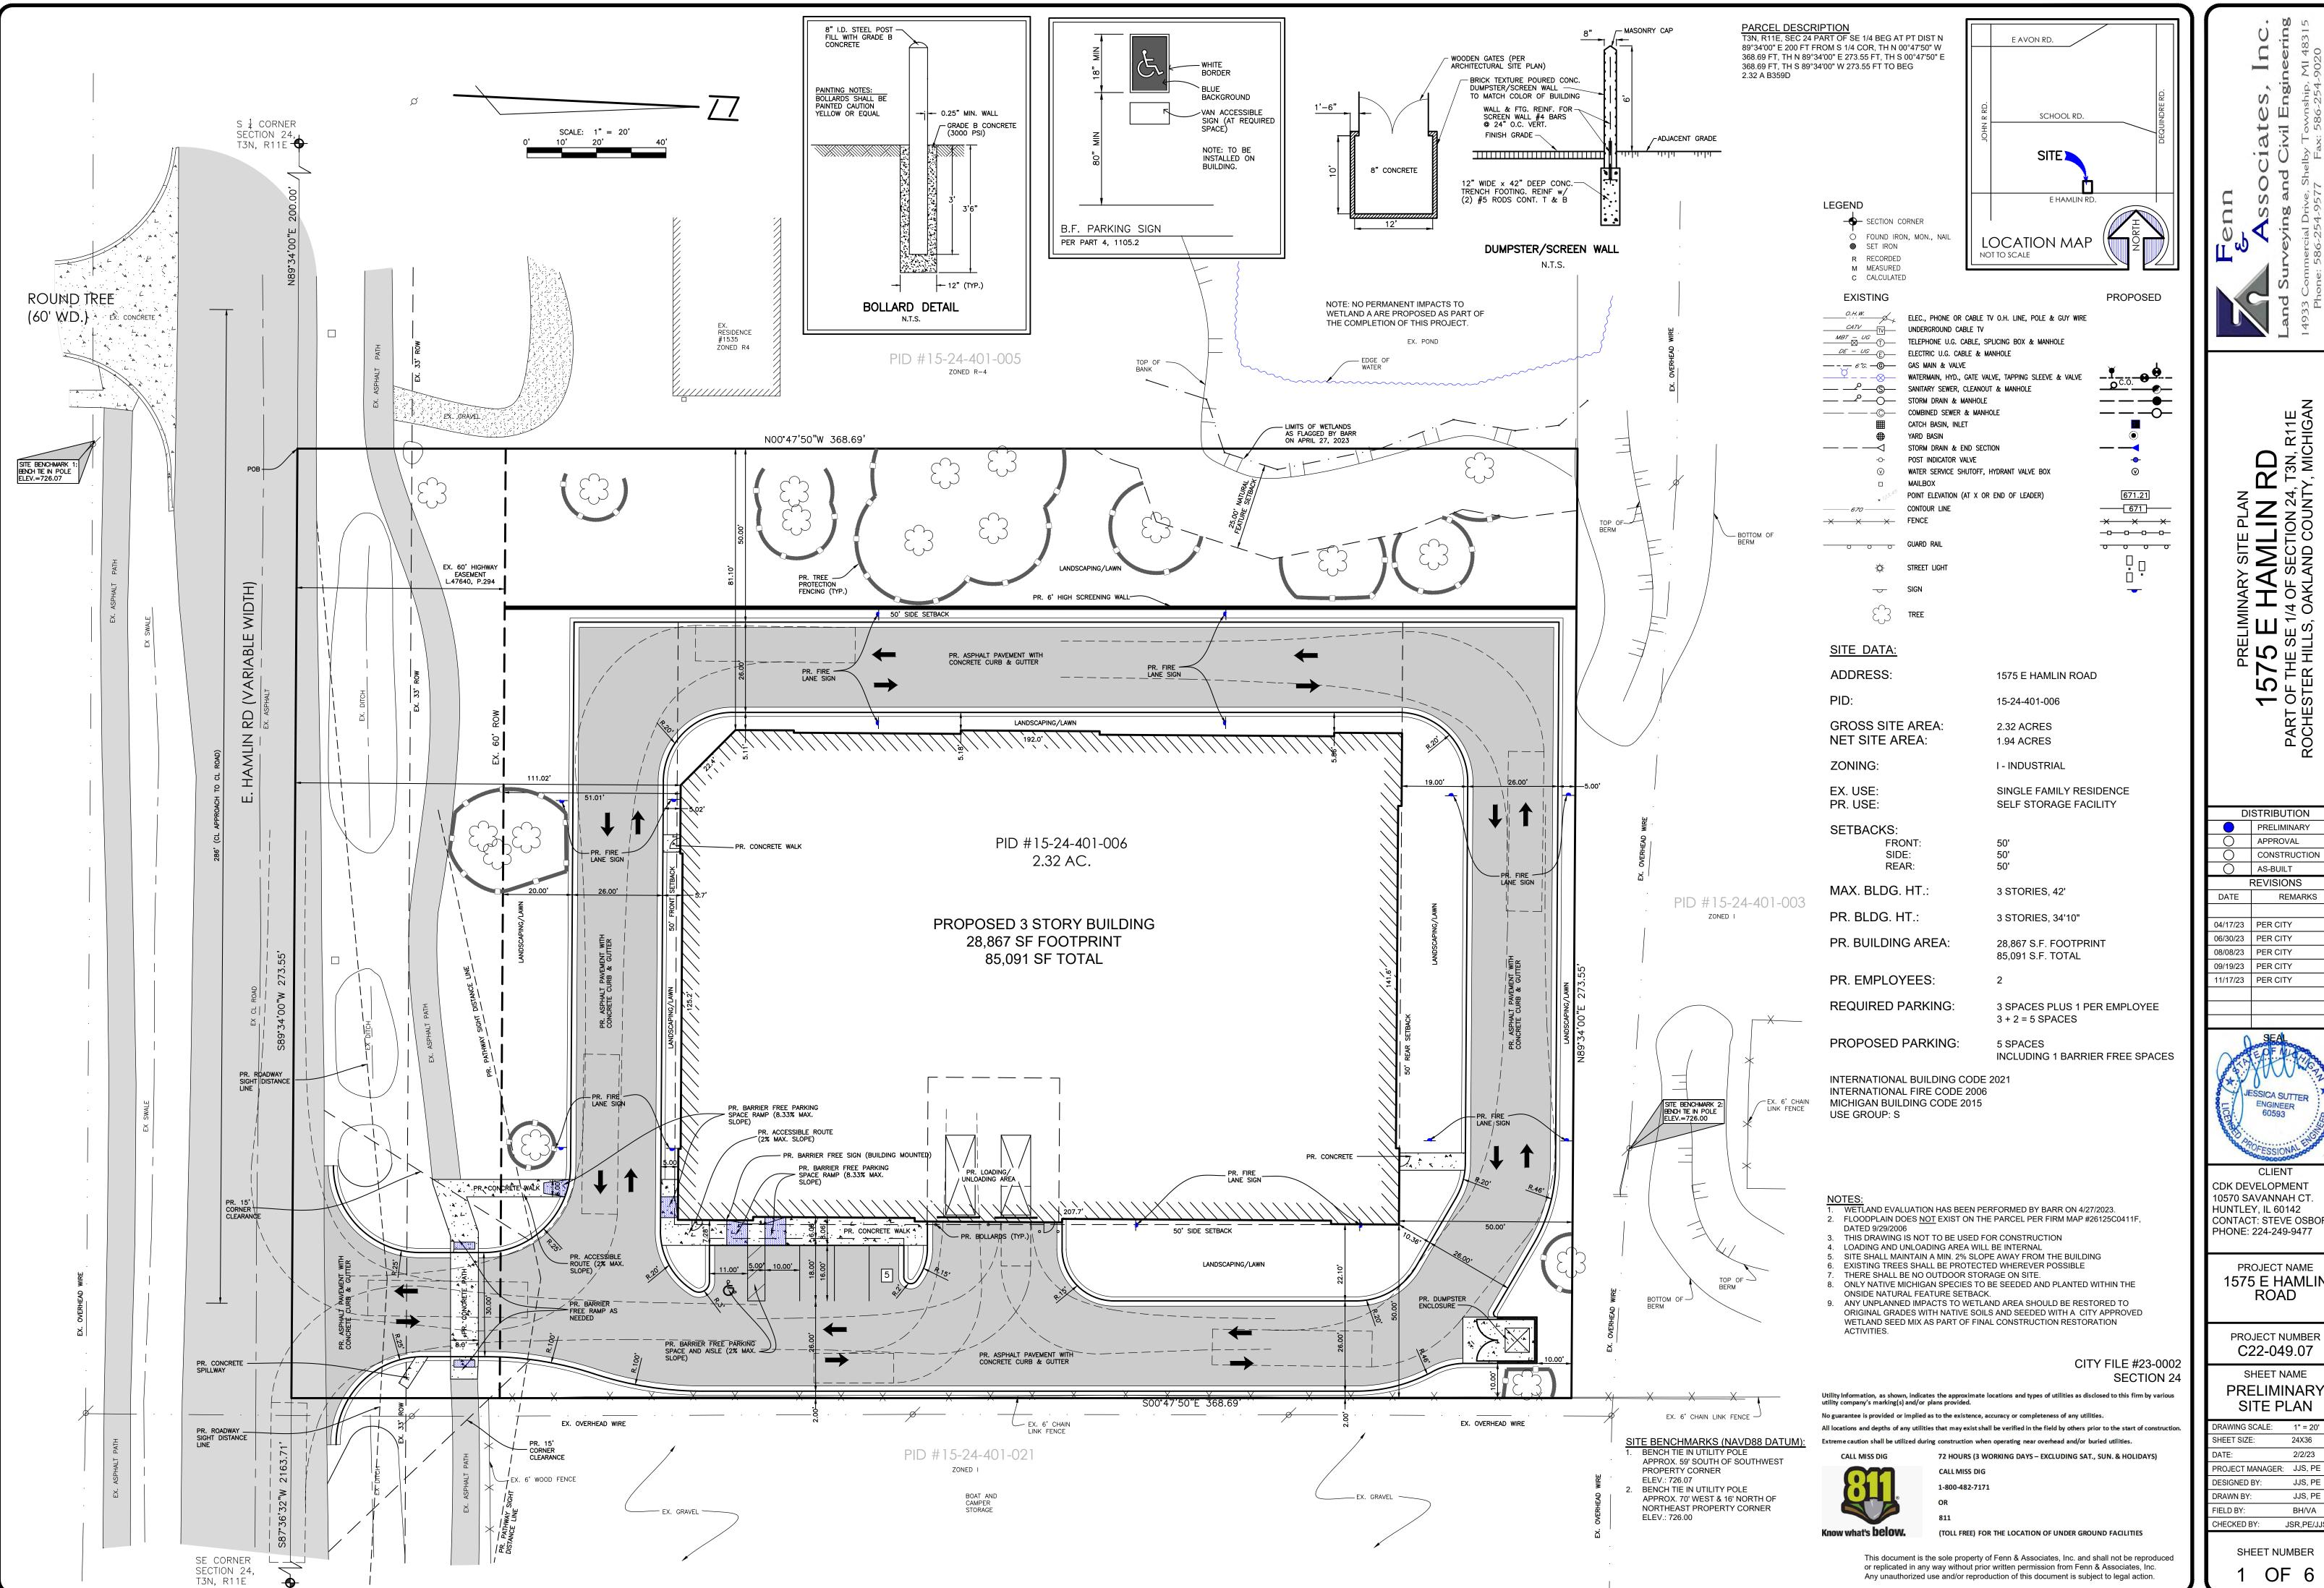

SHEET NUMBER

NOT TO BE USED AS CONSTRUCTION DRAWINGS

or replicated in any way without prior written permission from Fenn & Associates, Inc.

Any unauthorized use and/or reproduction of this document is subject to legal action.

DISTRIBUTION

PRELIMINARY

CONSTRUCTION

REVISIONS

SITE

09/19/23 PER CITY 11/17/23 PER CITY JESSICA SUTTER

CDK DEVELOPMENT 10570 SAVANNAH CT. HUNTLEY, IL 60142 CONTACT: STEVE OSBORN PHONE: 224-249-9477

> PROJECT NAME 1575 E HAMLIN ROAD

PROJECT NUMBER


C22-049.07

SHEET NAME **PRELIMINARY** 

SITE PLAN RAWING SCALE: 1" = 20'

SHEET SIZE: 24X36 PROJECT MANAGER: JJS, PE JJS, PE DESIGNED BY: DRAWN BY: JJS, PE FIELD BY: BH/VA CHECKED BY: JSR,PE/JJS,P

OF 6

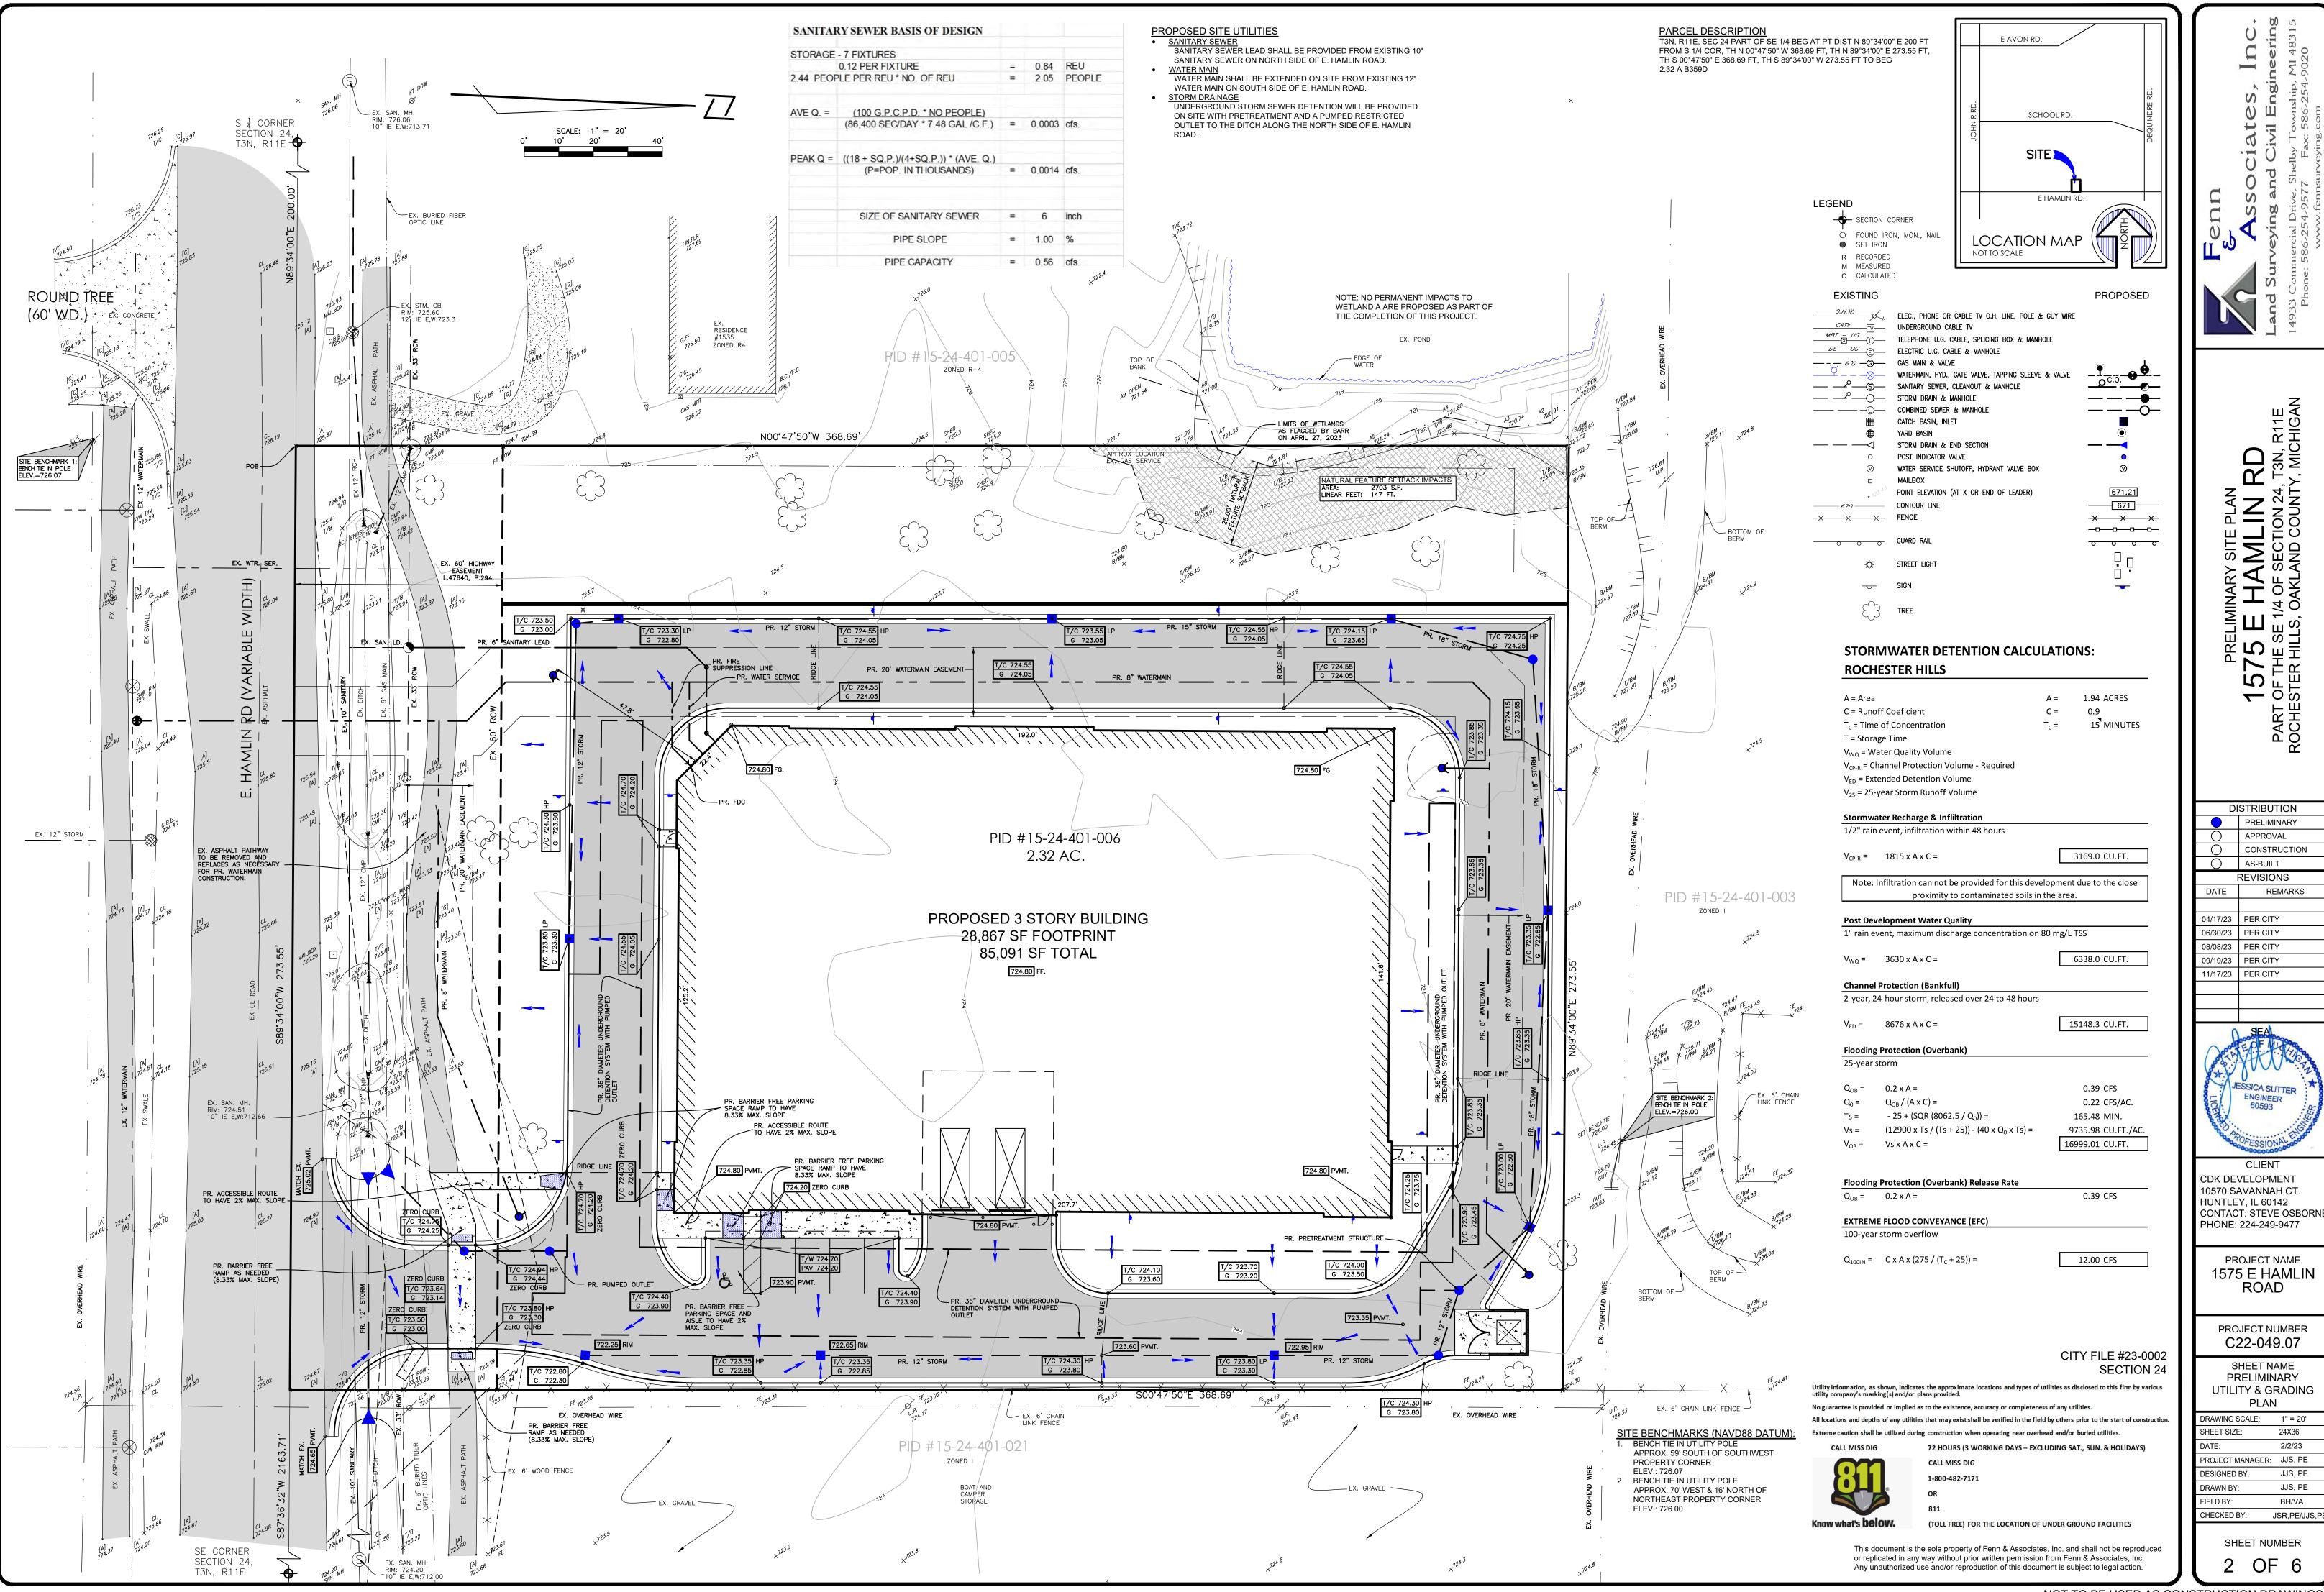


NOT TO BE USED AS CONSTRUCTION DRAWINGS

JJS, PE

JJS, PE

BH/VA

JSR,PE/JJS,PI

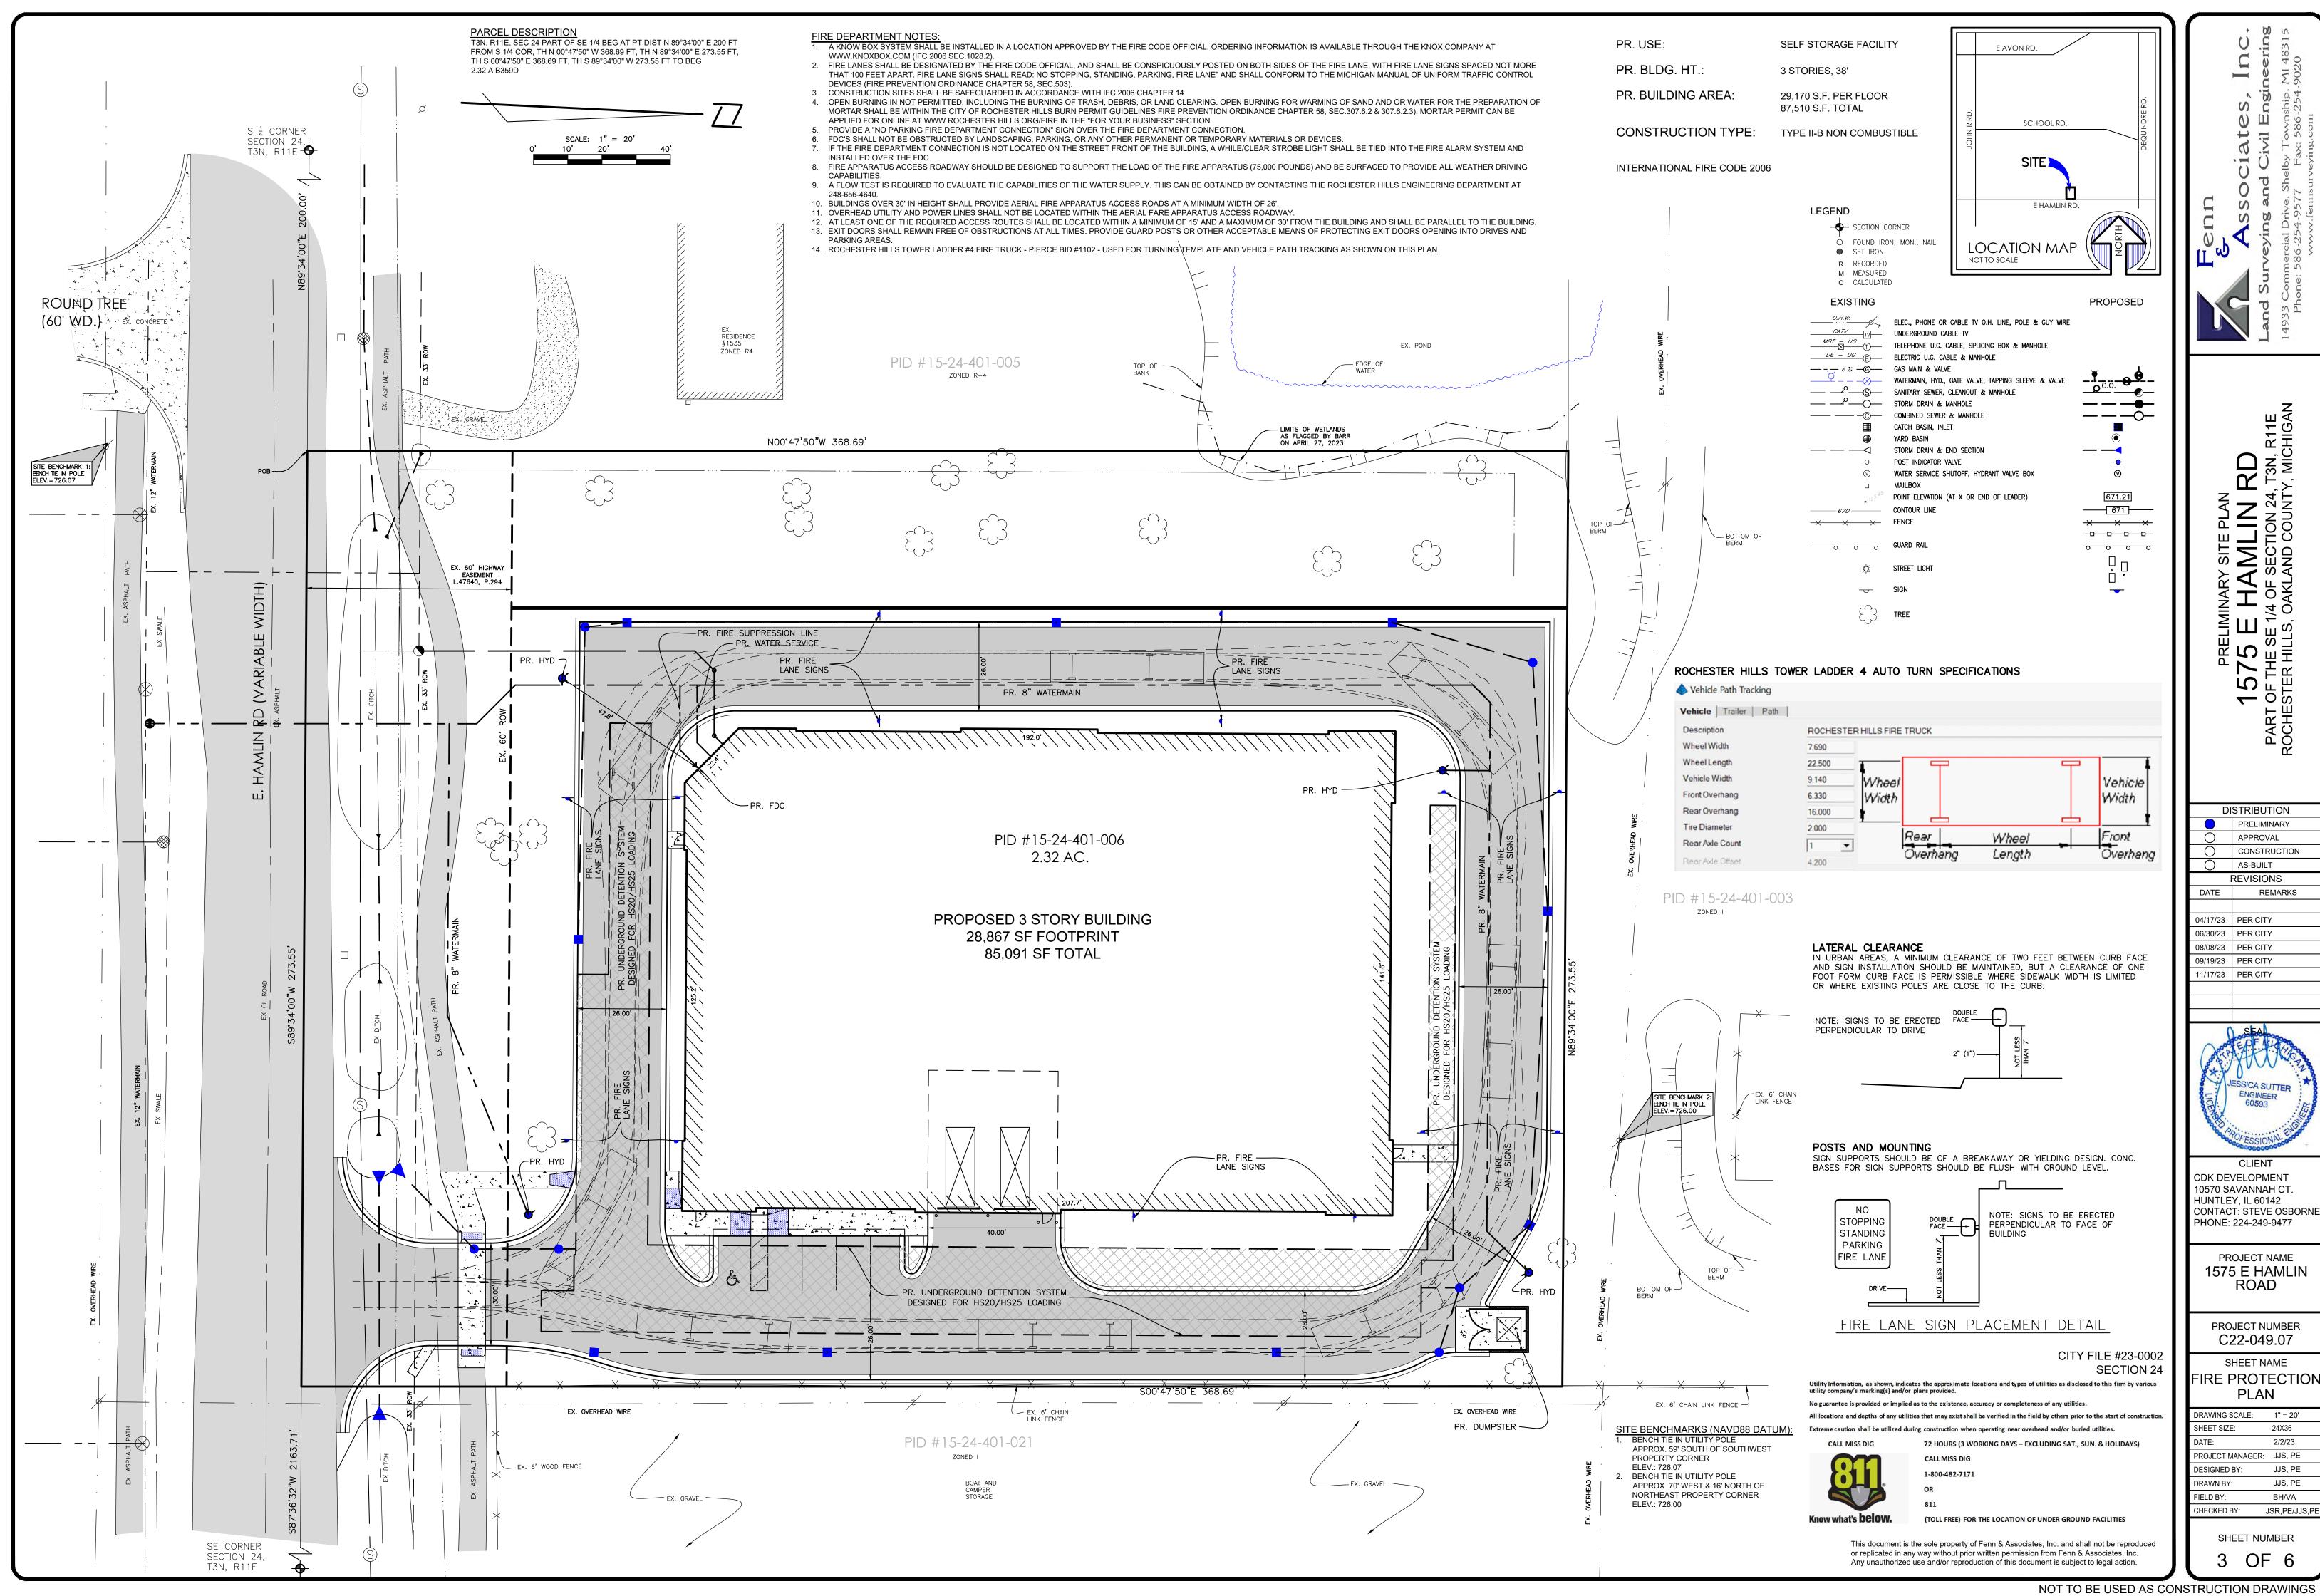

NOT TO BE USED AS CONSTRUCTION DRAWINGS

REMARKS


24X36

JJS, PE

JJS. PE

JSR,PE/JJS,P

BH/VA

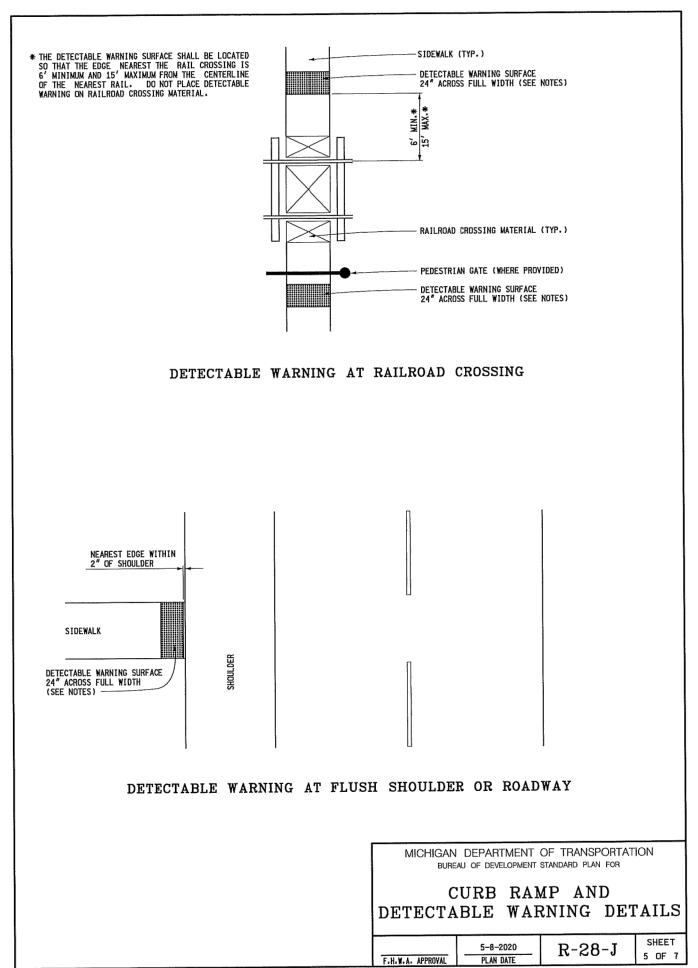

\* MAXIMUM LANDING SLOPE IS 2.0% IN EACH DIRECTION OF TRAVEL. LANDING MINIMUM DIMENSIONS  $5^\prime\times5^\prime.$  SEE NOTES.

\*\* MAXIMUM RAMP CROSS SLOPE IS 2.0%, RUNNING SLOPE 5% - 7% (8.3% MAXIMUM). SEE NOTES.

DETECTABLE WARNING SURFACE 24" ACROSS FULL WIDTH (SEE NOTES)

MDOT
Hedrogen Department of Transporterior

DESIGN DIVISION DRAWN BY: B.L.T.

CHECKED BY: W.K.P.

"NON-WALKING" AREA

- DETECTABLE WARNING SURFACE 24" ACROSS FULL WIDTH (SEE NOTES)

MICHIGAN DEPARTMENT OF TRANSPORTATION

BUREAU OF DEVELOPMENT STANDARD PLAN FOR

DETECTABLE WARNING DETAILS

R-28-J

CURB RAMP TYPE R

(ROLLED SIDES)

— FULL CURB HEIGHT MAY BE REDUCED TO ACCOMMODATE MAXIMUM SIDE FLARE SLOPE


CURB RAMP TYPE F


(FLARED SIDES, TWO RAMPS SHOWN)

DEPARTMENT DIRECTOR

Paul C. Ajegba

APPROVED BY: \_\_\_\_\_\_\_\_DIRECTOR, BUREAU OF FIELD SERVICES

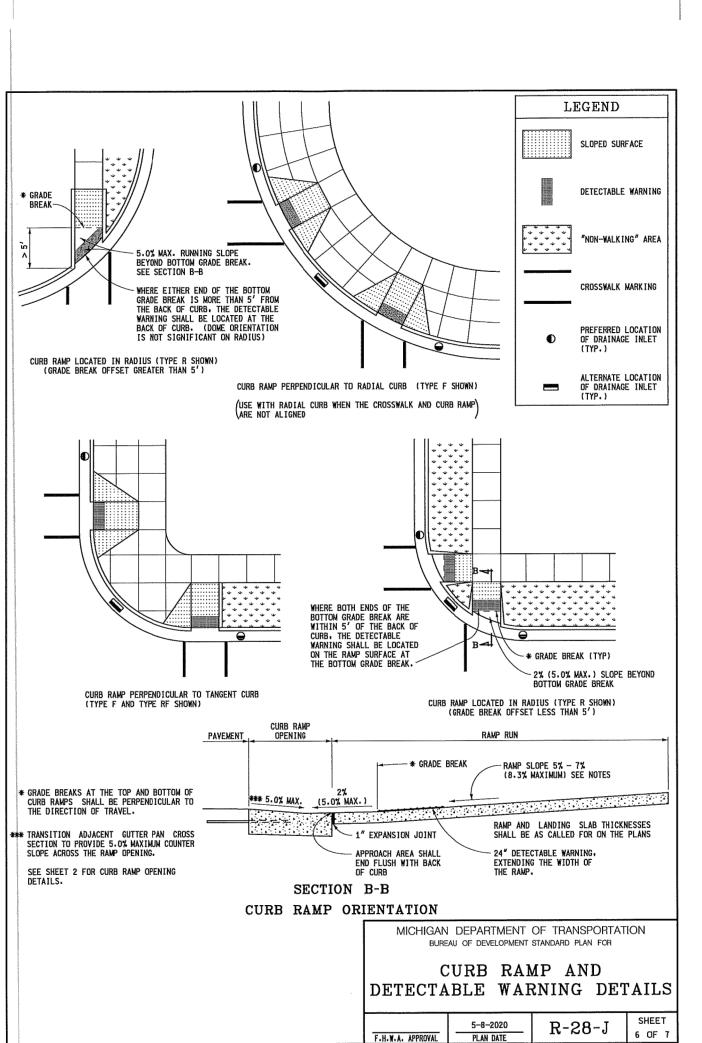

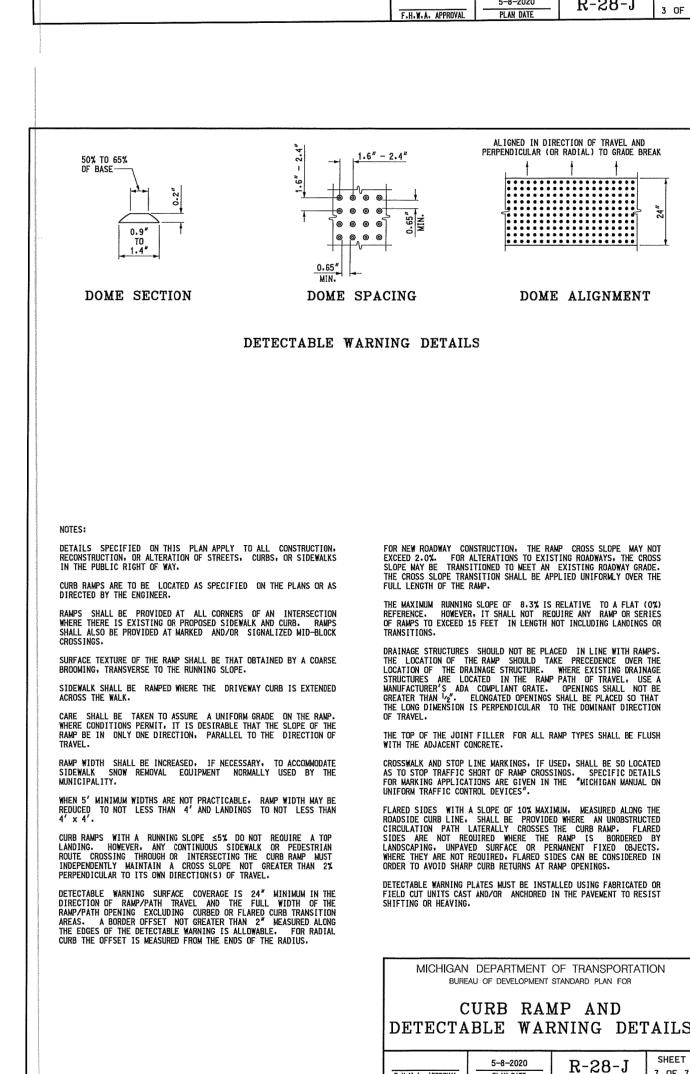


\* MAXIMUM LANDING SLOPE IS 2.0% IN EACH DIRECTION OF TRAVEL. LANDING MINIMUM DIMENSIONS  $5^\prime \times 5^\prime \cdot$  SEE NOTES.

\*\* MAXIMUM RAMP CROSS SLOPE IS 2.0%, RUNNING SLOPE 5% - 7% (8.3% MAXIMUM). SEE NOTES.

DETECTABLE WARNING SURFACE 24" ACROSS FULL WIDTH (SEE NOTES)

24" ACROSS FULL WIDTH (SEE NOTES)


"NON-WALKING" AREA -

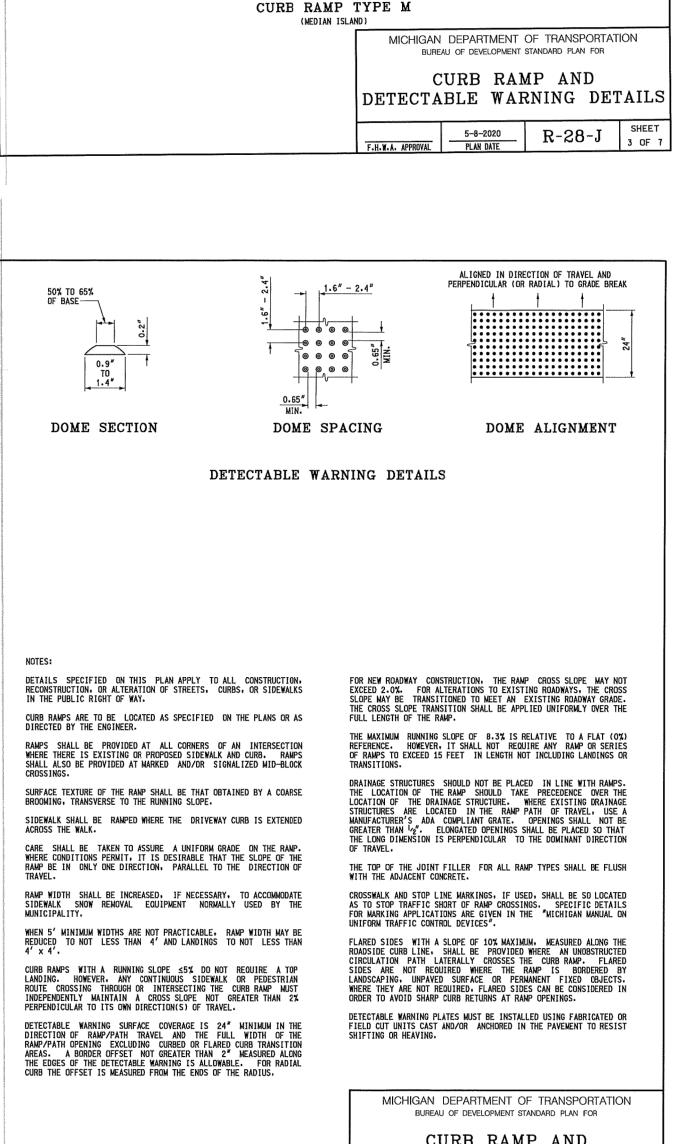



CURB RAMP TYPE P (PARALLEL RAMP)
DO NOT USE IN AREAS WHERE PONDING MAY OCCUR

CURB RAMP TYPE C

(COMBINATION RAMP)

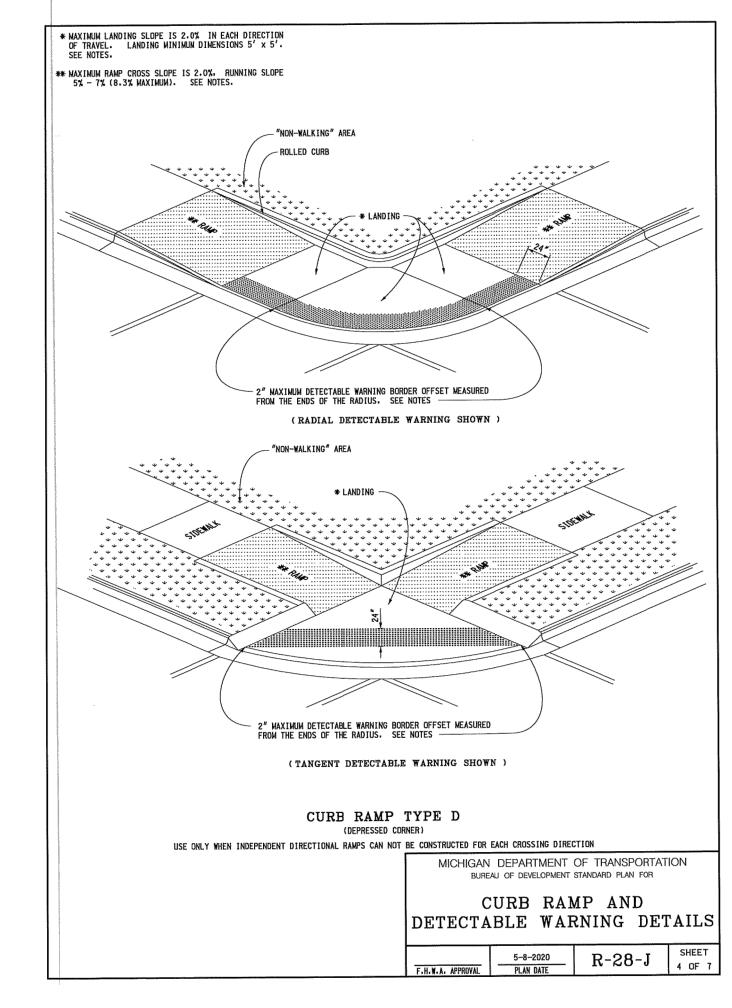

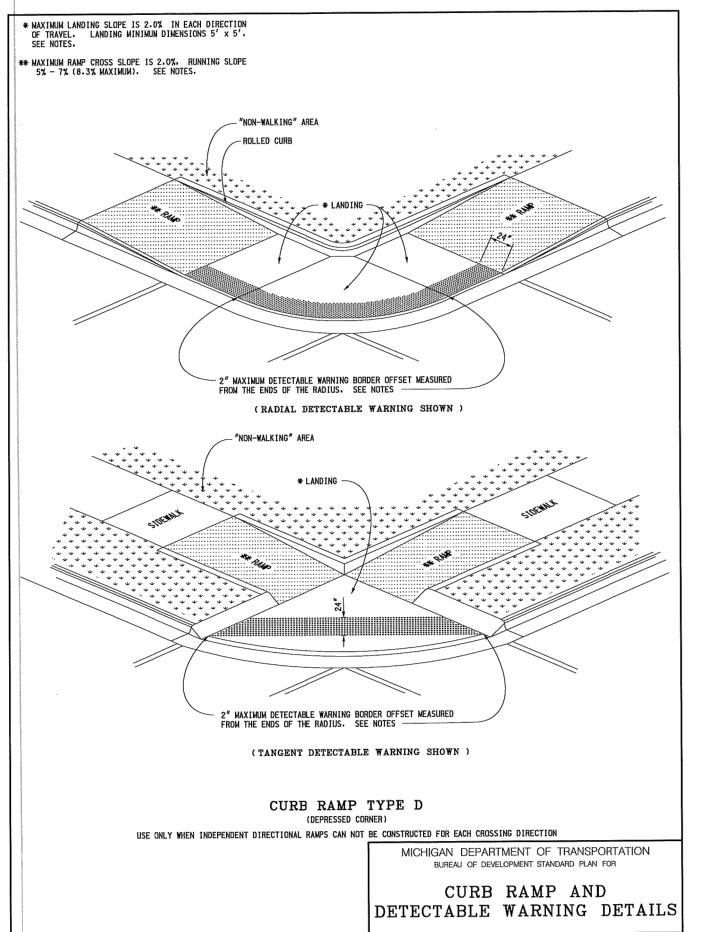

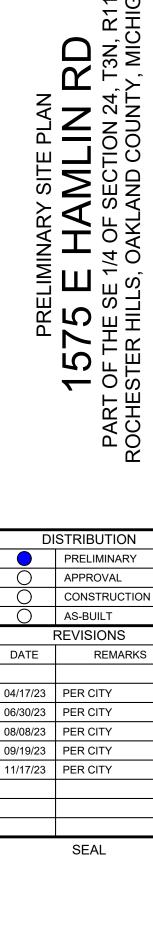

DISTRIBUTION

RAWING SCALE: N/A 24X36 PROJECT MANAGER: JJS, PE DESIGNED BY JJS, PE JJS. PE DRAWN BY FIELD BY: BH/VA CHECKED BY: JSR,PE/JJS,P SHEET NUMBER

CLIENT

CONTACT: STEVE OSBORNI

PROJECT NAME

1575 E HAMLIN

ROAD

PROJECT NUMBER

C22-049.07

SHEET NAME

DETAILS

CDK DEVELOPMENT

10570 SAVANNAH CT. HUNTLEY, IL 60142

PHONE: 224-249-9477

or replicated in any way without prior written permission from Fenn & Associates, Inc. OF 6 Any unauthorized use and/or reproduction of this document is subject to legal action.

CITY FILE #23-0002

Utility Information, as shown, indicates the approximate locations and types of utilities as disclosed to this firm by various utility company's marking(s) and/or plans provided.

All locations and depths of any utilities that may exist shall be verified in the field by others prior to the start of construction.

72 HOURS (3 WORKING DAYS – EXCLUDING SAT., SUN. & HOLIDAYS)

(TOLL FREE) FOR THE LOCATION OF UNDER GROUND FACILITIES

This document is the sole property of Fenn & Associates, Inc. and shall not be reproduced

No guarantee is provided or implied as to the existence, accuracy or completeness of any utilities.


**CALL MISS DIG** 


1-800-482-7171

**CALL MISS DIG** 

Extreme caution shall be utilized during construction when operating near overhead and/or buried utilities.

**SECTION 24** 

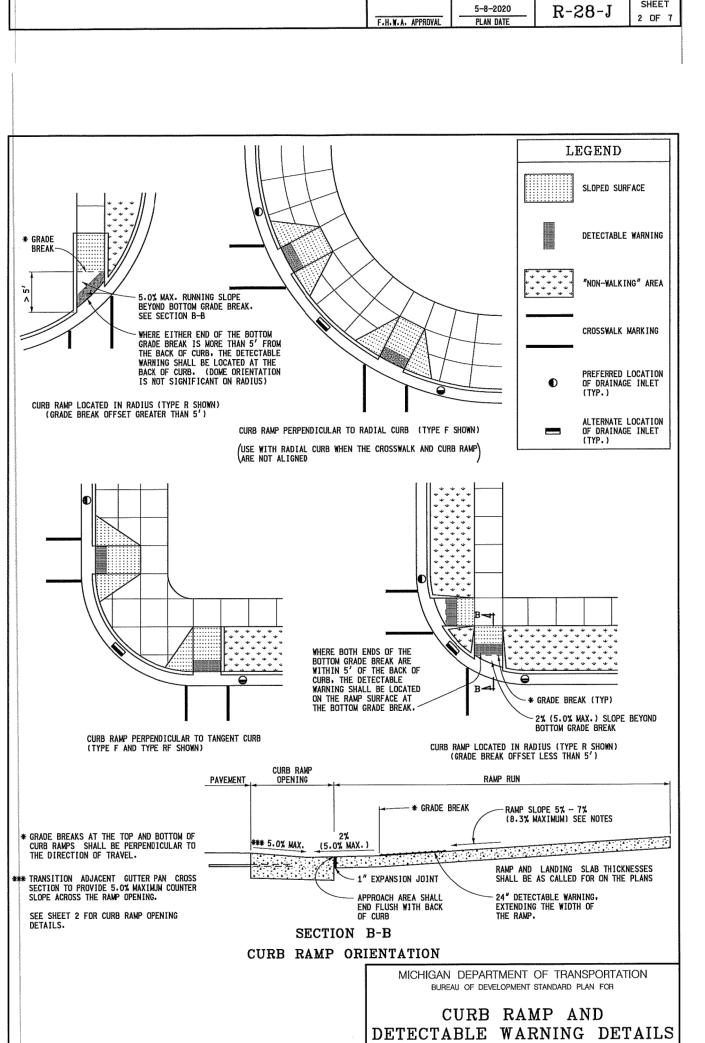

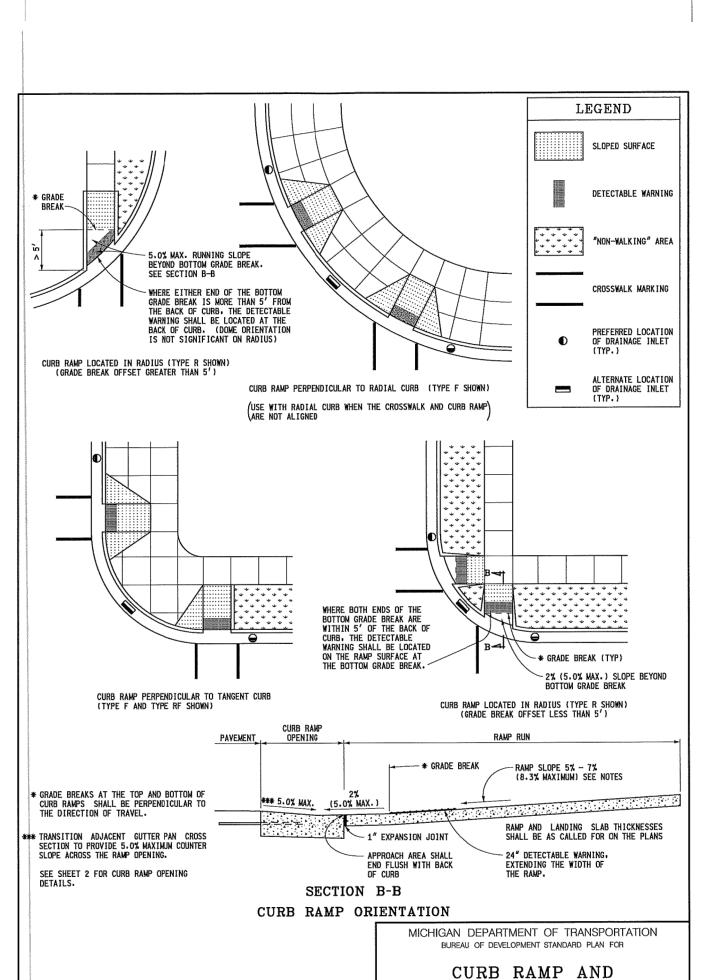

\* MAXIMUM LANDING SLOPE IS 2.0% IN EACH DIRECTION OF TRAVEL. LANDING MINIMUM DIMENSIONS 5' x 5'. SEE NOTES.

\*\* MAXIMUM RAMP CROSS SLOPE IS 2.0%, RUNNING SLOPE 5% - 7% (8.3% MAXIMUM). SEE NOTES.

FOR CURB TYPES SEE STANDARD PLAN R-30-SERIES

WALKING AREA

1" EXPANSION JOINT

LANE TIE AND REINFORCEMENT
AS IN ADJACENT CURB & GUTTER
SEE STANDARD PLAN R-30-SERIES

CURB RAMP TYPE RF

(ROLLED / FLARED SIDES)

SECTION A-A

- "NON-WALKING" AREA

- DETECTABLE WARNING SURFACE 24" ACROSS FULL WIDTH (SEE NOTES)

NOT TO EXCEED
MAXIMUM RISE B

SECTION THROUGH CURB RAMP OPENING

(TYPICAL ALL RAMP TYPES)

- RAMP SLOPE 5% - 7% (8.3% MAXIMUM) SEE NOTES

- PAVEMENT SHALL END FLUSH WITH THE GUTTER PAN

\*\*\* 5.0% MAX.

\* LANDING

RAMP AND LANDING SLAB THICKNESSES SHALL BE AS CALLED FOR ON THE PLANS

MICHIGAN DEPARTMENT OF TRANSPORTATION


BUREAU OF DEVELOPMENT STANDARD PLAN FOR


CURB RAMP AND


DETECTABLE WARNING DETAILS

\*\*\* TRANSITION ADJACENT GUTTER PAN CROSS SECTION TO PROVIDE 5.0% MAXIMUM COUNTER SLOPE ACROSS THE RAMP OPENING.


FLUSH WITH BACK OF CURB

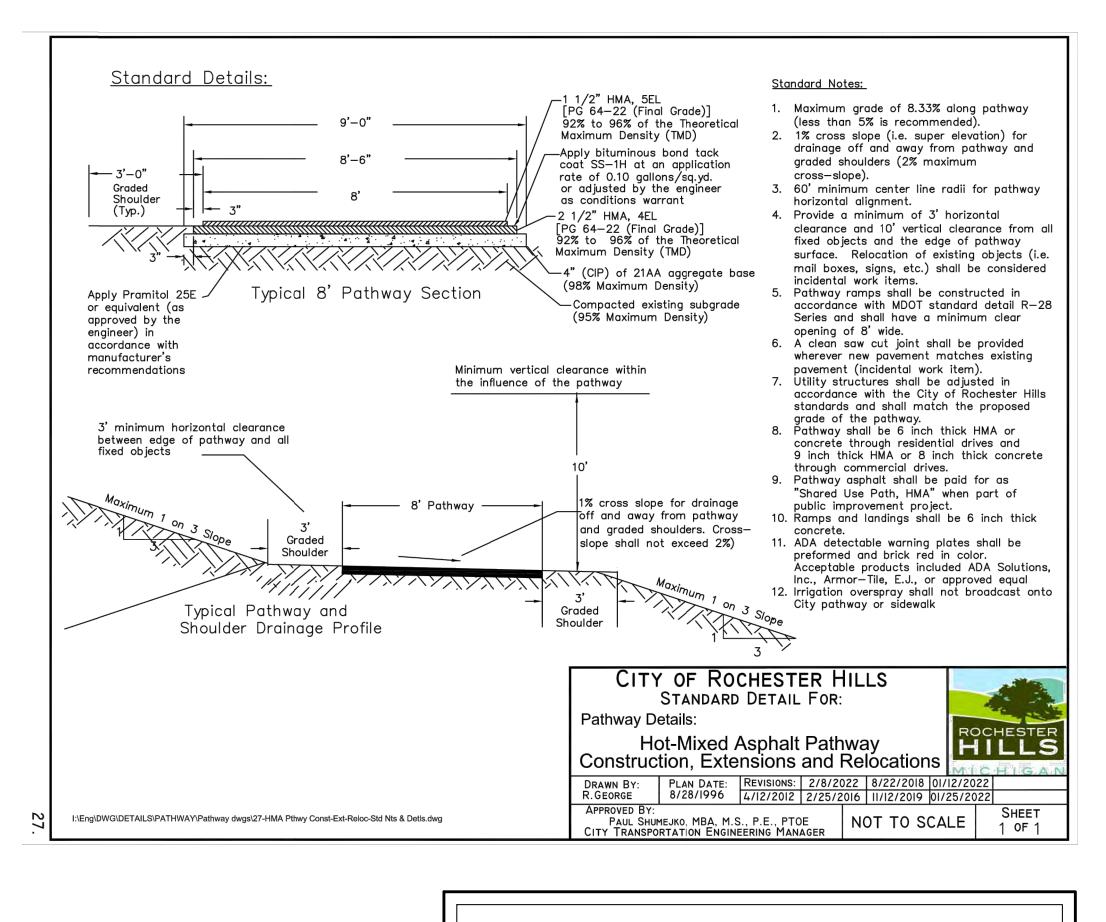


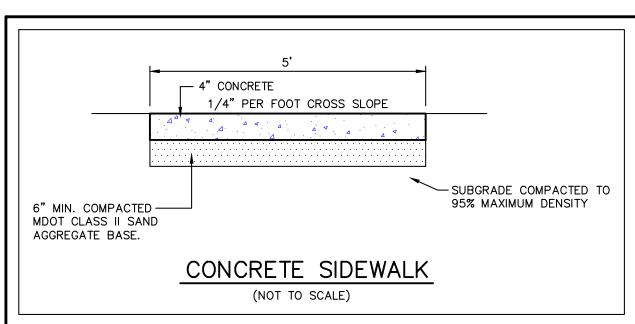


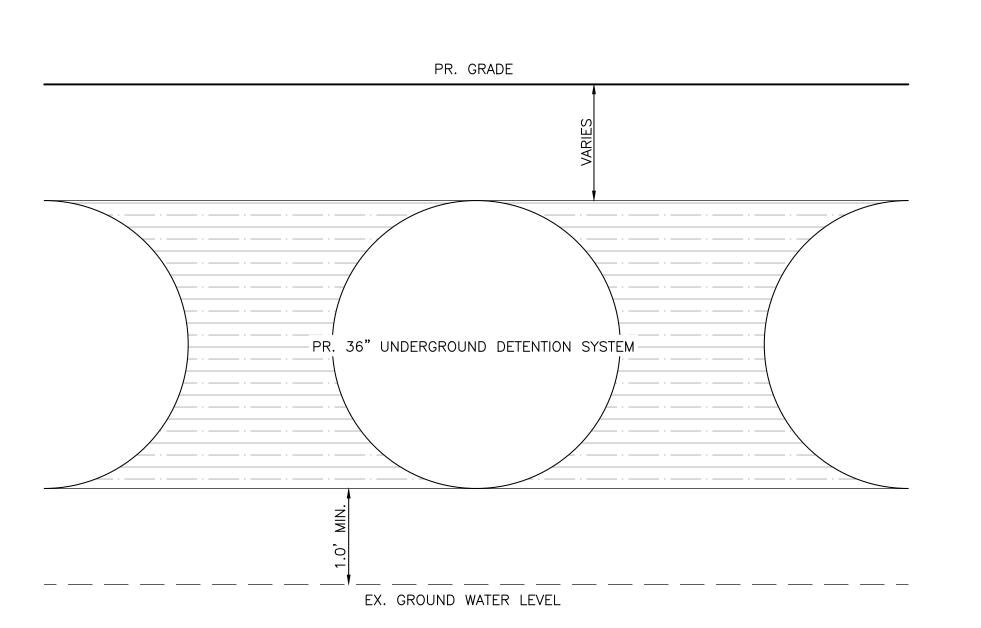



TYPICAL UNDERGROUND DETENTION SECTION
(NOT TO SCALE)

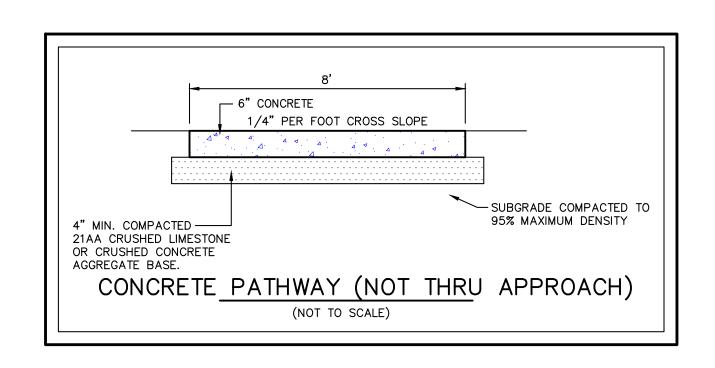

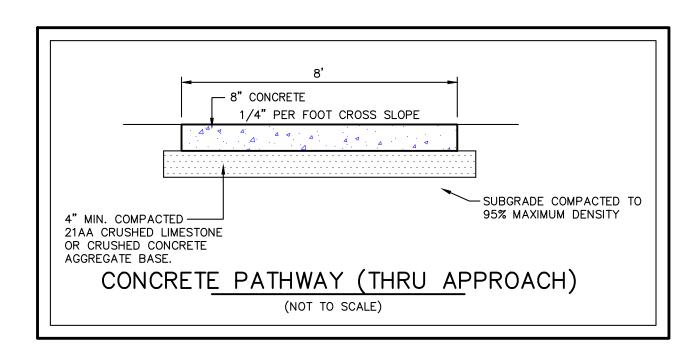

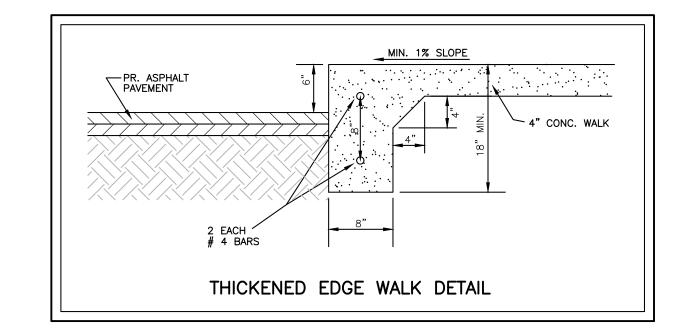


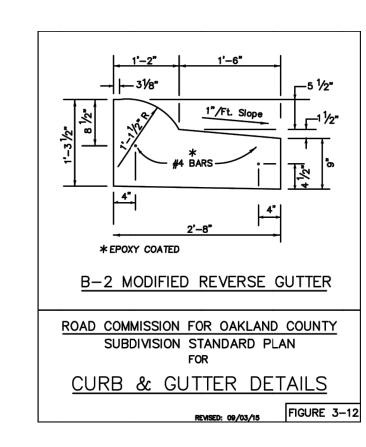

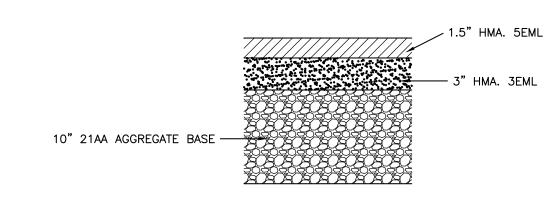

#### 4.5' BITUMINOUS PAVEMENT DETAIL ON-SITE ONLY

NOT TO SCALE

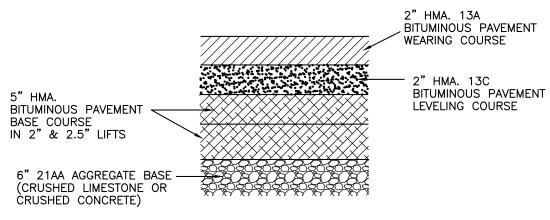

#### 9' BITUMINOUS PAVEMENT DETAIL R.O.W. ONLY

NOT TO SCALE

CITY FILE #23-0002 SECTION 24

Utility Information, as shown, indicates the approximate locations and types of utilities as disclosed to this firm by various utility company's marking(s) and/or plans provided.

No guarantee is provided or implied as to the existence, accuracy or completeness of any utilities.

All locations and depths of any utilities that may exist shall be verified in the field by others prior to the start of construction

Extreme caution shall be utilized during construction when operating near overhead and/or buried utilities.

CALL MISS DIG 72 HOURS (3 WORKING DAYS – EXCLUDING SAT., SUN. & HOLIDAYS)



CALL MISS DIG 1-800-482-7171 OR

(TOLL FREE) FOR THE LOCATION OF UNDER GROUND FACILITIES the sole property of Fenn & Associates. Inc. and shall not be rep

This document is the sole property of Fenn & Associates, Inc. and shall not be reproduced or replicated in any way without prior written permission from Fenn & Associates, Inc. Any unauthorized use and/or reproduction of this document is subject to legal action.

NOT TO BE USED AS CONSTRUCTION DRAWINGS

Fenn E Associate

Land Surveying and Civil

14933 Commercial Drive, Shelby Tow
Phone: 586-254-9577 Fax: 58

 $\overline{\phantom{a}}$ 

PRELIMINARY SITE PLAN

1575 E HAMLIN RD

PART OF THE SE 1/4 OF SECTION 24, T3N,
ROCHESTER HILLS, OAKLAND COUNTY, MIC

CONSTRUCTION
AS-BUILT
REVISIONS
DATE REMARKS

04/17/23 PER CITY
06/30/23 PER CITY
08/08/23 PER CITY
09/19/23 PER CITY
11/17/23 PER CITY

SEAL

APPROVAL

CLIENT CDK DEVELOPMENT

CONTACT: STEVE OSBORNE PHONE: 224-249-9477 PROJECT NAME

PROJECT NAME 1575 E HAMLIN ROAD

10570 SAVANNAH CT.

HUNTLEY, IL 60142

PROJECT NUMBER C22-049.07

C22-049.07

SHEET NAME

DETAILS

DRAWING SCALE: N/A

SHEET SIZE: 24X36

DATE: 2/2/23

PROJECT MANAGER: JJS, PE

DESIGNED BY: JJS, PE


DRAWN BY: JJS, PE

FIELD BY: BH/VA

CHECKED BY: JSR,PE/JJS,PE

SHEET NUMBER

5 OF 6

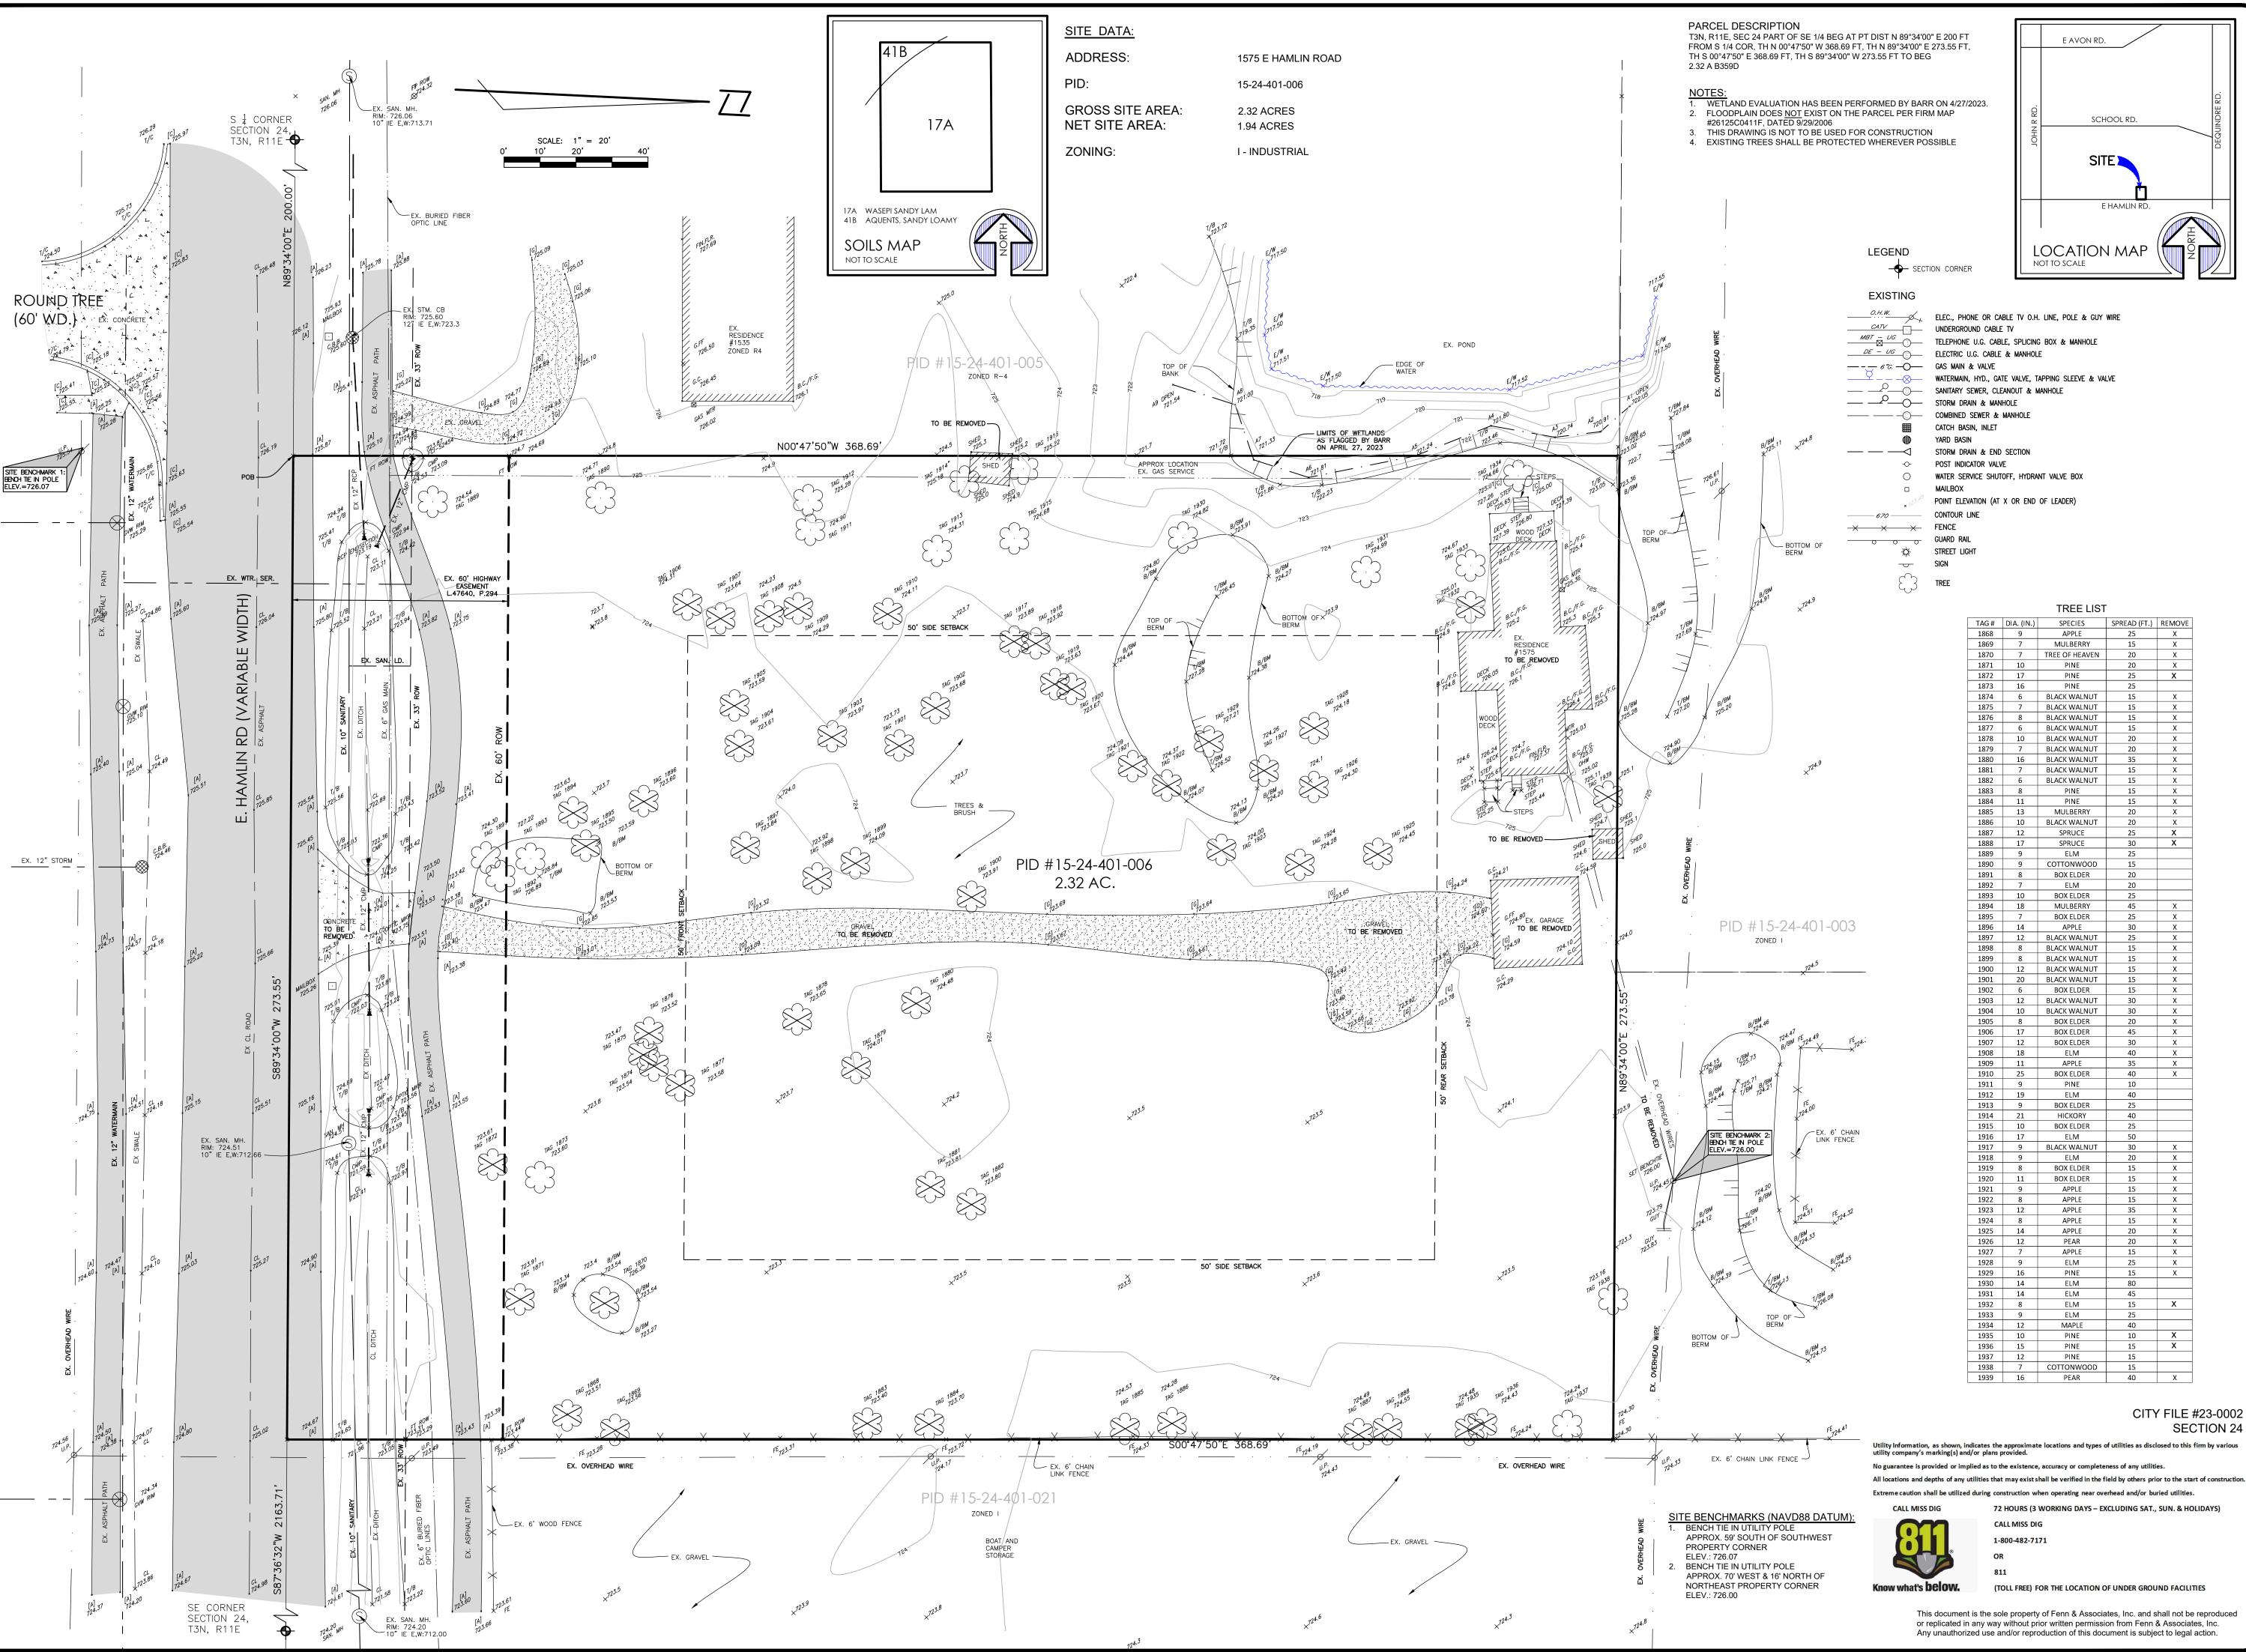

SCHOOL RD.

JESSICA SUTTER CDK DEVELOPMENT

10570 SAVANNAH CT. HUNTLEY, IL 60142 CONTACT: STEVE OSBORNE PHONE: 224-249-9477

5 **ທ** ≝ ਵ

DISTRIBUTION PRELIMINARY

APPROVAL

REVISIONS

DATE REMARKS

AS-BUILT

04/17/23 PER CITY 06/30/23 PER CITY 08/08/23 PER CITY 09/19/23 PER CITY 11/17/23 PER CITY

CONSTRUCTION

PROJECT NAME 1575 E HAMLIN ROAD

PROJECT NUMBER C22-049.07

SHEET NAME **TOPOGRAPHIC** MAPPING

DRAWING SCALE: 1" = 20'

24X36 PROJECT MANAGER: JJS, PE DESIGNED BY: JJS, PE RP/JJS, PE DRAWN BY FIELD BY: BH/VA CHECKED BY: JSR,PE/JJS,PE

> SHEET NUMBER 6 OF 6

NOT TO BE USED AS CONSTRUCTION DRAWINGS

CITY FILE #23-0002

**SECTION 24** 

Avg/Min

N/A

6.0:1

N/A

N/A

N/A

5.5:1

N/A

6.5:1

HAMLI

Designer
RTT
Date
05/16/2023
Scale
Not to Scale
<b>Drawing No</b>

Summary

1 of 1

	Statistics							
	Description	Symbol	Avg	Max	Min	Max/Min		
	East Boundary Line	+	0.2 fc	0.3 fc	0.0 fc	N/A		
	East Building Exterior	+	1.2 fc	3.0 fc	0.2 fc	15.0:1		
	North Boundary Line	+	0.0 fc	0.0 fc	0.0 fc	N/A		
	North Building Exterior	+	1.5 fc	3.0 fc	0.0 fc	N/A		
	South Boundary Line	+	0.2 fc	0.4 fc	0.0 fc	N/A		
	South Building Exterior	+	1.1 fc	3.0 fc	0.2 fc	15.0:1		

0.0 fc

1.3 fc

0.0 fc


2.6 fc

0.0 fc

0.2 fc

N/A

13.0:1

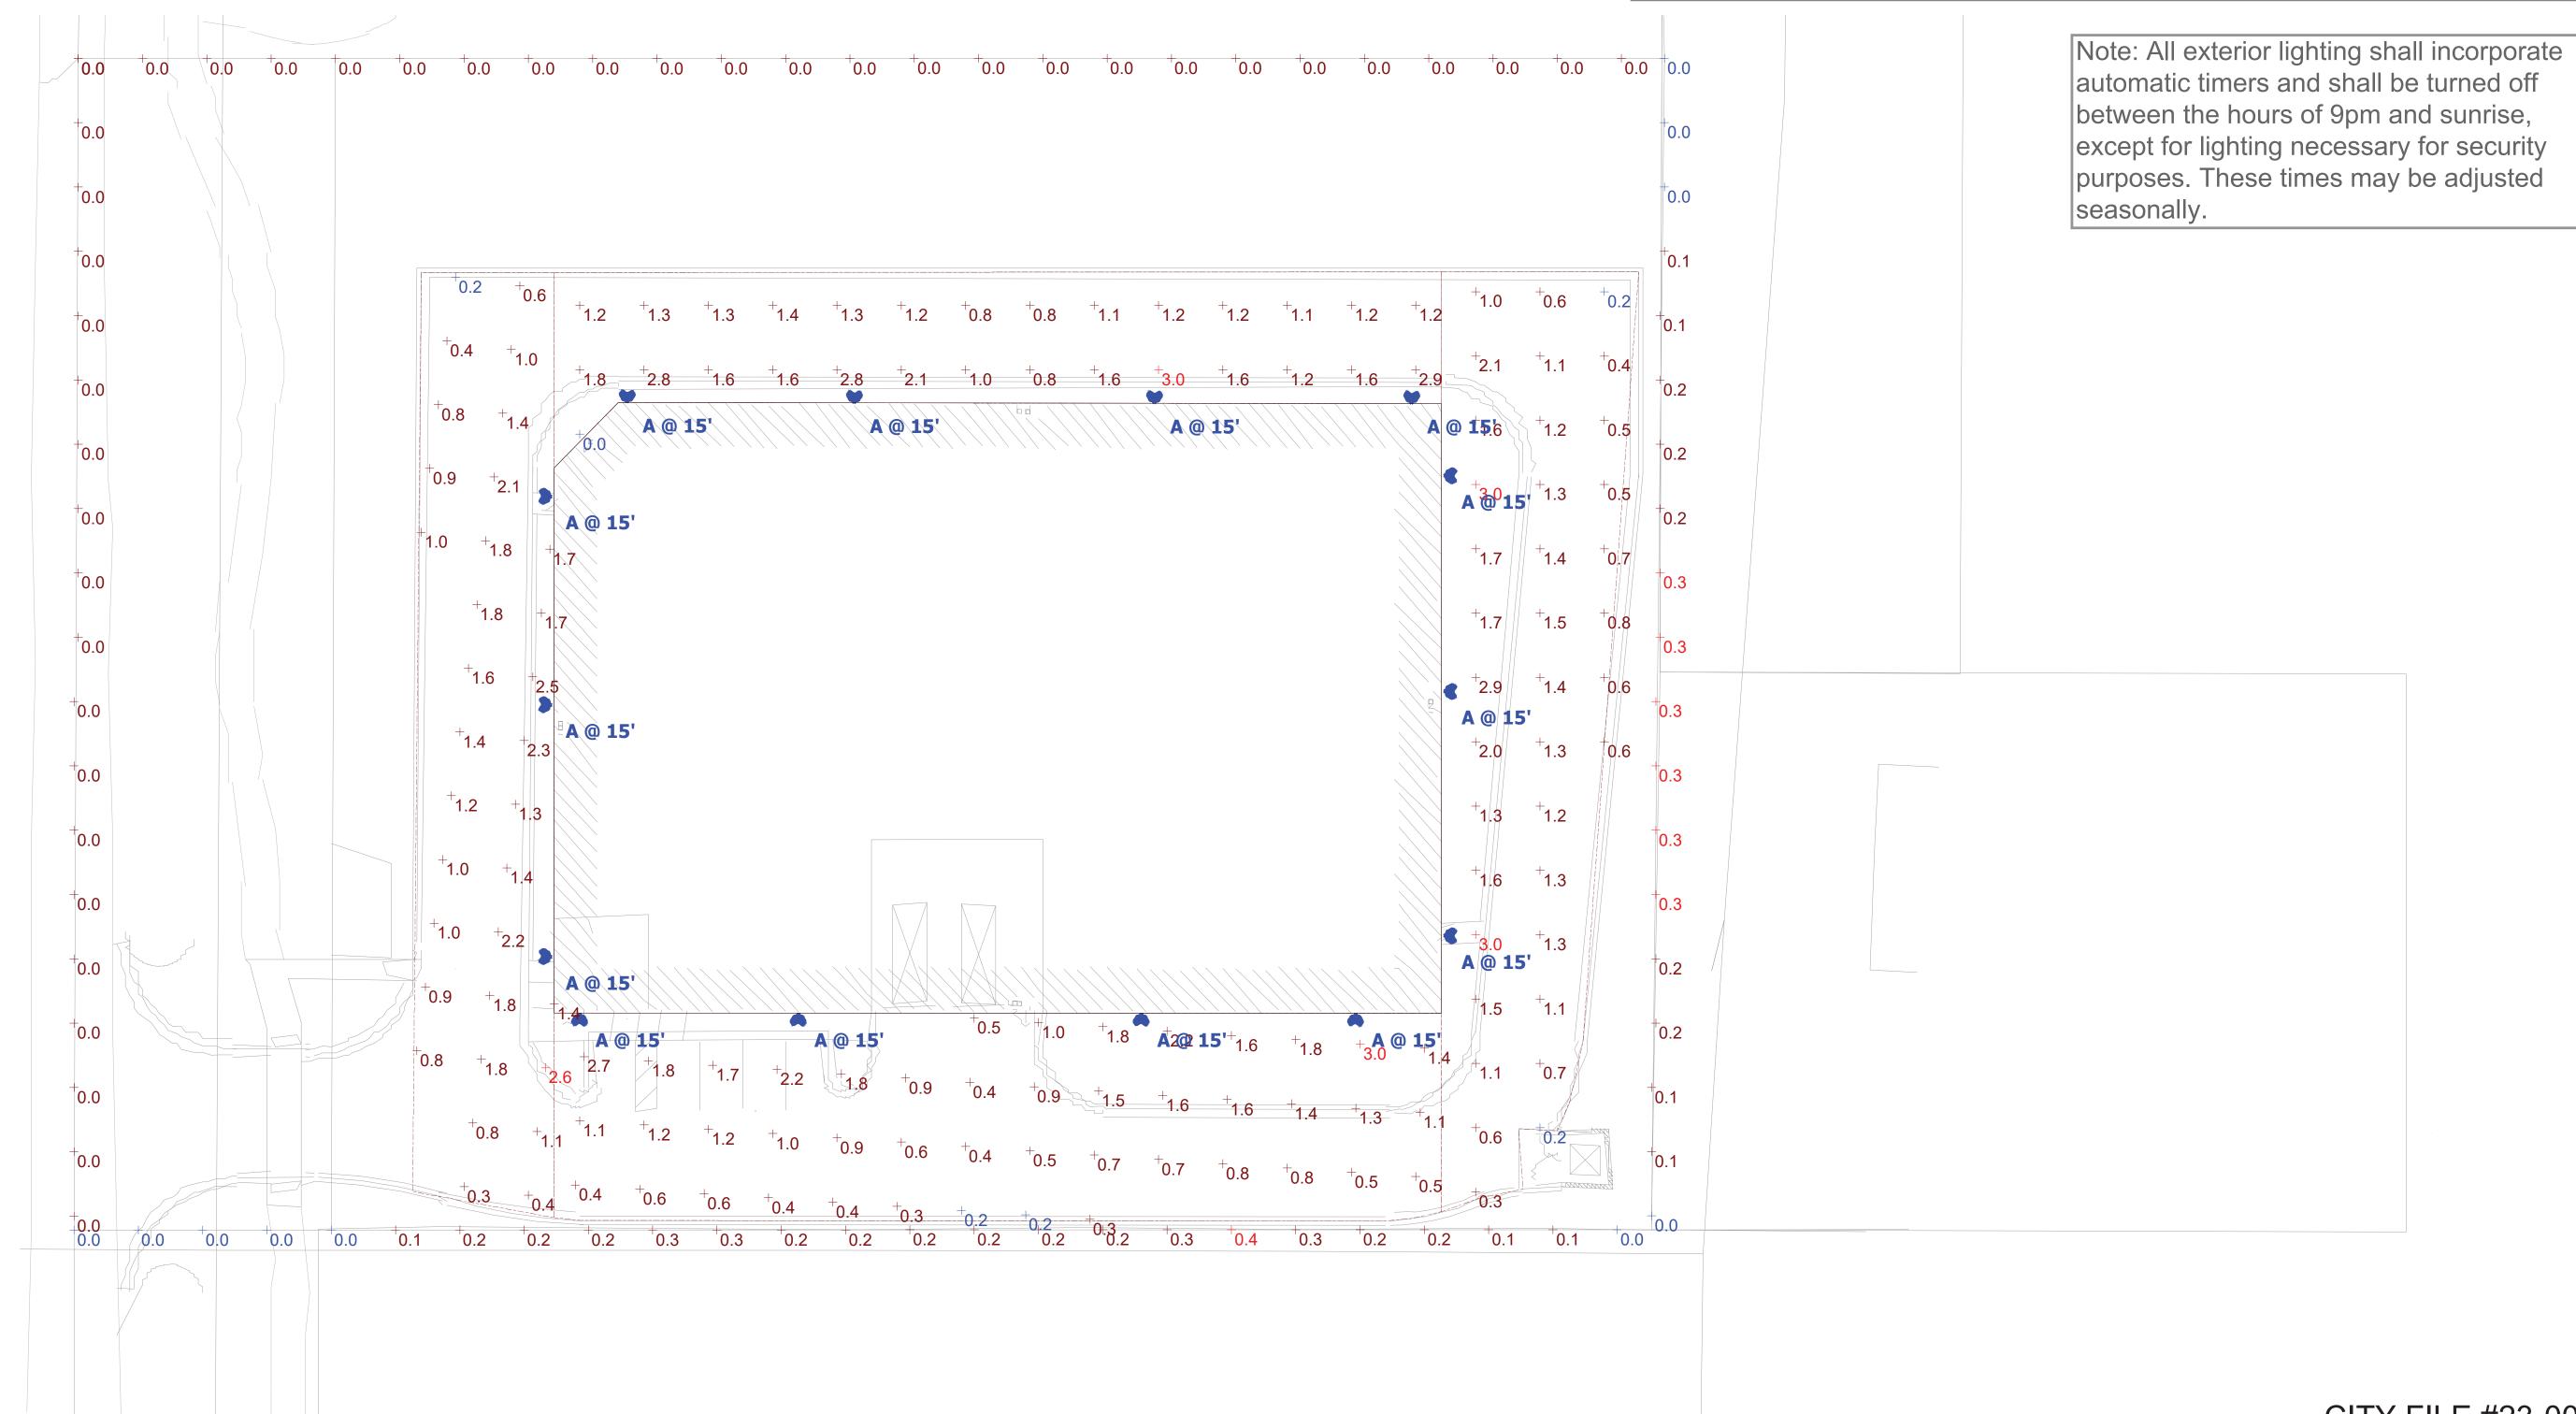

**Plan View** 

Light Loss Factor

Wattage

Plot

Max: 2695cd

West Boundary Line

West Building Exterior

Number Lumens Lamps Per Lamp

4115

Schedule

Quantity Manufacturer

14 Lithonia Lighting

**Catalog Number** 

30K TFTM MVOLT

DSXW2 LED 30C 350

Description

DSXW2 LED WITH 3 LIGHT ENGINES, 30

FORWARD THROW MEDIUM OPTIC

CITY FILE #23-0002 SECTION 24

### sheet index

LS-1 GENERAL LANDSCAPE PLAN
LS-2 PLANT MATERIAL LIST NOTES
& PLANT DETAILS

#### general landscape notes:

1. LANDSCAPE CONTRACTOR SHALL VISIT THE SITE, INSPECT EXISITING CONDITIONS, REVIEW PROPOSED PLANTINGS AND RELATED WORK, CONTACT THE OWNER AND/OR LANDSCAPE ARCHITECT WITH ANY CONCERNS OR DISCREPANCY BETWEEN THE PLAN, PLANT MATERIAL LIST, AND/OR SITE CONDITIONS.

2. PRIOR TO BEGINING OF CONSTRUCTION ON ANY WORK, CONTRACTORS SHALL VERIFY LOCATIONS OF ALL ON SITE UTILITIES. GAS, ELECTRIC, TELEPHONE, CABLE TO BE LOCATED BY CONTACTING MISS DIG 1-800-482-1111. ANY DAMAGE OR INTERRUPTION OF SERVICES SHALL BE THE RESPONSIBILITY OF THE CONTRACTOR. COORDINATE ALL RELATED WORK ACTIVITIES WITH OTHER TRADES AND REPORT ANY UNACCEPTABLE JOB CONDITIONS TO OWNER PRIOR TO COMMENCING

3. NUMERICAL VALUE ON THE LANDSCAPE QUANTITIES SPECIFIED ON THE PLAN TAKE PRECEEDENCE OVER GRAPHIC REPRESENTATION. VERIFY ANY CONCERN-DISCREPANCY WITH LANDSCAPE ARCHITECT.

4. ALL CONSTRUCTION AND PLANT MATERIAL LOCATION TO BE ADJUSTED ON SITE IF NECESSARY

5. ALL SUBSTITUTIONS OR DEVIATIONS FROM THE LANDSCAPE PLAN MUST BE APPROVED BY CITY OF ROCHESTER HILLS AND LANDSCAPE ARCHITECT

6. ALL LARGE TREES AND EVERGREENS TO BE STAKED, GUYED AND WRAPPED AS DETAIL SHOWN ON PLAN.

1. PLANT BEDS TO BE DRESSED WITH MIN. 4" OF FINELY DOUBLE SHREDDED HARDBARK MULCH.

8. DIG SHRUB PITS I' LARGER THAN SHRUB ROOT BALLS AND TREE PITS 2' LARGER THAN ROOT BALL. BACK FILL WITH ONE PART TOP SOIL AND ONE PART SOIL FROM EXCAVATED PLANTING HOLE.

9. NATURAL COLOR, FINELY SHREDDED HARDWOOD BARK MULCH REQUIRED FOR ALL PLANTINGS.

10. REMOVE ALL TWINE, WIRE AND BURLAP FROM TREE AND SHRUB EARTH BALLS, AND FROM TREE TRUNKS. 4" THICK BARK MULCH FOR TREES IN 4' DIA. CIRCLE WITH 3" PULLED AWAY FROM TRUNK. 4" THICK BARK MULCH FOR SHRUBS AND 2" THICK BARK MULCH FOR PERENNIALS

11. PLANT MATERIAL QUALITY & INSTALLATION SHALL BE IN ACCORDANCE WITH THE CURRENT AMERICAN ASSOCIATION OF NURSERYMEN LANDSCAPE STANDARDS.

12. PROVIDE PEAT SOD FOR ALL NEW AND DISTURBED LAWN AREAS UNLESS NOTED OTHERWISE. NO PEAT SOD

13. ALL PLANTING AREAS TO BE PREPARED WITH APPROPRIATE SOIL MIXTURES AND FERTILIZER BEFORE PLANT INSTALLATION.

14. PLANT TREES AND SHRUBS GENERALLY NO CLOSES	R THEN THE FOLLOWING DISTANCES
FROM SIDEWALKS, CURBS AND PARKING STALLS:	
a). SHADE TREES	5 FT.
b). ORNAMENTAL AND EVERGREEN TREES	
(CRAB PINE SPRUCE ETC.)	10 FT

15. NO TREES OR EVERGREENS TO BE INSTALLED OVER ANY PROPOSED OR EXISTING UTILITY LINES AS SHOWN ON THE OVERALL LANDSCAPE PLAN. SEE ENGINEERING PLANS FOR LOCATION AND DETAILS.

16. ALL LAWN AREAS AND LANDSCAPE BEDS TO BE FULLY IRRIGATED WITH A AUTOMATIC UNDERGROUND SYSTEMS. IRRIGATION SYSTEM TO HAVE SEPARTE ZONES FOR LAWN AREAS, PARKING ISLANDS, AND SHRUB BEDS WITH DIFFERENT CONTROL MOISTURE LEVEL ADJUSTMENT PER ZONE AS REQUIRED

17. UNLESS NOTED OTHERWISE, LANDSCAPE BEDS ADJACENT TO LAWN TO RECIEVE EDGING. EDGING SHALL BE 4"  $\times$  1/8" METAL (FINISH BLACK OR GREEN) OR APPROVED EQUAL AND TO BE INSTALLED WITH HORIZONTAL METAL STAKES AT 32" O.C. OR PER MANUFACTERER'S SPECIFICATION.

18. ALL NEW PARKING ISLANDS AND LANDSCAPE BEDS ADJACENT AND NEXT TO BUILDING SHALL BE EXCAVATED OF ALL BUILDING MATERIALS AND POOR SOILS A MIN. OF 16"-18" DEPTH. BACK FILL WITH GOOD, MEDIUM TEXTURED PLANTING SOILS. ADD A MIN. 4" OF TOPSOIL OVERFILL TO FINISH GRADE. PROVIDE POSITIVE DRAINAGE.

19. WATERING OF ALL PLANTS AND TREES TO BE PROVIDED IMMEDIATELY AND

MULCHING WITHIN 24 HOURS AFTER INSTALLATION.

SHRUBS THAT ARE LESS THAN I FOOT TALL

AND WIDE AT MATURITY

20. ALL TREE PITS TO BE TESTED FOR PROPER DRAINAGE PRIOR TO TREE PLANTING. PROVIDE APPROPERATES DRAINAGE SYSTEM AS REQUIRED IF THE TREE PIT DOES NOT DRAIN SUFFICIENTLY.

21. THE LANDSCAPE CONTRACTOR SHALL GUARANTEE ALL LANDSCAPE PLANT MATERIALS AND IRRIGATION INSTALLATION FOR A PERIOD OF TWO YEAR BEGINNING AFTER THE COMPLETION OF LANDSCAPE INSTALLTION DATE APPROVED BY THE CITY OR LANDSCAPE ARCHITECT. THE CONTRACTOR SHALL REPLACE DURING AND AT THE END OF THE GUARANTEE PERIOD, ANY DEAD OR UNACCEPTABLE PLANTS, AS DETERMINED BY THE TOWNSHIP OR LANDSCAPE ARCHITECT, WITHOUT COST TO THE OWNER.


#### landscape plan for:


# 1575 E Hamlin Road

## City of Rochester Hills, Michigan

#### note:

unless noted otherwise, numerical value on landscape quantities specified on plan take precedence over graphic representation.

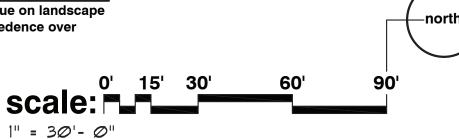

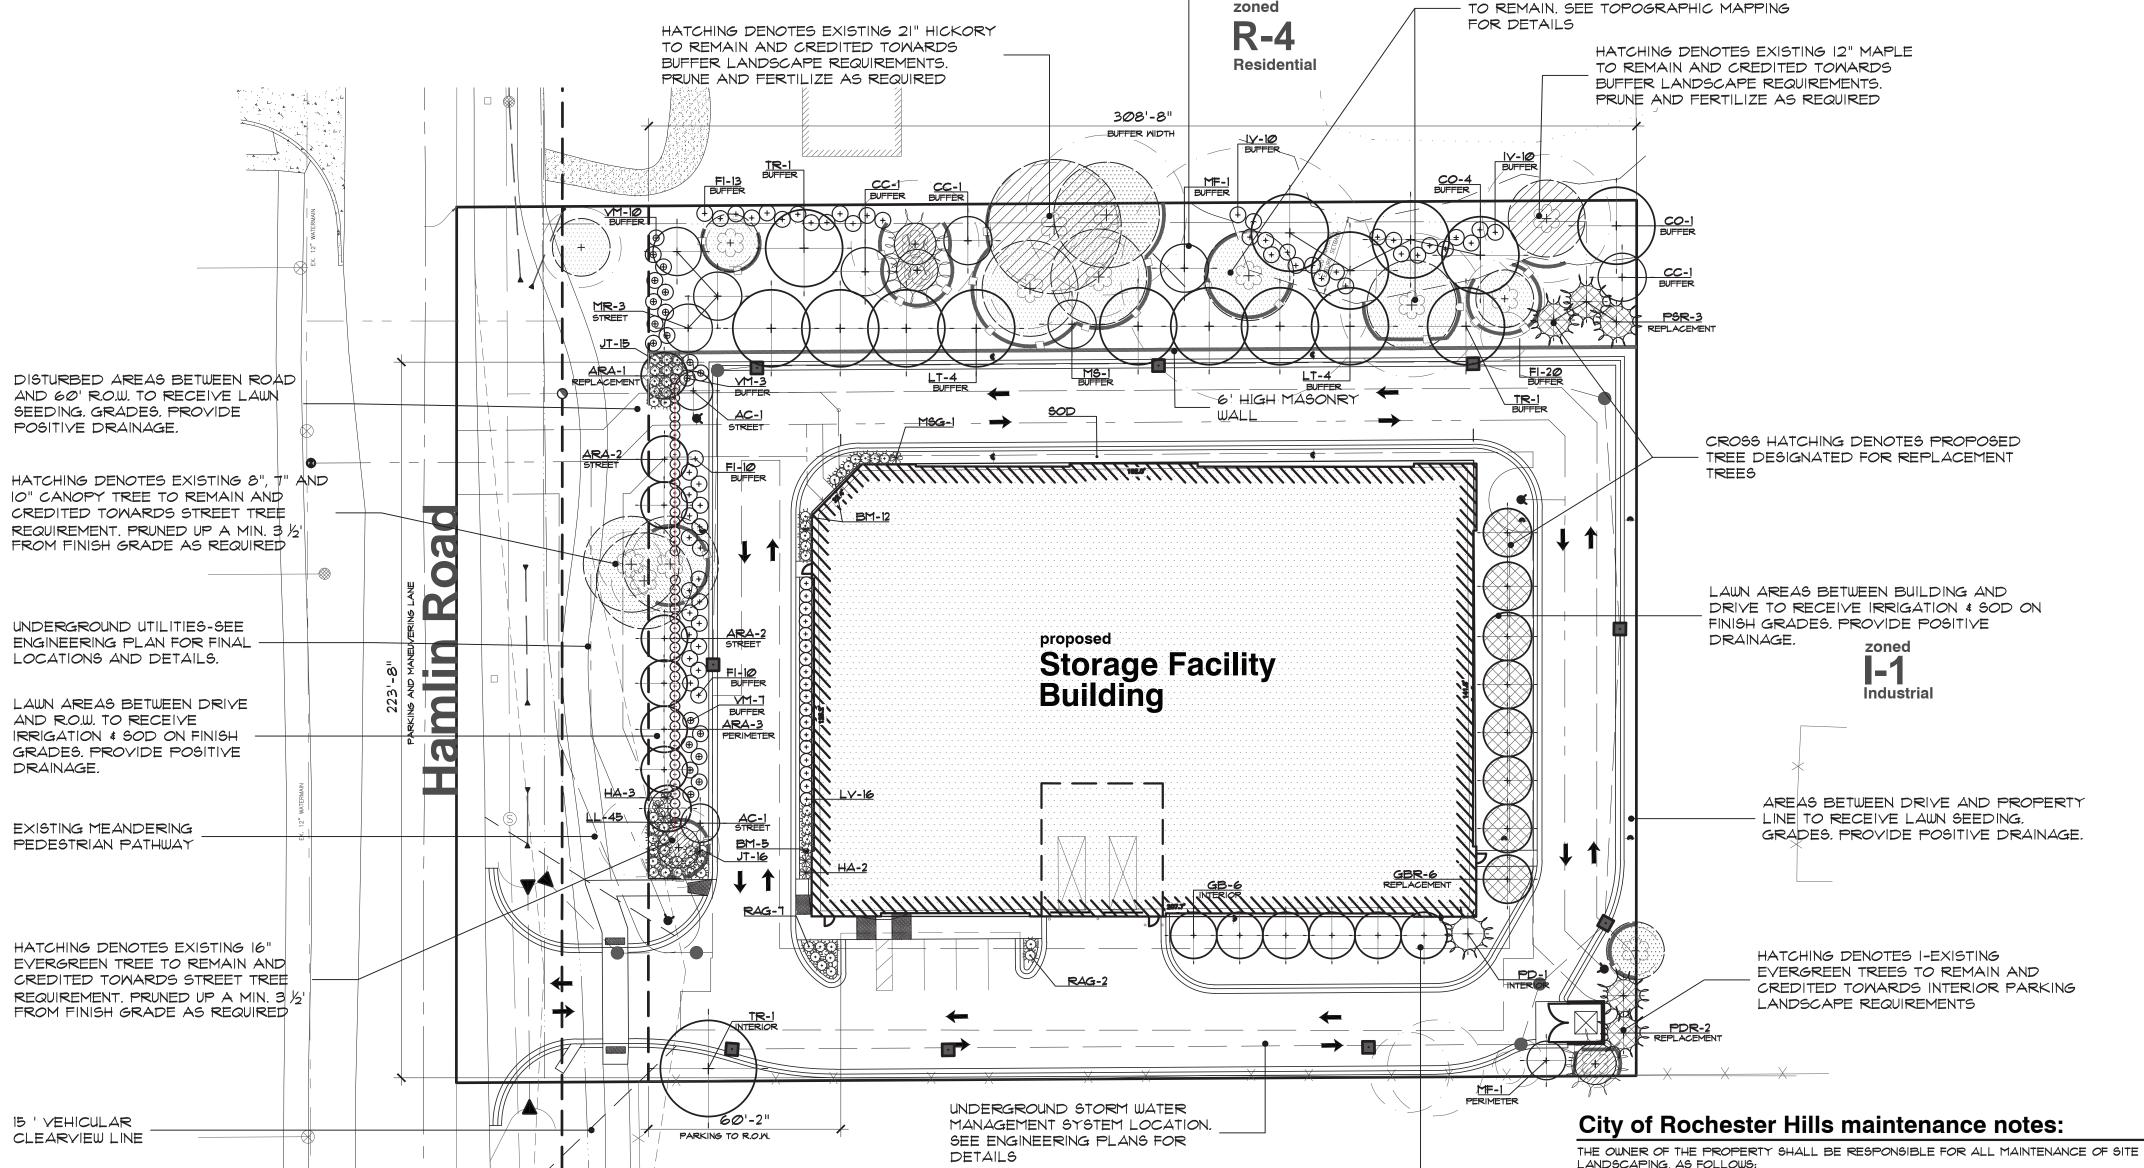

Industria

perimeter landscape

TOTAL LIN.FT. PARKING & MANEUVERING LANE

REQUIRED | PROVIDED

AREAS BETWEEN WALL AND PROPERTY

GRADES. PROVIDE POSITIVE DRAINAGE.

LINE TO RECEIVE LAWN SEEDING.

#### landscape requirement summary

**street tree** (Hamlin Road)

ri oot ti oo (namiin koad)		
TOTAL LIN.FT. OF HAMLIN ROAD FRONTAGE2	13' <u>+</u>	
(273' HAMLIN ROAD FRONTAGE LESS 30' ACCESS DRIVE= 243')		4-EXISTING
ONE (I) CANOPY OR EVERGREEN TREE PER 35'	8	+ 4-NEW
(243' / 35' PER TREE= 6.9 TREES)		
ONE (I) ORNAMENTAL TREE PER 60'	5	5
(243' / 60' PER TREE= 4.05 TREES)		
<b>Duffer</b> (west property line * residential R-4 * type-E with wall)	REQUIRED	PROVIDED
FOTAL LIN.FT. OF WEST PROPERY LINE 30	ට8' <u>+</u>	2-EXISTING
TWO&HALF (2.5) CANOPY TREES PER 100'	_	+ 6-NEW
(308' / 100'=3.08 × 2.5 TREES= 7.7 TREES)		
SIX (6) EVERGREEN TREES PER 100'		"A"
(308' / 100'=3.08 × 6-TREES= 18.48 TREES)		
ONE & HALF (1.5) ORNAMENTAL TREE PER 100'	5	5
	_	
(308' / 100'=3.08 X 1.5-TREES= 4.62 TREES)		
(308' / 100'=3.08 X 1.5-TREES= 4.62 TREES) TEN (10) SHRUB PER 100'	31	39
TEN (10) SHRUB PER 100'	EN TREES ARE	REQUIRED.
TEN (10) SHRUB PER 100'(308' / 100'=3.08 X 10-SHRUBS= 30.8 SHRUBS)	EN TREES ARE LL BE PROVID EVERGREEN TE REQUIRED	REQUIRED. DED AT THE REE THAT
TEN (IO) SHRUB PER IOO' (306' / IOO'=3.06 X IO-SHRUBS= 30.6 SHRUBS)  "A" WHERE A MASONRY WALL IS PROPOSED, NO EVERGRE INSTEAD, ADDITIONAL DECIDUOUS TREES AND SHRUBS SHA RATE OF Ø.5 DECIDUOUS TREES AND 2 SHRUBS FOR EACH I WOULD OTHERWISE BE REQUIRED IN THE BUFFER YARD.  NO. OF CANOPY TREES (O.5 TREE PER EVERGREEN TREE )	EN TREES ARE LL BE PROVID EVERGREEN TE REQUIRED 9	REQUIRED. DED AT THE REE THAT
TEN (IO) SHRUB PER IOO'  (306' / IOO'=3.06 X IO-SHRUBS= 30.6 SHRUBS)  "A" WHERE A MASONRY WALL IS PROPOSED, NO EYERGRE INSTEAD, ADDITIONAL DECIDUOUS TREES AND SHRUBS SHA RATE OF 0.5 DECIDUOUS TREES AND 2 SHRUBS FOR EACH WOULD OTHERWISE BE REQUIRED IN THE BUFFER YARD.  NO. OF CANOPY TREES (0.5 TREE PER EYERGREEN TREE )  (19-EYERGREENS LESS 2 EX. EYERGREENS=17-EYERGREENS X.5	EN TREES ARE LL BE PROVID EVERGREEN TR REQUIRED 9 = 8.5 TREES)	REQUIRED. DED AT THE REE THAT PROVIDED 9
TEN (IO) SHRUB PER IOO'  (308' / IOO'=3.08 X IO-SHRUBS= 30.8 SHRUBS)  "A" WHERE A MASONRY WALL IS PROPOSED, NO EVERGRE INSTEAD, ADDITIONAL DECIDUOUS TREES AND SHRUBS SHA RATE OF 0.5 DECIDUOUS TREES AND 2 SHRUBS FOR EACH WOULD OTHERWISE BE REQUIRED IN THE BUFFER YARD.  NO. OF CANOPY TREES (0.5 TREE PER EVERGREEN TREE )  (19-EVERGREENS LESS 2 EX. EVERGREENS=17-EVERGREENS X .5 NO. OF SHRUBS (2 SHRUBS PER EVERGREEN TREE )	EN TREES ARE LL BE PROVID EVERGREEN TR REQUIRED 9 = 8.5 TREES) 34	REQUIRED. DED AT THE REE THAT
TEN (IO) SHRUB PER IOO' (306' / IOO'=3.06 X IO-SHRUBS= 30.6 SHRUBS)  "A" WHERE A MASONRY WALL IS PROPOSED, NO EVERGRE INSTEAD, ADDITIONAL DECIDUOUS TREES AND SHRUBS SHA RATE OF Ø.5 DECIDUOUS TREES AND 2 SHRUBS FOR EACH I WOULD OTHERWISE BE REQUIRED IN THE BUFFER YARD.  NO. OF CANOPY TREES (0.5 TREE PER EVERGREEN TREE ) (19-EVERGREENS LESS 2 EX. EVERGREENS=17-EVERGREENS X .5  NO. OF SHRUBS (2 SHRUBS PER EVERGREEN TREE ) (19 EVERGREENS- 2-EX. EVERGREENS = 17-EVERGREENS X 2 =34	EN TREES ARE LL BE PROVID EVERGREEN TR REQUIRED 9 = 8.5 TREES) 34	REQUIRED. DED AT THE REE THAT PROVIDED 9
TEN (IO) SHRUB PER IOO'  (308' / IOO'=3.08 X IO-SHRUBS= 30.8 SHRUBS)  "A" WHERE A MASONRY WALL IS PROPOSED, NO EVERGRE INSTEAD, ADDITIONAL DECIDUOUS TREES AND SHRUBS SHA RATE OF 0.5 DECIDUOUS TREES AND 2 SHRUBS FOR EACH WOULD OTHERWISE BE REQUIRED IN THE BUFFER YARD.  NO. OF CANOPY TREES (0.5 TREE PER EVERGREEN TREE )  (19-EVERGREENS LESS 2 EX. EVERGREENS=17-EVERGREENS X .5 NO. OF SHRUBS (2 SHRUBS PER EVERGREEN TREE )	EN TREES ARE LL BE PROVID EVERGREEN TR REQUIRED 9 = 8.5 TREES) 34	REQUIRED. DED AT THE REE THAT PROVIDED 9
TEN (IO) SHRUB PER IOO'  (308' / IOO'=3.08 X IO-SHRUBS= 30.8 SHRUBS)  "A" WHERE A MASONRY WALL IS PROPOSED, NO EVERGRE INSTEAD, ADDITIONAL DECIDUOUS TREES AND SHRUBS SHA RATE OF 0.5 DECIDUOUS TREES AND 2 SHRUBS FOR EACH WOULD OTHERWISE BE REQUIRED IN THE BUFFER YARD.  NO. OF CANOPY TREES (0.5 TREE PER EVERGREEN TREE)  (19-EVERGREENS LESS 2 EX. EVERGREENS=17-EVERGREENS X .5  NO. OF SHRUBS (2 SHRUBS PER EVERGREEN TREE)  (19 EVERGREENS- 2-EX. EVERGREENS = 17-EVERGREENS X 2 = 34  DARKING IOT LANDSCAPE	EN TREES ARE LL BE PROVID EVERGREEN TO REQUIRED 9 = 8.5 TREES) 34 SHRUBS)	REQUIRED. DED AT THE REE THAT PROVIDED 9
TEN (IO) SHRUB PER IOO'  (306' / IOO'=3.06 X IO-SHRUBS= 30.6 SHRUBS)  "A" WHERE A MASONRY WALL IS PROPOSED, NO EVERGRE INSTEAD, ADDITIONAL DECIDUOUS TREES AND SHRUBS SHA RATE OF 0.5 DECIDUOUS TREES AND 2 SHRUBS FOR EACH I WOULD OTHERWISE BE REQUIRED IN THE BUFFER YARD.  NO. OF CANOPY TREES (0.5 TREE PER EVERGREEN TREE )  (19-EVERGREENS LESS 2 EX. EVERGREENS=IT-EVERGREENS X .5  NO. OF SHRUBS (2 SHRUBS PER EVERGREEN TREE )  (19 EVERGREENS- 2-EX. EVERGREENS = IT-EVERGREENS X 2 = 34  DARKING IOTAL AREA OF VEHICULAR USE  26,148± SG	EN TREES ARE LL BE PROVID EVERGREEN TR REQUIRED 9 = 8.5 TREES) 34 SHRUBS) REQUIRED	REQUIRED. DED AT THE REE THAT PROVIDED 9 34
TEN (IO) SHRUB PER IOO' (308' / IOO'=3.08 X IO-SHRUBS= 30.8 SHRUBS)  "A" WHERE A MASONRY WALL IS PROPOSED, NO EVERGRE INSTEAD, ADDITIONAL DECIDUOUS TREES AND SHRUBS SHA RATE OF 0.5 DECIDUOUS TREES AND 2 SHRUBS FOR EACH I WOULD OTHERWISE BE REQUIRED IN THE BUFFER YARD.  NO. OF CANOPY TREES (0.5 TREE PER EVERGREEN TREE ) (19-EVERGREENS LESS 2 EX. EVERGREENS=17-EVERGREENS X .5 NO. OF SHRUBS (2 SHRUBS PER EVERGREEN TREE ) (19 EVERGREENS- 2-EX. EVERGREENS = 17-EVERGREENS X 2 = 34  DARKING Iot landscape  TOTAL AREA OF VEHICULAR USE (PARKING AND CIRCULATION)	EN TREES ARE LL BE PROVID EVERGREEN TE REQUIRED 9 = 8.5 TREES) 34 SHRUBS)  REQUIRED	REQUIRED. DED AT THE REE THAT PROVIDED 9 34 PROVIDED
TEN (IO) SHRUB PER IOO' (306' / IOO'=3.06 X IO-SHRUBS= 30.6 SHRUBS)  "A" WHERE A MASONRY WALL IS PROPOSED, NO EVERGRE INSTEAD, ADDITIONAL DECIDUOUS TREES AND SHRUBS SHARATE OF 0.5 DECIDUOUS TREES AND 2 SHRUBS FOR EACH WOULD OTHERWISE BE REQUIRED IN THE BUFFER YARD.  NO. OF CANOPY TREES (0.5 TREE PER EVERGREEN TREE ) (19-EVERGREENS LESS 2 EX. EVERGREENS=17-EVERGREENS X .5 NO. OF SHRUBS (2 SHRUBS PER EVERGREEN TREE ) (19 EVERGREENS- 2-EX. EVERGREENS = 17-EVERGREENS X 2 = 34 DARKING IOT LANDSCAPE  TOTAL AREA OF VEHICULAR USE (PARKING AND CIRCULATION) INTERIOR LANDSCAPE AREA	EN TREES ARE LL BE PROVID EVERGREEN TE REQUIRED 9 = 8.5 TREES) 34 SHRUBS)  REQUIRED R.FT. 1,307 SQ.FT.	REQUIRED. DED AT THE REE THAT PROVIDED 9 34 PROVIDED
TEN (IO) SHRUB PER IOO' (308' / IOO'=3.08 X IO-SHRUBS= 30.8 SHRUBS)  "A" WHERE A MASONRY WALL IS PROPOSED, NO EVERGRE INSTEAD, ADDITIONAL DECIDUOUS TREES AND SHRUBS SHA RATE OF 0.5 DECIDUOUS TREES AND 2 SHRUBS FOR EACH I WOULD OTHERWISE BE REQUIRED IN THE BUFFER YARD.  NO. OF CANOPY TREES (0.5 TREE PER EVERGREEN TREE ) (19-EVERGREENS LESS 2 EX. EVERGREENS=17-EVERGREENS X .5 NO. OF SHRUBS (2 SHRUBS PER EVERGREEN TREE ) (19 EVERGREENS- 2-EX. EVERGREENS = 17-EVERGREENS X 2 = 34  DARKING Iot landscape  TOTAL AREA OF VEHICULAR USE (PARKING AND CIRCULATION)	EN TREES ARE LL BE PROVID EVERGREEN TE REQUIRED 9 = 8.5 TREES) 34 SHRUBS)  REQUIRED R.FT. 1,307 SQ.FT.	REQUIRED. DED AT THE REE THAT PROVIDED 9 34 PROVIDED

ONE (I) CANOPY TREE PER 25' (224' / 25' PER TREE= 8.96 TREES)	9	4 ("A")
ONE (I) ORNAMENTAL TREE PER 35'	7	l ("A")
(224' / 35' PER TREE= 6.4TREES)	40	90
ONE (1) SHRUBS PER 2.5'	90	90
("A") WAIVER REQUESTED DUE TO LIMITED LANDSCAF AND PUBLIC UTILITY EASEMENT RESTRICTIONS	E AREAS	
<b>.</b>		72
<b>-</b>	7	72
<del></del>	7	72 18
TOTAL NO. OF EXISTING 6" DBH TREES SURVEY ON SITE  NO. OF TREES LOCATED WITHIN BLDG. ENVELOP  NO. OF TREES LOCATED OUTSIDE BLDG. ENVELOP  4  NO. OF EXISTING TREE PRESERVATION REQUIRED	7 5	I8

REQUIRED | PROVIDED

224'<u>+</u>

LAWN AREAS BETWEEN BUILDING AND DRIVE

TO RECEIVE IRRIGATION & SOD ON FINISH

GRADES. PROVIDE POSITIVE DRAINAGE.

NO. OF EXISTING TREES PRESERVATION PROVIDED (SAVED)		18 (40%)
TOTAL EXISTING TREES REMOVED		52
NO. OF REGULATED EXISTING TREES REMOVED	49	
NO. OF SPECIMEN TREES REMOVED	3 (2-14" AF	PLE\$20" WALNUT)
	REQUIRED	PROVIDED
NO. OF REGULATED TREE REPLACEMENT	49	I + 48 TO CITY TREE FUND
NO. OF SPECIMEN TREE REPLACEMENT		12

(50% CALIPER INCHES REMOVED = 48" X .50 = 24" / 2" = 12-TREES)

THE OWNER OF THE PROPERTY SHALL BE RESPONSIBLE FOR ALL MAINTENANCE OF SITE LANDSCAPING, AS FOLLOWS:

A. LANDSCAPING SHALL BE KEPT IN A NEAT, ORDERLY AND HEALTHY GROWING CONDITION FREE FROM DEBRIS AND REFUSE.

B. PRUNING SHALL BE MINIMAL AT THE TIME OF INSTALLATION, ONLY TO REMOVE DEAD OR DISEASED BRANCHES. SUBSEQUENT PRUNING SHALL ASSURE PROPER MATURATION OF PLANTS TO ACHIEVE THEIR APPROVED PURPOSE.

C. ALL DEAD, DAMAGED, OR DISEASED PLANT MATERIAL SHALL BE REMOVED IMMEDIATELY AND REPLACED WITHIN SIX (6) MONTHS AFTER IT DIES OR IN THE NEXT PLANTING SEASON, WHICHEVER OCCURS FIRST. FOR PURPOSES OF THIS SECTION, THE PLANTING SEASON FOR DECIDUOUS PLANTS SHALL BE BETWEEN MARCH I AND JUNE I AND FROM OCTOBER I UNTIL THE PREPARED SOIL BECOMES FROZEN. THE PLANTING SEASON FOR EVERGREEN PLANTS SHALL BE BETWEEN MARCH I AND JUNE I. PLANT MATERIAL INSTALLED TO REPLACE DEAD OR DISEASED MATERIAL SHALL BE AS CLOSE AS PRACTICAL TO THE SIZE OF THE MATERIAL IT IS INTENDED TO REPLACE. THE CITY MAY NOTIFY PROPERTY OWNERS OF THE NEED TO REPLACE DEAD, DAMAGED, OR DISEASED MATERIAL.

D. THE APPROVED LANDSCAPE PLAN SHALL BE CONSIDERED A PERMANENT RECORD AND INTEGRAL PART OF THE SITE PLAN APPROVAL. UNLESS OTHERWISE APPROVED IN ACCORDANCE WITH THE AFOREMENTIONED PROCEDURES, ANY REVISIONS TO OR REMOVAL OF PLANT MATERIALS, OR NON-COMPLIANCE WITH THE MAINTENANCE REQUIREMENTS OF THIS SECTION 138-12.109 WILL PLACE THE PARCEL IN NON-CONFORMITY WITH THE APPROVED LANDSCAPE PLAN AND BE A VIOLATION OF THIS ORDINANCE.

E. IF PROTECTED TREES ARE DAMAGED, A FINE SHALL BE ISSUED ON AN INCH-BY-INCH BASIS AT A MONETARY RATE AS DEFINED BY THE FORESTRY DEPARTMENT.

### **City of Rochester Hills notes:**

SHADE PATTERN DENOTES EXISTING TREE

1. PRIOR APPROVAL IS REQUIRED TO PLANT ANY TREE OR SHRUB ON THE PUBLIC RIGHT-OF-WAY.
2. ALL TREES AND SHRUBS MUST BE PLANTED AT LEAST 10' FROM THE EDGE OF THE PUBLIC ROAD. (TREES MUST BE PLANTED AT LEAST 15' AWAY FROM CURB OR ROAD EDGE WHERE THE SPEED LIMIT IS MORE THAN 35 MPH.)

ROAD EDGE WHERE THE SPEED LIMIT IS MORE THAN 35 MPH.)

3. SHADE TREES AND SHRUBS MUST BE PLANTED AT LEAST 5'FROM THE EDGE OF THE PUBLIC WALKWAY. EVERGREEN AND ORNAMENTAL TREES MUST BE PLANTED AT LEAST 10'FROM THE EDGE OF THE PUBLIC WALKWAY.

4. NO TREES OR SHRUBS MAY BE PLANTED WITHIN THE TRIANGULAR AREA FORMED AT THE INTERSECTION OF ANY STREET RIGHT-OF-WAY LINES AT A DISTANCE ALONG EACH LINE OF 25'FROM THEIR POINT OF INTERSECTION.

5. NO TREES OR SHRUBS MAY BE PLANTED IN THE TRIANGULAR AREA FORMED AT THE INTERSECTION OF ANY DRIVEWAY WITH A PUBLIC WALKWAY AT A DISTANCE ALONG EACH LINE OF 15'FROM THEIR POINT OF INTERSECTION.

6. ALL TREES AND SHRUBS MUST BE PLANTED AT LEAST 10'FROM ANY FIRE


6. ALL TREES AND SHRUBS MUST BE PLANTED AT LEAST 10' FROM ANY FIRE HYDRANT.

7. SHADE AND EVERGREEN TREES MUST BE AT LEAST 15' AWAY FROM THE

NEAREST OVERHEAD WIRE. TREES MUST BE PLANTED A MINIMUM OF 5'FROM AN UNDERGROUND UTILITY, UNLESS THE CITY'S LANDSCAPE ARCHITECT REQUIRES A GREATER DISTANCE. PRIOR TO THE RELEASE OF THE PERFORMANCE BOND, 8. THE CITY OF ROCHESTER HILLS FORESTRY UNIT NEEDS TO INSPECT ALL TREES, EXISTING OR PLANTED, TO IDENTIFY ANY THAT POSE A HAZARD TO THE SAFE USE OF THE PUBLIC RIGHT-OF-WAY. FORESTRY MAY REQUIRE THE DEVELOPER TO REMOVE, AND POSSIBLY REPLACE, ANY SUCH TREES. THE ABOVE REQUIREMENTS ARE INCORPORATED INTO THE PLAN.

9. IF PROTECTED TREES ARE DAMAGED, A FINE SHALL BE ISSUED ON AN INCH-BY-INCH BASIS AT A MONETARY RATE AS DEFINED BY THE FORESTRY DEPARTMENT.



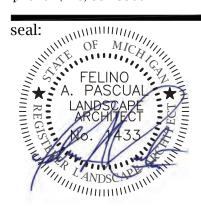

project sponsor

CDK DEVELOPMENT 10570 Savannah Ct Huntley, Illinois Contact: Steve Osborne Phone: 224-249-9447

1575 E Hamlin Road

project location:

City of Rochester Hills , Michigan

1575 E. Hamlin Road

sheet title:

LANDSCAPE PLAN

job no. / issue / revision date:

LS23.028.02 REVIEW 2-9-2023

LS23.028.02 SPA 2-9-2023

LS23.028.05 SPA 5-23-2023

LS23.028.06 SPA 6-29-2023

LS23.028.08 SPA 8-16-2023

LS23.028.09 SPA 9-18-2023

LS23.028.11 PC COMMENTS 11-15-2023

drawn by:

JP

checked by:

FP date:

7-1-2023

notice:
Copyright © 2023

This document and the subject matter contained therein is proprietary and is not to be used or reproduced without the written permission of Felino Pascual and Associates

Do Not scale drawings. Use figured dimensions only



The location and elevations of existing underground utilities as shown on this drawing are only approximate. no guarantee is either expressed or implied as to the completeness of accuracy. contractor shall be exclusively responsible for determining the exact location and elevation prior to the start of

project no: LS23.028.02

heet no:

#### nlant material list


key	quant. LS-1	botanical name	common name	size	comments
		REPLACEMENT TREES			
GBR	8	GINGKO BILOBA ('PNI 2720') 'PRINCETON SENTRY'	PRINCETON SENTRY MAIDENHAIR TREE	3" BB	МАТСН
PDR	2	PICEA GLAUCA 'DENSATA	BLACK HILL SPRUCE	8' BB	
PSR	3	PINUS STROBUS	EASTERN WHITE PINE	8' BB	
		LARGE AND SMALL DECIDUOUS TREES			
GB	6	GINGKO BILOBA ('PNI 2720') 'PRINCETON SENTRY'	PRINCETON SENTRY MAIDENHAIR TREE	3" BB	МАТСН
co	5	CELTIS OCCIDENTALIS	COMMON HACKBERRY	3" BB	
LT	8	LIRIODENDRON TULIPIFERA	TULIPTREE	3" BB	
TR	3	TILIA AMERICANA 'REDMOND'	REDMOND LINDEN	3" BB	
ARA	8	ACER R. 'ARMSTRONG'	ARMSTRONG RED MAPLE	3" BB	
cc	3	CERCIS CANADENSIS	EASTERN REDBUD	8' BB	MULTI-STEM
MF	2	MALUS FLORIBUNDA	JAPANESE FLOWERING CRABAPPLE	2" BB	
AC	2	AMECHANCIER CANADENSIS	AUTUMN BRILLIANCE SERVICEBERRY	8' BB	MULTI-STEM
MS	1	MALUS SNOWDRIFT	SNOWDRIFT CRABAPPLE	2" BB	
MR	3	MALUS RED VELVET	RED VELVET CRABAPPLE	2" BB	
PD	1	PICEA GLAUCA 'DENSATA	BLACK HILL SPRUCE	10' BB	
		DECIDUOUS AND EVERGREEN SHRUBS			
IV	20	CORNUS STOLONIFERA	MICHIGAN HOLLY	30" HIGH CONT	60" O.C. SPACIN
LY	16	LIGUSTRUM X. 'YICAYRII'	GOLDEN VICARY PRIVET	30" HIGH CONT	48" O.C. SPACINO
НД	5	HYDRANGEA ANNEBELLE	ANNABELLE HYDRANGEA	30" HIGH CONT	36" O.C. SPACIN
FI	33	FORSYTHIA X. INTERMEDIA	BORDER FORSYTHIA	30" HIGH CONT	60" O.C. SPACIN
JT	31	JUNIPERUS S. TAMARISCIFOLIA	TAMARIX JUNIPER	24" BB	60" O.C. SPACIN
M	20	VIBURNUM MOHAWK	MOHAWK VIBURNUM	6' BB	60" O.C. SPACIN
BM	17	BUXUS M. 'GREEN MOUNTAIN'	GREEN MOUNTAIN BOXWOOD	IS" BB	36" O.C. SPACINO
LL	45	LIGUSTRUM VULGAR 'LODENSE'	LODENSE PRIVET	30"HIGH CONT	48" O.C. SPACINO
RAG	9	RHUS AROMATIC 'GRO-LOW'	GRO-LOW FRAGRANT SUMAC	# 5 CONT	42" O.C. SPACING
		PERENNIALS AND GRASSES			
MSG	1	MISCANTHUS SINENSIS 'MORNING LIGHT'	MORNING LIGHT JAPANESE SILVER GRASS	*3 CONT.	42" O.C. SPACING

#### City of Rochester Hills landscape notes:

- A LANDSCAPE PLANTING SCHEDULE MUST BE PROVIDED INCLUDING THE SIZE OF ALL PURPOSED LANDSCAPING. A UNIT COST ESTIMATE AND LANDSCAPE COST SUMMARY, INCLUDING IRRIGATION COST, FOR THE LANDSCAPE BOND PURPOSES MUST BE PROVIDED
- 2. PRIOR TO THE RELEASE OF THE PERFORMANCE BOND, THE CITY OF ROCHESTER HILLS MUST INSPECT ALL LANDSCAPE PLANTING'S
- 3. ANY PLANT MATERIAL THAT IS DESIGNATED TO BE MAINTIANED THAT DIES OR DAMAGED DURING OR AS A RESULT OF CONSTRUCTION SHALL BE REPLACED IN KIND WITH LIKE SPECIES AND SIZE.
- 4. ALL LANDSCAPE AREAS MUST BE IRRIGATED. IRRIGATION PLAN TO BE SUBMITTED PRIOR TO STAFF APPROVAL OF FINAL SITE PLAN. A NOTE SPECIFYING THAT WATERING WILL ONLY OCCUR BETWEEN THE HOURS OF 12:00 AM AND 5:00 AM
- 5. ALL GROUND MOUNTED UTILITIES SHALL BE FULLY SCREENED FROM VIE 6. ALL LANDSCAPE AND GRASS AREAS, INCLUDING RIGHTS OF WAY SHALL

BE FULLY IRRIGATED


tree planting detail

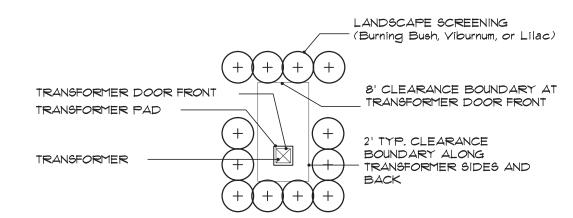

#### transformer pad planting detail

evergreen planting detail

A MINIMUM OF 2' SEPARATION BETWEEN TRANSFORMER AND FULL GROWN SHRUBS AND TREES. GROUND COVERS ALLOWED UP TO TRANSFORMER PAD IF MAINTAINED BELOW 4" FULL GROWTH. IF TRANSFORMER FACES TOWARDS THE HOUSE, THEN THE SAME CONDITIONS EXIST. NO FULL GROWTH IN FRONT OF THE TRANSFORMER FOR AT LEAST A MINIMUM OF 8'. THERE ARE NO WAIVERS GRANTED TO THE ABOVE CONDITION. DETAIL PER THE DETROIT EDISON COMPANY-SERVICE PLANNING

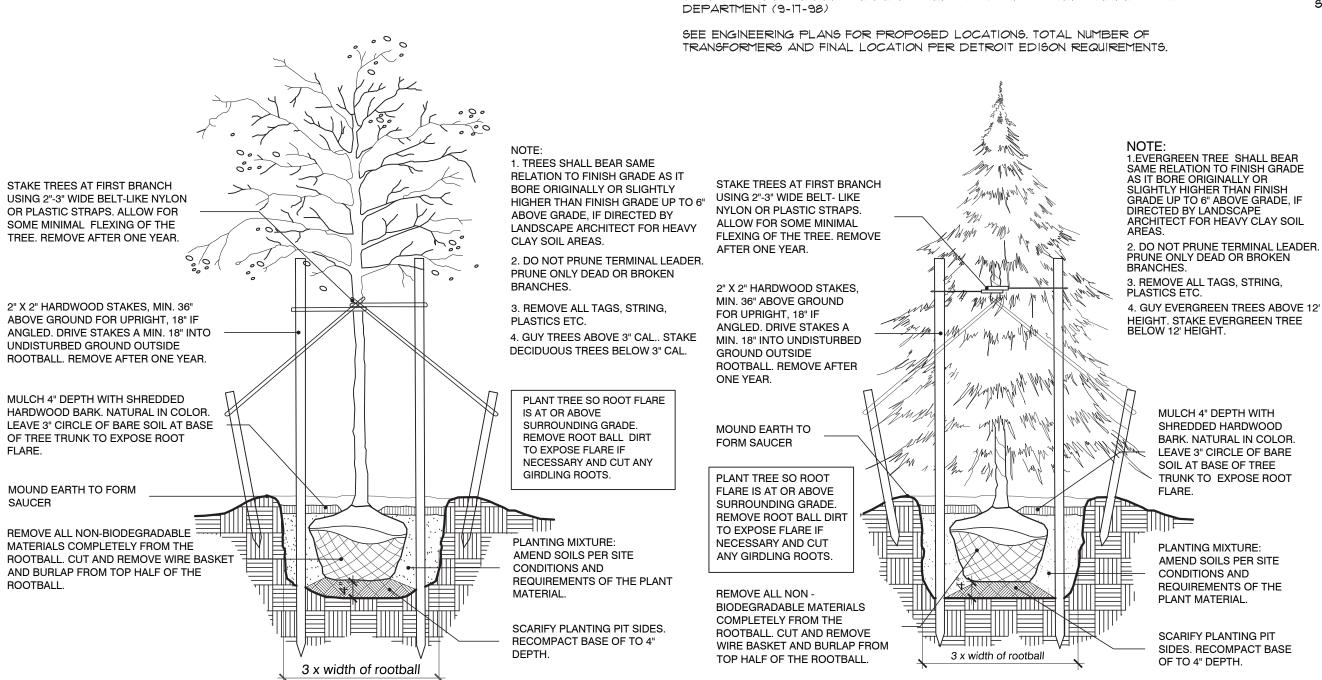

SEEDING ON FINISH GRADES. PROVIDE POSITIVE DRAINAGE. **Storage Facility** Building AREAS TO RECEIVE IRRGATION AND SOD ON FINISH GRADES, PROVIDE POSITIVE DRAINAGE AREAS TO RECEIVE IRRGATION AND SOD ON FINISH GRADES, PROVIDE AREAS TO RECEIVE POSITIVE DRAINAGE

#### planting landscape notes:

SCALE: |" = 40'-0"

1) PLANT MATERIALS TO BE INSTALLED ACCORDING TO THE CITY ROCHESTER AND CURRENT AMERICAN ASSOCIATION OF NURSERYMEN'S STANDARDS.

sod & seeding reference plan

2) PLANT MATERIALS TO BE GUARANTEED FOR 2 YEARS, REPLACE FALLING MATERIAL WITHIN I YEAR, OR THE NEXT APPROPRIATE PLANTING PERIOD.

AREAS TO RECEIVE IRRIGATION AND LAWN

- 3) PLANT MATERIALS TO BE OF PREMIUM QUALITY, NO. I GRADE NORTHERN
- 4) MULCH IS TO BE NATURAL COLORED, FINELY SHREDDED HARDWOOD BARK OF 4" THICK BARK MULCH FOR TREES IN 4' DIA. CIRCLE W/3" PULLED AWAY FROM TRUNK, 3" THICK BARK MULCH FOR SHRUBS AND 2" THICK BARK MULCH FOR PERRENIALS.

5) CALL MISS DIG AT 1-800-482-1171 PRIOR TO ANY CONSTRUCTION.

DECIDUOUS & EVERGREEN TREE:

- 1) TREE SHALL BE INSTALLED SAME RELATIONSHIP TO FINISH GRADE AS IT BORE ORIGINALLY OR SLIGHTLY HIGHER THAN FINISH GRADE UP TO 6" ABOVE GRADE, IF DIRECTED BY LANDSCAPE ARCHITECT FOR HEAVY CLAY 2) DO NOT PRUNE TERMINAL LEADER, PRUNE ONLY DEAD OR BROKEN
- 3) REMOVE ALL TAGS, STRING, PLASTICS AND OTHER MATERIALS THAT ARE UNSLIGHTLY AND COULD CAUSE GIRDLING.
- 4) REMOVE TREE STAKES, GUY WIRES AND TREE WRAP AFTER ONE WINTER 1) SHRUB SHALL BE INSTALLED SAME RELATIONSHIP TO FINISH GRADE AS IT
- BORE ORIGINALLY OR SLIGHTLY HIGHER THAN FINISH GRADE UP TO 4" ABOVE GRADE, IF DIRECTED BY LANDSCAPE ARCHITECT FOR HEAVY CLAY
- 2) DO NOT PRUNE TERMINAL LEADER PRUNE ONLY DEAD OR BROKEN BRANCHES. 3) REMOVE ALL TAGS, STRING, PLASTICS AND OTHER MATERIALS THAT ARE

- EITHER PLASTIC OR WOOD ORANGE SNOW FENCING SHALL BE INSTALLED AT OR BEYOND THE DRIPLINE, UNLESS MORE SUBSTANTIAL FENCING IS STAKES SHALL BE METAL 'T' POLES SPACED NO FURTHER THAN 5' ON
- FENCING SHALL NOT BE INSTALLED CLOSER TO THE TREE THAN THE DRIPLINE OF THOSE TREES TO BE SAVED. SPECIAL CIRCUMSTANCES SHALL BE REVIEWED BY THE CITY FENCING SHALL BE ERECTED PRIOR TO CONSTRUCTION. THE CITY SHALL BE
- NOTIFIED ONCE THE FENCING IS INSTALLED FOR INSPECTION. UNDER NO CIRCUMSTANCES SHALL THE PROTECTIVE FENCING BE REMOVED WITHOUT PROPER APPROVAL FROM THE CITY
- NO PERSON SHALL CONDUCT ANY ACTIVITY WITHIN THE AREAS PROPOSED TO REMAIN. THIS SHALL INCLUDE, BUT NOT LIMITED TO:
- a. NO SOLVENTS OR CHEMICALS WITHIN THE PROTECTED AREAS. b. NO BUILDING MATERIALS OR CONSTRUCTION EQUIPTMENT WITHIN THE
- PROTECTED AREAS. c. NO GRADE CHANGES, INCLUDING FILL, WITHIN THE PROTECTED AREAS. d.NO REMOVAL OF VEGETATION FROM THE GROUND UP WITHOUT PERMISSION
- FROM THE PROPER REVIEWING AUTHORITY, INCLUDING THE WOODLANDS e. ANY REQUIRED SWALE NEEDS TO BE DIRECTED AROUND THE PROTECTED AREAS. IN INSTANCES WHERE SWALES ARE APPROVED THRU A PROTECTED

AREA, THE SWALES NEED TO BE HAND DUG. MACHINERY OF ANY KIND IS

REGULATED WOODLANDS OR REGULATED TREES ADJACENT ADJACENT TO THE PROPERTY ARE ALSO REQUIRED TO BE PROTECTED WHETHER OR NOT THEY ARE SHOWN ON THE PLAN.

#### hatch pattern key

AREAS TO RECEIVE IRRIGATION AND SOD, MAINTAINED AND MOWED WEEKLY

AREAS TO RECEIVE LAWN SEEDING AND IRRIGATION

PVVVVVV EDGE SEED MIX

AREAS TO RECEIVE WETLAND

#### lawn area:

SOD LAWN AREAS SHALL BE KENTUCKY BLUE GRASS BLEND GRASS IN A SOD NURSERY ON LOAM SOIL, SOD TO BE INSTALLED ON MINIMUM 4" TOPSOIL. SEEDED LAWN AREAS SHALL CONSIST OF THE FOLLOWING TYPES AND PROPORTIONS:

> 5% PERENNIAL RYE GRASS 10% RED FESCUE 25% CHEWING FESCUE 60% KENTUCKY BLUE GRASS

SEED MIX SHALL BE APPLIED AT A RATE OF 200 POUNDS PER ACRE AND WEED CONTENT SHALL NOT EXCEED 1%, SEED. PROVIDE A MINIMUM 4" TOP SOIL ON ALL

#### wetland edge seed mix.

wettand edge s		
SPECIES	COMMON NAME	RATE (LBS./AC
ALISMA SUBCORDATUM	COMMON WATER PLANTAIN	0.375
ASCLEPIAS INCARNATA	SWAMP MILKWEED	0.062
ASTER NOVA-ANGLIAE	NEW ENGLAND ASTER	0.062
ASTER SIMPLEX	PANICLED ASTER	0.031
BIDENS CERNUA	NODDING BUR MARIGOLD	0.312
BIDENS FRONDOSA	COMMON BEGGAR'S TICK	0.125
BOLTONIA LATISQUAMA	FALSE ASTER	0.188
CAREX BEBBII	BEBB'S SEDGE	0.125
CAREX COMOSA	BOTTLEBRUSH GRASS	0.125
CAREX LUPULINA C	OMMON HOP SEDGE	0.062
CAREX STIPATA	AWL-FRUITED SEDGE	0.125
CAREX SCOPARIA	POINTED BROOM SEDGE	0.125
CAREX VULPINOIDEA	FOX SEDGE	0.500
ELEOCHARIS SPECIES	SPIKE RUSH SPECIES	0.062
ELYMUS VIRGINICUS	VIRGINIA WILD RYE	1.500
EUPATORIUM MACULATUM	SPOTTED JOE PYE WEED	0.125
GLYCERIA STRIATA	FOWL MANNA GRASS	0.125
HELENIUM AUTUMNALE	SNEEZEWEED	0.250
IRIS VIRGINICA	SOUTHERN BLUE FLAG	0.188
JUNCUS SPECIES	RUSH SPECIES	0.062
LEERSIA ORYZOIDES	RICE CUT GRASS	0.188
LUDWIGIA POLYCARPA	FALSE LOOSESTRIFE	0.001
MIMULUS RINGENS	MONKEYFLOWER	0.031
ONOCLEA SENSIBILIS	SENSITIVE FERN	0.031
PENTHORUM SEDOIDES	DITCH STONECROP	0.001
POLYGONUM HYDROPIPERO	IDES MILD WATER PEPPER	0.750
RUDBECKIA LACINIATA	GREEN CONEFLOWER	0.125
SAGITTARIA LATIFOLIA	DUCK POTATO	0.062
SCIRPUS ATROVIRENS	DARK GREEN RUSH	1.250
SCIRPUS FLUVIATILIS	RIVER BULRUSH	0.125
SCIRPUS PENDULUS	RED BULRUSH	0.031
SCIRPUS VALIDUS	SOFT STEM BULRUSH	0.031
SPARGANIUM EURYCARPUM		0.062
VERONONIA FASCICULATA	COMMON IRONWEED	0.062
VERBENA HASTATA	BLUE VERVAIN	0.125
	TOTA	
COVER CROP		
AVENA SATIVA	SEED OATS 20.0	
	<u> </u>	

LOLIUM MULTIFLORUM

IRRIGATION AND LAWN

SEEDING ON FINISH

GRADES. PROVIDE POSITIVE DRAINAGE

> SEED MIX TO BE BROADCAST OVER WETLAND RESTORATION AREA. THIS IS GENESIS NURSERY'S SEDGE GHETTO--THE NEXT GENERATION SEED MIX MODIFIED FOR USE IN MICHIGAN.

**ANNUAL RYE 5.0** 



24333 Orchard Lake Rd, Suite G Farmington Hills, Michigan 48336 phone: (248) 557-5588

project sponsort:

**CDK DEVELOPMENT** 10570 Savannah Ct Huntley, Illinois Contact: Steve Osborne

Phone: 224-249-9447

1575 E Hamlin Road

project location:

City of Rochester Hills , Michigan

1575 E. Hamlin Road

sheet title:

PLANTING DETAILS AND LANDSCAPE **NOTES** 

job no. / issue / revision date: LS23.028.02 REVIEW 2-9-2023 LS23.028.02 SPA 2-9-2023

LS23.028.05 SPA 5-23-2023 LS23.028.06 SPA 6-29-2023 LS23.028.08 SPA 8-16-2023 LS23.028.09 SPA 9-18-2023 LS23.028.11 PC COMMENTS 11-15-2023

checked by:

2-1-2023


notice: Copyright This document and the subject matter contained therein is proprietary and is not to be used or reproduced without the written permission of Felino Pascual and Associates


Do Not scale drawings. Use figured dimensions only

BEFORE YOU DIG ╱1-800-482-717

For free location of public utility lines existing underground utilities as shown on this drawing are only approximate. no guarantee is either expressed or implied as to the ompleteness of accuracy. contractor shall be exclusively responsible for determining the exact location and elevation prior to the start of

project no: LS23.028.02

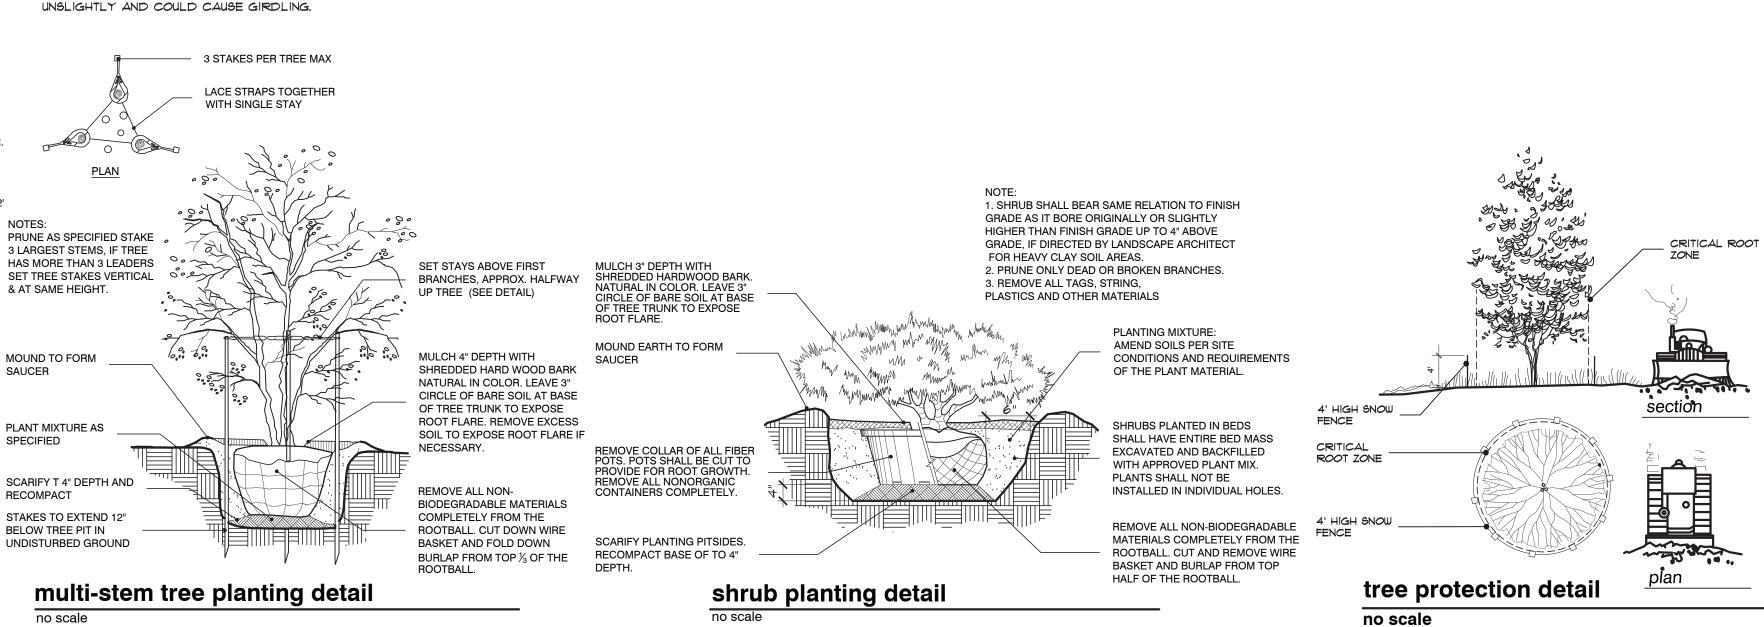

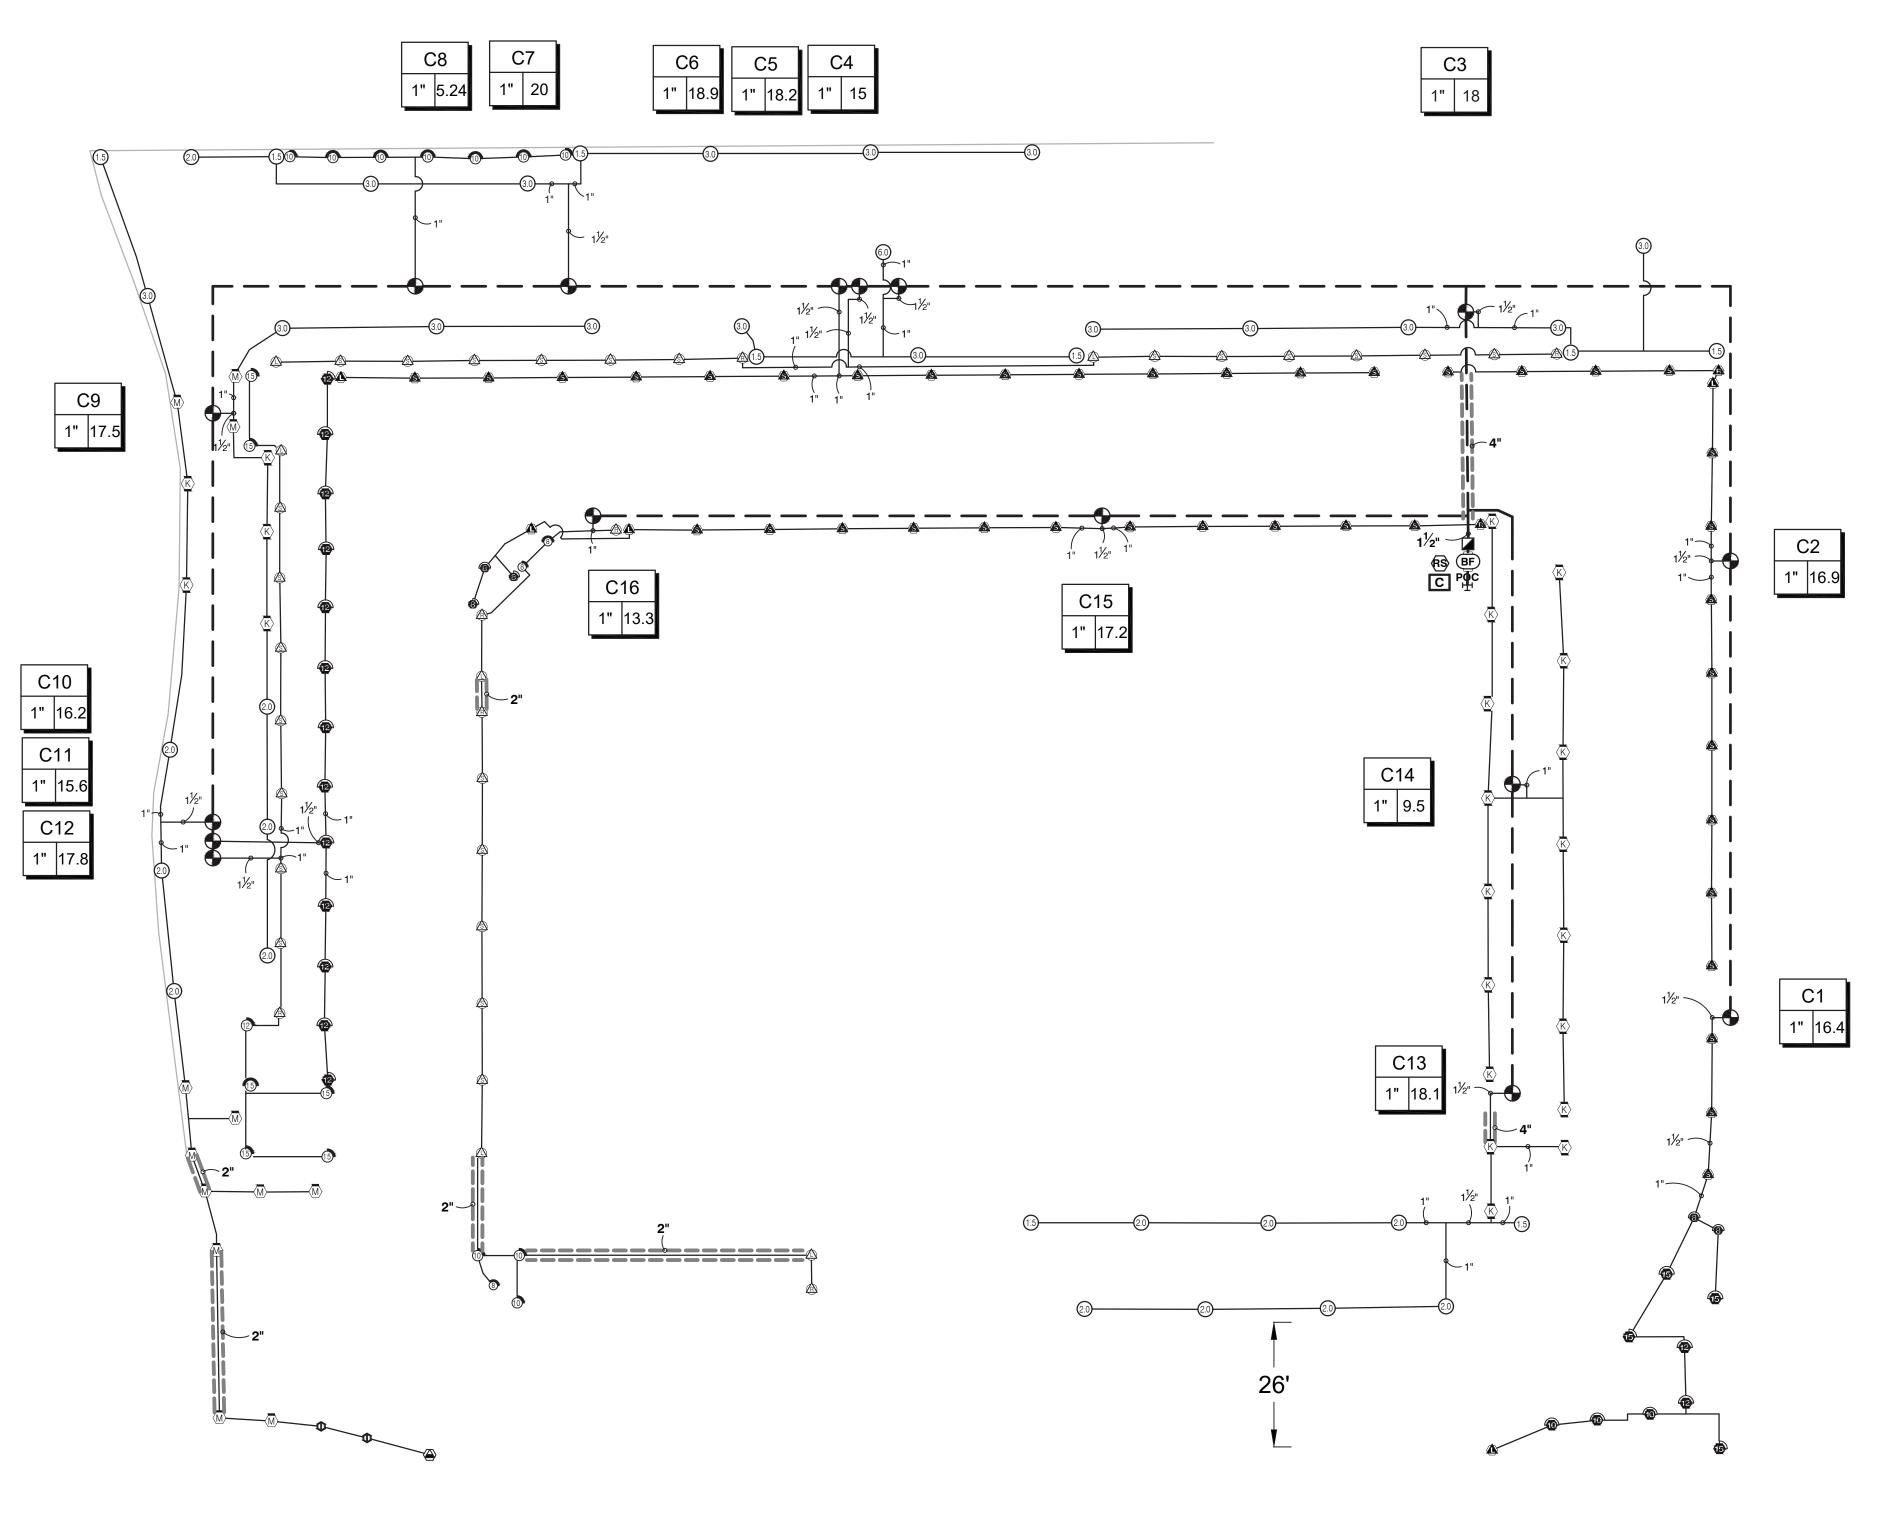


#### IDDIOATION COLIEDIUE

IRRIGATION SCHEDULE				
SYMBOL	MANUFACTURER/MODEL	QTY		
ES LCS RCS CS SS	Hunter PROS-04 5` strip spray	47		
<ul><li></li></ul>	Hunter PROS-04 8` radius	5		
(a) (b) (c) (c) (c) (c) (c) (c) (c) (c) (c) (c	Hunter PROS-04 10` radius	3		
	Hunter PROS-04 12` radius	15		
(a) (b) (a) (a) (b) (c) (d) (d) (d) (d) (d) (d) (d) (d) (d) (d	Hunter PROS-04 15` radius	4		
ES LCS RCS CS SS	Hunter PROS-12 5` strip spray	37		
8 8 8 8 Q T H F	Hunter PROS-12 8` radius	3		
(1) (1) (1) (1) (1) (1) (1) (1) (1) (1)	Hunter PROS-12 10` radius	10		
@ @ @ @ @ @ Q T H TT TQ F	Hunter PROS-12 12` radius	1		
(5) (5) (5) (5) (5) (6) (7) (7) (7) (7) (7) (7) (7) (7) (7) (7	Hunter PROS-12 15` radius	6		
LST RST SST	Hunter MP Strip PROS-04-PRS40-CV	1		
$\bigcirc \bigcirc \bigcirc$	Hunter MP1000 PROS-04-PRS40-CV	12		
$\langle K \rangle \langle G \rangle \langle R \rangle$	Hunter MP2000 PROS-04-PRS40-CV	22		
<b>D D ADJ.</b> 360	Hunter MP800SR PROS-04-PRS40-CV	2		
SYMBOL	MANUFACTURER/MODEL	<u>QTY</u>		
(1.5)	Hunter PGP-04 1.5	9		
2.0	Hunter PGP-04 2.0	14		
3.0	Hunter PGP-04 3.0	16		
60	Hunter PGP-04 6.0	1		
SYMBOL	MANUFACTURER/MODEL	QTY		
•	Hunter PGV-101G 1"	16		
	Hunter HQ-44RC 1"	1		
BF	Febco 765 1"	1		
C	Hunter I2C-1600-PL	1		
(RS)	Hunter WR-CLIK	1		
POC T	POC 1"	1		
	Irrigation Lateral Line: Polyethylene Pipe 100 PSI 1"	3,259		
	Irrigation Lateral Line: Polyethylene Pipe 100 PSI 1 1/2"	209.7		
	Irrigation Mainline: PVC Class 160 SDR 26 1 1/2"	961.8		
	Pipe Sleeve: PVC Class 160 SDR 26 2"	123.8		
	Pipe Sleeve: PVC Class 160 SDR 26 4"	36.2 l.		
	Valve Callout			

#### IRRIGATION SPECIFICATIONS

- 1. IRRIGATION SYSTEM DESIGN BASED ON 20 GPM AT 57 PSI.
- 2. IRRIGATION DESIGN IS FROM THE POINT OF CONNECTION(POC)ONLY. THE DESIGN IS BASED ON GALLONS PER MINUTE(GPM)AND POUNDS PER SQUARE INCH(PSI)FURNISHED BY OTHERS.
- 3. IRRIGATION CONTRACTOR IS TO VERIFY POINT OF CONNECTION IN THE FIELD. INSTALLER IS TO CONFIRM THE MINIMUM DISCHARGE REQUIREMENTS OF THE POINT OF CONNECTION AS INDICATED ON THE LEGEND PRIOR TO INSTALLATION.
- 4. THE PRESSURE REQUIREMENT AT THE POINT OF CONNECTION IS BASED ON NO MORE THAN 5 FEET OF ELEVATION CHANGE IN THE AREAS OF IRRIGATION.
- 5. ALL PRODUCTS SHALL BE INSTALLED IN ACCORDANCE WITH THE MANUFACTURER'S RECOMMENDATIONS AND ACCORDING TO LOCAL BUILDING, ELECTRICAL, AND PLUMBING CODES.
- 6. IRRIGATION CONTRACTOR WILL ARRANGE INSPECTIONS REQUIRED BY LOCAL AGENCIES AND ORDINANCES DURING THE COURSE OF CONSTRUCTION AS REQUIRED. ALL WIRING TO BE PER LOCAL CODE. BACKFLOW PREVENTION TO BE PER LOCAL CODE.
- 7. LOCATION OF IRRIGATION COMPONENTS SHOWN ON DRAWING IS APPROXIMATE. ACTUAL PLACEMENT MAY VARY SLIGHTLY AS REQUIRED TO ACHIEVE FULL, EVEN COVERAGE.
- 8. ALL SPRINKLER HEADS SHALL BE INSTALLED PERPENDICULAR TO FINISH GRADES. EXCEPT AS OTHERWISE INDICATED.
- 9. INSTALL IRRIGATION MAINS WITH A MINIMUM 18" OF COVER BASED ON FINISH GRADES. INSTALL IRRIGATION LATERALS WITH MINIMUM 12" OF COVER BASED ON FINISH GRADES.
- 10. PIPE LOCATIONS ARE DIAGRAMMATIC. VALVES AND MAINLINE SHOWN IN PAVED AREAS ARE FOR GRAPHIC CLARITY ONLY.
- 11. THE IRRIGATION CONTRACTOR SHALL COMPLY WITH PIPE SIZES AS INDICATED.
- 12. ALL WIRE SPLICES OR CONNECTIONS SHALL BE MADE WITH APPROVED WATERPROOF WIRE CONNECTIONS AND BE IN A VALVE OR SPLICE BOX.
- 13. ALL CONTROL WIRING DOWNSTREAM OF THE CONTROLLER IS TO BE 14 AWG, UL APPROVED DIRECT BURY.
- 14. THE DESIGN IS BASED ON THE SITE INFORMATION AND/OR DRAWING SUPPLIED WITH THE DESIGN CRITERIA BEING SET(AREA TO BE IRRIGATED, EQUIPMENT MANUFACTURER AND MODEL TO BE USED, WATER SOURCE INFORMATION, ELECTRICAL POWER AVAILABILITY, ETC...). SITEONE LANDSCAPE SUPPLY BEARS NO RESPONSIBILITY OR LIABILITY FOR ANY ERRORS IN DESIGN OR INSTALLATION THAT ARISE DUE TO INACCURACIES IN THE ABOVE REFERENCED INFORMATION SUPPLIED TO SITEONE LANDSCAPE SUPPLY LANDSCAPES IN RELATION TO THIS PROJECT, UNLESS OTHERWISE NOTED.

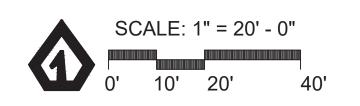



1-800-347-4272 http://www.projectservices.siteone.com

650 Stephenson Highway Troy, Michigan 48083 Phone 248.588.2100 Fax 248.588.3528 www.Siteone.com 800.347.4272

Project Name: **1575 E HAMLIN ROAD** ROCHESTER HILLS, MI, 48307

**Customer Name:** 

Checked By:

Design Date: 08/14/23 Drawn By:

C.BEST

**REVISIONS** 08/24/23

Drawing Title: IRRIGATION DESIGN

1" = 20' Drawing Scale:

Project Services Number: 333287

Sheet Number: