


GENERAL NOTES
 All work to comply with current laws, regulations, local zoning ordinances and The 2003 Michigan Residential Code.
 Do not scale drawings. Use figured dimensions only.
 Verify all dimensions in the field.

DEMOLITION

Demolition contractor shall be responsible for all shoring, blocking, cribbing, bracing, etc. to maintain building structure stability during demolition operation. Shoring shall remain in place until new system is in place and able to carry required loads.


EXTERIOR (Garage wing)
 Remove all existing windows, garage doors, and brick in area of complete demo.

INTERIOR (Garage wing)
 Visqueen door openings at Living Room
 Remove all cabinets, plumbing fixtures and appliances in area of complete demo.
 Remove all partitions as per plans.
 Remove all windows as required per plans.
 Remove existing roof trusses as per plans.
 Remove existing concrete slab as per plans.
 Demolition contractor shall coordinate with the construction superintendent removal of the debris.
 Demolition contractor shall be responsible for capping plumbing fixtures in areas affected by their work.
 Demolition contractor shall be responsible for cutting the power to electrical outlets in the area of demolition.

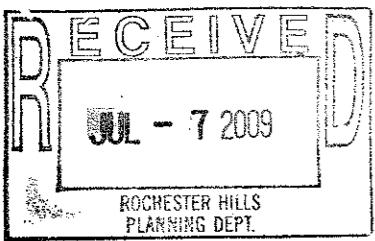


SITE WORK


- Call Miss Dig (1-800-462-7171) at least 72 hours prior to the commencement of any site work.
- Contractor shall shut off, cap and otherwise protect public utility lines.
- Strip topsoil from building area and all areas to have a change of grade to surface of subsoil.
- Stackpile soil on site clear of new construction area.
- Backfill only after the complete installation of the foundation dampening and the installation of perimeter drain tile.
- Finish grade the site to provide positive drainage away from the structure with a minimum of six inches clearance between the grade and the sill plate or unperfed block.
- Designed soil bearing capacity: 3000 PSF

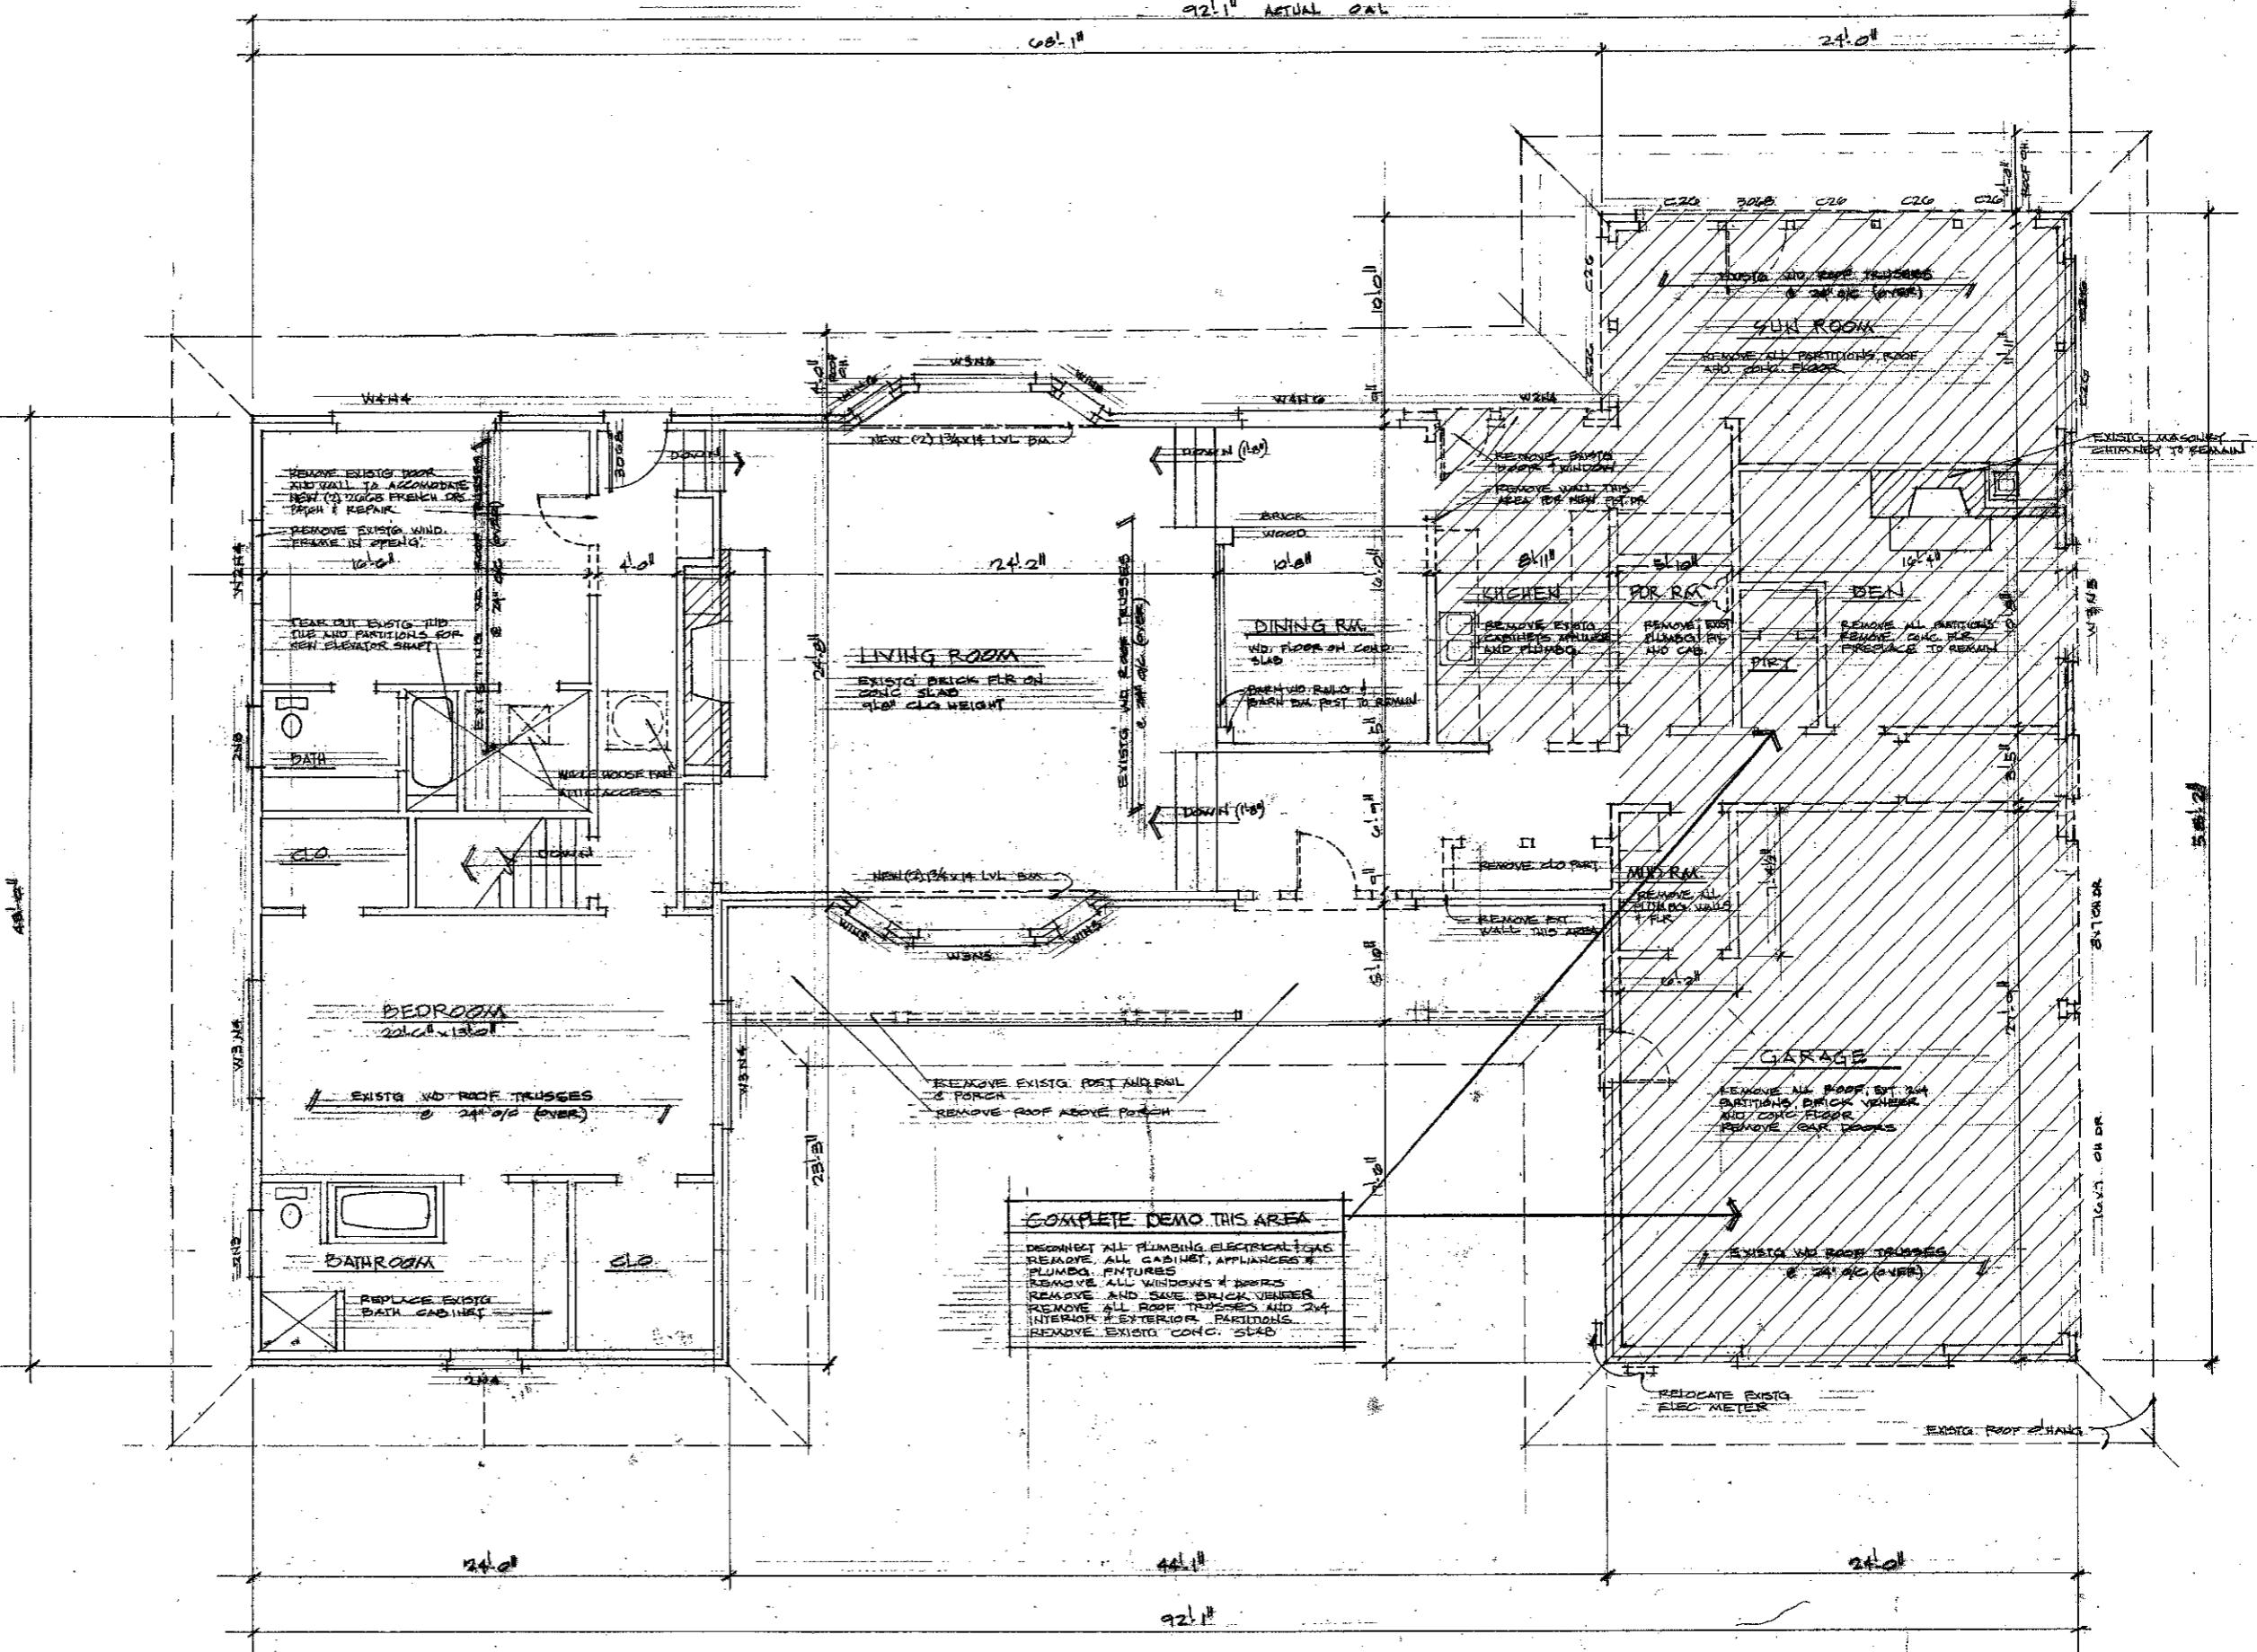

MAIN FLOOR DEMO PLAN

LARRY C. LIZZET RESIDENTIAL DESIGN	PROPOSED: SERES RESIDENCE REMODEL	DATE: 06/09 DRAWN BY: LCL CHECKED BY: LCL REV.: 1
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FIRST FLOOR PLAN

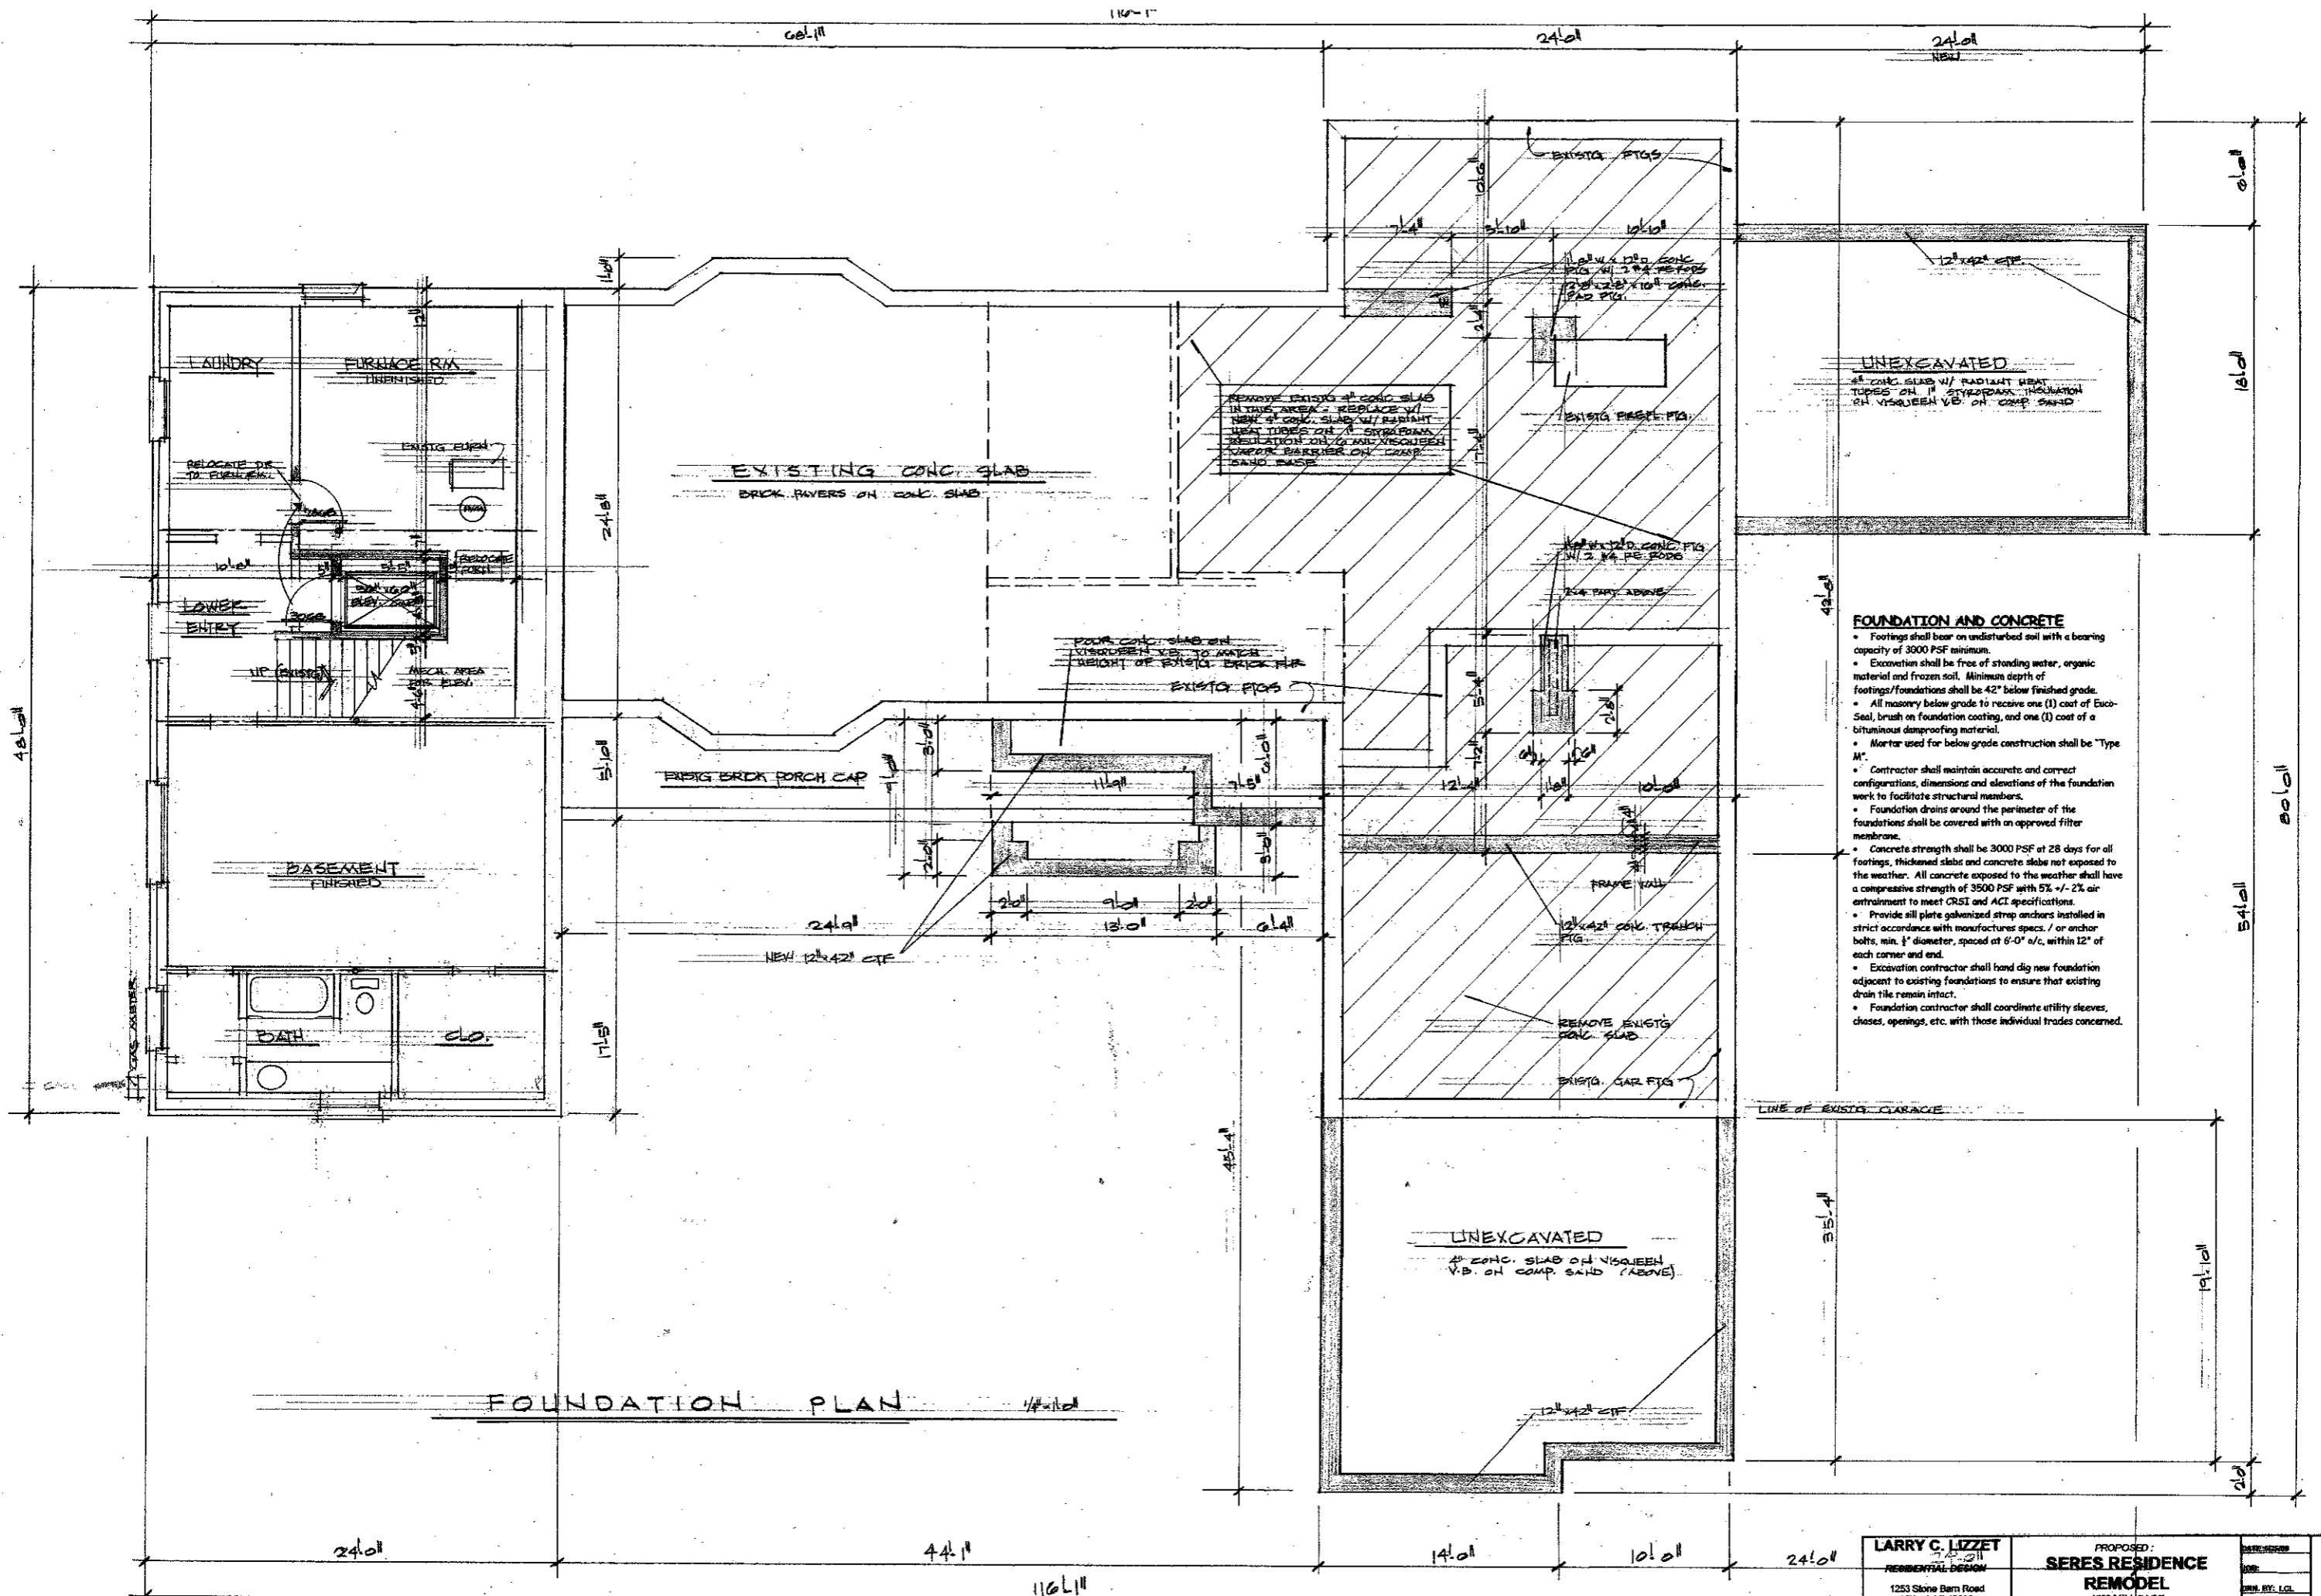2934 S.F. EXISTING LIVING AREA
432 S.F. SUN ROOM
89 S.F. FRONT ENTRY AND LOBBY RRM

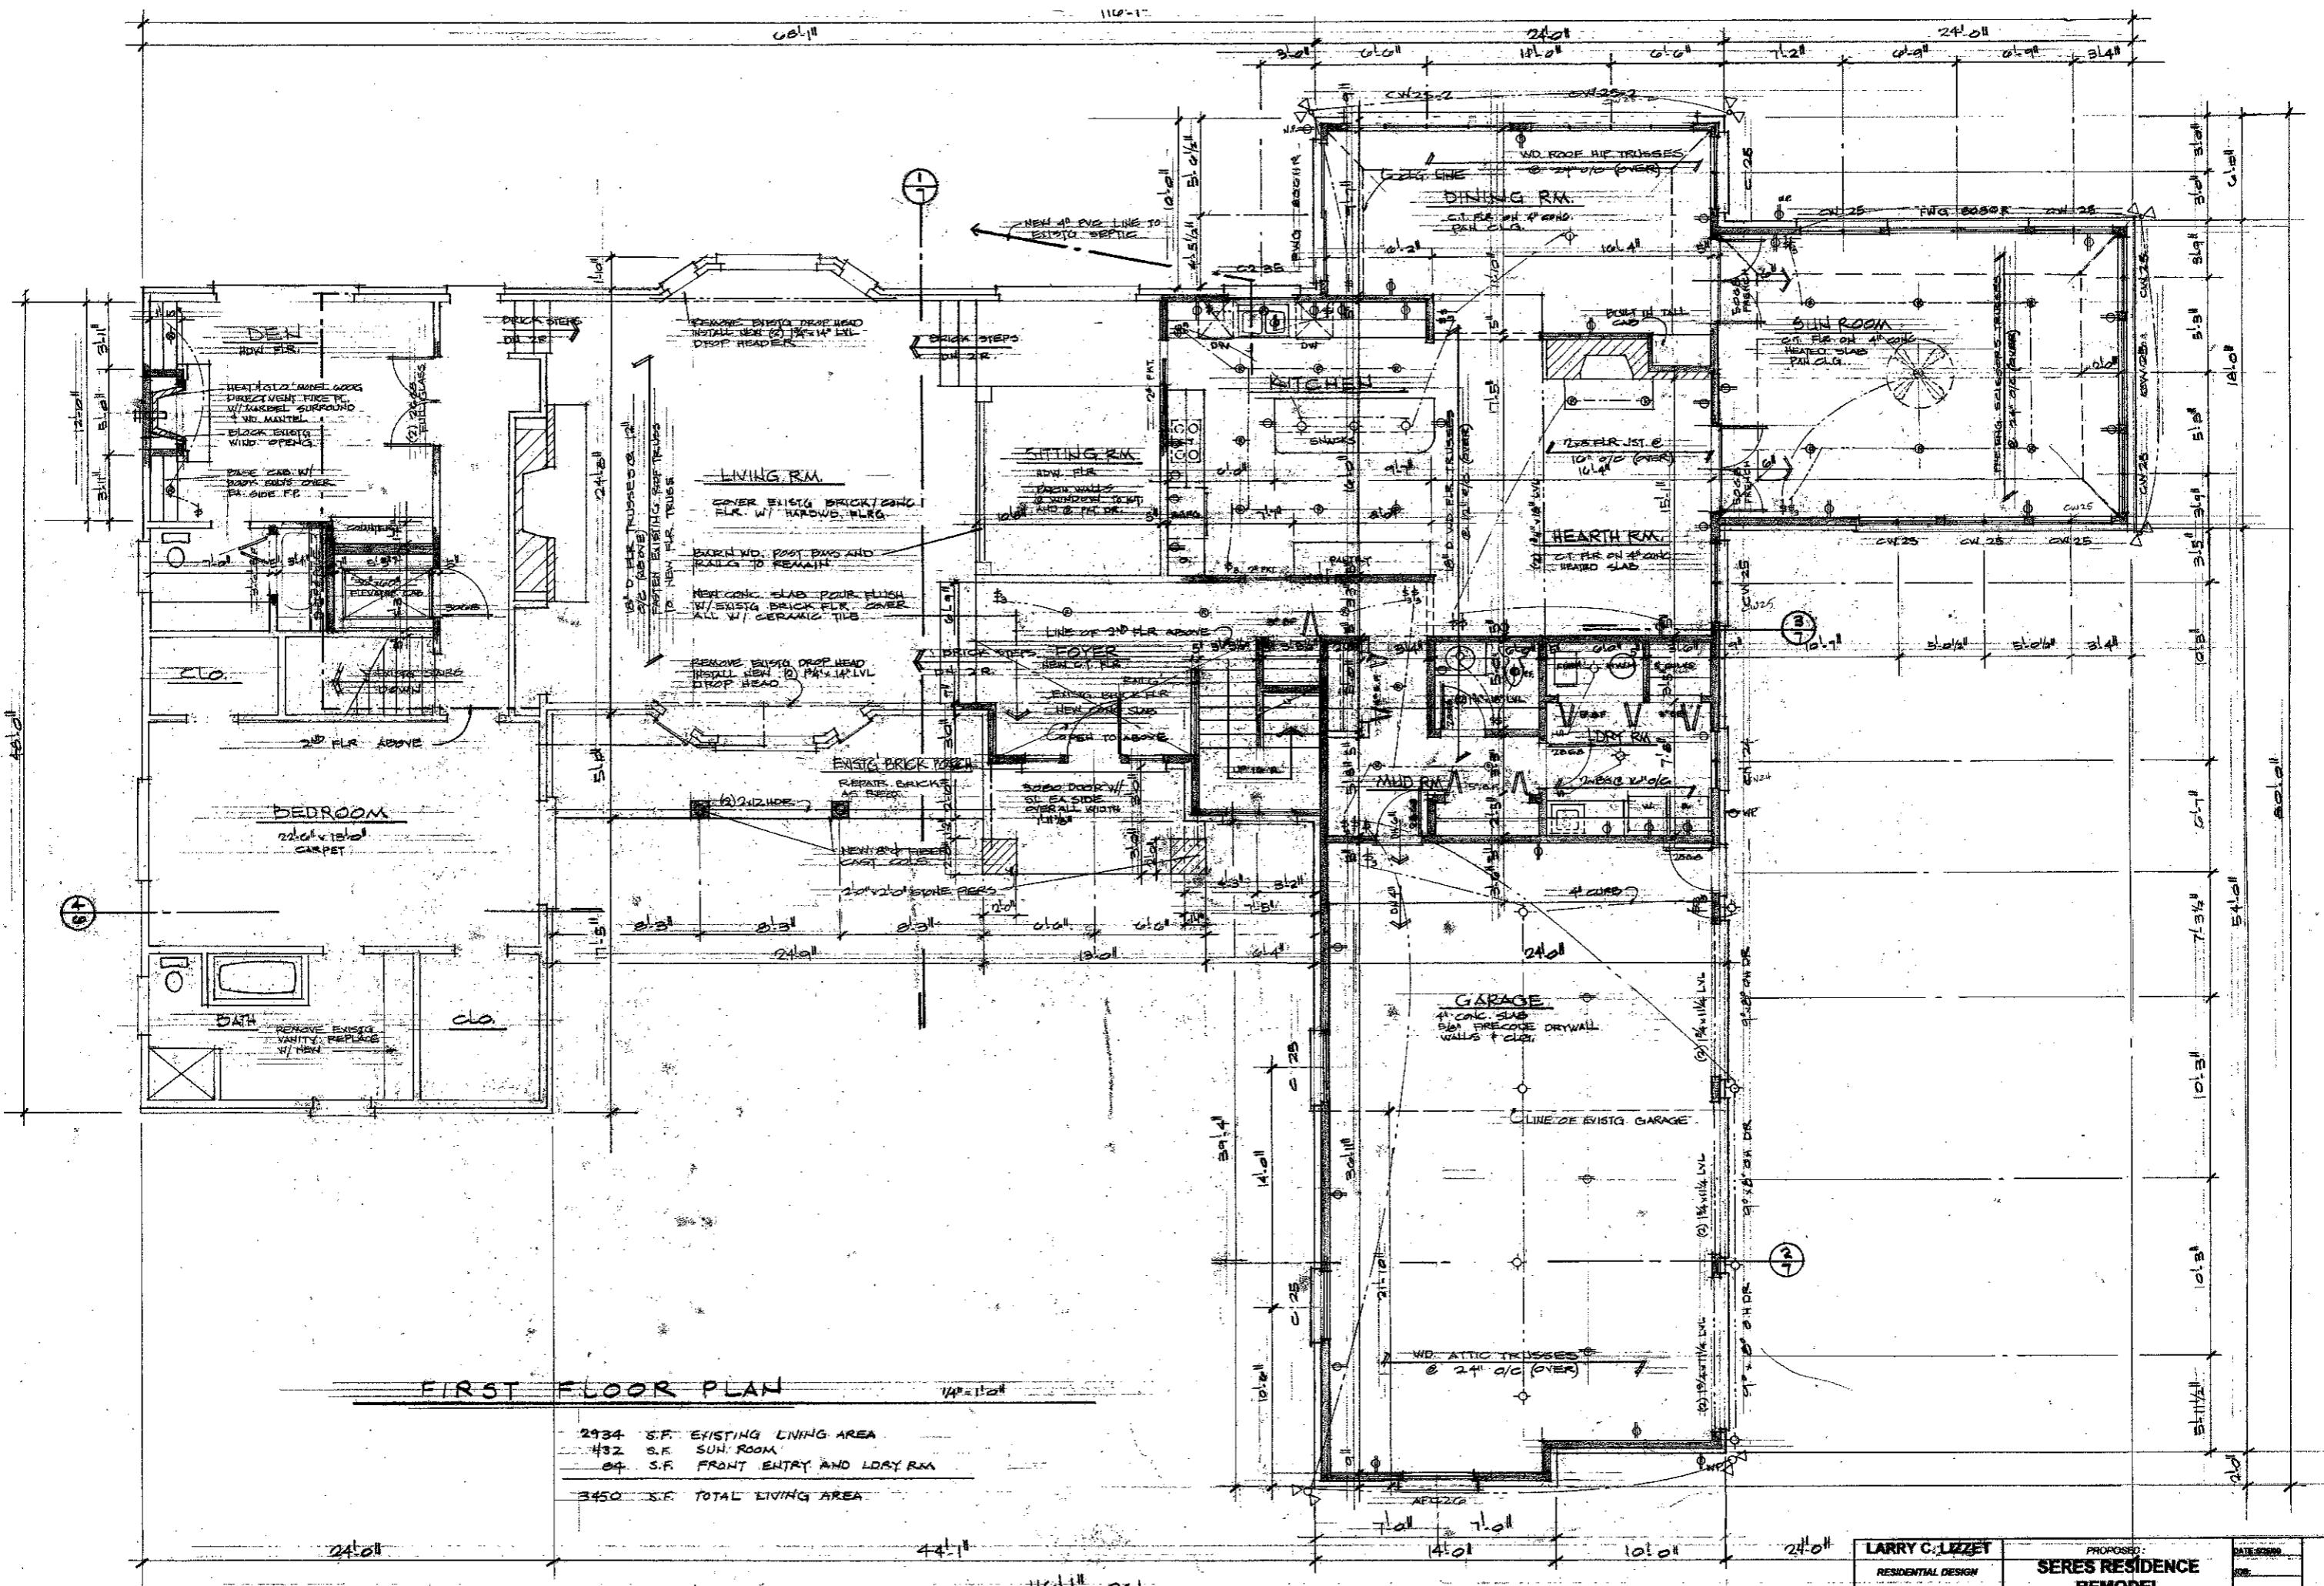3450 S.F. TOTAL LIVING AREA


3450 S.F. TOTAL LIVING AREA

LARRY C. LEZZET

RESIDENTIAL DESIGN

**PROPOSED:
SERES RESIDENCE
REMODELED**

SERES RESIDENCE REMODEL

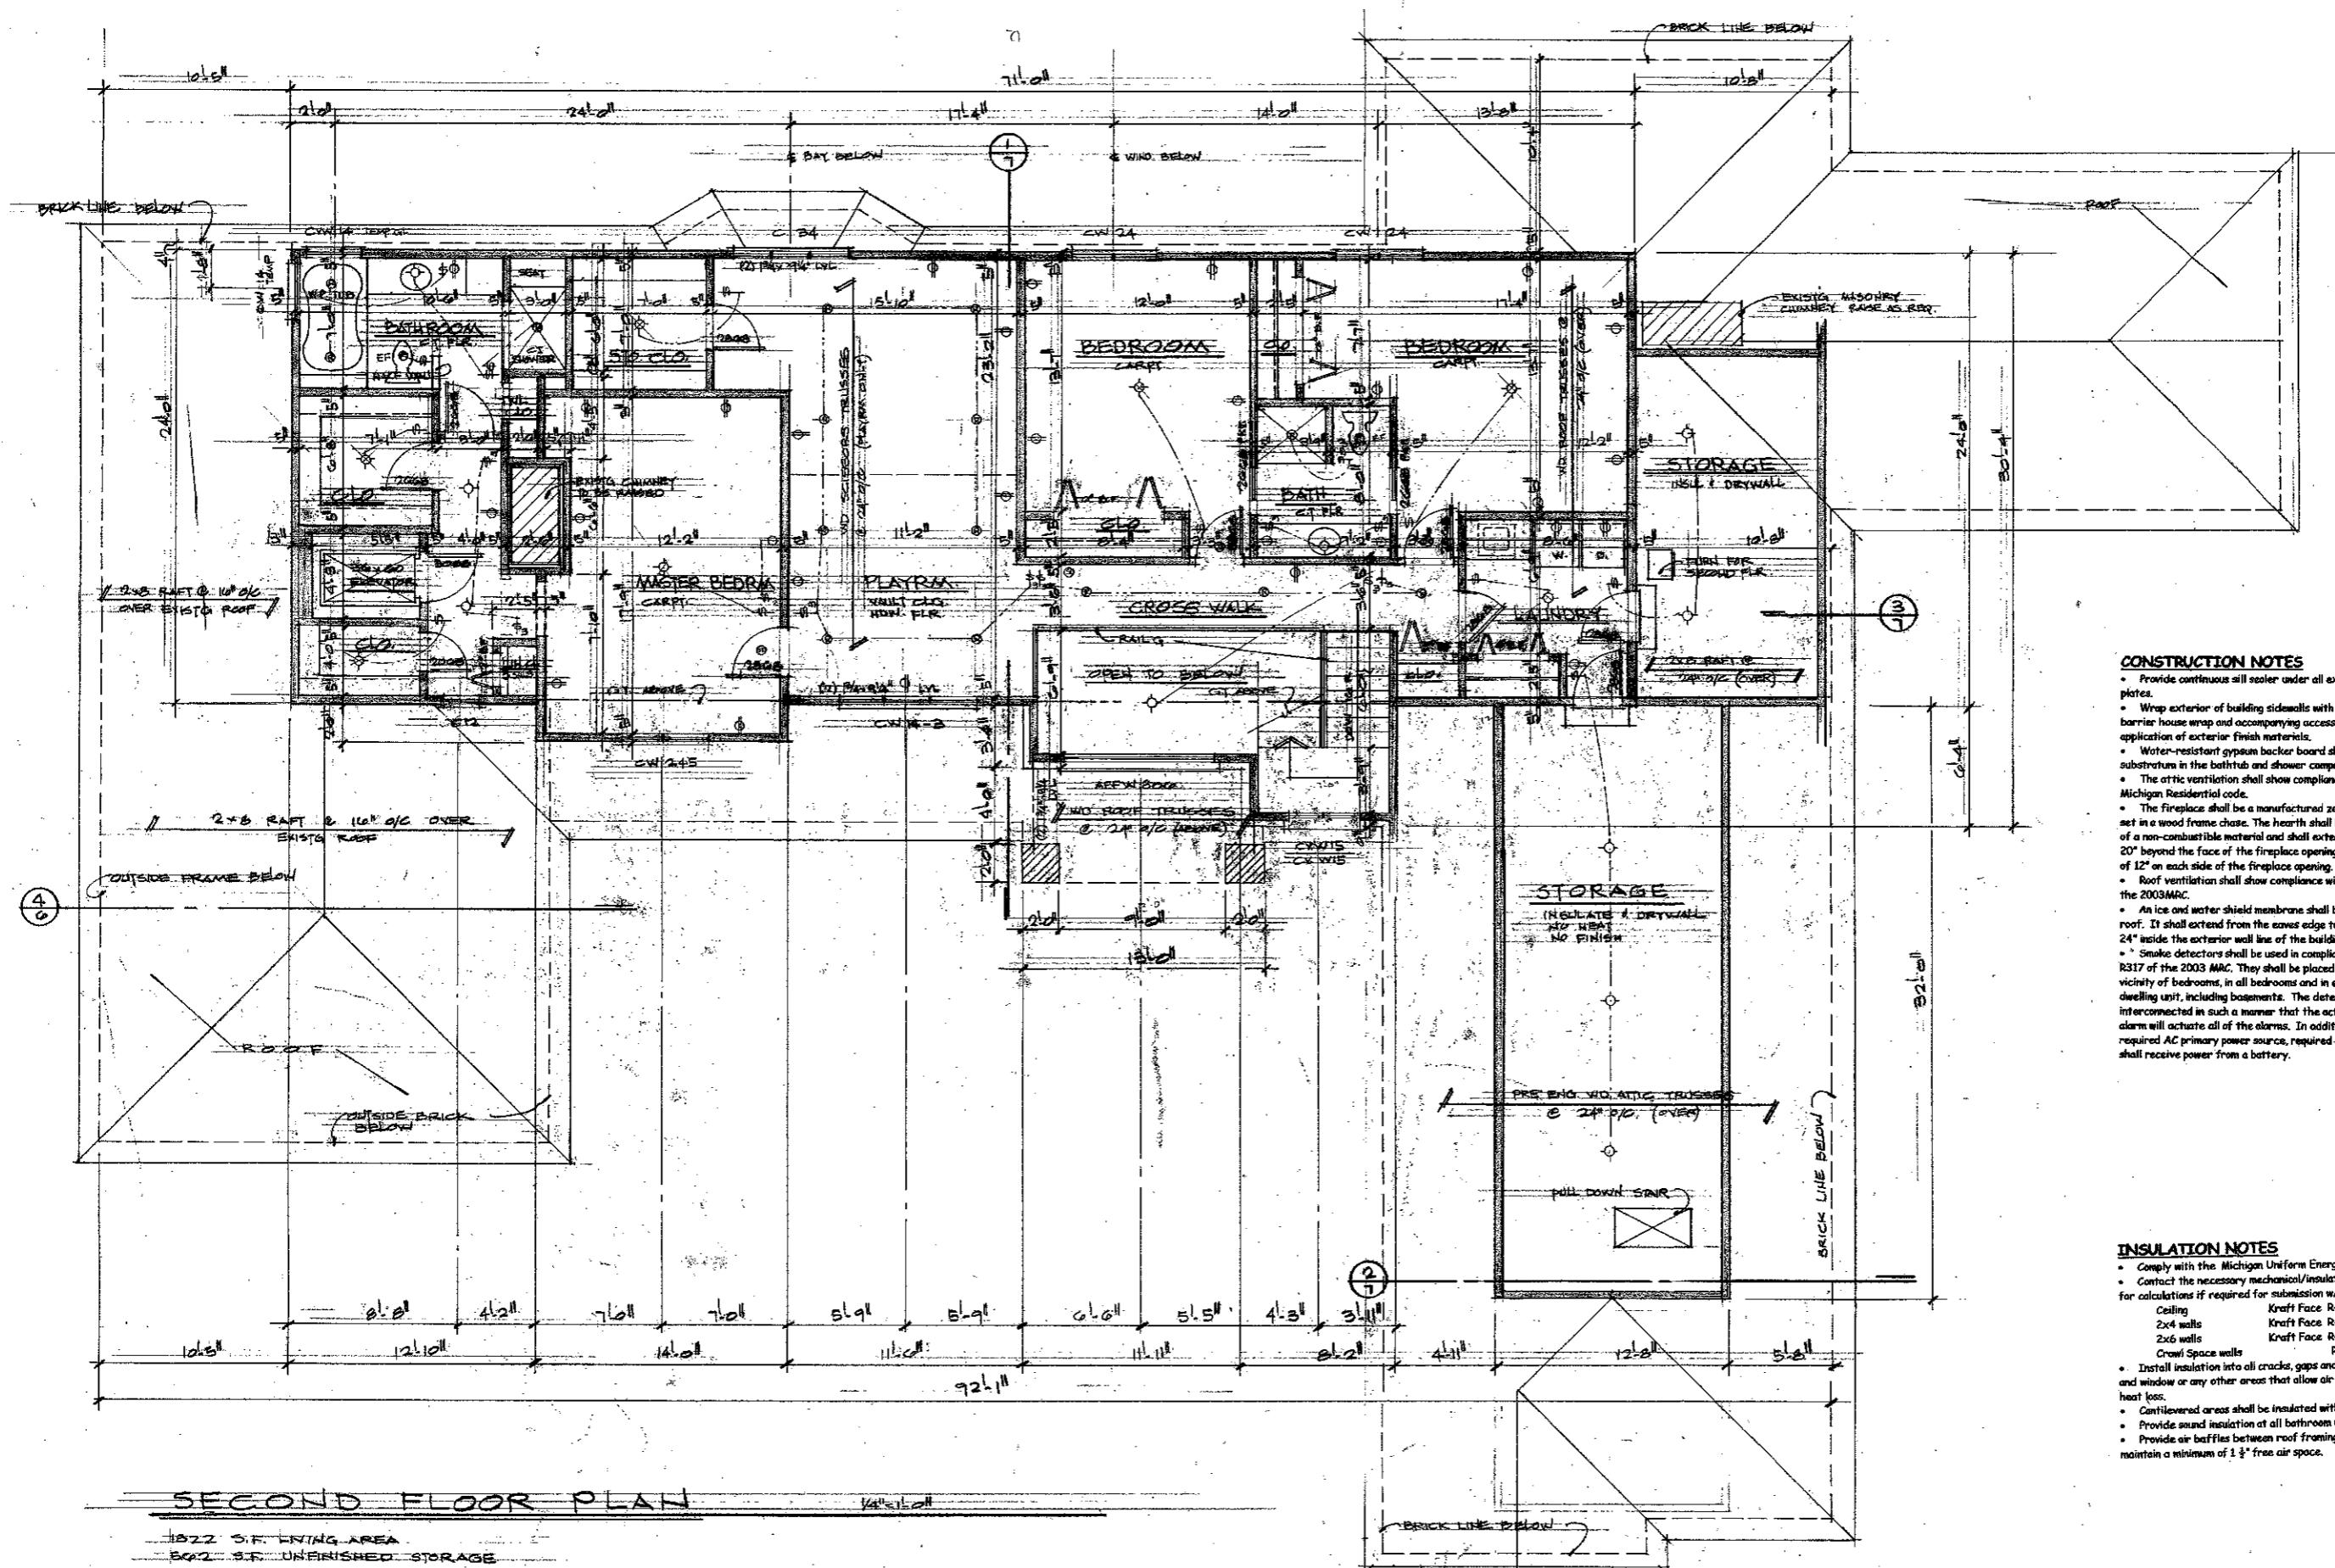

SECOND FLOOR PLAN

1522 S.F. LIVING AREA
5002 S.F. UNFINISHED STORAGE

INSULATION NOTES

- Comply with the Michigan Uniform Energy Code (MUEC)
 - Contact the necessary mechanical/insulation contractors for calculations if required for submission w/ building permit.



Ceiling	Kraft Face R-30 min. 9"	
2x4 walls	Kraft Face R-13	3 1/2"
2x6 walls	Kraft Face R-22	6 1/2"
Crab Space walls	R-5	

 - Install insulation into all cracks, gaps and around doors and window or any other areas that allow air infiltration or heat loss.
 - Cantilevered areas shall be insulated with R-30 insulation
 - Provide sound insulation at all bathroom walls.
 - Provide air baffles between roof framing at eaves to maintain a minimum of 1 1/4" free air space.

LARRY C. LIZZET
RESIDENTIAL DESIGN
1253 Stone Barn Road
Brentwood 38-4230

**PROPOSED:
SERES RESIDENCE
REMODEL
1520 MILL RACE**

DATE: 02/25/00	SHEET #
JOB:	
DRW. BY: LCL	
CSD. BY: LCL	

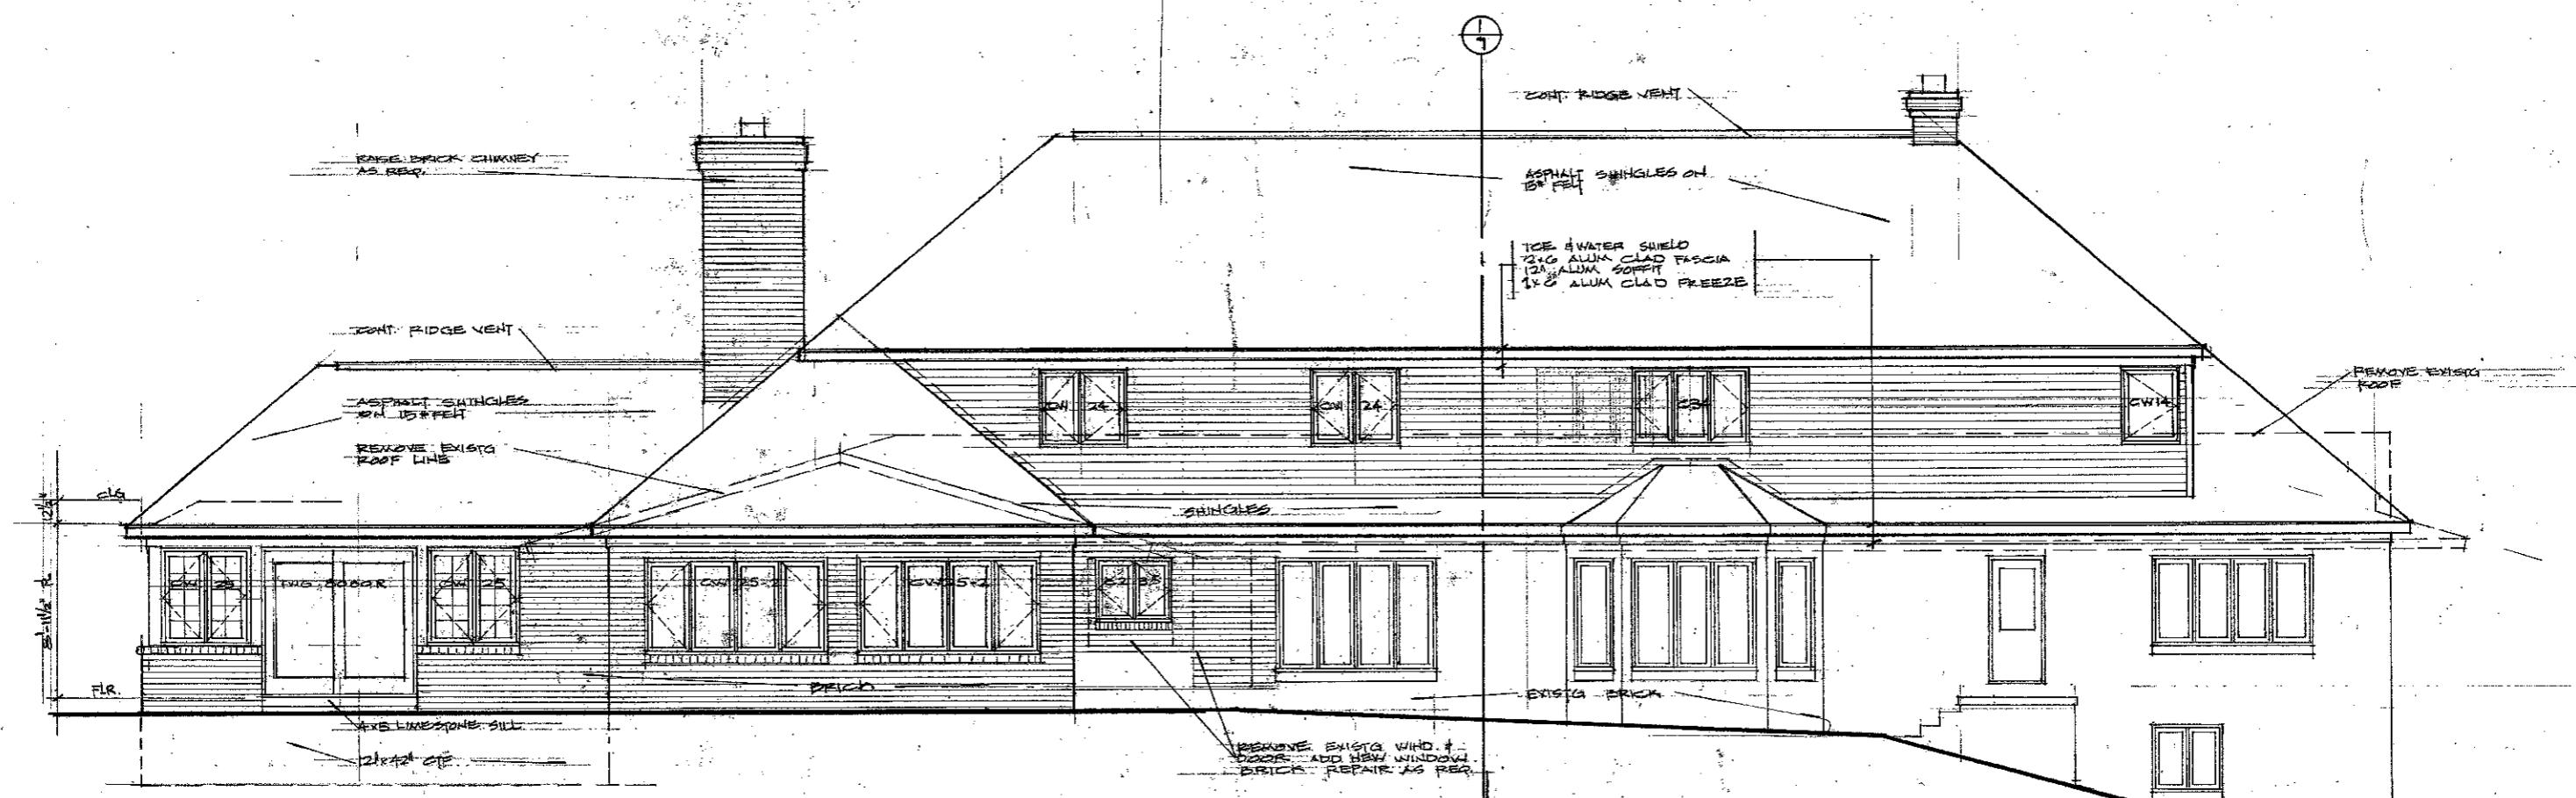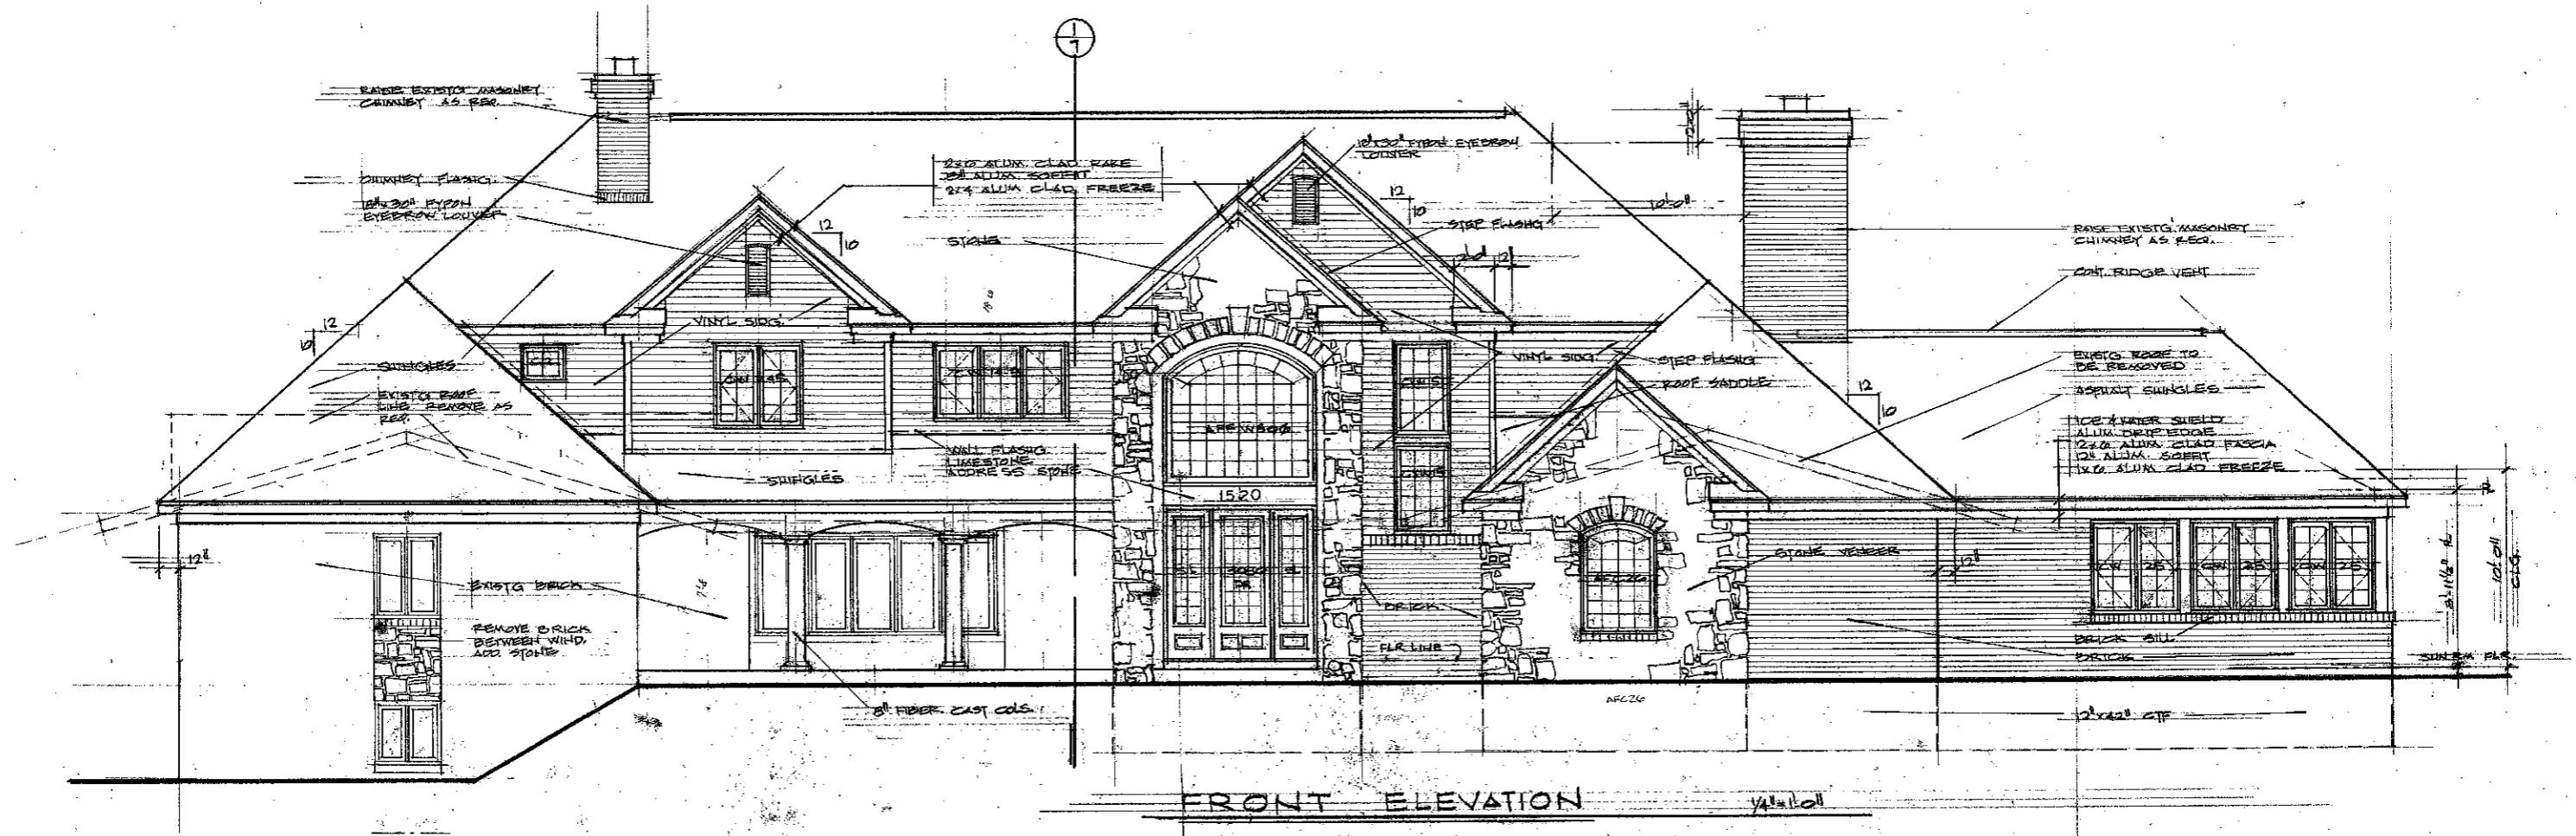


LARRY C. LIZZET
RESIDENTIAL DESIGN
1252 Sheep Run Road

**PROPOSED:
SERES RESIDENCE
REMODEL
1520 MILL RACE**


DATE ISSUED
JOB:
BY: LCL
KD. BY: LCL

SHEET NO.
5

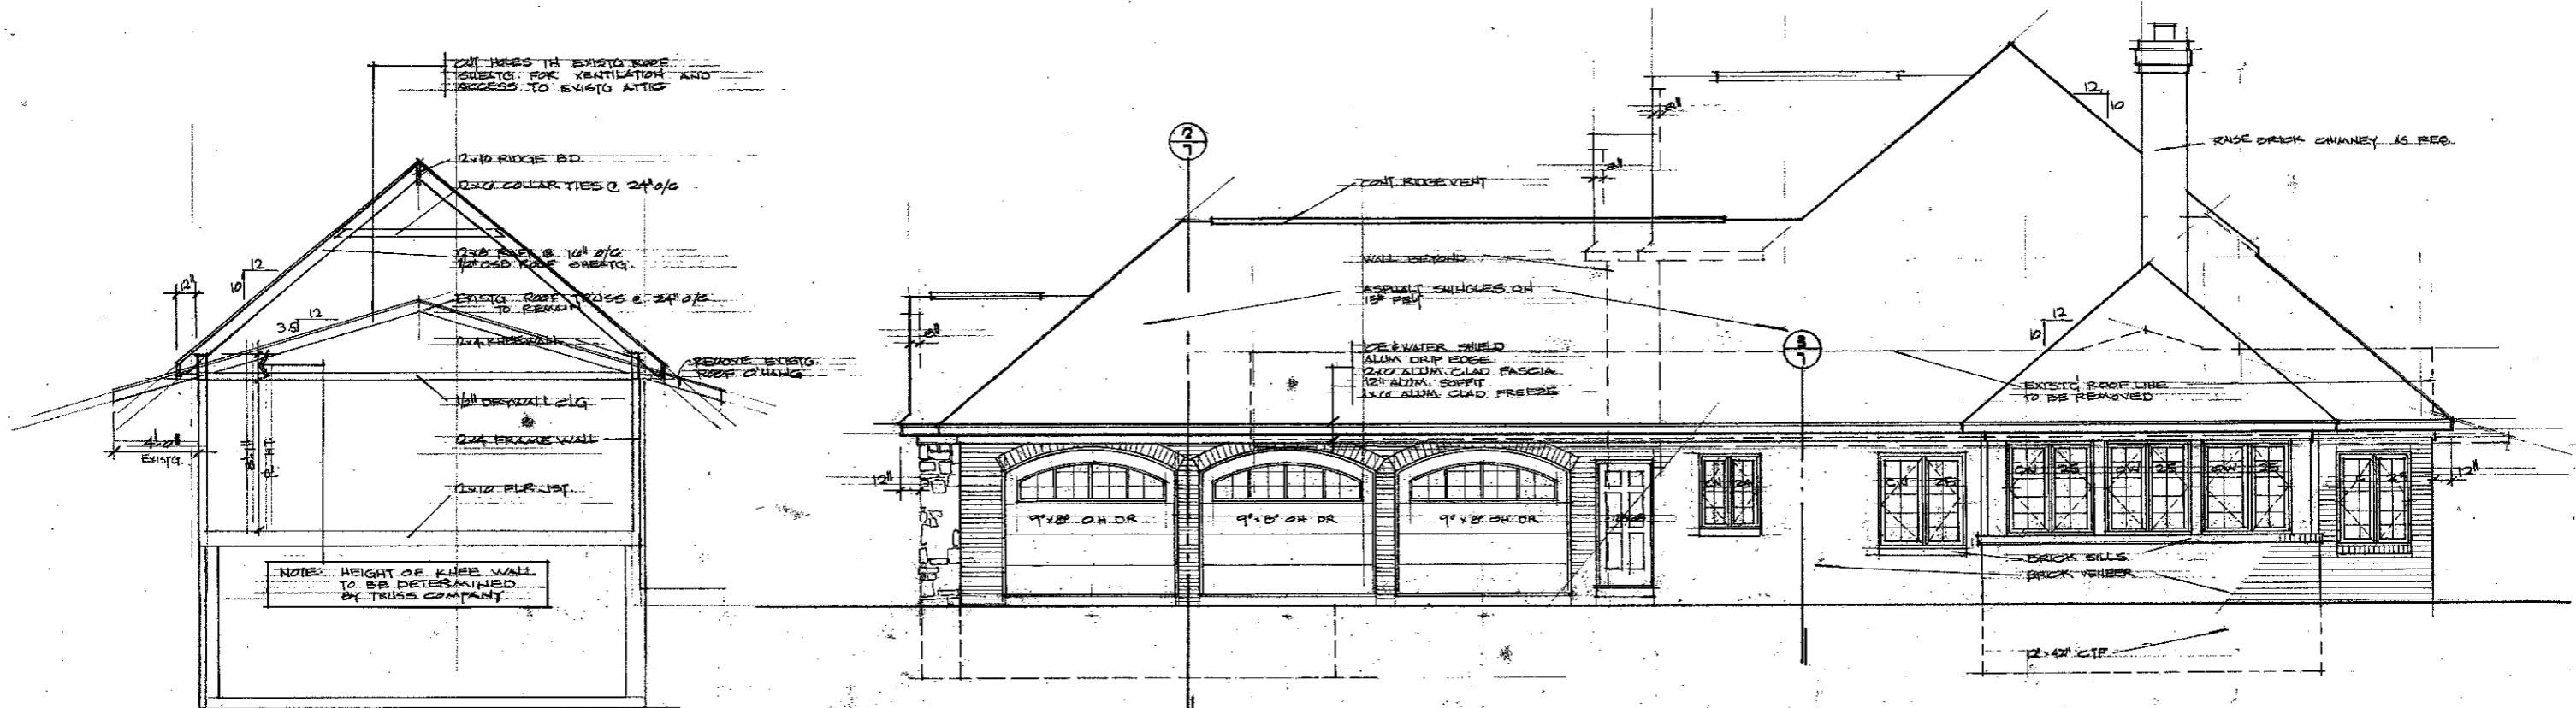

RIGHT SIDE ELEVATION

SECTION



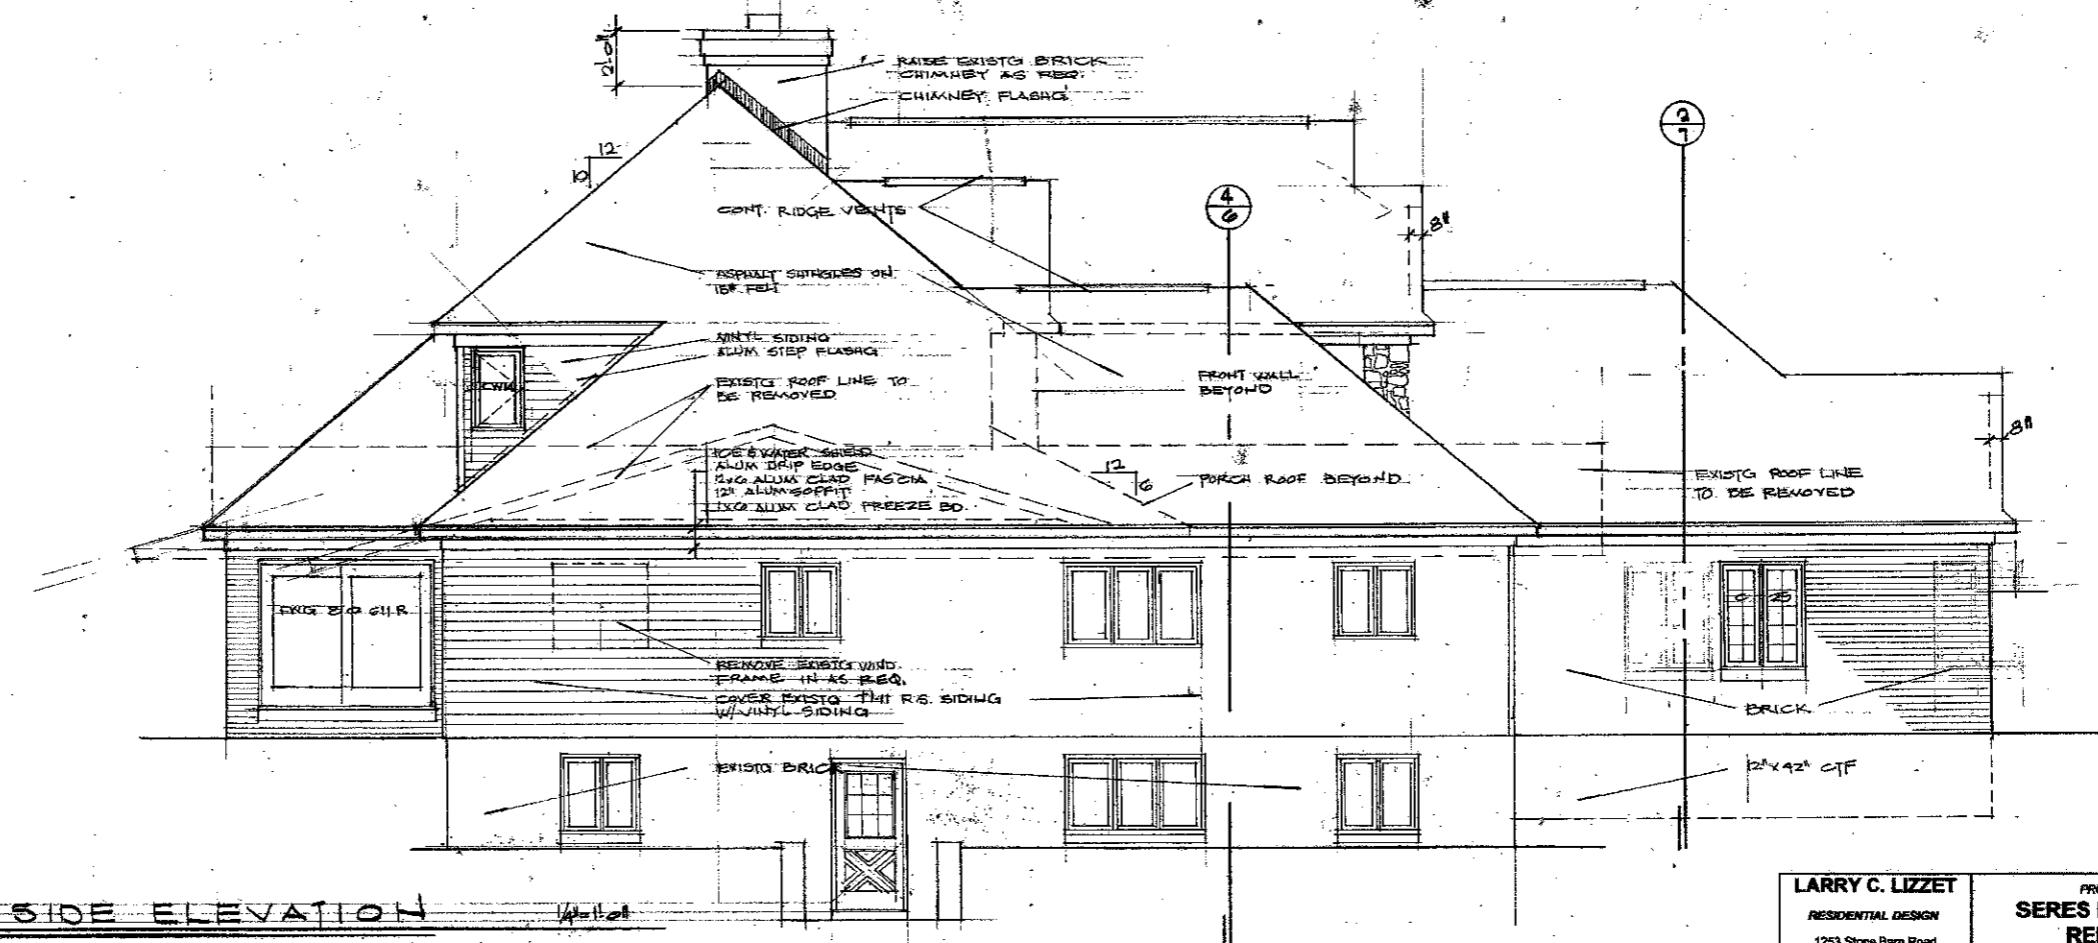


LEFT SIDE ELEVATION

LARRY C. LIZZET
RESIDENTIAL DESIGN
1253 Stone Barn Road
Milford, MI 48380
Ph. 248-877-1996

**PROPOSED:
SERES RESIDENCE
REMODEL
1520 MILL RACE
ROCHESTER HILLS, MI**

DATE: 8-22-98
SHEET NO.
JOB:
PRINT BY: LCL
PROD. BY: LCL
REV.

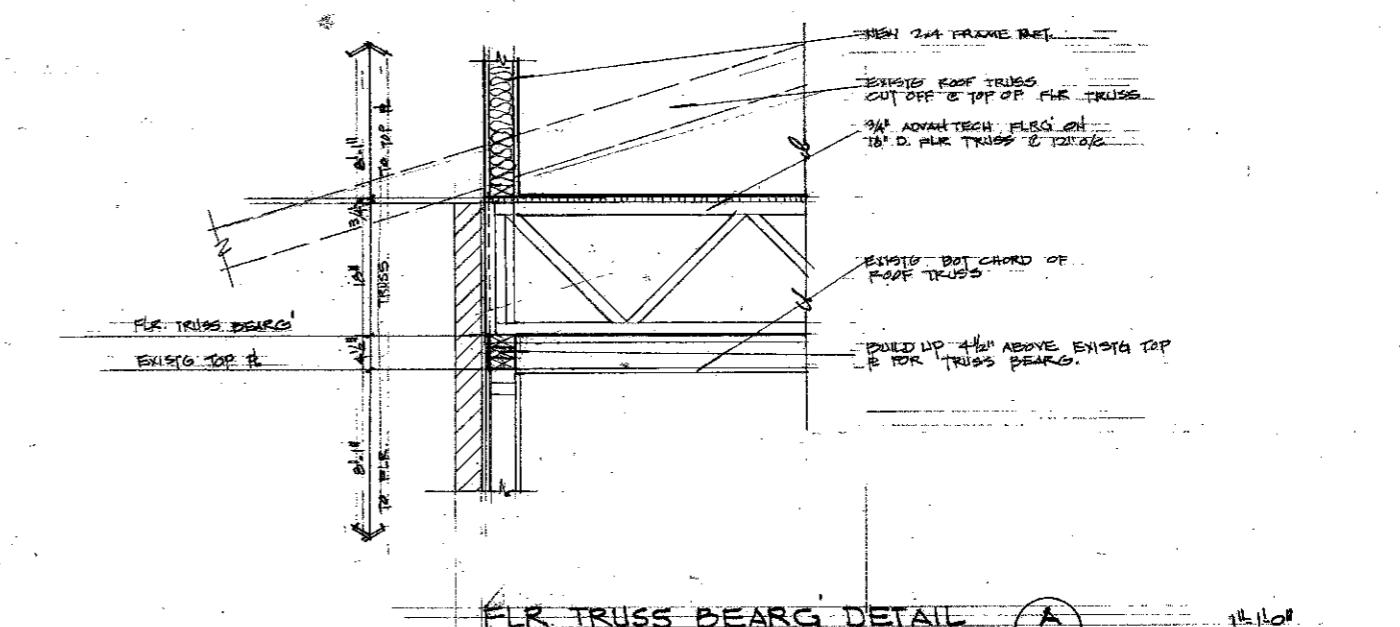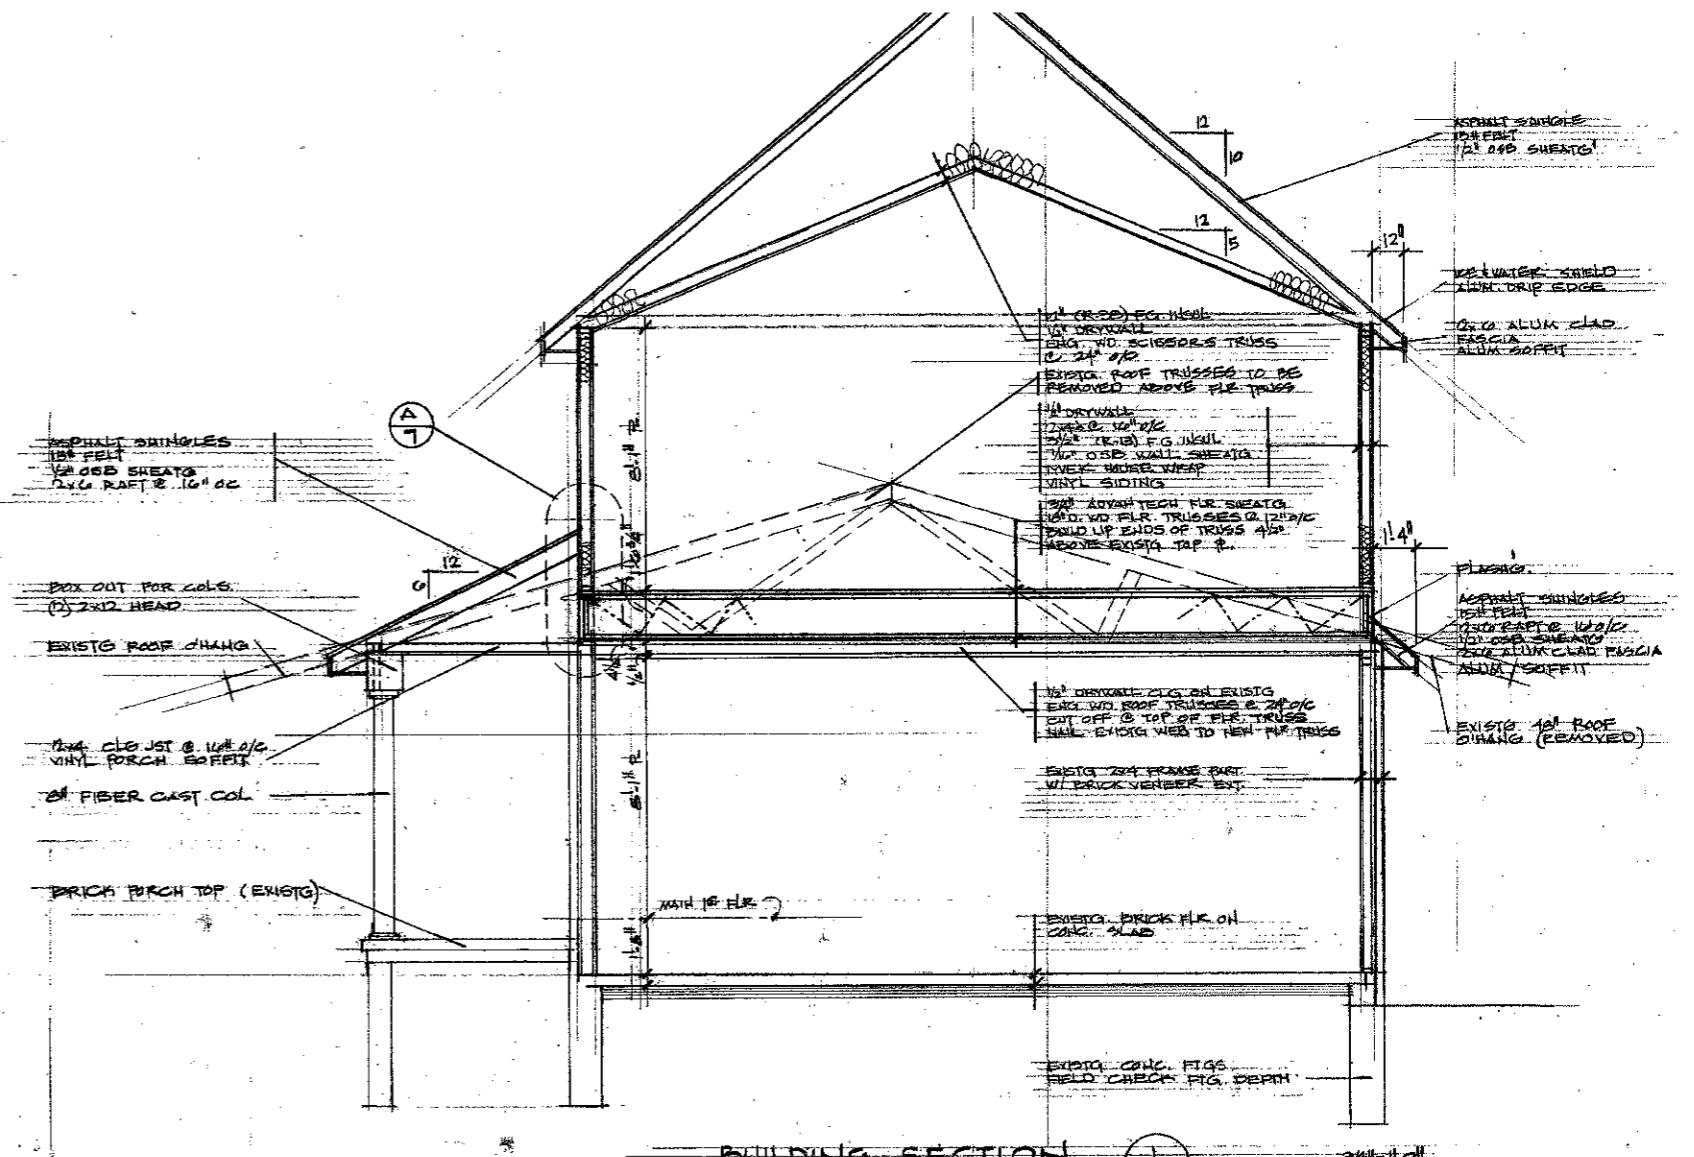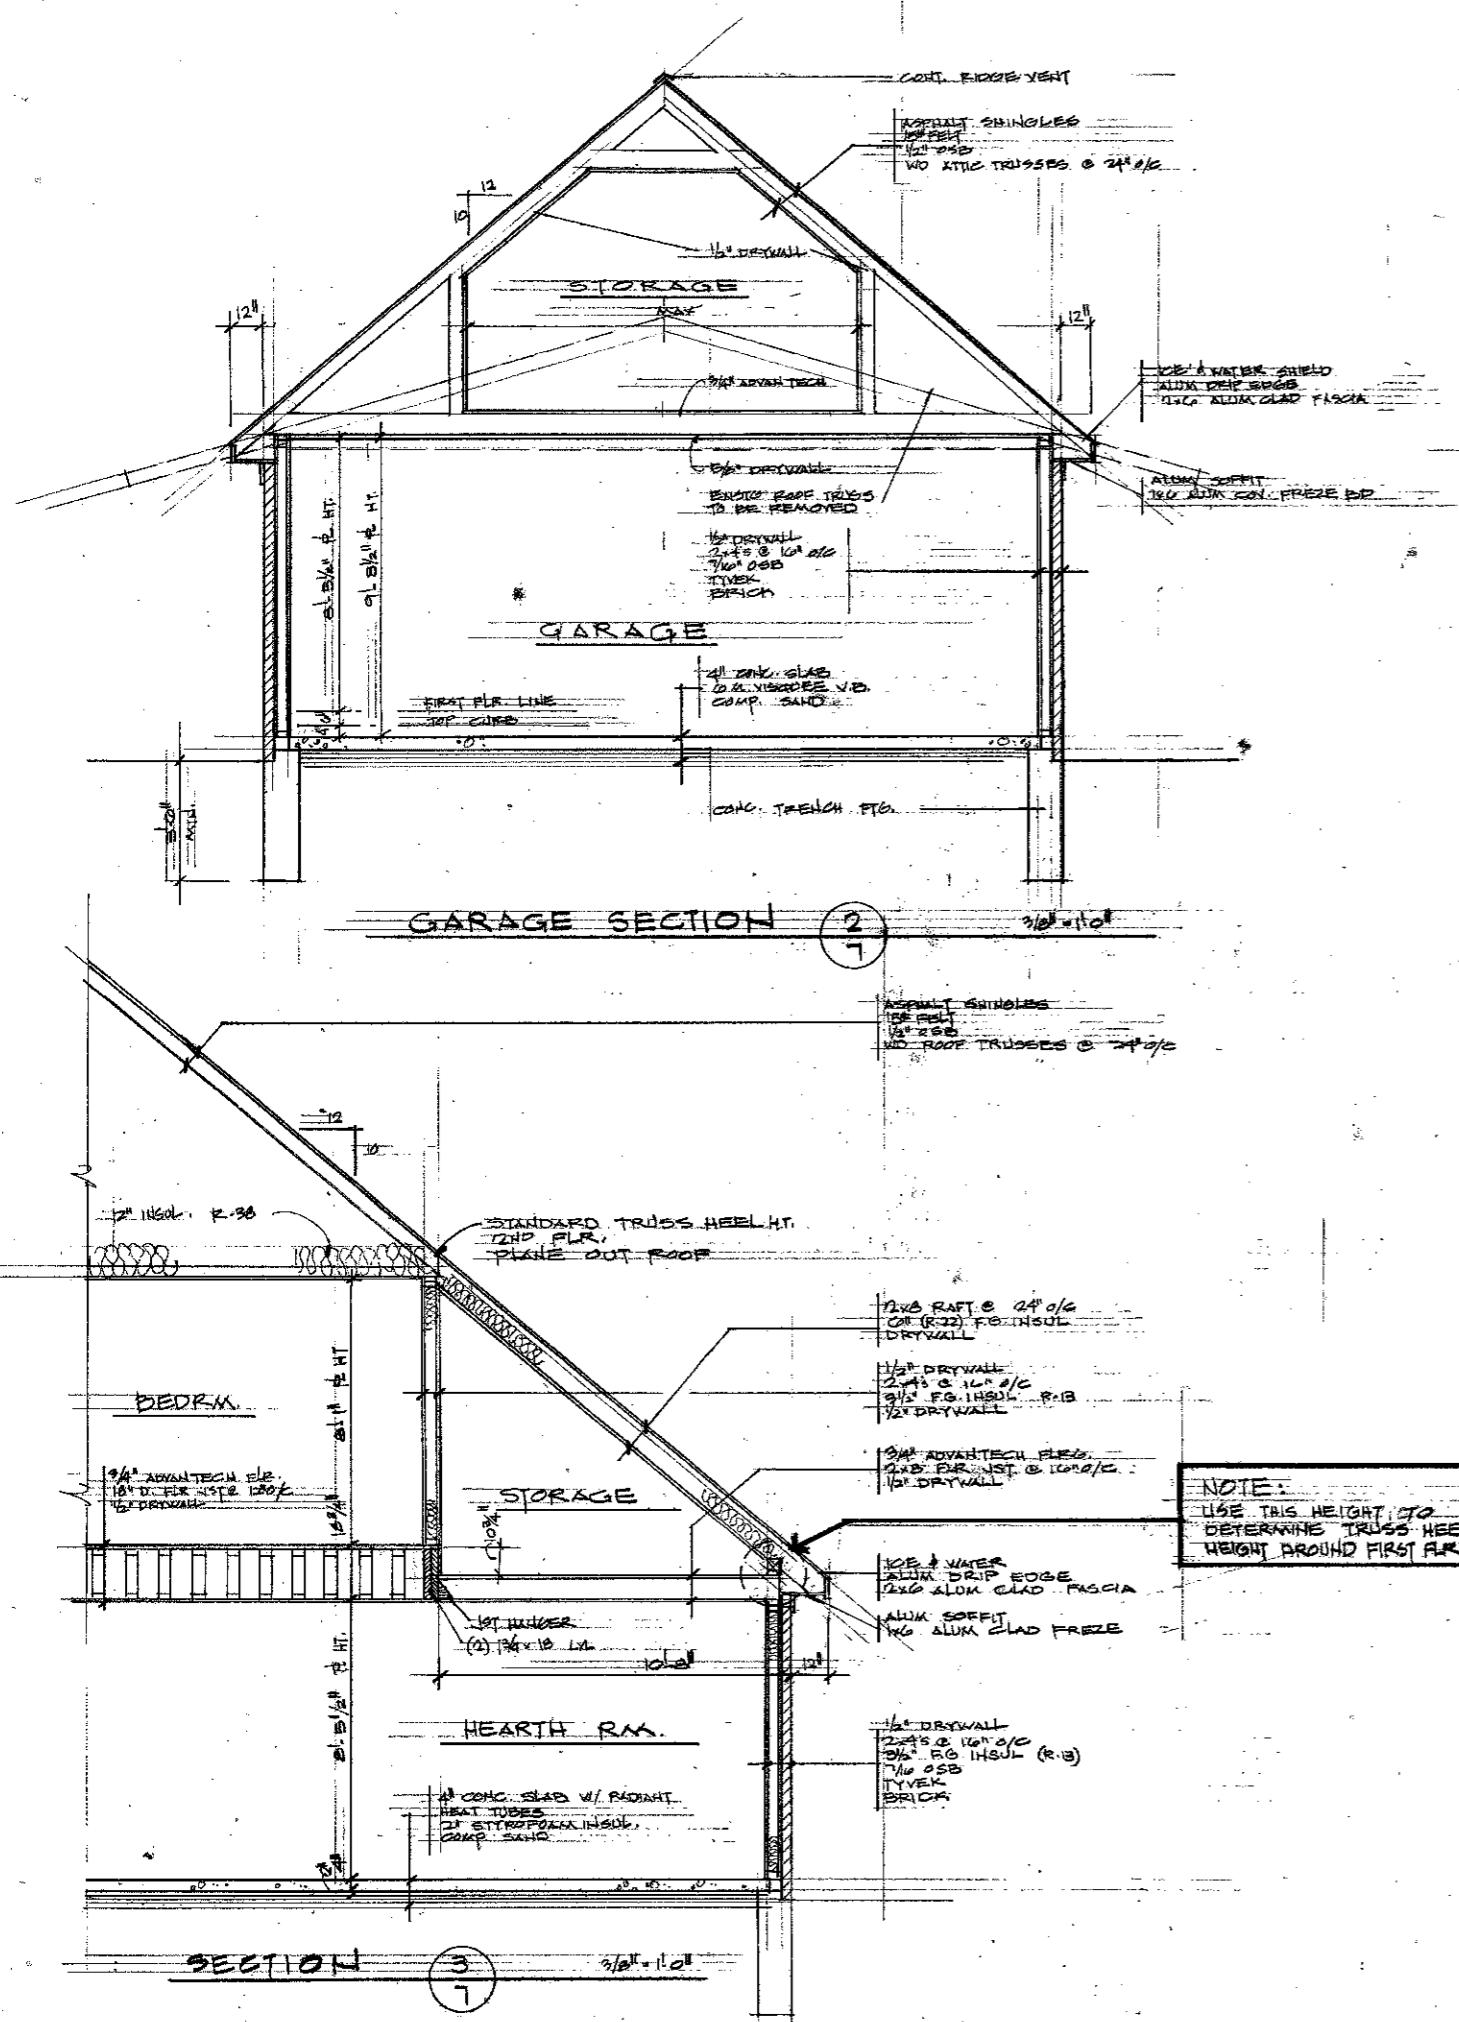


FLR TRUSS BEARING DETAIL

110

LARRY C. LIZZET
RESIDENTIAL DESIGN
1253 Stone Barn Road
Aptos, CA 95003

**PROPOSED:
SERES RESIDENCE
REMODEL
1500 N MILK RACE**

1-47888	SHIRT NO.
9:	
N. BY: L.C.	
100-100	

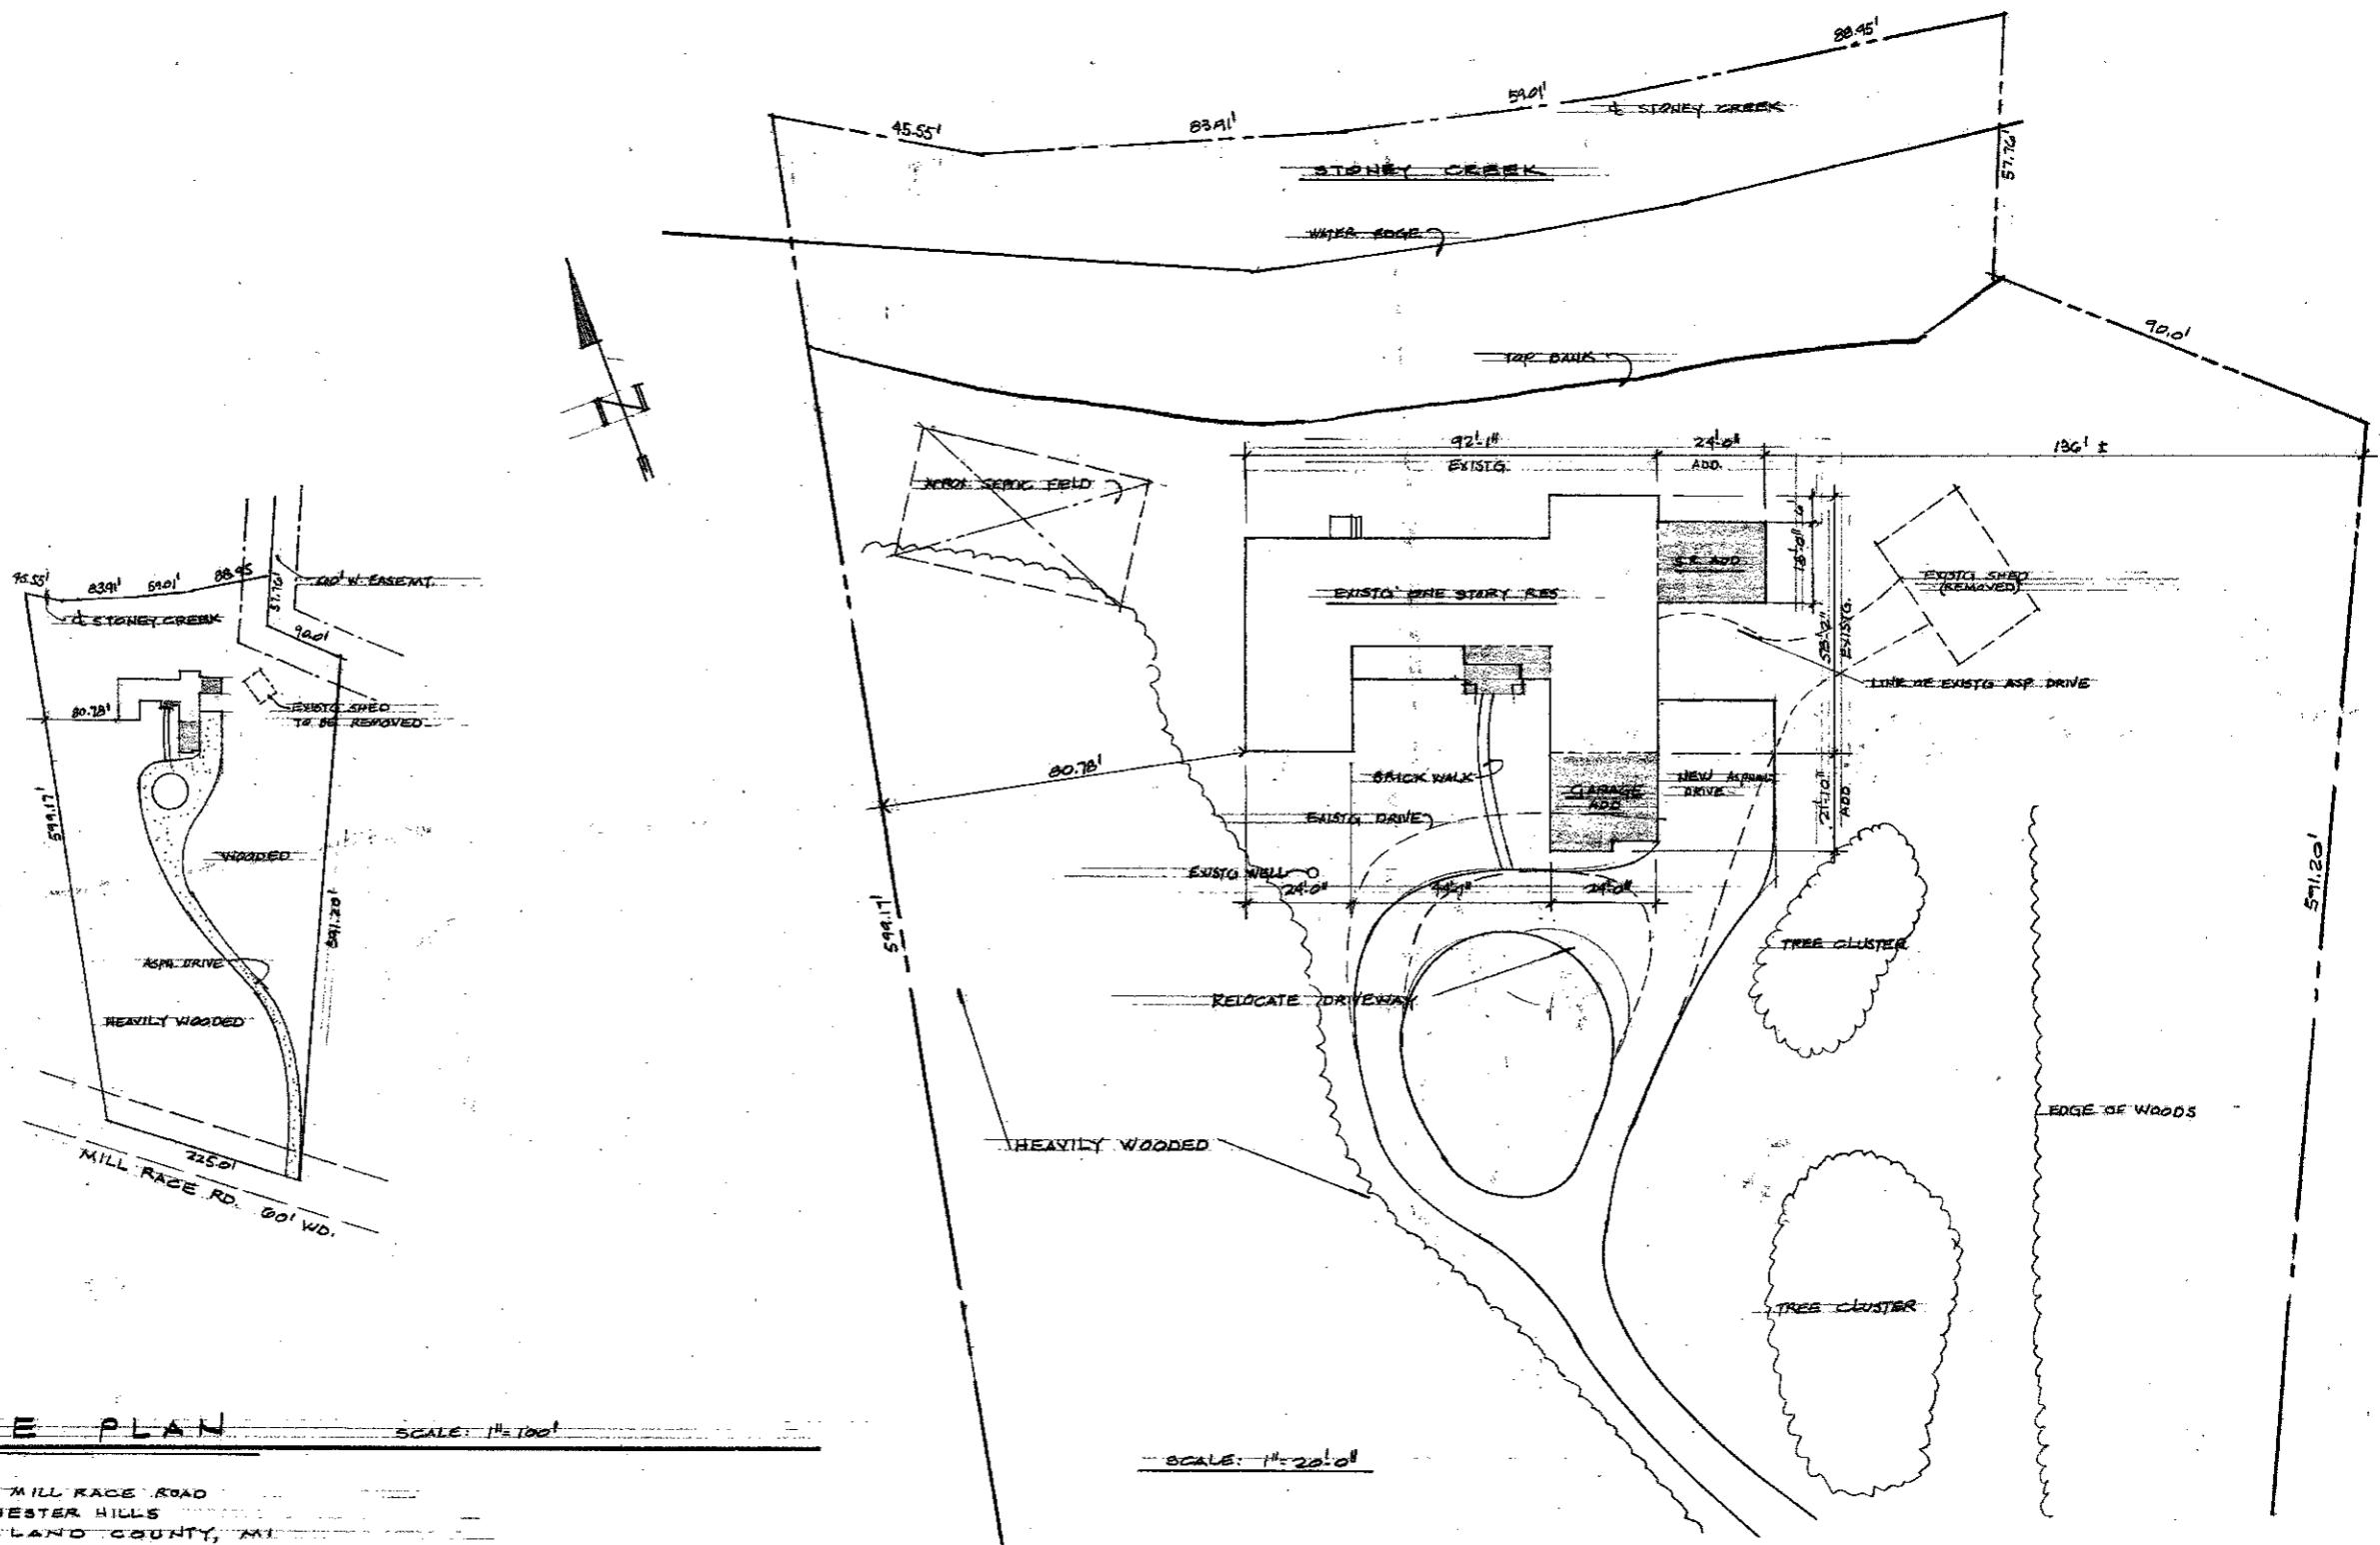

SITE PLA

1520 MILL RACE ROAD
ROCHESTER HILLS
OAKLAND COUNTY, MI

SCALE: 1" = 100'

— SCALE: $1^{\prime\prime} = 20'-0"$

LARRY C. LIZZET
RESIDENTIAL DESIGN
1263 Stone Barn Road

**PROPOSED:
SERES RESIDENCE
REMODEL**

DATE-WANTED
100%
DRW. BY: LCL

SHEET NO.