biddison architecture + design

PROPOSED SHELL BUILDING FOR:

Hampton Plaza Outlot

320 Martin Street Suite 10 Birmingham, MI 48009 t:248.554.9500 Contact Person: Kevin Biddison e.mail: kb@biddison-ad.com

CONDITIONS OF WORK

1. ALL CONTRACTORS SHALL REVIEW ALL DRAWINGS & ARE RESPONSIBLE FOR A COMPLETE REVIEW & SITE VISIT. ITEMS AFFECTING ALL TRADES ARE PLACED THROUGHOUT SET & NO TEXTRAS* FOR MISSED ITEMS IN OTHER SECTIONS WILL BE PERMITTED. THE CONTRACTOR SHALL IMMEDIATELY NOTIFY ARCHITECTOR ANY AMBIGUTY, INCONSISTENCY OR ERRORS WHICH THEY DISCOVER UPON EXAMINATION OF DOCUMENTS, THE SITE OR LOCAL CONDITIONS.

2. ANY CONTRACTOR OR SUBCONTRACTOR BY SUBJUTTING A BID WARRANT'S THAT HE HAS VISITED THE SITE AND IS AWARE OF ANY AND ALL SITE CONDITIONS AFFECTING MS BID.

3. THE CONTRACTOR BY COMMENCING WORK ACCEPTS THE CONDITIONS OF THE SITE & THE COMPLETENESS OF CONTRACT DOCUMENTS.

4. FIELD VERIFY ALL DIMENSIONS AND REPORT ANY DISCREPANCIES IMMEDIATELY TO THE ARCHITECT. DO NOT SCALE DRAWINGS USE FIGURED DIMENSIONS ONLY.

5. ANY MATERIAL OR LABOR NEITHER SHOWN ON THE DRAWINGS NOR SPECIFIED, BUT WHICH IS DRIVOUSLY NECESSARY TO COMPLETE THE WORK IN A WORKMARLIKE MANNER SHALL BE FURNISHED WITHOUT COST TO THE OWNER.

S. ALL MATERIALS FARMSHED AND INSTALLED BY THE DENERAL CONTRACTOR SHALL BE PREET FROM DECEPTOR. ALL WORK CHALL BE DAY MANTED FOR A PERIOD OF (1) YEAR FROM DATE OF ACCEPTANCE OF WORK, DURING THIS PERIOD THE GENERAL CONTRACTOR SHALL CORRECT ANY PROBLEMS DUE TO DEFECTIVE MATERIALS OR PRAILTY WORKMANSHEY AT NO COST TO THE OWNER, ANY PROBLEM THAT OCCURS DURING CONSTRUCTION SHALL MAJECUATED BE CORRECTED TO THE SANSFACTION OF THE GOWERS.

7. NO SUBSTITUTIONS OF SPECIFIED MATERIAL OR EQUIPMENT WILL BE ACCEPTED UNLESS WRITTEN REQUEST FOR APPROVIA. HAS BEEN RECEIVED BY THE ARCHTECT AND CONTRACTOR HAS RECEIVED WRITTEN APPROVIA, FROM ARCHTECT.

8. DURING AND AT THE COMPLETION OF THE CONTRACTOR'S DAILY WORK, CONTRACTOR IS RESPONSIBLE FOR THE CLEANING UP AND REMOVAL OF ALL RUBBISH AND DEBRIS BEFORE LEAVING THE PROJECT JOS SITE. PERMITS & SAFETY:

1. GENERAL CONTRACTOR SHALL APPLY & SUBMIT FOR BUILDING PERMIT.

2. GENERAL CONTRACTOR SHALL OBTAIN "ALL RISK" INSURANCE AND ALL CUSTOMARY STATUTORY INSURANCE FOR COMPREHENSIVE GENERAL LIABILITY, ETC. AS REQUIRED BY

GENERAL CONTRACTOR SHALL PROVIDE ADEQUATE PROTECTION OF WORK, MATERIALS, FIXTURES, ETC. IN LEASED SPACE FROM LOSS OR DAMAGE FROM FIRE, THEFT OR VANDALISM.

4. ALL WORK SHALL BE DONE IN COMPLIANCE WITH THE OCCUPATIONAL SAFETY AND HEALTH ACT (OSHA). THE FOLLOWING ARE STRICTLY PROHIBITED WORK PRACTICES.

A. MNY COMBUSTIBLE MATERIALS ABOVE FINISHED CEILING OR IN MNY NON-SPRINKLED LOCATIONS

B. IMPOSING ANY STRUCTURAL LOAD, TEMPORARY OR PERMANENT ON ANY PART OF THE LANDLORD'S WORK OR STRUCTURE WITHOUT PRIOR WRITTEN APPROVAL.

C. CUITING ANY HOLES IN LANDLORD'S EXISTING FLOOR SLABS, WALLS OR ROOF WITHOUT PROPER APPROVAL'S PROPER APPROVALS FROM LANDLORD. BEFORE START WY INDERSLAB WORK CONTRACTORS MUST CHECK WITH THE LANDLORD OR SUPERINTENDENT OF THE LANDLORD'S GENERAL CONTRACTOR TO DETERMINE IF ANY COMMON UTUIN OR OTHER TENANT WILLITY LIES EXIST WITHIN THE SPACE.

1. WORK INDICATED IS TO BE EXECUTED IN ACCORDANCE WITH THE LATEST EDITIONS OF ALL APPLICABLE CODES.

2. FIRE EXTINGUISHERS SHALL BE PROVIDED BY G.C. AND INSTALLED PER THE BUILDING

3. ALL WALL FINSHES TO MEET CLASS B FLAME SPREAD RATING FOR "A." USE-GROUP TERMIT SPACES AND CLASS C FLAME SPREAD RATING FOR "M" AND "B" USE-GROUP TENANT SPACES.

4. INTERIOR FINISHES IN EXIT ACCESS CORRIDORS AND OTHER EXIT WAYS IN

6, ALL REQUIREMENTS OF THE MICHIGAN BARRIER FREE ACT & THE AMERICAN'S WITH DISABILITIES ACT SHALL BE MAINTAINED.

7. ALL ENTRANCE AND EXIT DOORS SHALL HAVE BARRIER FREE ACCESSIBILITY.

IN RESPONSIBLE CHARGE DEFERRED SUBMITTAL STATEMENT:

DESIGN PROFESSIONAL IN CHARGE: KEVIN BIDDISON, AIA PRESIDENT BIDDISON ARCHITECTURE + DESIGN

REVIEW OF THE ALUMINAL-FRAMED STOREFRONTS;

(1) COPY OF EACH DEFERRED SUBMITTAL WILL BE SUBMITTED TO THE CITY ALONG WITH AN APPROVAL LETTER OF THE DEFERRED SUBMITTAL BY THE REGISTERED DESIGN PROFESSIONAL BY RESPONSIBLE CHARGE AS REQUIRED.

TYPE 2A FIRE EXTINGUISHERS SHALL BE PROVIDED AND SPACED A MAX. OF 75 APART PER SECTION BOS.1 OF THE 2015 INTERNATIONAL FIRE CODE AND / OR BY THE DIRECTION OF THE

FIRE PROTECTION NOTES:

SHOULD MAY FUTURE TERMIT SPACE BE A RESTAURANT OR SIMILAR USE AND HAVE AN AREA GREATER THAN 5,000 S.F. OR AN OCCUPANT LOAD OF 100 OR GREATER, A FIRE SUPPRESSION SYSTEM WILL BE REQUIRED PER SECTION 903.1.1.2.

PROJECT LOCATION:

Rochester Road Rochester Hills, Michigan

APPLICANT INFORMATION:

Hampton Plaza Associates 1334 Maplelawn Drive Troy, Michigan 48084 Phone: (248) 649-2924 Fax: (248) 649-2373 Contact person: Stuart Frankel

Consultants

SHEET INDEX:

T.101 TITLE SHEET

SP.101 SITE PLAN

CIVIL ENGINEERING COVER CO BOUNDARY / TOPO SURVEY

DEMOLITION PLAN C2

СЗ PAVING AND GRADING PLAN

C4 UTILITY PLAN

C5 SOIL EROSION/DRAINAGE AREA PLAN PROFILE, DETAILS AND CALC. PLAN C6

LANDSCAPE PLAN LS₁

SP.401 SITE DETAILS

SE.101 SITE ELECTRICAL PLAN

PHOTOMETRIC PLAN

FLOOR PLAN A.201 **ELEVATIONS**

TYPE: II-B $\langle 1 \rangle$

(UNPROTECTED)
OCCUPANCY CLASSIFICATION: A2 \rightarrow (1) STORY: 20'-0" (< 55'-0 TABLE 504.3) \rightarrow 8,154 S.F. (PROPOSED LARGEST SINGLE FLOOR AREA)

ALLOWABLE NUMBER OF STORIES ABOVE GRADE PLAN:

—>(2) STORY ALLOWABLE, TABLE 504.4) → 8,500 S.F. ALLOWABLE LARGEST SINGLE FLOOR AREA)

CITY FILE #: 18-002

GOVERNING CODES: 2015 MICHIGAN BUILDING CODE 2015 MICHIGAN PLUMBING CODE 2015 MICHIGAN MECHANICAL CODE

2015 INTERNATIONAL FUEL GAS CODE 2014 N.E.C. MICHIGAN ELECTRICAL CODE

2014 N.E.C. MICHIGAN ELECTRICAL CODE, W/PART 8 STATE AMENDMENTS ICC/ANSI A117.1-2003 AND MICHIGAN BARRIER FREE DESIGN LAW OF 1966 AS AMENDED. 2015 MICHIGAN UNIFORM ENERGY CODE RULES PART 10 WITH ANSI/ASHRAE/IESNA ETANDADD DO 1

STANDARD 90.1 2015 INTERNATIONAL FIRE CODE

NFPA 13 - 2010 NFPA 72 - 2007

MIXED SEPARATED USE PER 2015 BUILDING USE: MBC S508 4:

ASSEMBLY A-2 BUSINESS B MERCANTILE M

8.154 S.F.

2 HOUR FIRE BARRIER REQ'D BETWEEN A-2 & ANY B OR MUSE GROUP/TENANT SPACE (PER TABLE 707 & S.508.4).

BUILDING AREA:

BUSINESS: -B BUILDING USE: RESTAURANT: A-2

TYPE OF CONSTRUCTION:

HAMPTON PLAZA

2015 MBC: IIB (UNPROTECTED) TYPE II-000 NEPA 220:

SITE PLAN REVIEW 10.14.17 12.29.17 ①PER CITY REVIEW 03.09.18 TREV. PER CITY PER CITY 03.13.19


Project no.


2002.17





Sheet no.

T.101

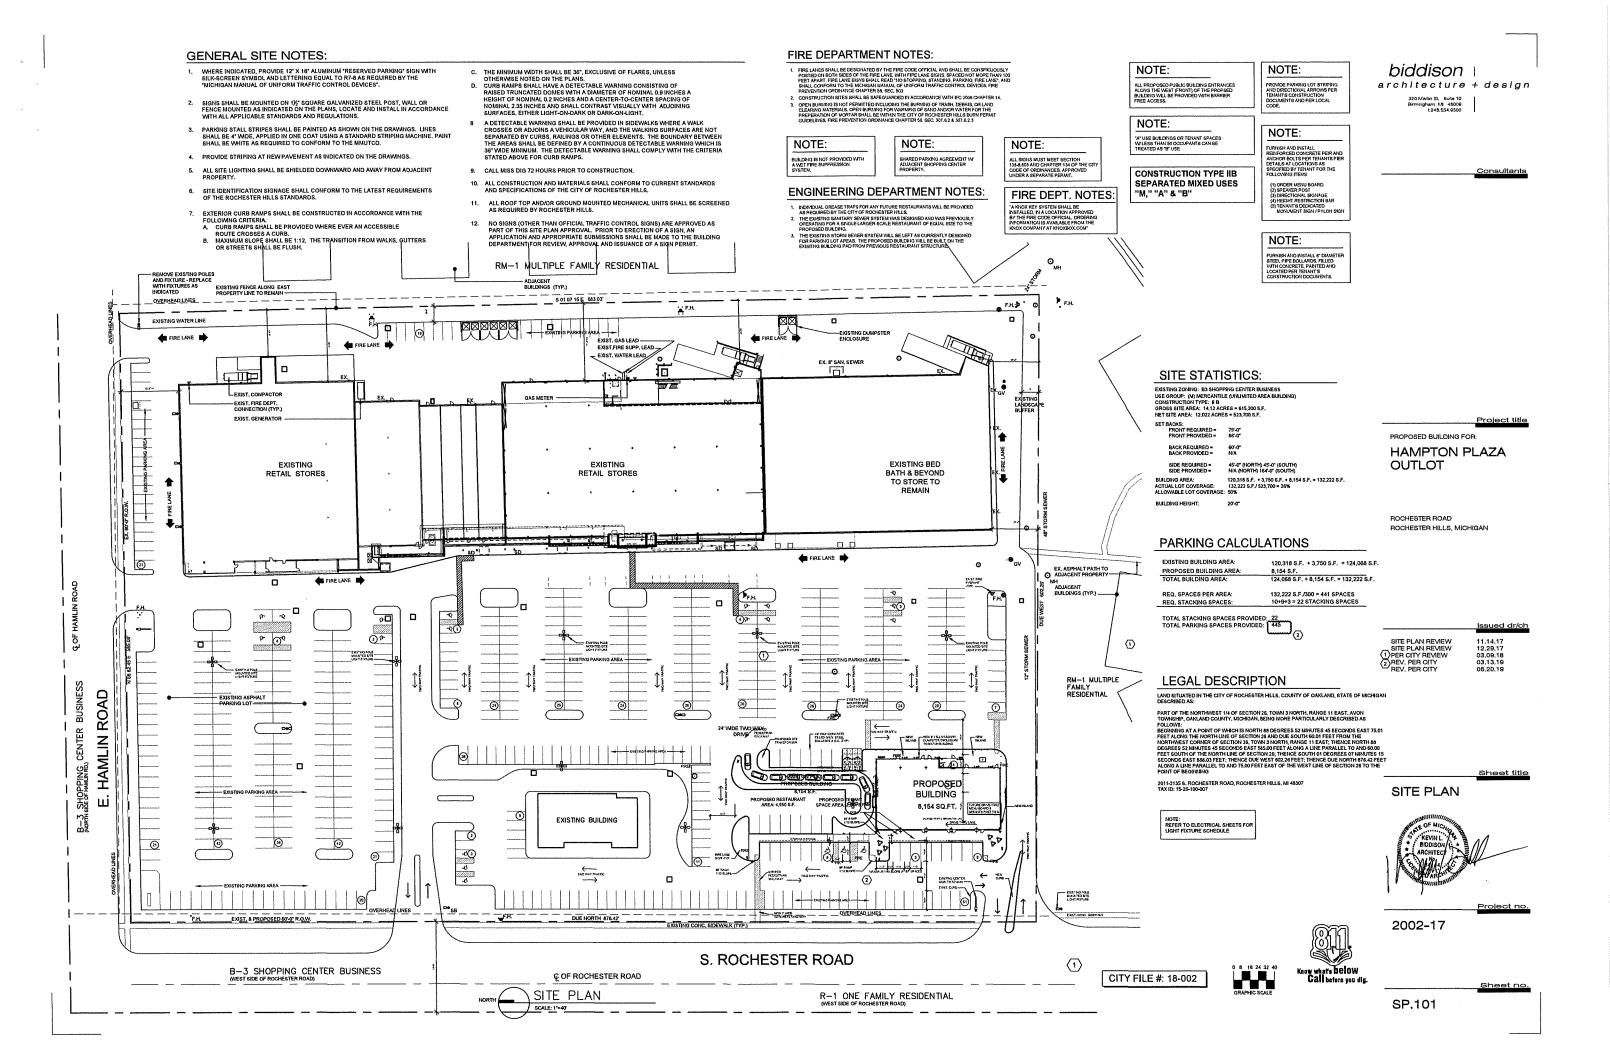

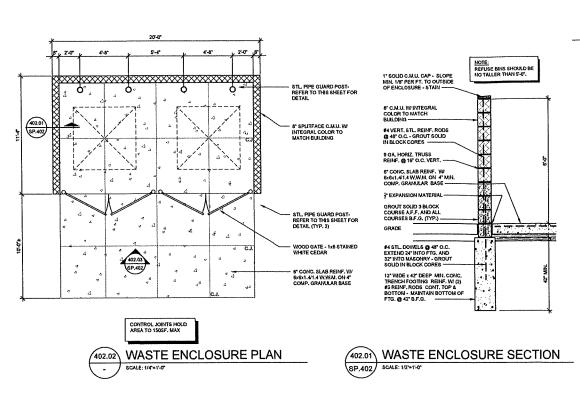


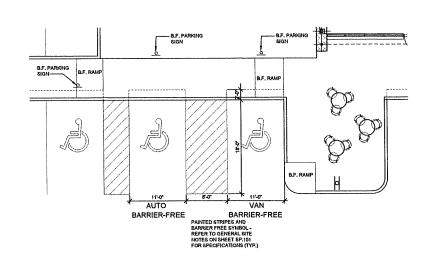

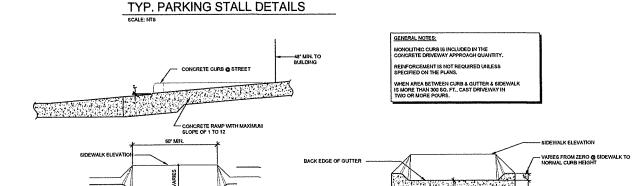





CONCRETE SIDEWALK RAMP

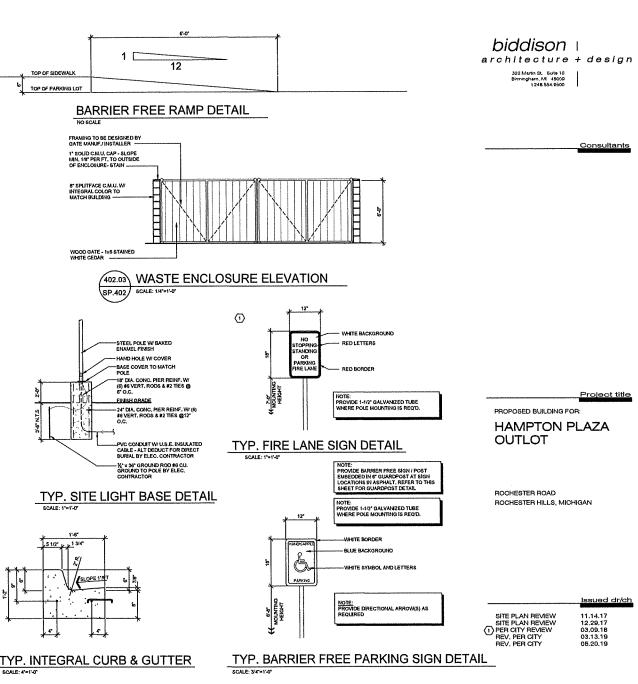

TYP. INTEGRAL CURB & GUTTER

SLOPE TOP OF FTG. TYP. GUARDPOST SECTION

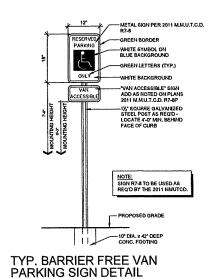

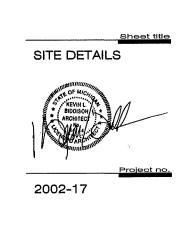

SP.401

CITY FILE #: 18-002

A.101

NOTE: SHOULD ANY FUTURE TENANT SPACE BE A RESTAURANT OR SIMILAR USE AND HAVE AN AREA GREATER THAN 5,000 S.F. OR AN OCCUPANT LOAD O 100 OR GREATER, A FIRE SUPPRESSION SYSTEM WILL BE REQUIRED PER SECTION 903.1.1.2. NOTE: SAFETY GLAZING MUST HAVE PERMANENT IDENTIFICATION IN ACCORDANCE WITH SECTION 2406.1.1 OF THE 2015 MICHIGAN BUILDING CODE. 1 WALL LEGEND INTERIOR GYP. BD. TO HAVE A 'LEVEL N' FINISH AT ALL GYP. BOARD BURFACES AS CALLED OUT ON SKEET A.116. REFER TO CHAPTER 5 OF "USG GYPSUM CONSTRUCTION HANDBOOK" FOR FINISH DEFINITIONS. TEMANT DEMISING WALLS:

1 HR. RATED WALL TO COMPLY WU U # 412.

1 HR. RATED WALL TO COMPLY WE # 412.

W (2) LAVERS OF 5 '40'R. BD. TYPE 'X' EACH SIDE OF 3 58' MTL.

STUD FRAMING (3) 10' CO. WALLS TO EXTEND TO DECK ABOVE.


PROVIDE FIRE COLULS SIM. OR BC. O'10 HILT SET-LEVELING

FIRE SIDE SEALANT (8) ALL WALL PENETRATIONS AND AT FLOOR

DECK ABOVE. EXTERIOR WALLS:

REINF, CONC. MASONRY WALL

- REFER TO ELEVATIONS, SECTIONS AND NOTE BOX FOR FINISHES (2) (5) PROPOSED BUILDING FOR: HAMPTON PLAZA (101h) OUTLOT UTILITY RM. (1019) ROCHESTER ROAD ROCHESTER HILLS, MICHIGAN --- GYP.BD. WALL - EXTENDED TO DECK PROPOSED SINGLE STORY BUILDING SITE PLAN REVIEW SITE PLAN REVIEW 1 PER CITY REVIEW REV. PER CITY REV. PER CITY 11.14.17 12.29.17 03.09.18 03.13.19 06.20.19 EXTERIOR WALL PLUS 3 METAL STUD AND P DRYWALL TO DECK -8,154 SQ.FT. FURNISH AND INSTALL FULLY AUTOMATIC DRIVE-THRU WINDOW AND FLY FAN AS PER TENANT'S SPECIFICATIONS (1010) FLOOR PLAN (1012 (1010) 24'-6" 24'-6" 2002-17 CITY FILE #: 18-002 \ FLOOR PLAN

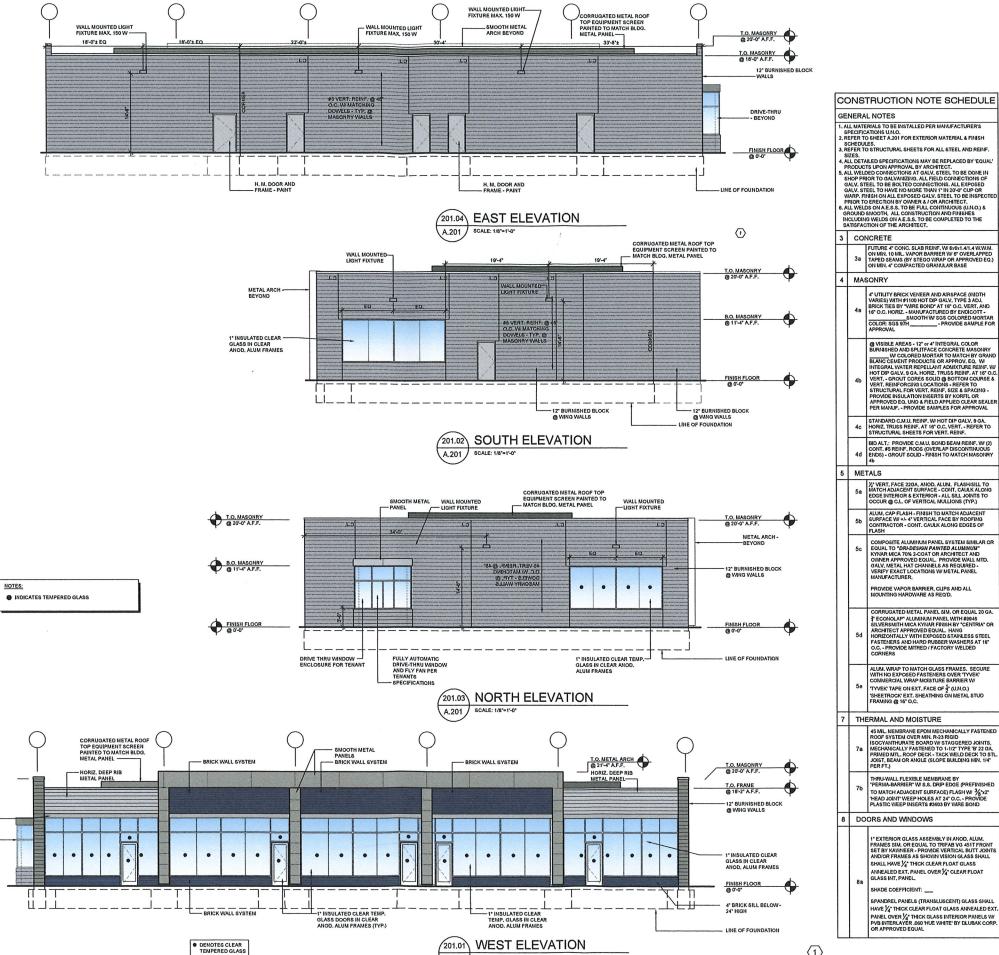

A.201 SCALE: 1/8"=1'-0"

EXPOSED GALVANIZED STEEL LINTEL BEAM FOR THE MASONRY ABOVE

DRIVE-THRU
- BEYOND

ALL MATERIALS TO BE INSTALLED PER MANUFACTURER'S SPECIFICATIONS U.N.O.

REFER TO SHEET A 201 FOR EXTERIOR MATERIAL & FINISH SCHEDULES. REFER TO STRUCTURAL SHEETS FOR ALL STEEL AND REINF. 3, REFER TO STRUCTURAL SHEETS FOR ALL STEEL AND REINF. SIZES.

4. ALL DETAILED SPECIFICATIONS MAY BE REPLACED BY "EQUAL" PRODUCTS UPON APPROVAL BY ARCHITECT.

5. ALL WELDED CONNECTIONS AT GALV. STEEL TO BE DONE IN SHOP PRIOR TO GALVANEZION, ALL FIELD CONNECTIONS OF GALV. STEEL TO BE BOLTED CONNECTIONS. ALL EXPOSED WARP, PINSH ON ALL EXPOSED GALV. STEEL TO BE RISPECTE PRIOR TO ERECTION BY OWNER 8.1 OR ARCHITECT.

6. ALL WELDS ON ALE. S. TO BE OWNER SHOW SIMPLY SHOWS ON ALL SAY, OR GROUND SIMOOTH. ALL CONSTRUCTION AND FINISHES INCLUDING WELDS ON A SE. S. TO BE COMPLETED TO THE SATISFACTION OF THE ARCHITECT. 3 CONCRETE FUTURE 4" CONC. SLAB REINF, W 6:641.4/1.4 W.W.M.
ON MIN. 10 MIL. VAPOR BARRIER W 6" OVERLAPPED
TAPED SEAMS (BY STEGO WRAP OR APPROVED EQ.)
ON MIN. 4" COMPACTED GRANULAR BASE MASONRY 4" UTILITY BRICK VENEER AND AIRSPACE (MOTH VARIES) WITH \$1100 HOT DIP GALV, TYPE 3 ADJ. BRICK TIES BY "AIRE BOND TA 116" O.C. VERT, AND 16" O.C. HORIZ. - MANUFACTURED BY ENDICOTT -SMOOTH WY SGS COLORED MORTA COLOR: SGS 97H - PROVIDE SAMPLE FO APPROVIDE @ MSIBLE AREAS - 12" or 4" INTEGRAL COLOR BURNISHED AND SPUTFACE CONCRETE MASONY BURNISHED AND SPUTFACE CONCRETE MASONY BURNISHED COLORED MORTHAT TO MATCHE BY GRAW BLANC CEMENT PRODUCTS OR APPROV. EQ. W. HOT DIP CALV. 9 CA. HORZ. TRUSS REINF. AT 15" O. VERT. - GROUT CORES SOLD @ BOTTOM CORRES EVERT. REINF CRUSH CONTROL CONTROL CONTROL CONTROL CONTROL CONTROL CONTROL CONTROL TO WAS THE SIZE A SPACING - PROVIDE INSULATION INSERTS BY MORFIL OR APPROVED EQ. UNO A FIELD APPLIED CLEAR SEALE PER MANJF. - PROVIDE SAMPLES FOR APPROVAL PROPOSED BUILDING FOR: HAMPTON PLAZA OUTLOT ROCHESTER ROAD 5 METALS ROCHESTER HILLS, MICHIGAN 5a DCCUR @ C.L. OF VERTICAL MULLIONS (TYP.) COMPOSITE ALUMINUM PANEL BYSTEM SIMILAR OR EQUAL TO "DRI-DESIGN PAINTED ALUMINUM" KYNAR MICA TO "2-COAT OR RACHTECT AND OWNER APPROVED EQUAL. PROVIDE WALL MTD. OALV, META LAT CHANNELS AS REQUIRED. VARIFY EXACT LOCATIONS W METAL PANEL MANGRACTURED. PROVIDE VAPOR BARRIER, CLIPS AND ALL MOUNTING HARDWARE AS REQ'D. SITE PLAN REVIEW 11,14,17 SITE PLAN REVIEW

SITE PLAN REVIEW

PER CITY REVIEW

REV. PER CITY

REVISED PER CITY CORRUGATED METAL PANEL SIM. OR EQUAL 20 GA.

F ECONOLAP ALURINAM PANEL WITH 48048
SILVERSWITH MOAL SYNAR FRISH BY "CENTRIA" OR
ARCHITECT APPROVED EQUAL. HANG
HORIZONTALLY WITH EXPOSED STAINLESS STEEL
FASTENERS AND HARD RUSBER WASHERS AT 16"
O.C. - PROVIDE MITRED / FACTORY WELDED
CORNERS ALUM, WRAP TO MATCH GLASS FRAMES, SECURE WITH NO EXPOSED FASTENERS OVER TYYEK COMMERCIAL WRAP MOISTURE BARRIER W/ TYVEK TAPE ON EXT. FACE OF \$\frac{1}{2}\ (U.N.O.)

"SHEETROCK EXT. SHEATHING ON METAL STUD
FRAMING @ 16" O.C. THERMAL AND MOISTURE 45 MIL NEMBRANE EPOM MECHANICALLY FASTENED ROOF SYSTEM OVER MIN. R-23 RIGID ISOCYANTHAPATE BOARD WIS TAGGERED JOINTS, MECHANICALLY FASTENED TO 1-1/2" TYPE "32 20 A. FRIMED MIN. ROOF DECK 1-TACK VELID DECK TO STI. JOST, BEAM OR ANGLE (SLOPE BUILDING MIN. 114" PER FT.) Sheet title **ELEVATIONS** THRU-WALL FLEXIBLE MEMBRANE BY 'PERMA-BARRIER' W/ S.S. DRIP EDGE (PREFINIS DOORS AND WINDOWS 1° EXTERIOR GLASS ASSEMBLY IN ANOD, ALUM, FRAMES SIM. OR EQUAL TO TRIFAB YG 451T FROM SET BY KAWNEER - PROVIDE VERTICAL BUTT JOHN AND/OR FRAMES AS SHOWN VISION GLASS SHALL SHALL HAVE 1/2" THICK CLEAR FLOAT GLASS Project no. ANNEALED EXT. PANEL OVER 1/2" CLEAR FLOAT LASS INT. PANEL 2002-17 SHADE COEFFICIENT: ___ SPANDREL PANELS (TRANSLUSCENT) GLASS SHALL HAVE 1/2" THICK CLEAR FLOAT GLASS ANNEALED EXT PANEL OVER 1/2" THICK GLASS INTERIOR PANELS W PVB INTERLAYER .060 HUE WHITE' BY DLUBAK CORF OR APPROVED EQUAL

CITY FILE #: 18-002

1

A.201

Sheet no.