DMR-South Blvd.

ZONING INFORMATION ZONING DISTRICT

30% MAX 3.6% PROPOSED

SIGN (ST/DE)

COUNTY:

NOTE: TRASH TO BE STORED INSIDE BUILDING UNTIL TRASH PICKUP NOTE: ALL SIGNS MUST MEET CHAPTER 134 OF THE CITY CODE OF ORDINANCES AND BE APPROVED BY THE BUILDING DEPARTMENT,

66,7%

HEIGHT

LOT COVG

OPEN SPACE

PARKING INFORMATION: 20 SPACES REQUIRED & SHOWN

1 SPACE REQUIRED PER 3 PERSONS

Rochester Hills, Michigan

Drau	wing Schedule	Issued	Issued	Issued	Issued	Issued
		Permit Revised	Permit Revised	Construct. Documents	Site Plan App. Revis.	Site Plan App. Revis.
SP-1	SITE PLAN & TITLE SHEET	10-05-17	01-31-18	02-05-18	04-20-18	06-13-18
	PHOTOMETRIC	10-05-17	01-31-18	02-05-18	04-20-18	06-13-18
F-1	FOUNDATION PLAN			02-05-18	04-20-18	06-13-18
A-1	FIRST FLOOR PLAN	10-05-17	01-31-18	02-05-18	04-20-18	06-13-18
A-2	ELEVATIONS	10-05-17		02-05-18	04-20-18	06-13-18
A-3	ENLARGED PLANS, ELEV. & MALL SECT.			02-05-18	04-20-18	06-13-18
M-1	MECHANICAL PLAN			02-05-18	04-20-18	06-13-18
E-1	ELECTRICAL & LIGHTING PLAN			02-05-18	04-20-18	06-13-18
P-1	PLUMBING PLAN			02-05-18	04-20-18	06-13-18
C-1	SURVEY	10-05-17	01-31-18	02-05-18	04-20-18	06-13-18
C-2	SITE PLAN				04-20-18	06-13-18
C-3	SOIL EROSION CONTROL PLAN					06-13-18
L5-1	LANDSCAPE PLAN	10-05-17	01-31-18	02-05-18	04-20-18	06-13-18
L5-2	LANDSCAPE DETAIL	10-05-17	01-31-18	02-05-18	04-20-18	06-13-18

SPECIFICATIONS COMMERCIAL				
POSTS	4'X4'X.125 MALL			
HORIZONTAL RAILS	1.625" x 1.625"			
TOP WALLS				
PICKETS PICKET SPACING	1"x1"x.062 MALL 3 3/4"			
AVAILABLE HEIGHTS	4, 4 1/2, 5, 6, 7, 8, 9, 10 FT.			

HT	Α	В	c	D	E
4'	7 5/8"	38 3/4"	7 5/8"	PER LOC	AL CODE
4 1/2	75/8"	44 3/4"	7 5/8"	PER LOC	AL CODE
5'	75/8"	50 3/4"	7 5/8"	PER LOC	AL CODE
6'	75/8"	62 3/4"	7 5/8"	PER LOC	AL CODE
7	10 5/8"	71 3/4"	10 5/8"	PER LOC	AL CODE
8'	10 5/8"	83 3/4"	10 5/8"	PER LOC	AL CODE
4	13 5/8"	92 3/4"	13 5/8"	PER LOC	AL CODE
10	13 5/8"	104 3/4"	13 5/8"	PER LOG	AL CODE


BUILDING CODE INFORMATION

CONSTRUCTION TYPE:

2015 MICHIGAN MECHANION. CODE 2015 MTERNATIONAL FUEL 645 CODE 2014 NATIONAL ELECTRICAL CODE WITH PART 8 AMENDMENTS

2015 MCHIGAN BUILDING CODE CHAPTER 13 2015 MCHIGAN ENERIE'S CODE CHAPTER 4 & MICHIGAN ENERGY CODE, PART 108. RULES (ANY-KAPIRAE IES STANDARDTER, 12019) OCCUPANCY CLASSIFICATION: A3-ASSEMBLY

6,000 SQ, FT. BUILDING AREA 1,370 SQ. FT.

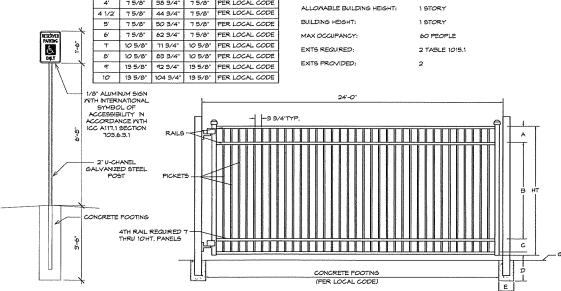

CONSTRUCTION OF GATES SHALL BE OF MATERIALS THAT ALLOW MANUAL OPERATION BY ONE PERSON.

ELECTRIC GATES SHALL BE EQUIPPED WITH A MEANS OF OPENING THE GATE BY FIRE DEPARTMENT PERSONNEL FOR EMERGENCY ACCESS. EMERGENCY
OFFINIS-DEVICES SHALL DE APPROVED BY THE FIRE GODE OFFICIAL.

PROVIDE A KNOX BOX KEY SYSTEM FOR THE BUILDING. THE LOCATION SHALL BE AFFROVED BY THE FIRE CODE OFFICIAL ORDERING INFORMATION IS AVAILABLE FROM THE KNOX COMPANY AT KNOXBOX.COM. MANUAL OPENING SATES SHALL BE PROVIDED WITH A MOX PADLOCK SYSTEM MANUAL ODENING SATES SHALL BE PROVIDE ONE KNOX PADLOCK SYSTEM WHICH ALLOWS FOR FIRE DEPARTMENT ACCESS, PROVIDE ONE KNOX PADLOCK ORDERING INFORMATION CAN BE OSTAINED FROM THE KNOX COMPANY, PLEASE VISIT KNOXBOX.COM FOR KNOX PADLOCK ORDERING INFORMATION.

FIRE LANES SHALL BE DESIGNATED BY THE FIRE CODE OFFICIAL, AND SHALL BE CONSPICUOUSLY POSTED ON BOTH SIDES OF THE FIRE LANE, M'TH FIRE LANE SIGNS SPACED NOT MORE THAN 100 FEET APART, FIRE LANE SIGNS SHALL READ 'NO STOPPING, STANDING, PARKING, FIRE LANE', AND SHALL CONFORM TO THE MICKINGAN MANUAL OF UNIFORM TRAFFIC CONTROL DEVICES, (FIRE PREVENTION ORDINANCE CHAPTER CHAPTER 59, SEC. 503)

CONSTRUCTION SITES SHALL BE SAFEGUARDED IN ACCORDANCE WITH IFC

OPEN BURNING IS NOT PERMITTED INCLUDING THE BURNING OF TRASH, DEBRIS, OR LAND CLEARING MATERIALS, OPEN BURNING FOR WARMING OF SAND AND/OR RATER FOR THE PREPARATION OF MORTAR SHALL BE WITHIN THE CITY OF ROCHESTER HILLS BURN FERMIT GUIDELINES, (FIRE FREVENTION ORDINANCE: CHAPTER S6, SEC. 3016.2 § 3016.2)

LOT 7

BENCHMARK

SEE LANDSCAPING

SOUTH BOULEVARD - 120' WIDE



PiN: 15-32-481-024

4 LOCATION MAP 5CALE: N.T.S.

801.68

7435 X

© 2018 Moiseev/Gordon Associates, Inc. Use of these drawings is limited to the client for the subject projec Use figured dimensions only. Do not scale the drawings. **Detroit Meeting** Rooms

248.549.4500 voice 248.549.7300 facs. www.mga-architects.net

Project Title: **DMR South** Blvd.

South Boulevard


SITE PLAN & TITLE SHEET

Project Number: 15443 Drawn By: AJM, MJN, SLC Checked By: AJM Approved By: MJG Date:07-11-16


issued: Ouner Review Ouner Review 8-9-16 10-12-16 Owner Review 11-04-16 Planning Review Owner Review 02-01-17 02-24-17 Site Plan Approva Permit Revised 04-24-17 Permit Revised Construction Documents
Site Play App. Revis. 04-26-18
Revised for City Rev. 06-18-18

6/14/2018 11:17:06 City Section #32

BENCHMARK

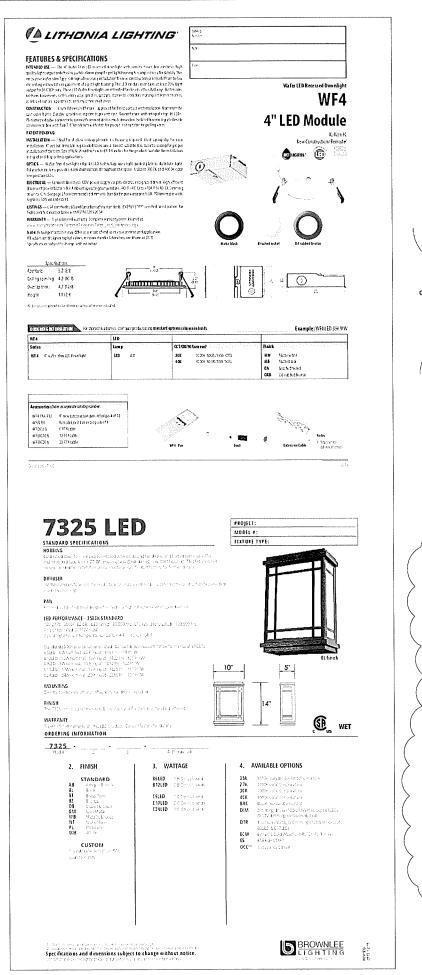

.1 0.0 0.0 0.1 0.1 0.1 0.2 0.2 0.3 0.3 0.3 0.2 0.3 0.3 0.2 0.2 0.2 0.2 0.2 0.2 0.2 0.2 0.3 0.3 0.3 0.3 0.3 0.2 0.3 0.3 0.2 0.3 0.3 0.3 0.2 0.3 0.3 0.3 0.2 0.2 0.1 0.1 0.1 0.0 0.0 0.0 0.0 0.0 0.0 MEETING 0.0 0.0 0.1 0.1 0.2 0.2 0.3 0.4 0.4 0.4 0.4 0.4 0.4 0.4 0.3 0.3 0.2 0.2 0.2 0.3 0.3 0.4 0.4 0.4 0.4 0.4 0.4 0.9 0.3 0.4 0.4 0.4 0.4 0.4 0.4 0.4 0.3 0.2 0.2 0.1 0.1 0.0 0.0 0.0 0.0 0.0 0.0 ROOM .1 0.0 0.0 0.1 0.1 0.2 0.3 0.3 0.4 0.5 0.5 0.5 0.5 0.5 0.4 0.4 0.3 0.2 0.2 0.2 0.3 0.4 0.5 0.5 0.5 0.5 0.5 0.5 0.3 0.4 0.5 0.5 0.5 0.5 0.5 0.4 0.4 0.3 0.2 0.1 0.1 0.0 0.0 0.0 0.0 0.0 0.0 0.0 00 0.0 0.0 0.1 0.1 0.2 0.3 0.3 0.4 0.4 0.4 0.5 0.5 0.4 0.4 0.4 0.3 0.3 0.2 0.3 0.3 0.4 0.4 0.4 0.5 0.5 0.6 0.4 0.3 0.4 0.4 0.4 0.4 0.4 0.4 0.4 0.3 0.3 0.2 0.1 0.1 0.0 0.0 0.0 0.0 0.0 1.1 0.2 0.3 0.4 0.5 0.7 0.9 1.1 1.4 1.7 2.0 2.1 2.0 1.7 1.5 1.2 1.1 1.1 1.0 1.1 1.1 1.2 1.5 1.7 2.1 2.2 2.1 1.9 1.7 10.5 1.3 1.2 1.1 1.1 1.0 1.0 1.1 1.4 1.6 2.0 2.1 2.0 1.8 1.5 1.1 0.9 0.7 0.6 0.4 0.3 0.2 0.1 0.1 0.0 0.0 0.1 0.1 0.2 0.3 0.4 0.6 0.8 0.9 1.1 1 4.4 1.6 1.7 1.7 1.7 1.6 1.4 1.2 1.2 1.1 1.1 1.1 1.2 1.2 1.4 1.7 1.8 1.8 1.8 1.7 1.5 1.3 1.2 1.0 0.8 0.9 0.9 0.9 0.9 1.0 1 1.3 1.6 1.7 1.8 1.7 1.6 1.7 1.8 1.7 1.6 1.4 1.1 1.0 0.8 0.6 0.4 0.3 0.2 0.1 0.1 0.0 0.0 0.0

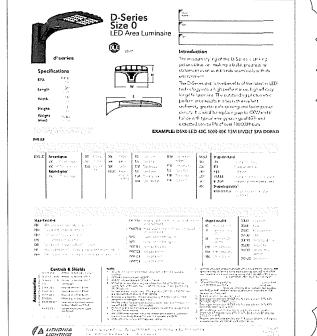

SEE SCHEDULE FOR LUMINAIRE MOUNTING HEIGHT

THE ENGINEER AND/OR ARCHITECT MUST DETERMINE APPLICABILITY OF THE LAYOUT TO EXISTING / FUTURE FIELD CONDITIONS. THIS LIGHTING LAYOUT REPRESENTS ILLUMINATION LEVELS CALCULATED FROM LABORATORY DATA TAKEN UNDER CONTROLLED CONDITIONS IN ACCORDANCE WITH ILLUMINATING ENGINEERING SOCIETY APPROVED METHODS. ACTUAL PERFORMANCE OF ANY MANUFACTURER'S LUMINADRE MAY VARY DUE TO VARIATION IN ELECTRICAL VOLTAGE, TOLERANCE IN LAMPS, AND OTHER

THESE LIGHTING CALCULATIONS ARE NOT A SUBSTITUTE FOR INDEPENDENT ENGINEERING ANALYSIS OF LIGHTING SYSTEM SUITABILITY AND SAFETY. THE ENGINEER AND/OR ARCHITEC' IS RESPONSIBLE TO REVIEW FOR MICHIGAN ENERGY CODE AND LIGHTING QUALITY COMPLIANCE.

Description	Symbol	Avg	Max	Min	Max/Min	Avg/Min	Avg/Max
Grade	+	0.4 fc	4.8 fc	0.0 fc	N/A	N/A	0.1:1
Parking Area	ж	1.0 fc	2.2 fc	0.5 fc	4.4:1	2.0:1	0.5:1
Prop Line East @ 5' AFG	+	0.1 fc	0.1 fc	0.0 fc	N/A	N/A	1.0:1
Prop Line North @ 5' AFG	+	0.0 fc	0.1 fc	0.0 fc	N/A	N/A	0.0:1
Prop Line South @ 5' AFG	+	0.2 fc	0.4 fc	0.1 fc	4.0:1	2.0:1	0.5:1
Prop Line West @ 5' AFG	+	0.1 fc	0.2 fc	0.0 fc	N/A	N/A	0.5:1

Symbol QTY Manufacture Mounting Height " MATTE WHITE LED ULTRA-THEN WAFER WF4_LED_40K k F4 LED 40K DSX0 LED 20C 700 40K TFTM Lithonia Lighting OSXO LED with 20 LEDs 60700 mA 4000K Р 325-C24 ED-35 7325,C22J FD-35K ies W

Revised 05-22-2018

Designer 6/21/2017 Not to Scale Drawing No. #17-75414-V1 1 of 1

CONCRETE SPECIFICATIONS


- ALL CONCRETE WORK SHALL CONFORM TO THE REQUIREMENTS OF ACI 301, "SPECIFICATIONS FOR STRUCTURAL CONCRETE BUILDINGS," EXCEPT AS MODIFIED BY SUPPLEMENTAL REQUIREMENTS.
- ALL CONCRETE NOT SUBLECT TO AMBIENT TEMPERATURES SHALL HAVE A
 MINIMIM OF 3000 PSI, 20 DAY COMPRESSIVE STRENGTH, UNDO, (SIT LBS.
 OF CEMENT PER CUBIC YARD MINIMIM (55 56ACKS) & NATER/CEMENT
 RATIO NOT TO EXCEED 6 GALLONS PER SACK). EXTERIOR CONCRETE
 \$1.485 SHALL HAVE A MINIMIM OF 4000 PSI, 20 DAY COMPRESSIVE
 STRENGTH, AND 4% AIR ENTRANMENT.

- REINFORCING STEEL SPECIFICATIONS

 1. ALL REINFORCING BARS, DONELS, AND TIES SHALL CONFORM WITH ASTM-615 GRADE 60 REQUIREMENTS AND SHALL BE FREE OF RUST, DIRT AND MUD.
- AND MUD.

 2. ALL NELDED WRE FABRIC SHALL CONFORM WITH ASTM A-185 AND BE POSITIONED AT THE MID HEIGHT OF SLABS, UN.O.

 3. ALL REINFORCING SHALL BE PLACED AND SECURELY TIED IN PLACE SUFFICIENTLY AHEAD OF PLACING OF CONCRETE TO ALLON INSPECTION AND CORRECTION, IF NECESSARY, WITHOUT DELAYING THE CONCRETE PLACEMENT.
- EXTEND ALL REINFORCING BARS A MINIMUM OF 36" AROUND ALL CORNERS AND LAP BARS AT ALL SPLICES A MINIMUM OF 24", U.N.O.
- 5. WELDING OF REINFORGING STEEL IS NOT ALLOWED.

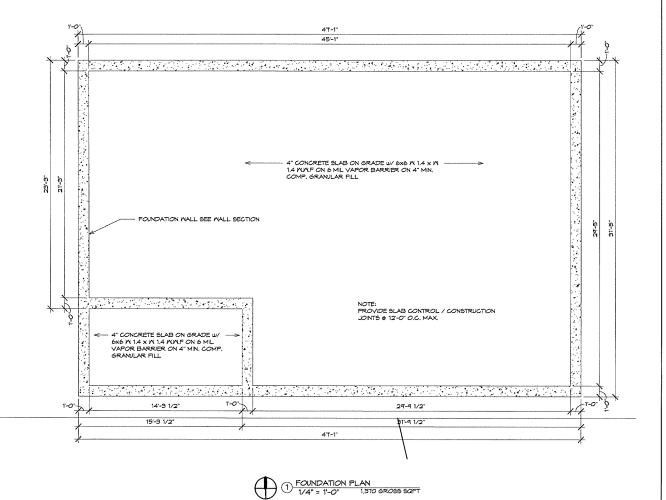



Moiseev/Gordon Associates, Inc. 4351 Delemere Court Royal Oak, MI 48073

248,549,4500 voice 248,549,7300 facs.

www.mga-architects.net

Copyright

© 2018
Moiseev/Gordon Associates, Inc.
Use of these drawings is limited
to the client for the subject project.
Common law copyright is reserved
by the Architect.

Use figured dimensions only, Do not scale the drawings.

Detroit Meeting Rooms

Project Title: **DMR South** Blvd.

South Boulevard Rochester Hills, MI

Sheet Title: FOUNDATION PLAN

Project Number: 15443 Drawn By: AJM, MJN, SLC Checked By: AJM Approved By: MJG Date:07-11-16

Issued:
Construction 02-05-18
Documents
Site Plan App. Revis. 04-20-18

City File #17-009 City Section #32

6/14/2018 11:17:04 AM

WOOD SPECIFICATIONS

- NOOD CONSTRUCTION SHALL BE GOVERNED BY THE LATEST EDITIONS OF THE ATT MANUAL AND NOA (NATIONAL DESIGN STANDARDS AS FUBLISHED BY THE NATIONAL PORSET PRODUCTS ASSOCIATION, 1941 EDITION).
- LAMINATED VENEER LIMBER (SUCH AS MICRO LAM) SHALL BE 1 9/4" NIDE AND HAVE THE FOLLOWING STRUCTURAL PROPERTIES: FB=2050 PSI, FV= 285 PSI, E=2,000,000 PSI, UNLESS OTHERWISE NOTED
- LAMINATED MOOD BEAMS (GLI)-LAMS) SHALL BE VISUALLY GRADED MESTERN SPECIES 24F-V/8 ATC DESIGNATION WTH THE FOLLOWING STRUCTURAL PROFERIES: FB-240-0 PS; IV-4 IS F9], E-1 BOO,000 PS.
- 4. STUDS SHALL BE SPF/STUD (MAPA) OR BETTER GRADE, U.N.O. AT MC 14% MAXMUM.
- STRUCTURAL DIMENSION LUMBER AS HEADERS AND JOISTS SHALL BE A MINIMUM OF #2 HEM FIR AT MC 19% MAXIMUM.
- 6. ALL STRUCTURAL LUMBER IN CONTACT WITH CONCRETE OR MASONRY, OR LESS THAN 8" ABOVE GRADE SHALL BE PRESSURE TREATED TO A MINIMUM OF 0.40 POUNDS FER CUBIC FOOT RETENTION WITH AMMONIACAL COPPER ARSENATE (ACA), OR CODE APPROVED EQUAL FOR USE.
- ALL LIMBER AT OR BELOW GRADE SHALL BE PRESSURE TREATED TO A MINIMUM OF 0.60 POUNDS FER CUBIC FOOT RETENTION WITH AMMONIACAL COPPER ARSENATE (CCA), OR APPROVED EQUAL TREATMENT.
- ALL TREATED LIMBER WHICH IS CUT, DRILLED OR NOTCHED SHALL BE FIELD TREATED (BRUSHED ON EXPOSED SURFACES) BY ONE OF THE PRESERVATIVES LISTED ABOVE.
- AT EACH WALL OPENING ADD ONE HALF THE TOTAL NUMBER OF STUDS DISPLACED TO EACH SIDE OF THE OPENING (FULL HEIGHT) AND ADD 1 JACK STUD BELOW THE HEADER, U.N.O.
- NOTCHING AND DRILLING OF L.Y.L. MEMBERS IS PROHIBITED WITHOUT PRIOR WRITTEN CONSENT OF THE ENGINEER.
- 11. ALL CONNECTONS NOT NOTED ON THE DRAWINGS SHALL BE MADE WITH PRE-FABRICATED STEEL HANGERS SIZED FOR THE CARRIED LOAD AND MEMBER SIZE (I.E. A DOUBLE 2XIO MUST HAVE A SIMPSON U-210-2 HANGER (OR EQUAL) ETC.)
- 12. MINIMUM HEADER, SIZE TO BE (2) 2x105 FOR OPENINGS UP TO SIX FOOT IN LENGTH UNLESS NOTED OTHERWSE

Door Material Legend

MD/GL - MOOD/GLASS MD - MOOD

NOTE: FRE EXTINGUISHERS MILL BE LOCATED AND INSTALLED PER THE LOCAL FIRE AUTHORITY IN RECESSED CABINETRY.

Door Schedule									
	1	T	E	200r	Fr	ame	Hdwr	1	
Dr. No.	Door Size	Door Location	Type	Material	Туре	Material	Type	Rating	Remarks
100	(2)3' - O" x T - O"	RECEPTION	A	ND/GL5	Α	ND	A		
101	6'-0" x T -0"	RECEPTION	В	MD	Α	MD	D		
102	3'-0" x 6'-8"	B.F. WASHRM	0	ND	Α	MD	6		
103	3'-0" x 6'-8"	B.F. WASHRM	- C	ND	A	ND	6		
104	3'-0"x6'-8"	MECH.	- C	ND	Α	ND	D		
105	3'-0" x 6'-8"	MEETING ROOM	C	ND	A	NO	A		

	Hardware	Schedule	
EXTERIOR DOOR - Set A Butts Lockset Closer Push / Pull Hardware Weather Stripping Aluminum Threshold	INTERIOR DOOR - Set B NOT USED	INTERIOR DOOR - Set C NOT USED	INTERIOR DOOR - Set D Butts Lockset Bumper
INTERIOR DOOR - Set E NOT USED	INTERIOR DOOR - Set F NOT USED	INTERIOR DOOR - Set 6 Butts Latchset w/ Thumblock in Handle Bumper Closer	INTERIOR DOOR - Set H NOT USED


ALL DOORS TO HAVE LEVER HANDLE LOCK AND LATCHSETS TO MEET WITH BARRIER FREE REQUIREMENTS. SEE SPECIFICATIONS

ALL DOORS TO BE SOLID CORE WITH A STAIN / POLYURETHANE FINISH TO BE APPROVED BY OWNER, WOOD FRAMES TO BE PAINTED FINISH.


DOOR OFENING FORCE WILL BE AS FOLLOWS:

1. INTERIOR HINGED DOORS (CHTER THAN FIRE DOORS) > 5.0 LBS OR 22.2 N.

2. SLDING OR HINGED DOORS = RELEASED WITH A FORCE OF 15 LBS OR 61 N SET IN MOTION WITH A FORCE OF 30 LBS OR 133

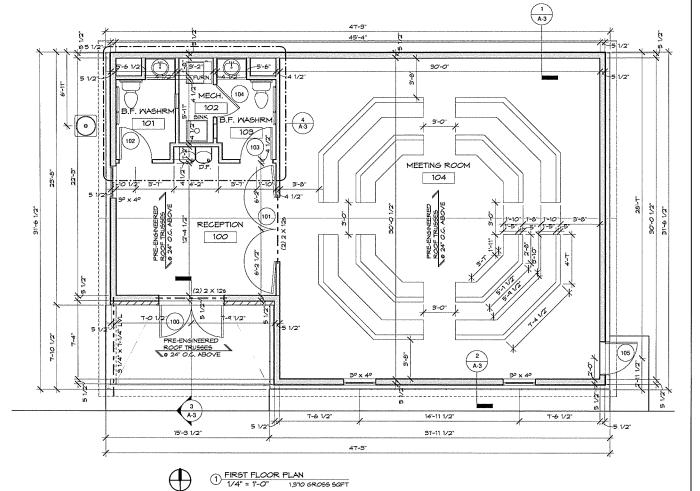

					Ro	om Fini	sh Sch	edule		· · ·	·	
		T	,	\all		T i	E	3ase				1
Rm #	Room Name	North	South	East	Mest	North	5outh	East	Mest	Floor	Celling	Remarks
										•		
100	RECEPTION	GP/P	GP/P	GP/P	GP/P	VΒ	VB	VΒ	∨B	CPT	GP	
101	B.F. WASHRM	GP/P	GP/P	GP/P	GP/P	VB	VB	V₿	VB	VT	GP	
102	месн.	GP/P	GP/P	GP/P	GP/P	VB	VB	VΒ	∨ B	VT	GP	
103	B.F. WASHRM	GP/P	GP/P	GP/P	GP/P	VB	VB	VΒ	√B	VT	GP	
104	MEETING ROOM	GP/P	GP/P	GP/P	GP/P	VB	VΒ	VB	VB	CPT	GP	

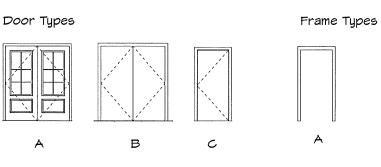



NOTE:
BARRIER FREE WASHROOM
SIGNAGE W/ BRAILLE MOUNTED
MINIMUM 4-0' ABOVE FLOOR TO
BOTTOM OF SIGN, LOCATE
MINIMUM OF 4" FROM SWNG SIDE
OF DOOR

City File #17-009 City Section #32



Moiseev/Gordon Associates, Inc 4351 Delemere Court Royal Oak, MI 48073

248.549.4500 voice 248.549.7300 facs.

www.mga-architects.net

Copyright

© 2018 Moiseev/Gordon Associates, Inc. Moiseev/Gordon Associates, Inc.
Use of these drawings is limited to the client for the subject project.
Common law copyright is reserved by the Architect.

Use figured dimensions only. Do not scale the drawings.

Detroit Meeting Rooms

Project Title: **DMR** South Blvd.

South Boulevard Rochester Hills, MI

Sheet Title: FIRST FLOOR PLAN

Project Number: 15443 Drawn By: AJM, MJN, SLC Checked By: AJM Approved By: MJG

Date:07-11-16 Issued: Owner Review Owner Review Owner Review 10-12-16 11-04-16 Planning Review 02-01-17 Owner Review
Site Plan Approv
Permit Revised 02-24-17 04-03-17 04-24-17 Permit Revised 10-05-17 Permit Revised 01-31-18
Construction 02-05-18
Documents
Site Plan App. Revis. 04-20-18



6/14/2018 11:16:59

NOTE: TRUSS DRAWINGS TO BE SUBMITTED TO ARCHITECT FOR REVIEW PRIOR TO FABRICATION.

12

NOTE: PROVIDE ROOF VENTILATION TOTAL OF 1/300 OF ROOF W 50% IN EAVE TYP.

NOTE: FROYIDE FLASHING WHERE REQUIRED BY CODE



4351 Delemere Court Royal Oak, MI 48073

248.549.4500 voice 248.549.7300 facs.

www.mga·architects.net

Copyright

ASPHALT ROOFING

STOKE

+ FOUNDATION 4" SLAB ON GRADE FRST FLOOR SLAB

1 x 6 TRIM BOARD 1'-6" x 4'-0" SHUTTER TYP. - 1 x 6 FACIA & TRIM BOARD © 2018
Moiseev/Gordon Associates, Inc.
Use of these drawings is limited to the client for the subject project.
Common law copyright is reserved by the Architect.

Detroit Meeting Rooms

Project Title: **DMR South** Blvd.

South Boulevard Rochester Hills, MI

Sheet Title: **ELEVATIONS**

Project Number: 15443 Drawn By: AJM, MJN, SLC Checked By: AJM Approved By: MJG Date:07-11-16

8-9-16 10-12-16 11-04-16 02-01-17

02-24-17 04-03-17 04-24-17 10-05-17

Issued: Owner Review


Owner Review Owner Review Planning Review
Owner Review
Site Plan Approva
Permit Revised Permit Revised

Construction 02-05-18
Documents
Site Plan App. Revis. 04-20-18



VINYL SHAKE SIDING 1 x 6 FACIA & TRIM BOARD HARD BOARD SIDING 9-0-STONE

MATERIAL.	PERCENT
HARD BOARD SIDING	62%
VINYL SHAKE SIDING	30%
STONE	896

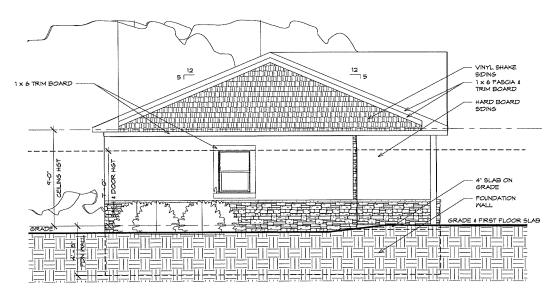


3 MEST ELEVATION

MEST ELEVATION MATERIAL PERCENTAGES

MATERIAL	PERCENT
HARD BOARD SIDING	55%
VINYL SHAKE SIDING	30%
STONE	15%


VINYL SHAKE SIDING 1 x 6 TRIM

SOUTH ELEVATION MATERIAL PERCENTAGES				
MATERIAL	PERCENT			
HARD BOARD SIDING	40%			
VINYL SHAKE SIDING	15%			
STONE	45%			

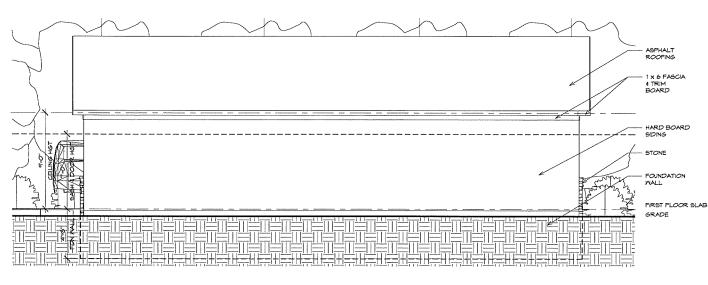

MORTH ELEVATION

PERCENT
100%
0%
0%

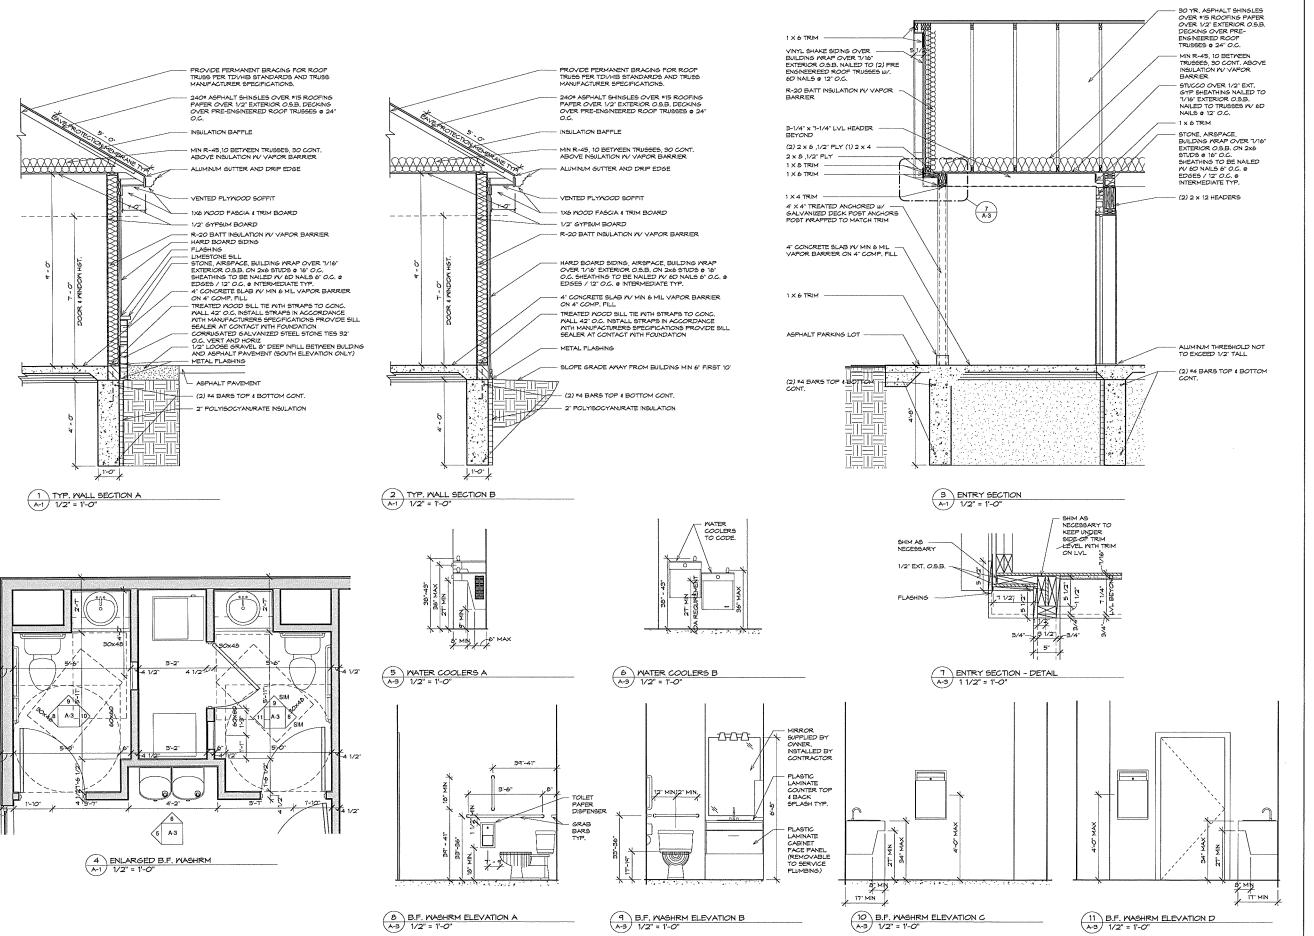

Architects/Designers

Moiseev/Gordon Associates, Inc 4351 Delemere Court Royal Oak, MI 48073

248.549.4500 voice 248.549.7300 facs.

www.mga-architects.net

Copyright

© 2018
Moiseev/Gordon Associates, Inc.
Use of these drawings is limited
to the client for the subject project.
Common law copyright is reserved
by the Architect.

Use figured dimensions only. Do not scale the drawings.

Detroit Meeting Rooms

Project Title: **DMR South** Blvd.

South Boulevard Rochester Hills, MI

Sheet Title: ENLARGED PLANS, ELEVATIONS & WALL SECTIONS

Project Number: 15443 Drawn By: AJM, MJN, SLC Checked By: AJM Approved By: MJG Date:07-11-16

issued: Construction


02-05-18 Documents


Site Plan App. Revis. 04-20-18




6/14/2018 11:17:02 AM

City File #17-009 City Section #32

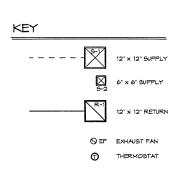

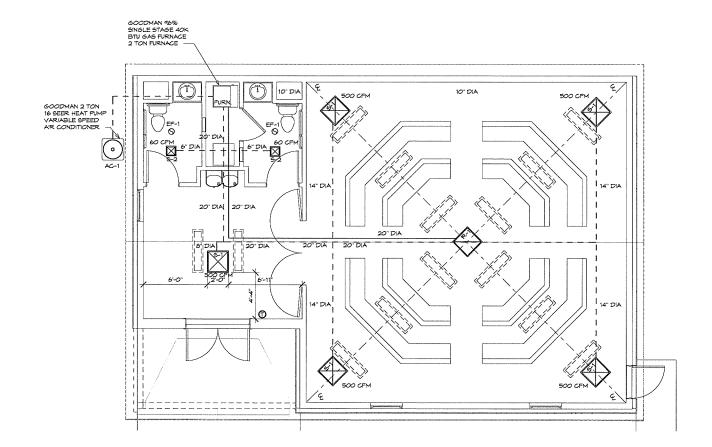

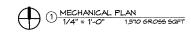



Moiseev/Gordon Associates, inc. 4351 Delemere Court Royal Oak, MI 48073

248.549.4500 voice 248.549.7300 facs.

www.mga-architects.net

Copyright

© 2018

Moiseev/Gordon Associates, Inc.
Use of these drawings is limited to the client for the subject project.
Common law copyright is reserved by the Architect.

Use figured dimensions only. Do not scale the drawings.

Client

Detroit Meeting Rooms

Project Title:
DMR South
Blvd.

South Boulevard Rochester Hills, MI

Sheet Title: MECHANICAL PLAN

Project Number: 15443 Drawn By: AJM, MJN, SLC Checked By: AJM Approved By: MJG Date:07-11-16

Issued:
Construction 02-05-18
Documents
Site Plan App. Revis. 04-20-18

Sheet Number:

6/14/2018 11:17:05 AM

COMMERCIAL NOTES

ELECTRICAL INSTALLATION NOTES FOR CONTRACTOR:

1. ALL NRING TO BE INSTALLED FER THE 2014 NEC. ARTICLE 517 AND THE STATE OF MICHIGAN ELECTRICAL CODE RULES FOR 5 AS EFFECTIVE 2011

2. ALL BRANCH CROUNT NRING SHALL BE MINIMUM *12 ANS THINVTHAN AS SPECIFIED. ALL WIRE TO BE COPPER INLESS SPECIFIED OTHERWISE.

3. ALL CONDUTI INSTALLED IN FILORIS SHALL

4. ALL SERVICE EQUIPMENT TO BE PROPERLY BONDED AND GROUNDED WITH CORRECT SIZE WIRE.

5. BACH SERVICE DISCONSICTING MEANS SHALL BE FERMANENTLY MARKED TO IDENTIFY IT AS A SERVICE DISCONNECTING MEANS AND THE LOAD SERVED, ALL PANELS, LOAD CENTERS, PANEL BOARDS, SMITCHBOARDS SHALL BE LEGISLY IDENTIFIED BY PAINT. BY SHARWAD OR EMBOSSED PLATES, ALL CIRCUITS NOW, EXISTING OR MODIFIED SHALL BE LEGISLY IDENTIFIED BY PAINT. BY SHARWAD OR EMBOSSED PLATES, ALL CIRCUITS NOW, EXISTING OR MODIFIED SHALL BE LEGISLY IDENTIFIED AS TO PURPOSE OR USE ON A CIRCUIT DIRECTORY LOCATED ON THE FACE OR INSIDE OF THE FANEL DOORS

SHALL BE LEGIBLY DENTIFIED AS TO PURPOSE OR USE ON A CIRCUIT DRECTORY LOCATED ON THE FACE OR INSIDE OF THE PANEL DOORS

6. IN CASE OF MORE THAN ONE SERVICE TO A BUILDING, IDENTIFICATION SHALL BE FER N.E.C. 220-2.

7. ALL WRING INSTALLED IN A PLEDWIN OR ENVIRONMENTAL AIR HANDLING SPACE SHALL BE AFFROVED FOR SUCH USE AND COMPLY NITH N.E.C. 300-22.

8. ALL FLOOR, WALL, CELING FENETATIONS TO BE SEALED WITH MATERIAL. FLAME SAFE FIRE STOP SYSTEM TYPE FSIGO INSTALL FIRE INSTALLED IN SUSPENDED CEILINGS THAT ARE ALSO USED FOR ENVIRONMENTAL AIR SHALL CONFORM TO SEE N.E.C. 300-2, ARTICLE TOP FLOWING PERMANDATION.

10. A 120 YOLT 6-F.C.I. PROTECTED RECEPTACLE OUTLET SHALL BE INSTALLED INTHIN 25 FEET OF ANY HAVE OR REPRISERATION EXIPMENT, N.E.C. 210-63.

11. FOR MEDICAL FACILITYS AND MEDICAL OFFICES ONLY: WIRING IN EXAMINING ROOMS AND OR PATIENT CARE AREAS IS REQUIRED TO COMPLY WITH NO.C. ARTICLE SIT, LIGHT FIXTURES MOUNTED BELOW T-1/2 FEET ARE REQUIRED TO COMPLY ALSO.

12. ALL BATTERY BACK UP OFERATED EXIT SIGNS AND BMERGENCY LIGHT UNITS ARE TO BE CONNECTED TO LIGHTING COMPLY ALSO.

12. ALL BATTERY BACK UP OPERATED EXIT SIGNS AND EMERGENCY LIGHT UNITS ARE TO BE CONNECTED TO LIGHTING CRUITS IN AREAS SERVED AND AHEAD OF ANY SATICHING DEVICE. N.F.P.A. LIFE SAFETY CODE SECTION 5-6 THRU

CROUTS IN AREAS SERVED AND AHEAD OF ANY SATCHING DEVICE. N.F.P.A. LIFE SAFETY CODE SECTION 5-8 THRU 510, N.E.C. ARTICLE 100.

19. PLACEMENT OF EMERGENCY LIGHTING UNITS AS SHOWN ON FURNISHED DRAWINGS ARE BASED ON THE PHOTOMETRIC LIGHTING CURVES FURNISHED BY THE FUNDING MANUFACTURER FOR EACH FIXTURE INSTALLED. THESE CURVES ALLOW A REASONABLE REPEDICTION OF THE LEVELS THAT MAY DEEPER EXPORTED FOR TO YAROUS POINTS FROM THE LIGHT SOURCE. ACTUAL LEVELS OF OUTPUT INTENSITY MAY DIFFER BY AS MUCH AS 4-7-195, DUE TO NORMAL VARIABLES INDERENT IN THE MANUFACTURING FROCCESS, ALSO VARIABLES SUCH AS THE FINAL COLOR OF AREA SERVED AND REFLECTIVITY OF CEILING, WALL AND FLOOR SURFACES.

11. THE INTENT OF EMERGENCY LIGHTING IS TO PROVIDE A LEVEL OF ILLUMINATION SUFFICIENT TO ALLOW FEOFILE TO SAFELY EXIT A BUILDING IN CASE OF A POACR FAILURE OR OTHER EMERGENCY.

15. BEFORE FINAL ACCEPTANCE BY LOCAL FREE MARSHALL OR CITY OFFICIAL RELEGATED TO SUCH TASK AN ON SITE CHECK OF ACTUAL ILLUMINATION LEVELS SHALL BE DONE IN THE FINISHED AREAS SERVED BY THE ELECTRICAL CONTRACTOR TO DETERMINE IF CODE REQUIREMENTS HAVE BEEN MET OR IF ADDITIONAL LIGHTING UNITS ARE REQUIRED TO BE INSTALLED. CONTRACTOR TO FURNISH ALL PAPERS AND INFORMATION FURNISHED WITH UNITS TO TENANT OR OWNER BEGAUSE PERIODIC MAINTENANCE AND TESTING IS REQUIRED, AND RECORDS KEPT ON FILE OF SUCH TESTS.

16. CIRCUIT BREAKERS USED TO SMITCH 120Y OR 2TTY FLUORESCENT LIGHTING CIRCUITS MUST BE LISTED AND MARKED

Nater Proof Exterior LED Decorative Mall Sconce (See Lighting Specifications) Mall Mounted Incandescent Wall Sconce Recessed Nater Proof incandescent Fixture (See Lighting Specifications) Surface Mounted Pull Chord Incandescent Fixture Switch ទិន 3-Way Switch Duplex Receptacle PMP Duplex Receptacle With Ground Fault Interupter Switch Φ GFI

1' X 4' Surface Mounted T-5

Florescent Fixture (2) T-5 Per Fixture

15 Watt Combination Exit Emergency Light with Battery Charger-Tester Æ,


Emergency Lights


(3)

CMD

Carbon Monoxide Device May Be Batteny-Fowered, Flig-in Or Mithout Batteny Backup, Mred Into The Duelling's Ac Fower Line Mith Secondary Batteny Backup, Or Connected To A System By Means OF A Control Panel. Per Code.

0 Exhaust Fan

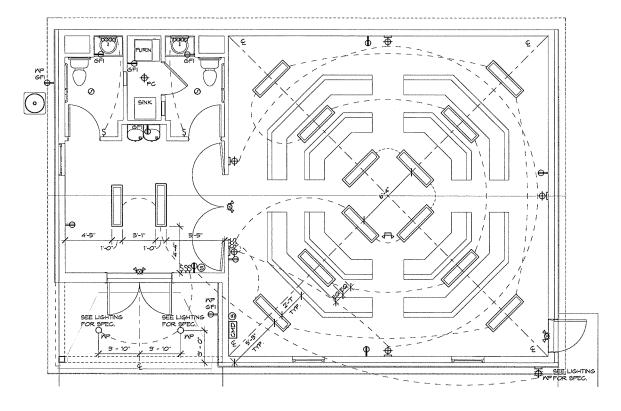

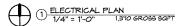



4351 Delemere Court Royal Oak, MI 48073

248,549,4500 voice 248,549,7300 facs.

www.mga-architects.net

Copyright

© 2018
Moiseev/Gordon Associates, Inc.
Use of these drawings is limited
to the client for the subject project.
Common law copyright is reserved
by the Architect.

Use figured dimensions only. Do not scale the drawings.

Client:

Detroit Meeting Rooms

Project Title: **DMR South** Blvd.

South Boulevard Rochester Hills, MI

Sheet Title: ELECTRICAL & LIGHTING PLAN

Project Number: 15443 Drawn By: AJM, MJN, SLC Checked By: AJM Approved By: MJG Date:07-11-16

Issued: Construction Documents 02-05-18 Site Pian App. Revis. 04-20-18




6/14/2018 11:17:03

City File #17-009 City Section #32

PLUMBING NOTES

- ALL PLUMBING WORK SHALL BE DONE IN STRICT ACCORDANCE WITH STATE CODES 4 THE CITY OF DEARBORN, MICHIGAN BUILDING DEPARTMENT.
- THE PLIMBING CONTRACTOR SHALL BE RESPONSIBLE FOR THE COST OF CUTTING AND PATCHING FLOORS, WALLS, & ROOPS NECESSARY TO ACCOMMODATE THE PLUMBING WORK
- 3. ALL PLIMBING PIPING SHALL BE CONCEALED INTEREVER POSSIBLE UNLESS NOTED ON THE DRAWINGS OTHERWISE. DOMESTIC WATER PIPING IS SHOWN ABOVE THE CEILING WITH DROPS IN WALLS AND PARTITIONS. THE CONTRACTOR MAY ELECT TO INSTALL THE PIPING BELOW THE FLOOR. ALL PIPING BELOW THE FLOOR SHALL BE TYPE IN SOFT COPPER WITH NO JOINTS BELOW THE FLOOR.
- 4. THE CONTRACTOR SHALL PROVIDE ALL NEW PIPE, VALVES & FITTINGS.
- 5. MATERIALS:
- .01 UNDERGROUND WATER PIPING: TYPE 'K' SOFT COPPER .02 ABOVEGROUND WATER PIPING: TYPE 'L' HARD COPPER .03 SOLDER 95-5 TIN-ANTIMONY OF SILFOS.
- (DO NOT USE LEAD BEARING SOLDER).
- .04 SANITARY AND WASTE PIPING:
- ABOVE GROUND LEVEL: SCHEDULE 40 PVC
 GROUND LEVEL AND BELOW: SCHEDULE 40 PVC
- .05 VENT PIPING: NO HJB' CAST IRON, SCHEDULE 40 GALVANIZED STEEL OF DMV-PVC
 .06 GAS PIPING: 2" AND SMALLER SCHEDULE 40 BLACK STEEL ASTM A-53 WITH
 WROJGHT IRON FITTINGS, PIPING LARGER THAN 2" SHALL HAVE
 - MROUGHT IRON FITTINGS. PIPING LARGER THAN 2" SHALL HAVE MELDED JOINTS AND PITTINGS. PIPING LOCATED ON ROOF SHALL BE SET ON TREATED LUMBER, 4X4X18" LONG AT A MASWUM OF 10" APART, AND RETAINED TO THE LUMBER WITH GALVANIZED CUPS.
- .01 FLOOR DRAINS: SHALL BE AS MANUFACTURED BY SMITH, JOSAM, ZURN OR MIFAB,
- NOTE: ALL FLOOR DRANS SHALL BE SERVED BY TRAP FRIMERS OR AS REQUIRED BY THE CITY OF DEARBORN BUILDING DEPARTMENT
- TRAP PRIMER SMITH FIG. 2699 or EQUAL
- FLOOR DRAIN FI
- SMITH FIG. NO. 2005-A- CAST IRON BODY WITH NICKEL BONZE STRAINER AND TRAP PRIMER CONNECTION.
- 6. PIPE INSULATION: INSULATE ALL HOT, COLD DOMESTIC WATER PIPING & NON VERTICAL RANWATER CONDUCTORS WITH 1" THICK FIBERGLASS INSULATION WITH AN ALL SERVICE JACKET, ASJ. JOHNS MANVILLE, OWENS CORNING FIBERGLAS OF EQUAL.

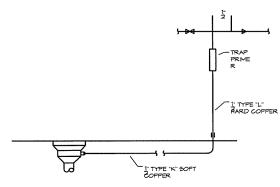

TYPICAL FLOOR DRAIN TRAP PRIMER DETAIL SCALE: NOT TO SCALE


NOTE: 1

NOT

ALL FLOOR DRAINS SHALL BE SERVED BY TRAP PRIMERS


2. TRAP PRIMERS SHALL BE MIFAB MODEL MR-500 WITH VACUUM

NTH VACUUM BREAKER OR EQUAL BY PRECISION PRODUCTS, or SMITH.

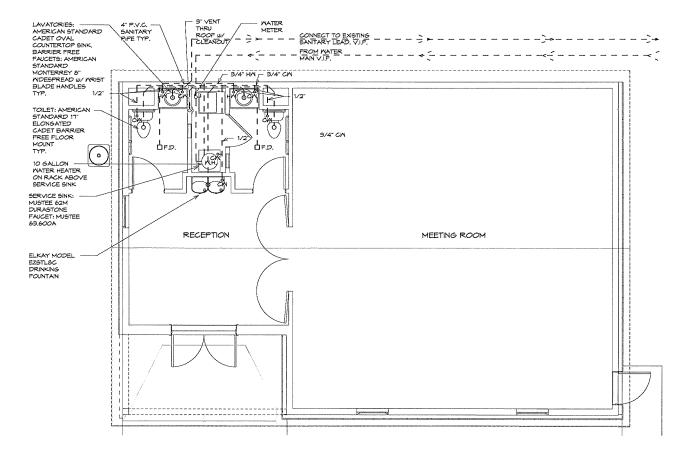

MASTE LINE SIZES: LAVATORIES: 1 1/4" TOILETS: 3" FLOOR DRAINS: 2" DRINKING FOUNTAIN: 1 1/4" SERVICE SINK: 1 1/2"

NOTE: ALL WATER LINES ARE TO BE ABOVE FINISH CEILING LINE

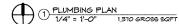



Moiseev/Gordon Associates, inc 4351 Delemere Court Royal Oak, Mi 48073

248.549.4500 voice 248.549.7300 facs.

www.mga-architects.net

Copyright

© 2018
Molseev/Gordon Associates, Inc.
Use of these drawings is limited
to the client for the subject project.
Common law copyright is reserved
by the Architect.

Use figured dimensions only. Do not scale the drawings.

011----

Detroit Meeting Rooms

Project Title:
DMR South
Blvd.

South Boulevard Rochester Hills, MI

Sheet Title: PLUMBING PLAN

Project Number: 15443 Drawn By: AJM, MJN, SLC Checked By: AJM Approved By: MJG Date:07-11-16


02-05-18

Issued: Construction Documents

Site Plan App. Revis. 04-20-18



City File #17-009 City Section #32 6/14/2018 11:17:05 AM

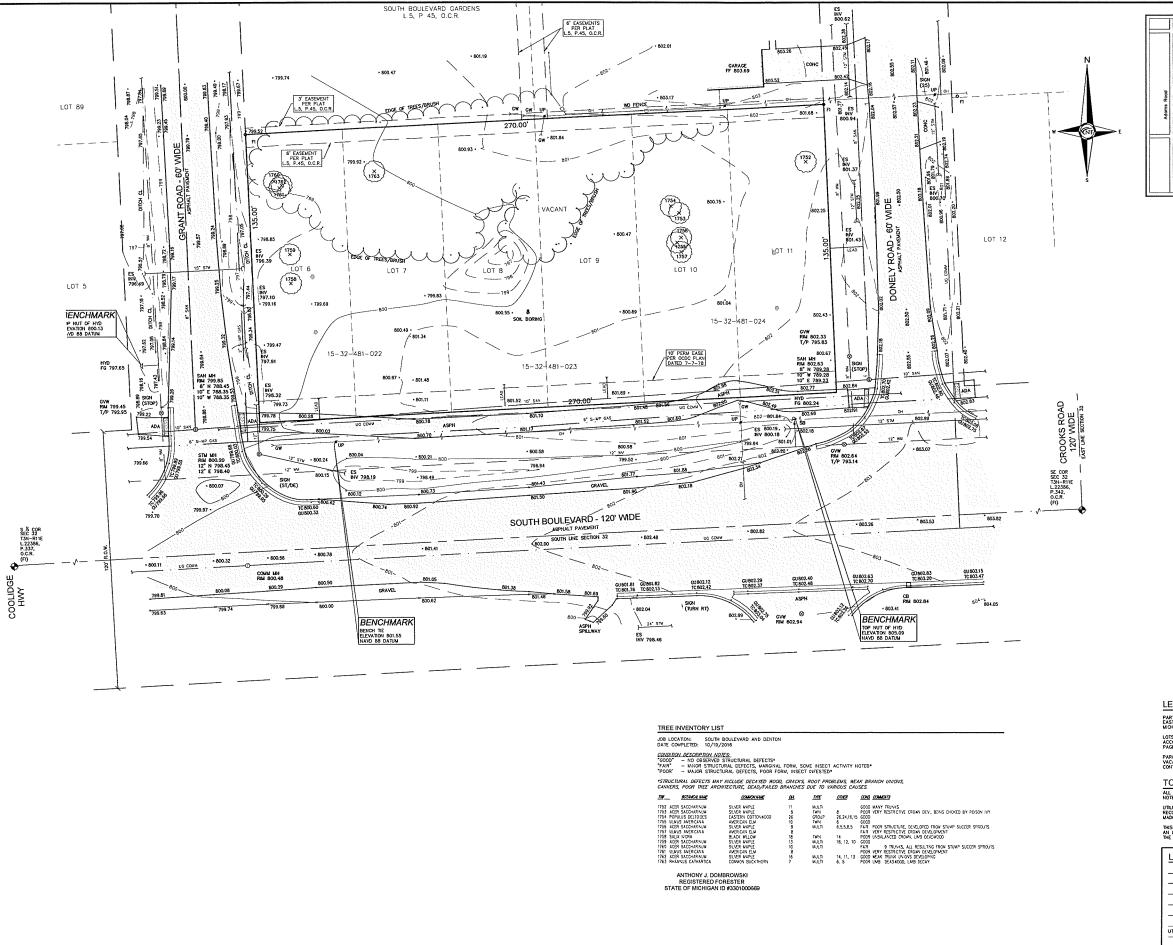






NOWAK & FRAUS ENGINEERS 28 WEST ADAMS, SUITE 210 DETROIT, MI 48226 TEL. (313) 965-2444 FAX. (248) 332-8257

LAND PLANNERS

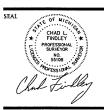

PROJECT South Boul

South Boulevard Meeting Room

CLIENT

Moiseev / Gordon Associates, Inc. 4351 Delemere Ct. Royal Oak, MI 48073 CONTACT

Mr. Michael J. Gordon, RA Tel: 248-549-4500 Email:michaelg@mga-architects.ne

PROJECT LOCATION

Part of the Southeast ¼ of Section 32 T.3 North, R.11 East City of Rochester Hills, Oakland County, Michigan

SHEE

Boundary, Topographic, and Tree Survey



DATE ISSUED/REVISED

LEGAL DESCRIPTION

PART OF THE SOUTHEAST K OF SECTION 32, TOWN 3 INORTH, RANCE EAST, CITY OF ROCHESTER HILLS, COUNTY OF GANLAING, STATE OF INCHERN AND LIGHE PARTICULARLY DESCRIBED AS FOLLOWS: LOTS 6 THROUGH 11, BICLUSHE, SOUTH BOOLEVARD GARDENS, ACCORDIG TO THE FLAT THEREOF RECORDED BY UBER 5 OF PLATS, PAGE 45 OF DAILAND COUNTY RECORDS.

PARCELS - 15-32-481-022, 15-32-481-023, 15-32-481-024 VACANT NO ADDRESS CONTAINS 36,450 SQUARE FEET OR 0.837 ACRES OF LAND

TOPOGRAPHIC SURVEY NOTES

ALL ELEVATIONS ARE EXISTING ELEVATIONS, UNLESS OTHER NOTED.

UTILITY LOCATIONS WERE OBTAINED FROM MUNICIPAL OFFICIALS A RECORDS OF UTILITY COMPANES, AND INO QUARANTEE CAN BE MADE TO THE COUPLETINESS, OR EXACTINESS OF LOCATION. THE SURVEY MAY NOT SHOW ALL EASTERDING OF RECORD UNLESS AN UPDATED TITLE POLICY IS FURRISHED TO THE SURVEYOR BY THE OWNERS.


	LEGEND	
	MAIHOLE	EXISTING SANITARY SEV
	HYDRANT	EXISTING SAN. CLEAN O
	MANHOLE CATCH BASIN	EXISTING WATER MAIN
	WANHOLE CATCH BASIN	EXISTING STORM SEWER
1	×	EX. R.Y. CATCH BASIN
	UTILITY POLE GUY POLE	EXISTING BURIED CABLE
	GUY WARE	OVERHEAD LINES
i	⋫	LIGHT POLE
	4	23CM
		EXISTING GAS MAIN

DRAWN BY: J. Klenk	
PROJECT MANAGER: J. Klinkenberger	
APPROVED BY: C. Findley	
DATE: December 18, 201	.7
SCALE: 1" = 20'	20
NFE JOB NO.	SHEET NO.

C1

J J462

CITY FILE #: 17-009 CITY SECTION #: 32

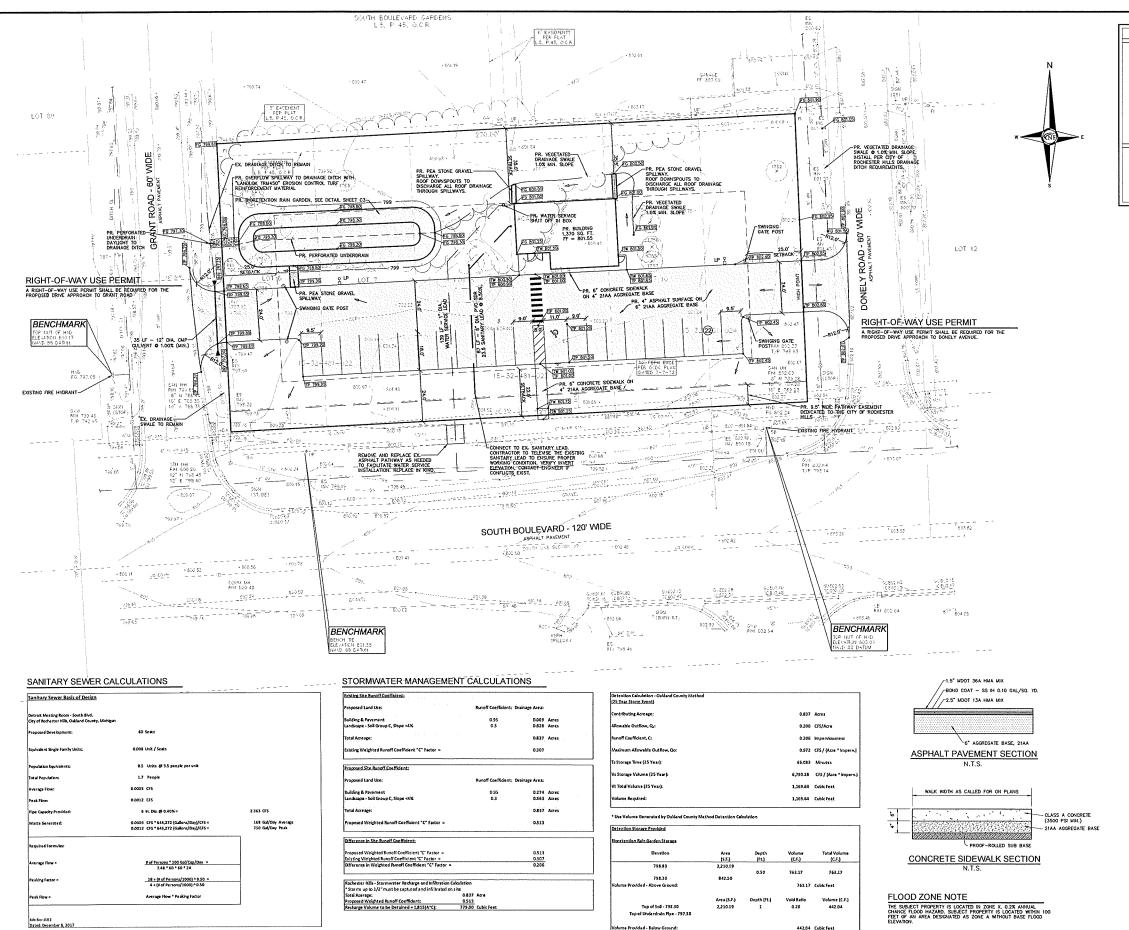





CIVIL ENGINEERS LAND SURVEYORS LAND PLANNERS

NOWAK & FRAUS ENGINEERS 28 WEST ADAMS, SUITE 210 DETROIT, MI 48226 TEL. (313) 965-2444 FAX. (248) 332-8257

CHAD L. FINDLEY

ENGINEER NO.

South Boulevard Meeting Room

CLIENT Moiseev / Gordon Associates, Inc. 4351 Delemere Ct. Royal Oak, MI 48073

CONTACT

Mr. Michael J. Gordon, RA Tel: 248-549-4500 Email:michaelg@mga-architec

Part of the Southeast 1/4

City of Rochester Hills,

of Section 32 T.3 North, R.11 East

FIRE DEPARTMENT NOTES

- CONSTRUCTION OF GATES SAUL BE OF MATERIAS THAT ALLOW MANUAL OFFERNOR. BY ONE PERSON. WITH A VEALS OF OFFIRM CHE GATE BY PIRE DEPARTMENT FERSONAL FOR EMERGENCY OFFIRM DEVELOPED BY THE FIRE FOOL OFFICIAL.
- CARDENIC BEGGLATION.

 PRECLAIRS SHALL BE DESIGNATED BY BY THE PIPE CODE
 OFFICIAL, AND SHALL BE CONSPICUOUSLY POSTED ON BOTH SDES
 OF THE PIPE LINE, SHALL BE LES CONSPICUOUSLY POSTED ON BOTH
 OF THE PIPE LINE, STATES SHALL BELS SHALL SPACED TO MORE
 THAN 100 FEET APART.

 PRECLAIRS SHORT SHALL READ "NO STOPPING, STANDRING, PARKHING,
 FIRE LINE," AND SHALL COMPORN TO THE MICHEGAN MANNAL OF
 HARFORN HAPPIC COURTED, DEVICE SAFEGUARDED BY ACCORDANCE
 WITH PED 2008, CHAPTER 14.

GENERAL PAVING NOTES


PAYEMENT SHALL BE OF THE TYPE, THICKNESS AND CROSS SECTION AS INDICATED ON THE PLANS AND AS FOLLOWS:

ALL SIDEWALK RAMPS, CONFORMING TO PUBLIC ACT NO. 8, 1993, SHALL BE INSTALLED AS INDICATED ON THE PLANS.

CONSTRUCTION OF A NEW OR RECONSTRUCTED DRIVE APPROACH COMMECTING TO AN EXISTING STATE OR COUNTY ROADWAY SHALL ALLOWED ONLY AFTER AN APPROVED PERIAT HAS BEEN SECURED FROM THE AGENCY HAYING JURISDICTION OVER SAID ROADWAY.

EXISTING TOPSOIL, VEGETATION AND ORGANIC MATERIALS SHALL BE STRIPPED AND REMOVED FROM PROPOSED PAVEMENT AREA PRIOR TO PLACEMENT OF BASE MATERIALS.

EXPANSION JOINTS SHOULD BE INSTALLED AT THE END OF ALL INTERSECTION RADII.

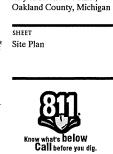


J462

C2

		DATE ISSUI	D/REVISED
PAVING LEGEND		2018-06-13 - REVISED PE	R CITY REVIEW
11 1 PRO	OPOSED CONCRETE PAVEMENT		
PRODUCTION OF THE PRODUCTION O	OPOSED ASPHALT PAVEMENT		
LEGEND			
MANHOLE	- EXISTING SANITARY SEWER		
HYDRANT GATE VALVE	- SAN. CLEAN OUT - EXISTING WATERWAIN		
E CHICK BASIC	- EXISTING STORM SEWER	DRAWN BY:	
	EX. R. Y. CATCH BASIN	J. Klenk	
UTILITY POLE GUY POLE	- EXISTING BURIED CABLES	PROJECT MANAG	
GUY WRE	OVERHEAD LINES	J. Klinkenberg	
φ.	LIGHT POLE	APPROVED BY:	201
4	SIGN	C. Findley	
C.O. MANHOLE	- EXISTING GAS MAIN	DATE:	
HYDRANT GATE VALVE	PR. SANITARY SEWER	December 18,	2017
	- PR. WATER MAIN	Becomoci 10,	2017
BRET C.B. MANHOLE	- PR. STORM SEWER	SCALE: 1" = 20)'
	PR. R. Y. CATCH BASIN	20 10 6	10 20
*	PROPOSED LIGHT POLE	NFE JOB NO.	SHEET N

CITY FILE #: 17-009

CITY SECTION #: 32

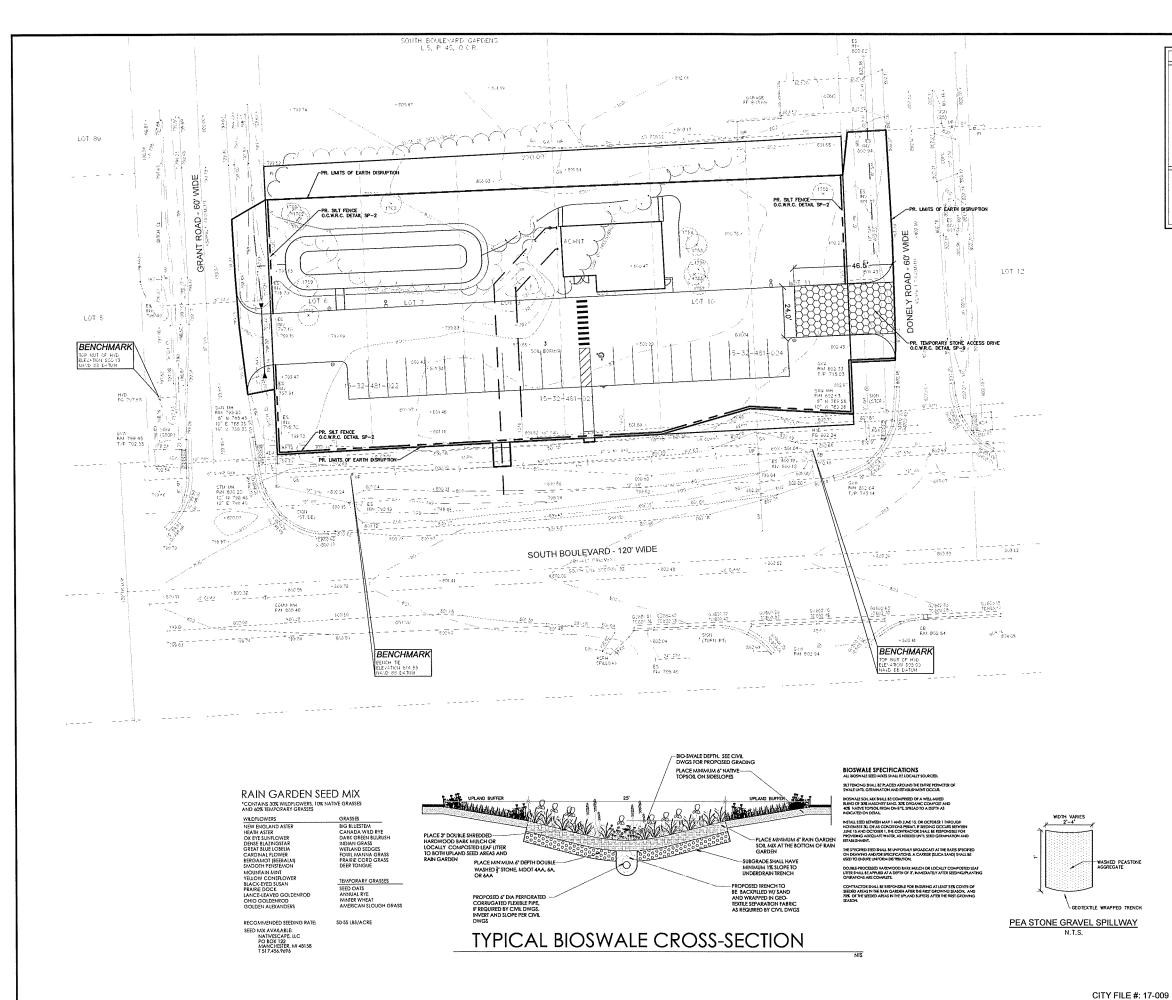






LAND PLANNERS

NOWAK & FRAUS ENGINEERS
28 WEST ADAMS, SUITE 210
DETROIT, MI 48226
TEL. (313) 965-2444
FAX. (248) 332-8257

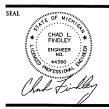

PROJECT
South Boulevard
Meeting Room

4351 Delemere Ct.

Royal Oak, MI 48073 CONTACT

Mr. Michael J. Gordon, RA

CLIENT
Moiseev / Gordon
Associates, Inc.

PART OF THE SOUTHEAST X OF SECTION 32, TOWN 3 NORTH, RANGE 11 EAST, CITY OF ROCHESTER HILLS, COUNTY OF OAKLAND STATE OF MICHIGAN AND MORE PARTICULARLY DESCRIBED AS FOLLOWS:

LOTS 6 THROUGH 11, INCLUSIVE, SOUTH BOULEVARD GARDENS ACCORDING TO THE PLAT THEREOF RECORDED IN LIBER 5 OF PLATS, PAGE 45 OF OAKLAND COUNTY RECORDS.

PARCELS - 15-32-481-022, 15-32-481-023, 15-32-481-024 VACANT NO ADDRESS CONTAINS 36,450 SQUARE FEET OR 0.837 ACRES OF LAND

SOIL EROSION CONTROL

LEGAL DESCRIPTION

SECULIACE OF OPERATION (NEW CONSTRUCTION)
INSTALL CRUSHED CONGESTE ACCESS DRIVE AND TELPORARY
CILVERTS AT THE SITE ENTRANCE AS INDICATED ON THE PL
INSTALL SET, FEDICE OR SULURA APPROVED SET BARRER ALD
PROPERTY LINES AND AROUND SENSITIVE NATURAL FEATURES
RODICATED ON THE PLANTS.

IF INDICATED ON CONSTRUCTION PLANS, SEDIMENTATION BASIN DETENTION POND, ETC., SHALL BE CONSTRUCTED PRIOR TO INSTAIL ATION OF ANY OTHER WORK

STRIP ENSTRING TOPSOIL, VEGETATION AND ORGANIC MATTER FROM BRIDDING PAD AND PARKING AFEAS. COMMENCE LAND BALANCE AND MASS GRADRIG OPERATIONS. MAINTAIN A MINIMUM BUFFER 15' OF ENSTRING VEGETATION WHEREVER POSSBLE AROUND SIE PERMETER. STOCK PLES SHOULD BE LOCATED. AWAY FROM EXISTING DRANAGE FACULTIES.

COMMENCE FINAL GRADING AND TRUMENG OPERATIONS. PREPARE SUBGRADE FOR INSTALLATION OF PROPOSED PAYEMENT.

SEED AND MULCH ALL DISTURBED SITE AREAS AND INSTALLED SITE LANDSCAPING.

REMOVE CONSTRUCTION DEBRIS AND JET VAC NEWLY INSTALLED STORM SEWER SYSTEM AS REQUIRED BY THE MUNICIPALITY. REMOVE ALL REMAINING TEMPORARY SOIL EROSION AND SEDIMENTATION CONTROL MEASURES ONCE PERMAININT MEASURES

MERIEVER POSSIBLE, THE SITE SHALL BE GRADED TO WITHIN SI NCHES (6") OF THE PROPOSED FINISH GRADE PRIOR TO ISTALLATION OF UNDERGROUND FACILITIES.

STAGING OF PROPOSED WORK SHALL BE COMPLETED B CONTRACTOR AS REQUIRED TO ENSURE PROGRESSIVE STABULZATION OF DISTURBED AREAS.

NOTES

REFER TO THE WRC SOIL EROSION AND SEDMENTATION CONTROL DETAIL SHEET FOR ALL ADDITIONAL HOTES & DETAILS (THY) A DISTANCE OF 150½ TO THE ALEREST BODY OF WATER, UNHAUEL WETLANDS TO THE SOUTH AND WEST.

THE TOTAL AREA OF EARTH DISSUPTION IS 0.837 ACRES.

THE SOIL EROSION CONTROLS WILL BE MAINTAINED WEEKLY AND AFTER EVERY STORM EVENT BY THE CONTRACTOR.

A SOIL EROSION PERNIT IS REQUIRED FROM THE OAKLAND COUNTY WATER RESOURCES COMMISSIONER.

SOIL DATA

CITY SECTION #: 32

THIS SITE CONSISTS OF 96.7X THE CAPAC SAIDY LOAM, 0 TO 4 PERCENT SCOPES, AND 3.3X 12. BROOKSTON AND COUNCOL LOADS BASED ON DATA PROVIDED BY THE UNITED STATES EPPERMENT OF AGRICULTURE, HATURAL RESOURCES CONSERVATION SERVICE, AS ACCESSED JAIN 12, 2018.

ESTIMATED QUANTITIES

DESCRIPTION	QUANTITY	UNIT
SILT FABRIC FENCING	460	LF.
STONE ACCESS DRIVE	1,116	S.F.

LEGEND	
	BINDICATES LIMITS OF SALT FABRIC FENCE
	BIOICATES LIMITS OF SOIL

Tel: 248-549-4500
Email:michaelg@mga-architects

PROJECT LOCATION
Part of the Southeast ¼ of Section 32
T.3 North, R.11 East
City of Rochester Hills,


SHEET

Soil Erosion Control Plan

Oakland County, Michigan



DATE	13301	D/KEV	SED	
2018-06-13 - RE	VISED PE	CITY REV	TEW	
				_
DRAWN B	Y:			_
J. Klenk				
PROJECT A	AANAG	ER:		
J. Klinke	enberg	er		
APPROVED	BY:			
C. Findle				
DATE:	ر			
	o= 10	2017		
Decemb	er 10,	2017		
SCALE: 1	" = 20	į.		
20 10	0	10	20	3
				_
NFE JOB N	O.	SF	IEET N	O.
J462			C3	
J T U 22				

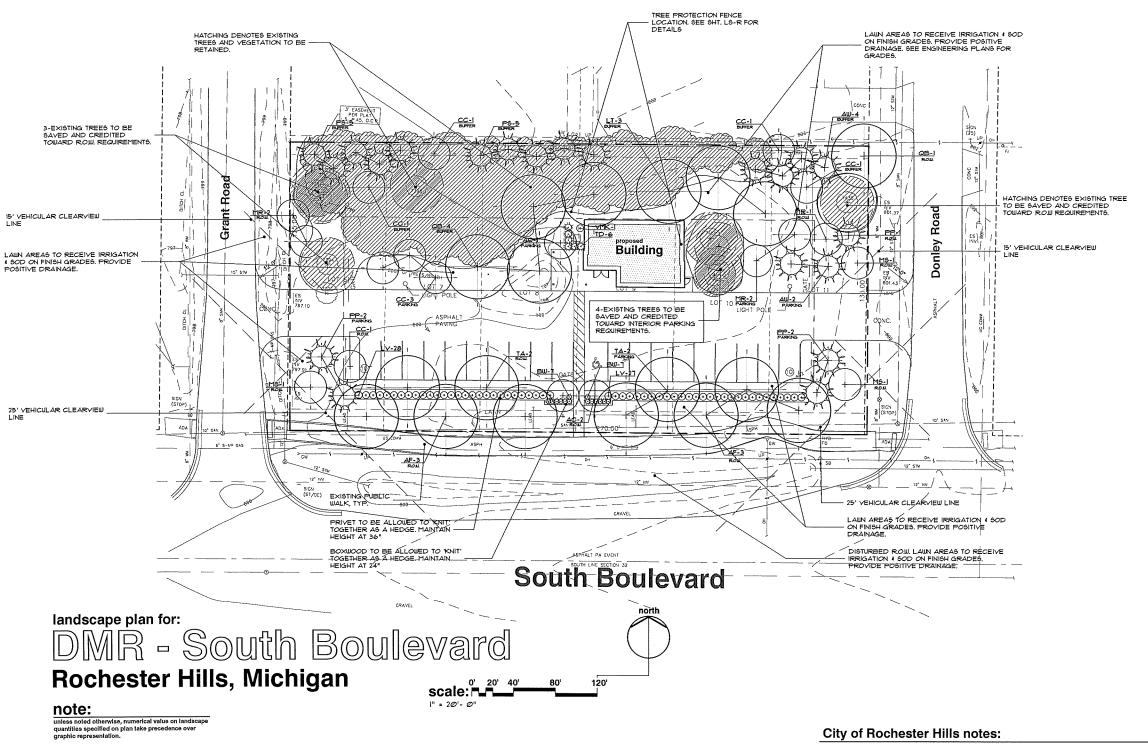

VEHICULAR CIRCULATION & PARKING AREA

ONE (1) TREE PER PER 150 SQFT.

buffer requirements

REQUIRED INTERIOR AREA . 5% OF 11,001 SQFT.

TWO 4 HALF (25) DECIDUOUS TREE PER 100 LIN. FT.

ONE (HALF (15) ORNAMENTAL TREE PER 100 LIN. FT.

FIVE (5) EVERGREEN TREES PER 100 LIN. FT.

EIGHT (8) SHRUBS FER 100 LIN. FT.

11.007 SQFT.4

55Ø35 saft.

4 EX. TREES

REQUIRED | PROVIDED

13.5

landscape requirement summary:

TOTAL LIN. FT. FRONT YARD IN SOUTH BOULEVARD

ONE (1) DECIDUOUS TREE PER 35 LIN. FT.

ONE (1) DECIDUOUS TREE PER 35 LIN. FT. ONE (I) ORNAMENTAL TREE PER 60 LIN. FT

ONE (1) DECIDUOUS TREE PER 35 LIN. FT

ONE (1) ORNAMENTAL TREE PER 60 LIN. FT.

ONE (1) ORNAMENTAL TREE PER 35 LIN. FT. CONTINUOUS SHRUB HEDGE (* 3'-0" O.C.)

ONE (1) DECIDUOUS OR EVERGREEN TREE PER 25 LIN. FT.

TOTAL LIN FT. SIDE YARD DONLEY ROAD

TOTAL LIN FT. SIDE YARD GRANT ROAD...

SOUTH BLVD LIN. FT. PARKING FRONTAGE

ONE (1) ORNAMENTAL TREE PER 60 LIN. FT.

road r.o.w. requirements

parking requirements

REQUIRED | PROVIDED

2+ I EX. TREES

3 EX. TREES

2_____

2

REQUIRED | PROVIDED

58 6

4.5

1.9

3.3

206'+

1.9

68.6

- L PRIOR APPROVAL IS REQUIRED TO PLANT ANY TREE OR SHRUB ON THE RUBLIC RIGHT-OF-UAY

 ALL TREES AND SHRUBS HIJST BE PLANTED AT LEAST 10'
 FROM THE EDGE IF THE PUBLIC ROAD (TREES HIST BE PLANTED BY JULY TRANCH CURBO OR ROAD EDGE UGERE SCEED LIMIT IS HORSE THAN 350 HIST BE PLANTED AT LEAST 5'
 FROM THE EDGE OF THE PUBLIC WALKULAY
- 4. EVERGREEN AN ORNATENTAL TREES MUST BE PLANTED AT LEAST 10' FROM THE EDGE OF THE PUBLIC WALKWAY
- LEAST TO FROM THE ELOS OF THE POBLIC WALKWAY.

 NO TREES OR SHARDS AND SE PLANTED WITHIN THE
 TRIANSULAR AREA FORTED AT THE INTERSECTION OF ANY
 STREET RISULT-CHIAN THES AT A DISTANCEALONS EACH
 LINE OF 25 FROM THEIR POINT OF INTERSECTION

 ON OTREES OR SHARDS FIT DE PLANTED IN THE TRIANSULAR
 AREA FORTED AT THE INTERSECTION OF ANY DRIVEWAY
 WITH A PUBLIC WALKWAY AT A DISTANCE ALONG EACH LINE
 OF 15' FROM THEIR POINT OF INTERSECTION
- ALL TREES AND SHRUBS MUST BE PLANTED AT LEAST 10° FROM ANY FIRE HYDRANT
- 8. SHADE AND EVERGREEN TREES MUST BE AT LEAST IS AWAY FROM THE NEAREST OVERHEAD WIRE
- TREES MUST BE PLANTED A MINIMUM OF 5' FROM AN INDERGROUND UTILITY, INLESS THE CITY'S LANDSCAPE ARCHITECT REQUIRES A GREATER DISTANCE

- IO. PRIOR TO THE RELEASE OF THE PERFORMANCE BOND, THE CITY OF ROCHESTER HILLS PORESTRY DIVISION NEEDS TO NSPECT ALL TREES, EXISTING OR PLANTED, TO IDENTIFY ANY THAT POSE A HAZARD TO THE SAFE USE OF THE PUBLIC RIGHT-OF-MAY
- 1 FORESTRY MAY REQUIRE THE DEVELOPER TO REMOVE, AND POSSIBLY REPLACE. ANY SUCH TREES
- THIS REQUIREMENTS ARE INCORPORATED INTO THE PLAN

This document and the subject matter contained therein is proprietary and is not to be used or reproduced without the written permission of Felino Pascus and Associates Do Not scale drawings. Use figured dimensions only

notice: Copyright

drawn by checked by

FP 2-5-2018



24333 Orchard Lake Rd, Suite G Farmington Hills, MI 48336 ph. (248) 557-5588 fax. (248) 557-5416

Detroit

Meeting

DMR South

Boulevard

City of Rochester

landscape planting

job no./issue/revision date:

LS17.092.08 SPA 9-5-2017 LS18.031.02 SPA 2-12-2018 LS18.031.05 SPA 6-2-2018

detail


Hills, Michigan South Blvd. sheet title:

Room

LS18.031.02

plant material list

key	quant. LS-1	botanical name	common name	size	comments	unit cost	cost total
		LARGE AND SMALL DECIDUOUS TREES					
AF	6	ACER X FREEMANII 'JEFFERSRED'	AUTUMN BLAZE RED MAPLE	2 l/2* BB		1350	12,100
JA	4	TILIA AMERICANA "BOULEYARO"	BOULEYARD LINDEN	2 l/2* BB		1350	fl,400
QВ	5	QUERCUS 'BICOLOR'	SWAMP WHITE OAK	2 I/2* BB		1350	11,750
ŢŢ.	3	LIRIODENDRON TULIPIFERA	TULIPTREE	2 I/2" BB		435 <i>0</i>	1050
cc		CERCIS CANADENSIS	EASTERN RECEUD	2° BB	(MULTI-STEM)	1250	12000
AC	3	AMELANCHIER CANADENSIS	SHADBLOW SERVICEBERRY	6'BB	(MULTI-STEM)	1250	1750
MS	3	MALUS SARGENTII	SARGENT CRABAPPLE	2° BB		1250	1750
MR	5	MALUS ROYALTY	ROYALTY CRABAPPLE	2* BB		1250	11250
	1	SHRUBS					
VMK_		AIBRIMINE ACHAIR.	MOHAUK VIBURNUM	3' 1/2' BB		150	150
LV	55	LIGUSTRUM X 'VICARYII'	VACARY PRIVET	3 CONT	36" O.C. 5PACING	150	12,750
EW	14	BUXUS M. 'GREEN VELVET'	GREEN VELVET BOXWOOD	3 CONT	24" O.C. SPACING		1700
TO	6	TAXUS XM DENSIFORMIS	DENSIFORMIS SPREADING YEW	36° BB	32" O.C. SPACING	150	13,00
		LARGE AND SMALL EVERGREENS					
ACW	6	ABIES CONCOLOR	CONCOLOR WHITE FIR	8' BB		1300	11,800
PP	5	PICEA GLAUCA "DENSATA"	BLACK HILLS SPRUCE	8' BB		1300	H500
P5	lø.	PINUS STROBUS	EASTERN WHITE PINE	8' BB		±3 <i>0</i> ∞	13,000
		LANDSCAPE MATERIALS					
	2300 1101	». 5 00				#6/ SQLYRD.	113,800
		IRRIGATION				13500	14500
						TOTAL COST.	139,450
	H						
	H	***************************************					
	Н			-			

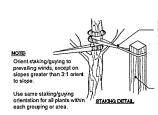


USE 3 HARDWOOD STAKES PER TREE. Z X Z X 8" STAKES. DRIVE STAKES INTO UNDISTURBED SOIL 6-3" OUTSIDE OF ROOTBALL TO A DEPTH OF 18" BELOW TREE PIT. REMOVE AFTER ONE DITYEAR. DO NOT USE WIRE OR ROPE THRU A HOSE

120" 120"



tree staking detail

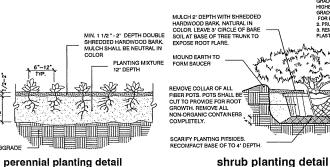

4' HIGH FENCE LOCATED 1' FROM DRIP LINE

tree protection fence detail

1, SHRUB SHALL BEAR SAME RELATION TO FINISH AMEND SOILS PER SITE CONDITIONS AND REQUIREMENTS OF THE PLANT SHRUBS PLANTED IN BEDS SHALL HAVE ENTIRE BED MASS EXCAVATED AND BACKFILLED WITH APPROVED PLANT MIX. PLANTS SHALL NOT BE

INSTALLED IN INDIVIDUAL HOLES REMOVE ALL NON-BIODEGRADABLE MATERIALS COMPLETELY FROM THE ROOTBALL CUT AND REMOVE WIRE BASKET AND BURLAP FROM TOP HALF OF THE ROOTBALL.

STAKE 3 LARGEST STEMS USING 2'-3' WIDE BELT-LIKE NYLON OR PLASTIC STRAPS. ALLOW FOR SOME MINIMAL FLEXING OF THE TREE. LACE STRAPS TOGETHER AFTER ONE YEAR. PLANT TREE SO ROOT FLARE IS AT OR ABOVE 3. REMOVE ALL TAGS, STRING, PLASTICS ETC. MIN. 36" ABOVE GROUND FOR UPRIGHT. NATURAL IN COLOR LEAVE: MOUND EARTH TO FORM SAUCER

BOOTBALL CUT AND REMOVE WIR 3 x width of rootball

multi-stem tree planting detail

general landscape notes:

L LANDSCAPE CONTRACTOR SHALL VISIT THE SITE, INSPECT EXISTING CONDITIONS, REVIEW PROPOSED PLANTINGS AND RELATED WORK CONTACT THE CUNER AND/OR LANDSCAPE ARCHITECT WITH ANY CONCERNS OR DISCREPANCY BETWEEN THE PLAN, PLANT MATERIAL LIST, AND/OR SITE CONDITIONS.

2. PRIOR TO BEGINN'S OF CONSTRUCTION ON ANY WORK, CONTRACTORS SHALL VERIFY LOCATIONS OF ALL ON SITE UTILITIES, GAS, ELECTRIC, TELEPHONE, CABLE TO BE LOCATED BY CONTACTING HISS DIG 1-800-403-1711. ANY DAYAGE OR INTERRIPTION OF SERVICES SHALL BE THE RESPONSIBILITY OF THE CONTRACTOR COORDINATE ALL RELATED WORK ACTIVITIES WITH OTHER TRADES AND REPORT ANY WACCEPTABLE JOB CONDITIONS TO CUNER PRIOR TO CONTENDEN

3. NUMERICAL VALUE ON THE LANDSCAPE QUANTITIES SPECIFIED ON THE PLANTAKE PRECEEDENCE OVER GRAPHIC REPRESENTATION VERIFY ANY CONCERN-DISCREPANCY WITH LANDSCAPE ARCHITECT.

4. ALL CONSTRUCTION AND PLANT MATERIAL LOCATION TO BE ADJUSTED ON SITE IF NECESSARY

5. ALL SUBSTITUTIONS OR DEVIATIONS FROM THE LANDSCAPE PLAN MUST BE APPROVED BY ROCHESTER HILLS AND LANDSCAPE ARCHITECT

6. ALL LARGE TREES AND EVERGREENS TO BE STAKED, GUYED AND WRAPPED AS DETAIL SHOWN ON PLAN.

7. PLANT BEDS TO BE DRESSED WITH MIN. 4" OF FINELY DOUBLE SHREDDED HARDBARK MULCH.

8. DIG SHRIB PITS I' LARGER THAN SHRIB ROOT BALLS AND TREE PITS 2' LARGER THAN ROOT BALL. BACK FILL WITH ONE PART TOP SOIL AND ONE PART SOIL FROM EXCAVATED PLANTING HOLE.

9. NATURAL COLOR, FINELY SHREDDED HARDWOOD BARK MULCH REQUIRED FOR ALL PLANTINGS.

II. PLANT MATERIAL QUALITY & INSTALLATION SHALL BE IN ACCORDANCE WITH THE CURRENT AMERICAN ASSOCIATION OF NURSERYMEN LANDSCAPE

12. PROVIDE PEAT SOD FOR ALL NEW AND DISTURBED LAWN AREAS WILESS NOTED OTHERWISE.

13, ALL PLANTING AREAS TO BE PREPARED WITH APPROPRIATE SOIL MIXTURES AND FERTILIZER BEFORE PLANT INSTALLATION.

I4. PLANT TREES AND SHRUBS GENERALLY NO CLOSER THEN THE FOLLOWING DISTANCES FROM SIDEWALKS, CURBS AND FARKING STALLS:

a). SHADE TREES
b). ORNAMENTAL AND EVERGREEN TREES
(CRAB, FINE, SFRACE, ETC.) |0 FT.
c). SHRUBS THAT ARE LESS THAN I FOOT TALL
AND WIDE AT THATWINTY 2 FT.

IS. NO TREES OR EVERGREENS TO BE INSTALLED OVER ANY PROPOSED OR EXISTING UTILITY LINES AS SHOUN ON THE OVERALL LANDSCAPE PLAN, SEE EVISINEERING PLANS FOR LOCATION AND DETAILS.

IB. ALL NEW PARKINS (SLANDS AND LANDSCAPE BEDS ADJACENT AND NEXT TO BUILDING SHALL BE EXCAVATED OF ALL BUILDING MATERIALS AND POOR SOILS A HIM. OF 18-18-19 DEPTH BACK FILL WITH BOOOD, HEDILM TEXTIRED PLANTING SOILS, ADD A MIN. 4" OF TOPSOIL OVERFILL TO FINISH GRADE, PROVIDE POSITIVE DRAINAGE.

19. WATERING OF ALL PLANTS AND TREES TO BE PROVIDED IMMEDIATELY AND MULCHING WITHIN 24 HOURS AFTER INSTALLATION.

20. ALL TREE PITS TO BE TESTED FOR PROPER DRAINAGE PRIOR TO TREE PLAYING, PROVIDE APPROPERATES DRAINAGE SYSTEM AS REQUIRED IF THE TREE PIT DCES NOT DRAIN SEPTICIENTY.

21. THE LANDSCAPE CONTRACTOR SHALL GUARANTEE ALL LANDSCAPE PLANT MATERIALS AND IRRIGATION INSTALLATION FOR A PERIOD OF TWO YEAR BEGINNING AFTER THE COMPLICION OF LANDSCAPE INSTALLTION DATE APPROVED BY THE CITY OR LANDSCAPE ARCHITECT. THE CONTRACTOR SHALL REPLACE DURING AND AT THE END OF THE GUARANTEE PERIOD, ANY DEAD OR INACCEPTABLE PLANTS, AS DETERMINED BY THE TOWNSHIP OR LANDSCAPE ARCHITECT, WITHOUT COST TO THE OWNER.

22. IRRIGATION OF LANDSCAPING TO OCCUR BETWEEN THE HOURS OF MIDNIGHT (12:00) AND 5:00 AM

Rochester Hills landscape notes:

D. THE APPROVED LANDSCAPE IT AN SHALL BE CONSIDERED A FERTIMENT RECORD AND RITERAL PART OF ESTE THAN HAPPOOL AND THE REMUSE PROVED IN ACCORDANCE UITH THE APPROVED FROM THE PROPERTIONED PROCEDURES OF THE APPROVED FROM THE PROPERTION OF THAT HANDENANCE REQUIREMENTS OF THIS SECTION 189-11295 WILL PLACE THE PARCEL IN NON-CONFORMITY WITH THE APPROVED LANDSCAPE (FLAN AND BE A VIOLATION OF THIS OFDINANCE.

I6. ALL LAWN AREAS AND LANDSCAPE BEDS TO BE FULLY IRRIGATED WITH A AUTOMATIC UNDERGROUND SYSTEMS, IRRIGATION SYSTEM TO HAVE SEPARTE ZONES FOR LAWN AREAS, PARKINS IDLANDS, AND SHRUB BEDS WITH DIFFERENT CONTROL MOISTURE LEVEL ADJUSTMENT PER ZONE AS REQUIRED


IT. UNLESS NOTED OTHERUISE, LANDSCAPE BEDS ADJACENT TO LAUN TO RECIEVE EDGING. EDGING SHALL BE 4" X I/8" METAL. (FINISH BLACK OR GREEN) OR APPROVED EQUAL. AND TO BE INSTALLED WITH HORIZONTAL METAL STAKES AT 32" O.C. OR FER MANIFACTERER'S SPECIFICATION.

THE CUNER OF THE PROPERTY SHALL BE RESPONSIBLE FOR ALL MAINTENANCE OF SITE LANDSCAPING, AS FOLLOUS:

A. LANDSCAPING SHALL BE KEPT IN A NEAT, ORDERLY AND HEALTHY GROWING CONDITION, FREE FROM DEBRIS AND REPUSE.

B. FRANNA SHALL BE MINMAL AT THE TIME OF INSTALLATION, OAL'T TO REMOVE DEAD OR DISEASED BRANCHES, SUBSECIENT PRANNS SHALL ASSINE PROPER MATURATION OF PLANTS TO ACHIEVE THEIR APPROVED PURPOSE.

E. IF PROTECTED TREES ARE DAMAGED, A FINE SHALL BE ISSUED ON AN INCH-BY-INCH BASIS AT A MONETARY RATE AS DEFINED BY THE FORESTRY DEPARTMENT.

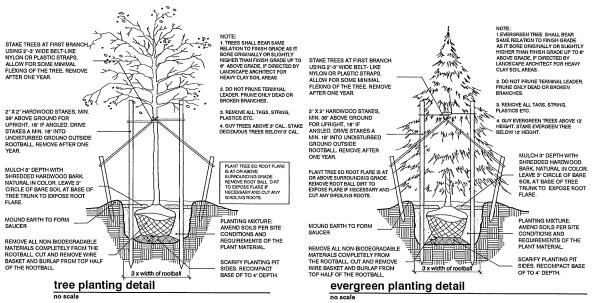

Plant Material List, Planting Details and Notes



24333 Orchard Lake Rd, Suite G Farmington Hills, MI 48336 ph. (248) 557-5588 fax. (248) 557-5416



Detroit Meeting Room

DMR South Boulevard

project location: City of Rochester Hills, Michigan

South Blvd.

plant material list, planting details and landscape notes

job no./issue/revision date LS17.092.08 SPA 9-5-2017 LS18.031.02 SPA 2-12-2018 LS18.031.05 SPA 6-2-2018

IP. CS

checked by FΡ

2-5-2018



LS18.031.02