# Breckenridge Condominiums Hamliv, LLC



Site Plan City File # 18-008 Date: 8/21/2018

## BRECKENRIDGE CONDOMINIUMS

Submitted for Site Plan Review

Rochester Hills, Oakland County, Michigan

THE NORTHEAST 1/4 OF SECTION 28, T3N, R11E PARCEL #15-28-226-023 & 024

## Site Data

**EXISTING ZONING GROSS AREA** 

MR: MIXED RESIDENTIAL OVERLAY (R-3)

3.73 AC.

TOTAL NUMBER OF UNITS

12

PERMITTED DENSITY (MAX.) PROPOSED DENSITY

3.45 DU/AC 3.2 UNITS / AC.

SETBACKS (MIN.) **FRONT YARD** 

(25 FEET) A 15 FEET

SIDE YARD REAR YARD (EAST AND WEST SIDE) REAR YARD (SOUTH SIDE)

25 FEET 60 FEET

#### LOCATION MAP



#### **LEGAL DESCRIPTION**

PARCEL 15-28-226-023
A PARCEL OF LAND IN PART OF THE NORTHEAST 1/4 OF SECTION 28, T3N, R11E, BEGINNING AT A POINT DISTANT THENCE S 89-34-00 W 515.01 FT FROM NORTHEAST SECTION CORNER, THENCE DUE SOUTH 439.10 FT; THENCE DUE WEST 185.00 FT; THENCE DUE NORTH 437.70 FT; THENCE N 89-34-00 E 185.00 FT TO THE POINT OF BEGINNING CONTAINING 1.86 ACRES OF LAND RESERVING ALL EASEMENTS OF

PARCEL 15-28-226-024

PARCEL 19:29-289-924
A PARCEL OF LAND IN PART OF THE NORTHEAST 1/4 OF SECTION 28, T3N, R11E, BEGINNING AT A POINT DISTANT THENCE S 99-34-90 W 339.01 FT FROM NORTHEAST SECTION CORNER. THENCE DUE SOUTH 449.50 FT, THENCE DUE WEST 185 00 FT. TO THE POINT OF BEGINNING. CONTAINING 1.87 ACRES OF LAND RESERVING ALL EASEMENTS OF

1. RETAINING WALLS OVER 4 FEET HIGH WILL REQUIRE SEALED AND SIGNED

#### SITE GRADING NOTES

1. SITES SHALL BE GRADED TO DRAIN SURFACE WATER AWAY FROM FOUNDATION WALLS, THE GRADE SHALL FALL A MINIMUM OF 6° WITHIN THE FIRST 10' (R401.3).

2. WHEREVER POSSIBLE, SWALES SHALL BE PROVIDED ALONG LOT LINES WITH 1% MINIMUM SLOPE TO CONVEY RUNOFF TO CONVEY RUNOFF TO A STORM SEWER OR OTHER APPROVED COLLECTION POINTS.

- DRIVEWAY SLOPES SHALL MEET THE FOLLOWING REQUIREMENTS:
   APPROACH AND DRIVEWAY: 2% MINIMUM, 10% MAXIMUM.
- SIDEWALK CROSS-SLOPE (INCLUDING DRIVEWAY APPROACH); 1% MIN, 2% MAX.
- SIDE-ENTRY GARAGE: 2% MINIMUM, 4% MAXIMUM.
- NEGATIVE SLOPE DRIVEWAY: 2% MINIMUM, 7% MAXIMUM

#### PROPOSED PRIVATE ROADS

THE PROPOSED PRIVATE ROADS ARE NOT BEING CONSTRUCTED TO THE CITY'S PUBLIC ROAD STANDARDS, AND THEREFORE, CANNOT BE TRANSFERRED AS PUBLIC

#### TRAFFIC NOTES

THE PROPOSED PRIVATE ROADS ARE NOT BEING CONSTRUCTED TO THE CITY'S PUBLIC ROAD STANDARDS, AND THEREFORE, CANNOT BE TRANSFERRED AS PUBLIC

HAMLIN ROAD IS UNDER THE JURISDICTION OF THE CITY OF ROCHESTER HILLS AND A CITY RIGHT-OF-WAY PERMIT IS REQUIRED FOR ALL WORK WITHIN THE HAMLIN

#### FIRE DEPARTMENT NOTES

1. "CONSTRUCTION SITES SHALL BE SAFEGUARDED IN ACCORDANCE WITH IFC 2006

2. "OPEN BURNING IS NOT PERMITTED INCLUDING THE BURNING OF TRASH, DEBRIS, OR LAND CLEARING MATERIALS. OPEN BURNING FOR WARMING OF SAND AND OR WATER FOR THE PREPARATION OF MORTAR SHALL BE WITHIN THE CITY OF ROCHESTER HILLS BURN PERMIT GUIDELINES."

NATURAL FEATURES SETBACKS
BEST MANAGEMENT PRACTICES WILL BE STRICTLY FOLLOWED DURING CONSTRUCTION TO MINIMIZE THE IMPACTS ON THE NATURAL FEATURES SETBACKS

NOT FOR CONSTRUCTION UNLESS APPROVED BY MUNICIPALITY, HOUSE DIMENSIONS TO BE VERIFIED BY OWNER AND/OR BUILDER BEFORE CONSTRUCTION.

THE PROPERTY DIMENSIONS AND UTILITY LOCATIONS SHOWN ARE ONLY APPROXIMATE AND GATHERED FROM EXISTING RECORDS AVAILABLE, THERE IS NO GUARANTEE THEREOF. CONTRACTOR SHALL FIELD VERIFY ALL DIMENSIONS AND UTILITIES PRIOR TO START OF CONSTRUCTION AND REPORT ANY DISCREPANCIES

NOTE: ALL CONSTRUCTION SHALL CONFORM TO THE CURRENT STANDARDS AND SPECIFICATIONS OF ALL GOVERNING AGENCIES.

USER AGREES THAT PLAN IS SUBJECT TO STANDARD ASCE CONTRACT AND LIABILITY AND IS LIMITED TO FEE

#### SHEET INDEX

GENERAL

**ENGINEERING SHEET INDEX** 

Final Site Plan

ENG-2 Utility Layout and Grading Plan ENG-3

#### LANDSCAPE SHEET INDEX

**Existing Tree Survey** T-1.1 Tree Analysis

Landscape Concept Plan Landscape Planting Plan and Probable Cost Estimate Elevations and Cross Sections LA-1.1

LA-1.3 Aspen Unit Planting Plan

LA-1.4 LA-2.0 Spruce Unit Planting Plan Landscape Planting Details and Notes

Spruce Second Floor Plan

ARCHITECTURE SHEET INDEX

Aspen Unit Elevation A-1.1 Aspen First Floor Plan Aspen Second Floor Plan A-2.0 Spruce Unit Elevation Spruce First Floor Plan

A-2.2

CLIENT / APPLICANT

**PROJECT TEAM** 

HAMLIV, LLC. JIM POLYZOIS 14955 Technology Dr. SHELBY TWP, MICHIGAN 48315 PHONE: (586) 421-5729

#### PROJECT LANDSCAPE ARCHITECT/PLANNER

NÚÑEZDESIGN, INC.

RALPH L. NÚÑEZ, RLA, CLARB, ASLA, GRP

249 PARK ST TROY, MICHIGAN 48083 PHONE: (248) 224-5933

PROJECT ENGINEER D'ANNA ASSOCIATES

1055 SOUTH BLVD. F. SUITE 200.

PHONE: (248) 852-7702

#### PROJECT ARCHITECT

TR DESIGN GROUP, LLC. JEFF ZIEGELBAUR, PRINCIPAL

BLOOMFIELD HILLS, MICHIGAN 48304

#### PROJECT FORESTER

MIKE'S TREE SURGEONS, INC.

JOHN P. MOSES, REGISTERED FORESTER - MICHIGAN 241 PARK ST

TROY, MICHIGAN 48083 PHONE: (248) 588-0202

#### ISSUED FOR

SITE PLAN REVIEW

PRELIMINARY & FINAL REVIEW

FINAL REVIEW

DATE:

FINAL REVISIONS

PLANNING DEPT. APPROVAL

CITY REFERENCE NUMBER

City File: #18-008








ROCHESTER HILLS, MI PARCEL #15-28-226-023 & 024 N-01-28

CONDOMINIUMS

BRECKENRIDGE

CLIENT: HAMLIV, LLC JIM POLYZOIS 14955 Technology Dr., Shelby Twp., MI 48315 Phone: 586-421-5729 FAX: 586-421-5742

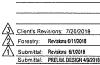




249 Park Street Troy, Michigan 48083 P: 248, 397, 8540

Designed / Drawn RN Checked / Approved RN ob # N-01-28



G -1.0

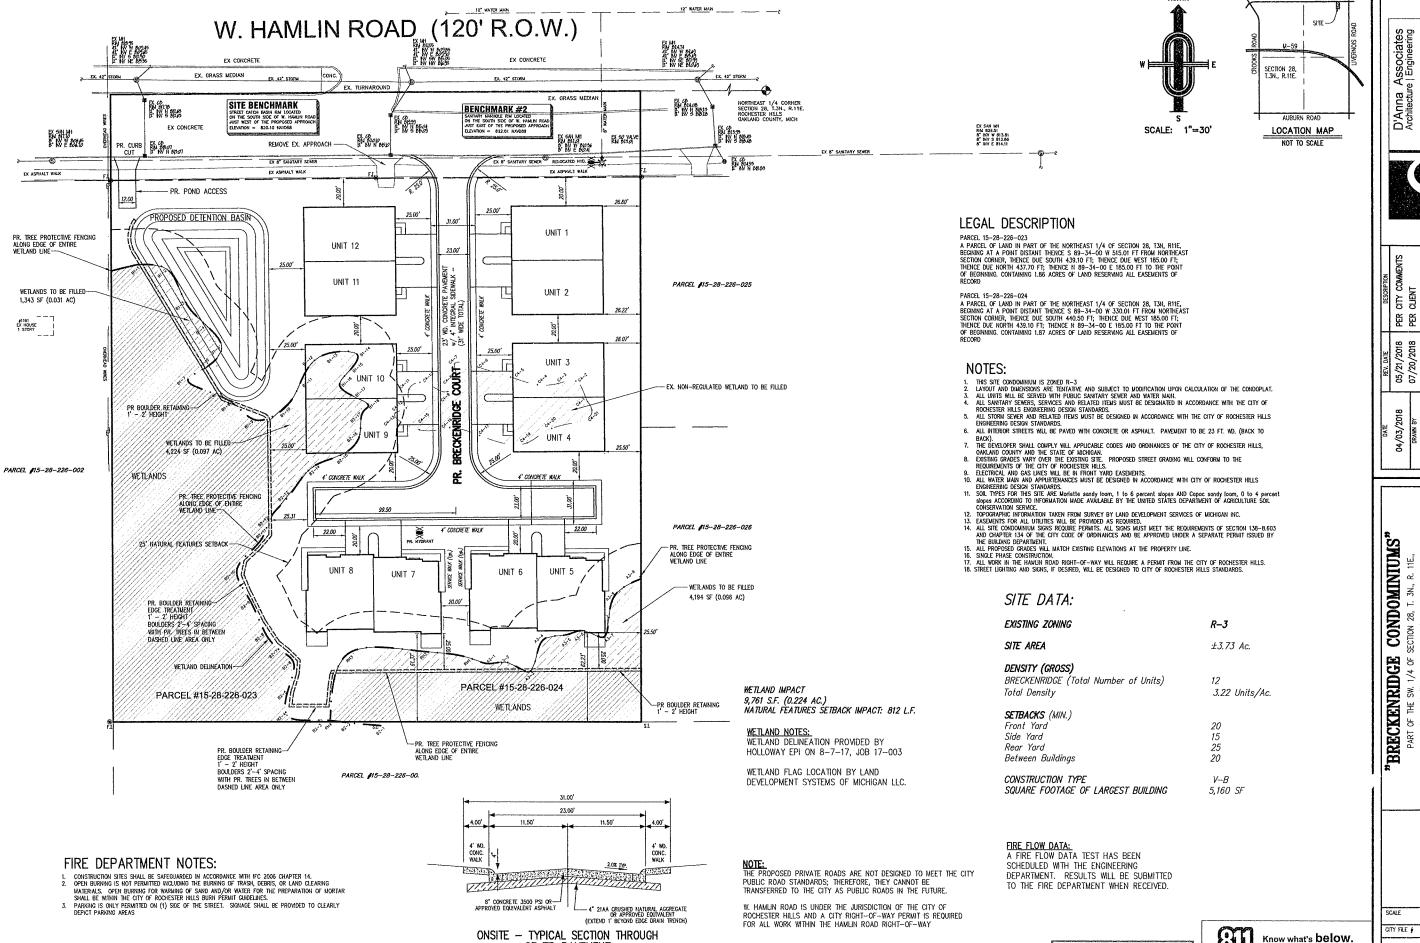

23 FT. PAVEMENT

NOT TO SCALE

4/03/2018
DRAWN BY
S.V. CONDOMINIUMS" SECTION 28, T. 3N., R. 11E., OAKLAND COUNTY, MICHIGAN. PLAN 깷 "BRECKENRIDGE
PART OF THE SW. 1/4 OF SI
CITY OF ROCHESTER HILLS, O.

Call before you dig.

SCALE

1"=30"

CITY FILE # 18-008

ENG-1


NORTH


NOTE: NOT TO BE USED AS CONSTRUCTION DRAWINGS.


HAMLIN ROAD

D'Anna Associa'
Architecture | Enginee
1055 SOUTH BLVD. E. SUITE
ROCHESTER HILLS, MI 4
P 246-852-7702 F 248-852dannaassoc.com @

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BRECKENRIDGE CONDOMINIUMS ROCHESTER HILLS, MI PARCEL #15-28-226-023 & 024

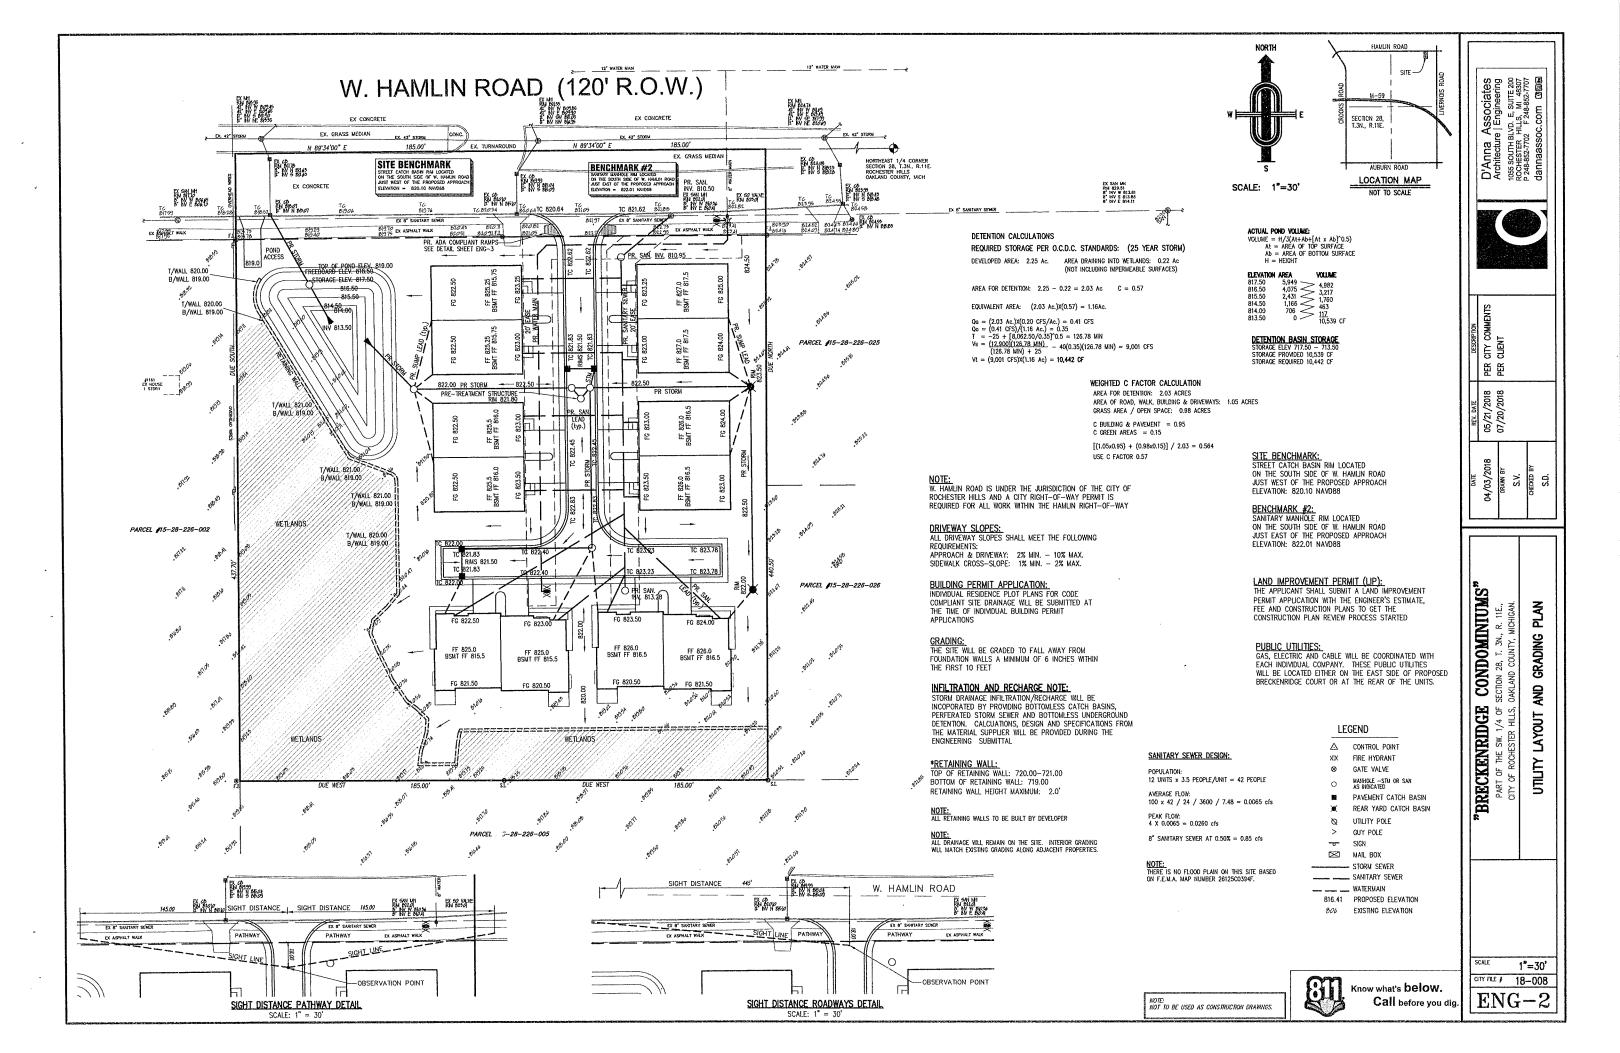CLIENT:
HAMLIV, LLC
JIM POLYZOIS
14955 Technology Dr.,
Shelby Twp., MI 48315
Phone: 586-421-5729
FAX: 586-421-5742
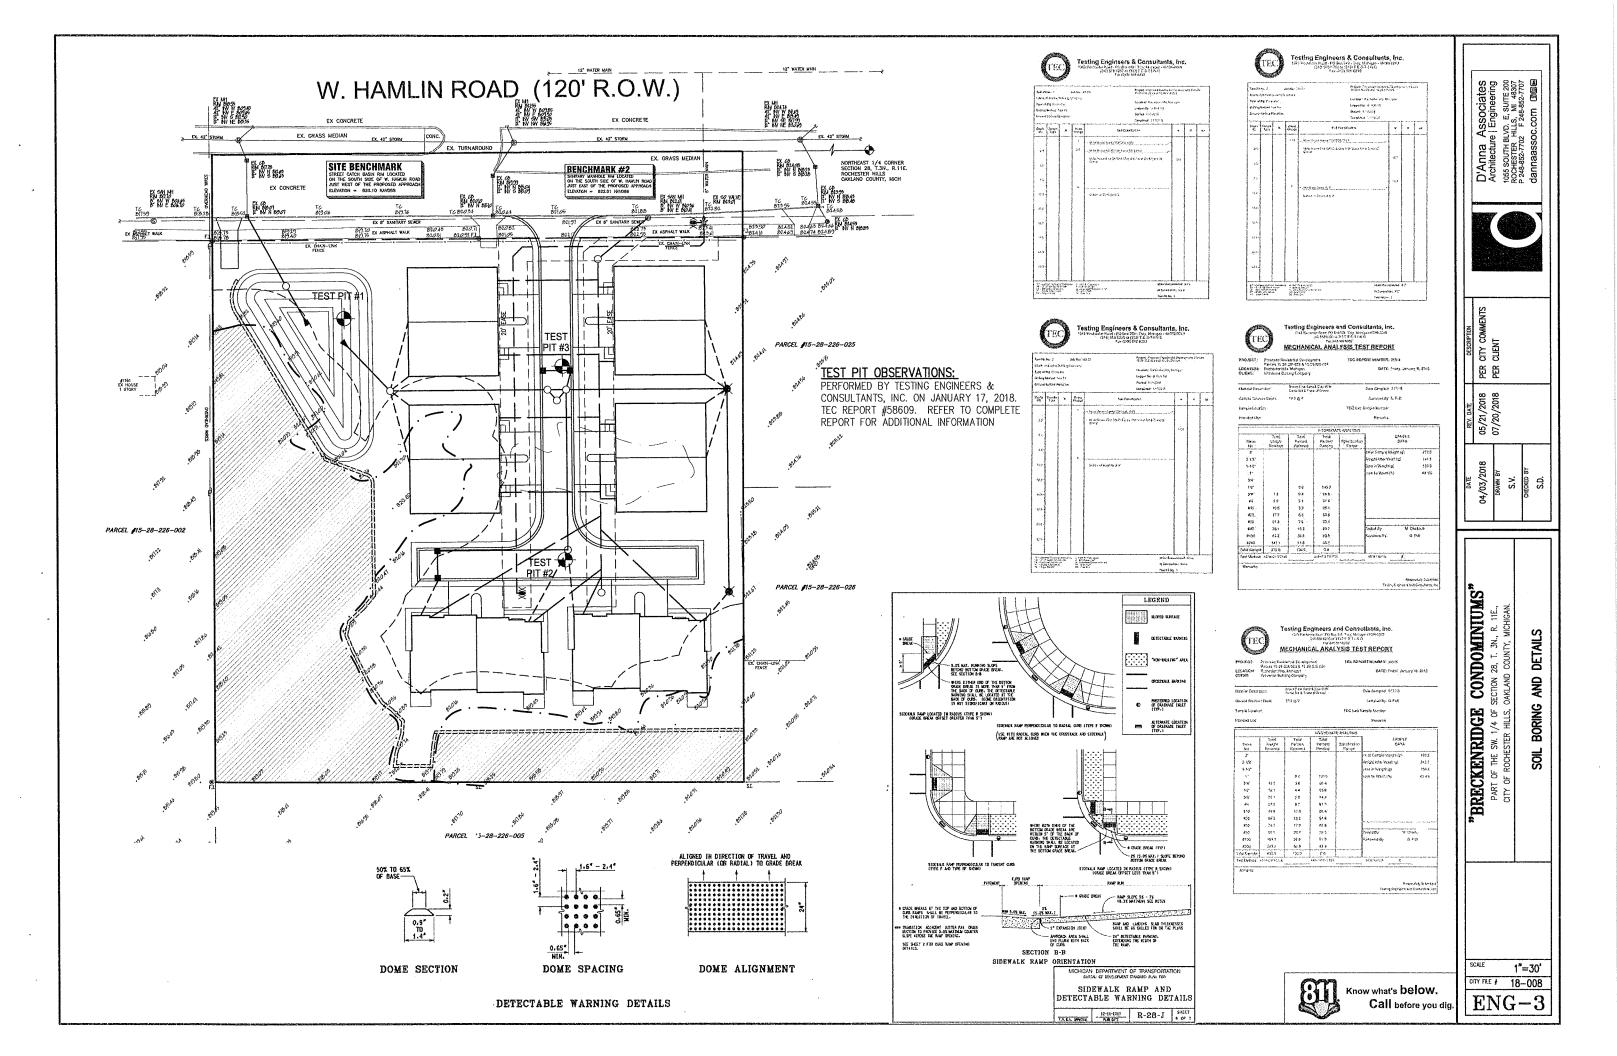
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23 Client's F	Revisions	7/20/2018
2 No chang	100	

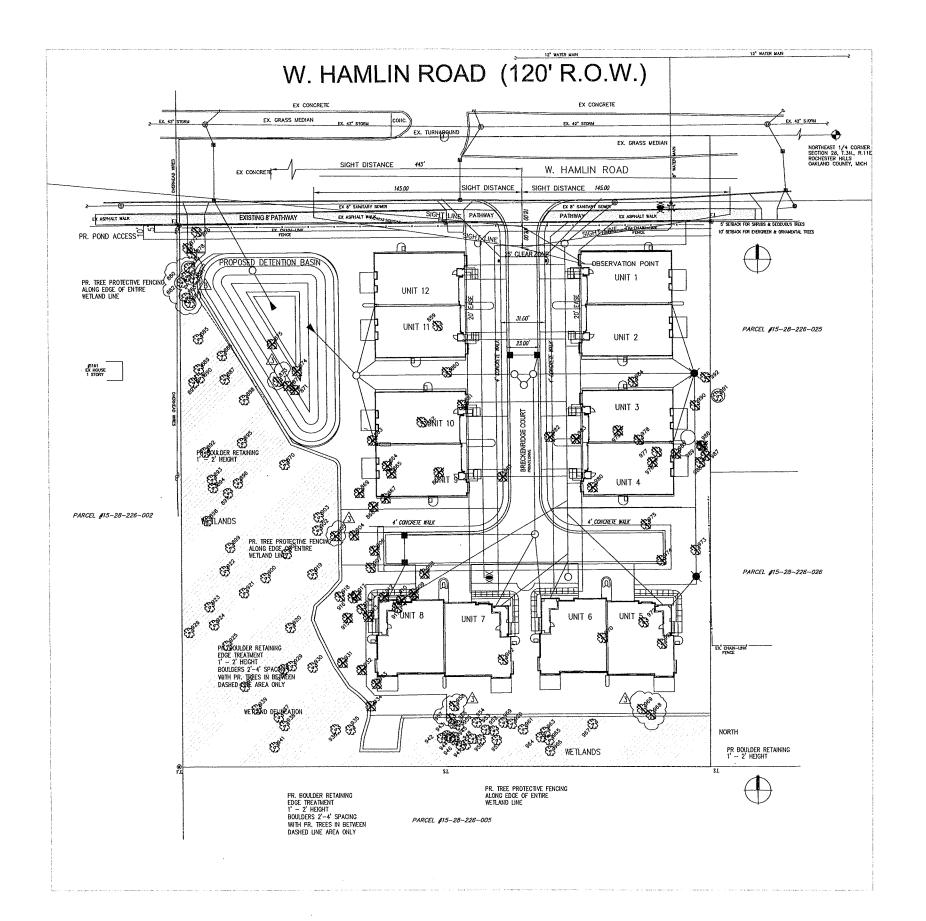LAIDSCAPE ARCHTECTURE • URBAN 249 Park Street Troy, Michigan 48083 P: 248, 397, 8540 nunezdesigninc@gmail.com

P: 248, 397, 8540 nunezdesigninc@gmail Designed / Drawn RN Checked / Approved RN

Job # N-01-28



SHEET: CITY FILE # 18-008

EXISTING TREE SURVEY T-1.0

TREE SURVEY LEGEND

TREE ANALYSIS:

TOTAL # OF TAGGED TREES

PRESERVED REGULATED

**REMOVED - REGULATED &** 

DEAD, ASH TREES, & DISEASED AMERICAN ELM -

TREE PROTECTION FENCING

=134

**EXEMPT + REMOVED** 

REPLACED

# OFF SITE TAGGED TREES (PRESERVED)
# DEAD TREES (NON-REGULATED)

TOTAL # OF REGULATED TREES REMOVED

TOTAL # OF REGULATED TREES PRESERVED
TOTAL % TREES PRESERVED

TOTAL # OF REPLACEMENT CREDITS REQUIRED

TOTAL # OF REPLACEMENT CREDITS PROVIDED

REFER TO SHEET LA 1.0 FOR THE BREAKDOWN OF PLANT SIZES, REPLACEMENT CREDITS AND LOCATION

NOTE: TREE PROTECTION FENCING IS REQUIRED REFER TO NOTES AND DETAIL 1 SHEET LA-2.0

# OF TREES PRESERVED (MINIMUM 37% REQUIRED)

ASH TREES (NON-REGULATED)
OF REGULATED TREES

## Tree Inventory Parcel #9 15-28-226-023 & 024 S. off Hamlin Rd, W. of Livernois Rd City of Rochester Hills, Michigan

By: Mike's Tree Surgeons, Inc. John P. Moses Registered Forester - Michigan ID # 3301045988

EX Tree recommended for replacement exemption per Ordinance section 126-267(5) - Health

EX - EAB Tree is showing outward syngiforms of Emerald Ash Borer activity (Agritus planipennis)

A Health determined using International Society of Abbricature guidelines (9th Edition)

Crown spread is visually estimated at plus or minus five (5) feet in diameter

F	Tree Tag	D.B.H.	0-1-10-10-10-10-10-10-10-10-10-10-10-10-	Health	Crown	Notes	Removed/	Replaced
L	#	(Inches)	Species Name ( Common - Scientific )	Condition*	Spread"	Notes	Preserved	
	859	16	Cottonwood - Populus deltoides	Good	20		Removed	R
L	860	14	Cottonwood - Populus deltoides	Fair	20		Removed	R
- 1	861	13.12,12	Cottonwood - Populus deltoides	Good	20		Removed	R
	862	77	Crabapple - Malus spp.	Good	15		Removed	R
- 1	863	6	White Ash - Fraxinus americana	Fair	15	EX - EAB	Removed	
- 1	864	6	White Ash - Fraxinus americana	Poor	15	EX - EAB	Removed	
Į.	865	8	White Ash - Fraxinus americana	Poor	15	EX - EAB	Removed	
Ļ	866	7	White Ash - Fraxinus americana	Poor	1.5	EX - EAB	Removed	
1	867	6	White Ash - Fraxinus americana	Pair	15	EX · EAB	Removed	
1	868	10	White Ash - Fraxinus americana	Poor Fair	20	EX - EAB	Removed	
- 1	869 870	6	White Ash - Fraxinus americana White Ash - Fraxinus americana	Fair	15	EX - EAB	Removed Preserved	<del>  </del>
ŀ	871	7	White Ash - Fraximis americana	Poor	15	EX - EAB	Removed	
ŀ	872	9	White Ash - Fraxinus americana	Very Poor	15	EX - EAB	Removed	
_	873	8	White Mulberry - Morus alba	Poor	20	CXTEAD	Removed	R
<b>A</b>	874	6,6	White Ash - Fraxinus americana	Poor	15	EX - EAB	Removed	
ŀ	875	7	White Ash - Fraxinus americana	Fair	15	EX - EAB	Removed	t
ŀ	876	12	White Poplar - Populus alba	Pour	20	E/( 2.1.5	Removed	R
ł	877	7	White Poplar - Populus alba	Very Poor	20		Removed	R
i	878	7	White Poplar - Populus alba	Very Poor	20		Removed	R
A	879	17	White Poplar - Populus alba	Fair	25		Preserved	
Ä	880	9	White Poplar - Populus alba	Poor	15		Preserved	
Δ Δ Δ	881	7	White Poplar - Populus alba	Very Poor	15		Preserved	
A	882	8	White Poplar - Populus alha	Very Poor	15		Preserved	
Ā	883	14,13	White Poplar - Populus alba	Fair	25		Preserved	
Ā	884	10	Boxelder - Acer negundo	Poor	20		Preserved	
	885	- 8	Cottonwood - Populus deltoides	Good	15		Preserved	
ı	886	6	White Ash - Fraxinus americana	Very Poor	15	EX - EAB	Preserved	
	887	9	Boxelder - Acer negundo	Fair	20		Preserved	
	888	9	White Ash - Fraxinus americana	Fair	15	EX - EAB	Preserved	
	889	10	Cottonwood - Populus deltoides	Fair	20		Preserved	
	890	7	Crabapple - Malus spp.	Poor	15		Preserved	
	891	16	Cottonwood - Populus deltoides	Good	25		Preserved	+
	892	14,7	Boxelder - Acer negundo	Fair	30	ļ	Preserved	
	893	9	Boxelder - Aver negundo	Poor	25	L	Preserved	
	894	7	White Ash - Fraxinus americana	Fair	15	EX - EAB		_
	895	7	White Ash - Fraxinus americana	Dead	10	EX	Preserved	
	896	6	White Ash - Fraxinus americana	Fair	15	EX - EAB		
	897	9	Boxelder - Acer negundo	Poor	20	EV 540	Preserved	
	898	7	White Ash - Fraxinus americana	Poor	15	EX - EAB	Preserved	
	899 900	6	White Ash - Fraxinus americana	Dead Fair	20	EX - EAB		
		8	White Ash - Fraxinus americana		20	EX-EAD	Preserved	-
	901 902	8	Boxelder - Acer negundo White Ash - Fraxinus americana	Poor	15	EX - EAB		-
	903	6	White Ash - Fraxinus americana	Very Poor		EX - EAS		
	904	7	White Ash - Fraxinus americana	Very Poor	15	EX - EAB		
A	905	7	White Ash - Fraxinus americana	Fair	15	EX - EAB		<b>†</b>
757	906	6	White Ash - Fraxinus americana	Fair	15	EX - EAB		1
	907	10	Boxelder - Acer negundo	Fair	20		Removed	R
	908	6	White Ash - Fraxinus americana	Fair	15	EX - EAE	Removed	
	909	11	American Elm - Ulmus americana	Dead	20	EX	Removed	
	910	6	White Ash - Fraxinus americana	Fair	15	EX - EAE	Removed	
	911	1)	Siberian Elm - Ulmus pumila	Fair	15		Removed	R
	912	6	White Ash - Fraxinus americana	Poor	15	EX - EAE	Removed	
	913	12	White Ash - Fraxinus americana	Very Poor		EX - EAE	Removed	
	914	11	Siberian Elm - Ulmus pumila	Fair	20	1	Removed	
	915	10	White Ash - Fraxinus americana	Poor	20	EX - EAE		
	916	9	Boxelder - Acer negundo	Poor	20		Removed	
	917	7	White Ash - Fraxinus americana	Very Poor		EX - EAL		
Λ	918	6	Crabapple - Malus vpp.	Fair	15		Removed	R

		,		,				
-	919	6	White Ash - Fraxinus americana	Poor	15	EX - EAB	Preserved	
ŀ	920 921	10	Black Maple - Acer nigrum	Good	25		Preserved	
- 1	922	6 7	White Ash - Fraxinus americana	Fair	15 15	EX - EAB	Preserved	
H	923	9	Boxelder - Acer negundo Boxelder - Acer negundo	Poor Fair	20		Preserved Preserved	
ŀ	924	q	Boxelder - Acer negundo  Boxelder - Acer negundo	Poor	20		Preserved	
- 1	925	7	White Ash - Fraxinus americana	Poor	15	EX - EAB	Preserved	
ŀ	926	6	White Ash - Fraxinus americana	Very Poor	10	EX - EAB	Preserved	
ŀ	927	13	Boxelder - Acer negundo	Good	25	FV - FVD	Preserved	-
ı	928	10	Boxelder - Acer negundo	Fair	25		Preserved	
ı	929	7	White Ash - Fraxinus americana	Fair	15	EX - EAB	Preserved	
ı	930	7	White Ash - Fruxinus americana	Fair	15	EX - EAB	Preserved	
ı	931	7	White Ash - Fraximus americana	Fair	15	EX - EAB	Removed	
Ī	932	8	White Ash - Fraximus americana	Very Poor	15	EX - EAB	Removed	
1	933	6	White Ash - Fraxinus americana	Very Poor	15	EX - EAB	Removed	
	934	7	White Ash - Fraxinus americana	Very Poor	15	EX - EAB	Removed	
Г	935	- 8	White Ash - Fraxinus americana	Very Poor	15	EX - EAB	Preserved	
	936	7	White Ash - Fraxinus americana	Fair	15	EX - EAB	Preserved	
	937	8	Boxelder - Acer negundo	Fair	15		Preserved	
	938	6	White Ash - Fraxinus americana	Dead	10	EX	Preserved	
	939	10	Boxelder - Aver negundo	Good	25		Proserved	
L	940	15	Boxelder - Acer negundo	Good	30		Preserved	
	941	6	White Ash - Fraxinus americana	Poor	15	EX - EAB	Preserved	
L	942	9,6	Cottonwood - Populus deltoides	Poor	20		Preserved	
I.	943	10	Cottonwood - Populus deltoides	Very Poor	20	<u> </u>	Preserved	
L	944	8	Black Willow - Salix nigra	Very Poor	20	ļ	Preserved	
-	945	6	Cottonwood - Populus deltoides	Poor	15		Preserved	
-	946	16,12,11,8	Cottonwood - Populus deltoides	Fair	35		Preserved	
-	947	6	Cottonwood - Populus deltoides	Very Poor	15		Preserved	
- 1	948 949	19	Cottonwood - Populus deltaides	Good	25		Preserved	<b></b>
ŀ	950	7 13,9	Cottonwood - Populus deltoides	Very Poor	10		Preserved	
ŀ	951		Cottonwood - Populus deltoides	Poor	20 10		Preserved	
H	952	11,7,6	Cottonwood - Populus deltoides Cottonwood - Populus deltoides	Very Poor Fair	20		Preserved Preserved	l
ŀ	953	8	Cottonwood - Populus deltoides	Poor	15		Preserved	ļ
ŀ	954	8	Cottonwood - Populus deltoides	Very Poor	20		Preserved	
H	955	6	Cottonwood - Populus deltoides	Very Poor	10		Preserved	
t	956	6	Cottonwood - Populus deltoides	Very Poor	10	-	Preserved	
Δ	957	6	Cottonwood - Populus deltoides	Poor	15		Removed	R
Ã	958	16	Cottonwood - Populus deltoides	Good	30		Removed	R
223	959	9	Cottonwood - Populus deltoides	Very Poor	20	-	Preserved	ii
t	960	16	Cottonwood - Populus deltoides	Good	30		Preserved	·
t	961	18	Cottonwood - Populus deltoides	Fuir	30		Preserved	
- 1	962	6	Eastern Red Cedar - Juniperus virginiana	Good	10		Removed	R
ı	963	14,10	Cottonwood - Populus deltoides	Fair	20		Preserved	
ı	964	8	Black Willow - Salix nigra	Poor	10		Preserved	
ı	965	16	Cottonwood - Populus deltoides	Fair	20		Preserved	
[	966	7	White Ash - Fraxinus americana	Very Poor	10	EX - EAB	Preserved	
	967	12,11,11	Black Willow - Salix nigra	Good	30		Preserved	
Δ	968	14	Black Willow - Salix nigra	Poor	25		Removed	R
Δ	969	22	Cottonwood - Populus deltoides	Good	30		Removed	R
Į.	970	7	Boxelder - Acer negundo	Fair	15		Removed	R
- 1	971	7	Boxelder - Acer negundo	Good	15	ļ	Removed	R
I	972	6	Russian Olive - Elacagnus angustifolia	Very Poor	15	L	Removed	R
- 1	973	6	Boxelder - Acer negundo	Fair	15	ļ	Removed	R
ļ	974	6	Boxelder - Acer negundo	Poor	15	<u> </u>	Removed	R
	975	10,7	Black Cherry - Prunus serotina	Very Poor	20		Removed	R
- 1	976	8	White Ash - Fraxinus americana	Poor	15	EX - EAB	Removed	
- 1	977	9	White Mulberry - Morus alba	Good	15	-	Removed	R
- 1	978 979	6	White Mulberry - Morus alba	Fair	15	Fy =:-	Removed	R
		7	White Ash - Fraxinus americana	Fair	15	EX - EAB	Removed	
I	980 981	7,7	White Ash - Frazinus americana	Poor Vore Boor	15	EX - EAB	Removed	<del> </del>
	981	8	White Ash - Fraximis americana White Ash - Fraxinus americana	Very Poor	15	EX - EAB	Removed	<b></b>
	982	6	White Ash - Fraximis americana White Ash - Fraximis americana	Fair	15 15	EX - EAB	Removed	
}	984	7	Austrian Pine - Pinus nigra	Fair Fair	15	EX-EAB	Removed Removed	R
1	985	7	White Ash - Fraxinus americana	Dead	15	EX	Removed	<del>  ^</del>
1	986	9,6	White Mulberry - Morus alba	Fair	25		Removed	R
1	987	6,6	White Ash - Fraxinus americana	Very Poor	10	EX - EAB	Removed	<del>  ^</del> _
1	988	6	White Ash - Fraxinus americana	Dead	10	EX	Removed	<del> </del>
1	989	6	White Mulherry - Morus alba	Fair	15	<del></del>	Removed	R
	990	6,6	Crabapple - Malus spp.	Fair	15		Removed	R
	991	10	Boxelder - Acur negundo	Good	20	Offsite	Preserved	<del></del>
	992	7 7	Black Walnut - Juglans nigra	Good	15		Removed	R
1								

TREE REPLACEMENT CREDITS

TREE-CREDITS PROVIDED = 36

IF REQUIRED TREES CANNOT BE BE PLANTED DUE TO INFRASTRUCTURE CONFLICTS, A PAYMENT IN LIEU OF MAY BE MADE TO THE CITY'S TREE FUND AT A RATE OF \$216.75 PER TREE.

AN AUTOMATIC IRRIGATION SYSTEM IS INCLUDED FOR THE LANDSCAPE AREAS AS REQUIRED BY CITY OF ROCHESTER HILLS

S. off Hamlin Rd, W. of Livernois Rd City of Rochester Hills, Michigan July 18, 2017

Species	Good	Fair	Poor	Very Poor	Dead	Totals	%
American Elm	0	0	0	0	1	1	0.7%
Austrian Pine	0	1	0	0	0	1	0.7%
Black Cherry	0	0	0	1 1	0	1	0.7%
Black Maple	1	0	0	0	0	1	0.7%
Black Walnut	1	0	0	0	0	1	0.7%
Black Willow	1	0	2	1	0	4	3.0%
Boxelder	5	8	7	1 1	0	21	15.7%
Cottonwood	8	7	5	8	0	28	20.9%
Crabapple	1	2	1	0	0	4	3.0%
Eastern Red Cedar	1	0	0	0	0	1	0.7%
Russian Olive	0	0	0	1	0	1	0.7%
Siberian Elm	0	2	0	0	0	2	1.5%
White Ash	0	21	15	14	5	55	41.0%
White Mulberry	1	3	T-7	i 0	0	5	3.7%
White Poplar	0	2	2	1 4	0	8	6.0%
Totals	19	46	33	30	6	134	
%	14.2%	34.3%	24.6%	22.4%	4.5%		100.0%

TREE REPLACEMENT CREDITS

Tree Type and Size 2" Caliper Shade Tree Replacement Credits
1 Credit (MINIMUM) 2.5" Caliper Shade Tree 1.5 Credits 2 Credits 3" Caliper Shade Tree

8' Evergreen Trees 9' Evergreen Trees 10' Evergreen Trees 1.5 Credits 2 Credits

TREE ANALYSIS:

TOTAL # OF TAGGED TREES
# OFF SITE TAGGED TREES (PRESERVED) # OFF SITE TAGGED TREES (FRESE)
# DEAD TREES (NON-REGULATED)
# OF REGULATED TREES - <u>50</u> =31 =46 =59

Tree Inventory Summary
Parcel #s 15-28-226-023 & 024

Species	Good	Fair	Poor	Very Poor	Dead	Totals	%
American Elm	0	0	0	0	1	1	0.7%
Austrian Pine	0	1	0	0	0	1	0.7%
Black Cherry	0	0	0	1 1	0	1	0.7%
Black Maple	1	0	0	. 0	0	1	0.7%
Black Walnut	1	0	0	0	0	1	0.7%
Black Willow	1	0	2	1	0	4	3.0%
Boxelder	5	8	7	Î 1	0	21	15.7%
Cottonwood	8	7	5	. 8	0	28	20.9%
Crabapple	1	2	1	0	0	4	3.0%
Eastern Red Cedar	1	0	0	0	0	1	0.7%
Russian Olive	0	0	0	1 1	0	1	0.7%
Siberian Elm	0	2	0	0	0	2	1.5%
White Ash	0	21	15	14	5	55	41.0%
White Mulberry	1	3	7-7-	1 0	0	5	3.7%
White Poplar	0	2	2	1 4	0	8	6.0%



ROCHESTER HILLS, MI PARCEL #15-28-226-023 & N-01-28

BRECKENRIDGE CONDOMINIUMS

CLIENT: HAMLIV, LLC JIM POLYZOIS 14955 Technology Dr., Shelby Twp., MI 48315 Phone: 586-421-5729 FAX: 586-421-5742

Client's Revisions: 7/20/2018

Forestry: Revisions 6/11/2018 

NÚÑEZ DESIGN 249 Park Street Troy, Michigan 48083 P: 248, 397, 8540 nezdesigninc@gmail.c

Designed / Drawn RN Checked / Approved RN lob # N-01-28





SHEET: CITY FILE # 18-008

TREE ANALYSIS

T-1.1

 $\Lambda$ 

# OF TREES PRESERVED (MINIMUM 37% REQUIRED)


TOTAL # OF REGULATED TREES REMOVED
TOTAL # OF REGULATED TREES PRESERVED
TOTAL % TREES PRESERVED

TOTAL # OF REPLACEMENT CREDITS REQUIRED TOTAL # OF REPLACEMENT CREDITS PROVIDED

REFER TO SHEET LA 1.0 FOR THE BREAKDOWN OF PLANT SIZES, REPLACEMENT CREDITS AND LOCATION

NOTE: TREE PROTECTION FENCING IS REQUIRED REFER TO NOTES AND DETAIL 1

= 31

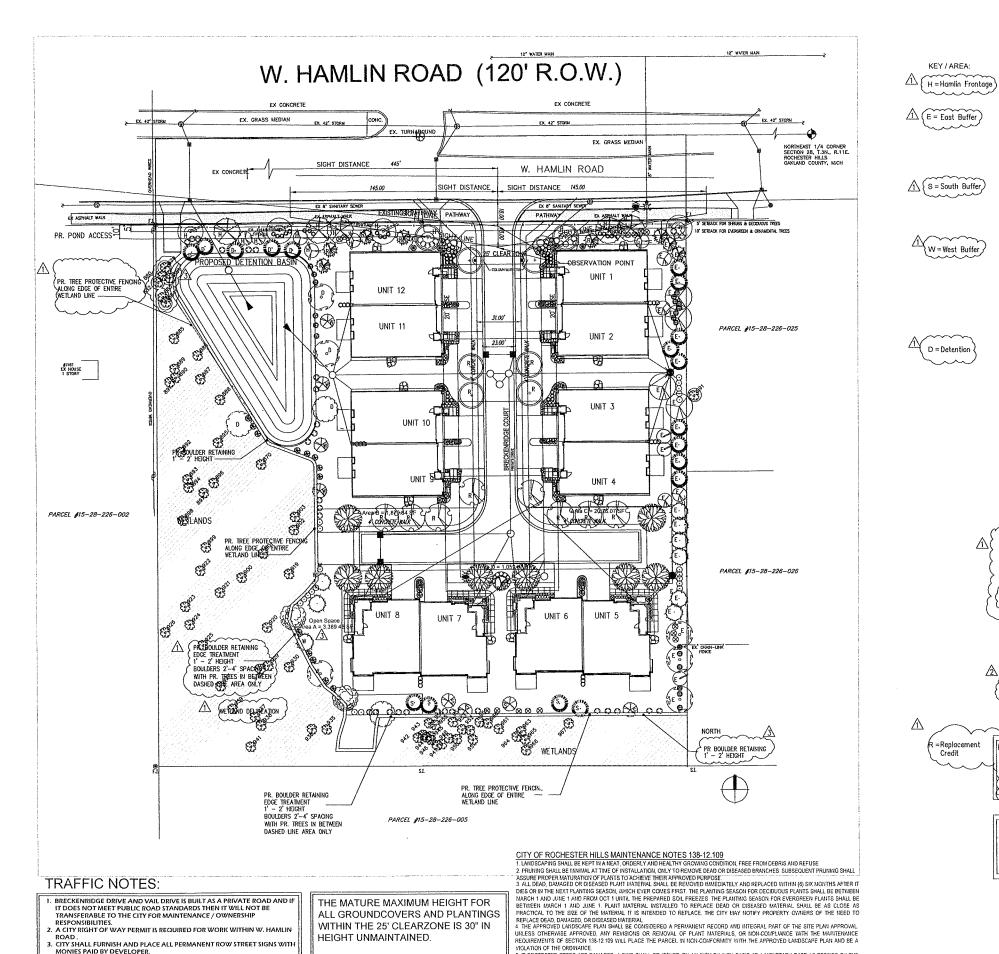

### LANDSCAPE BUFFER STANDARDS

HAMLIN ROAD - FRONTAGE NORTH PROPERTY BOUNDARY: TYPE 'C' BUFFER - 370 LF

KEY / AREA:

D = Detention

1 deciduous per 35 LF.+ 1 ornamental per 60 LF. = 11 deciduous + 6 ornamental REQUIRED EXISTING Deciduous Shade Trees Ornamental Trees  $370 \times 60 = 6$ 

EAST PROPERTY BOUNDARY: TYPE 'C' BUFFER - 440 LF PROPOSED 1 REQUIRED EXISTING Deciduous Shade Trees Evergreen Trees  $44 \times 4 = 176$ 4.4 x 1.5 = 6.6 Ornamental Trees Shrubs  $4.4 \times 6 = 26.4$ 

S = South Buffer SOUTH PROPERTY BOUNDARY: TYPE 'C' BUFFER - 370 LF REQUIRED EXISTING

3.7 x 2 = 7.4 Evergreen Trees  $3.7 \times 4 = 14.8$ 3.7 x 1.5 = 5.55 Ornamental Trees 3.7 x 6 = 22.2

WEST PROPERTY BOUNDARY: TYPE 'C' BUFFER - 338 LF

REQUIRED EXISTING PROPOSED

7 }

39 2 + 39 Credit 3.38 x 2 = 6.76 Deciduous Shade Trees 3.38 x 4 = 13.5 3.38 x 1.5 = 5.07 Evergreen Trees Ornamental Trees 3.38 x 6 = 20.28

STORMWATER DETENTION BUFFER: 484 LF

PROPOSED

4 + 5 Credit Deciduous Shade Trees 4.84 x 1.5 = 7.26 4.84 x 1 = 4.84 Evergreen Trees Omamental Trees 4.84 x 4 = 19.36

#### PLANT MATERIAL REQUIREMENTS:

3 CALIPER INCHES 10 FEET HEIGHT AND 5 FEET SPREAD Evergreen Trees 2 CALIPER INCHES\* OR 6 FEET OVERALL HEIGHT Shrubs 30 INCHES IN HEIGHT, 24 INCHES IN SPREAD WHEN USED FOR SCREENING OR BUFFERING PURPOSES 3 GALLON CONTAINED SIZE WHEN USED FOR

OTHER PURPOSES SHALL BE FROM FLATS Groundcovers

OPEN SPACE REQUIRED: PROVIDED ACTIVE OPEN = 5% OF GROSS SITE AREA 3.73 AC. = 16,2478.8 S.F. X 5% = 8,123.94SF 9,146.20 SF Area A (3.389.48 SF) + Area B (1.870.84) + Area C (2.826.07 SF)+ Area D(1.059.81SF) = 9.146.20 SF Open space permits future access of roadway to the west without losing area designated for open space Refer to plan for location.

#### TREE REPLACEMENT CREDITS QUALIFICATIONS

Replacement Credits	Tree Type and Size	Replacement Credits
~~~~~	~~~~~	·····
= 1 Credit (MINIMUM)	8' Evergreen Trees	= 1 Credit (MINIMUN
= 1.5 Credits	9' Evergreen Trees	- 1.5 Credits محمد
= 2 Credits	10' Evergreen Trees	= 2 Credits
	= 1 Credit (MINIMUM) = 1.5 Credits = 2 Credits	= 1 Credit (MINIMUM) 8' Evergreen Trees = 1.5 Credits 9' Evergreen Trees = 2 Credits 10' Evergreen Trees

=Replacement Credit

F PROTECTED TREES ARE DAMAGED. A FRIE SHALL BE ISSUED ON AN INCH BY INCH RASIS AT A MONETARY RATE AS DEFINED BY THE

TREE CREDITS REQUIRED = 31)/3

TREE CREDITS PROVIDED = 36

18 Trees Provided - (12 [3" cal. deciduous] + 6 [10" ht. evergreen 18 Replacement Trees x 2 CREDITS = 36 Replacement Credits PROVIDED Refer to Sheet T-1.0 for tree impacts

IF REQUIRED TREES CANNOT BE BE PLANTED DUE TO INFRASTRUCTURE CONFLICTS, A PAYMENT IN LIEU OF MAY BE MADE TO THE CITY'S TREE FUND AT A RATE OF \$216.75 PER TREE.

CONDOMINIUMS BRECKENRIDGE ROCHESTER HILLS, M PARCEL #15-28-226-0: N-01-28

CLIENT: HAMLIV, LLC JIM POLYZOIS 14955 Technology Dr., Shelby Twp., MI 48315 Phone: 586-421-5729 FAX: 586-421-5742

Client's Revisions: 7/20/2018 2 Forestry: Revisions 6/11/2018 Submittal: Revisions 6/1/2018
Submittal: PREUM, DESIGN 4/9/2016

NÚÑEZ DESIGN

Troy, Michigan 48083 P: 248 397, 8540 nunezdesigninc@gmail.co

Designed / Drawn RN Checked / Approved RN lob # N-01-28






CITY FILE # 18-008

LA-1.0

LANDSCAPE CONCEPT PLAN

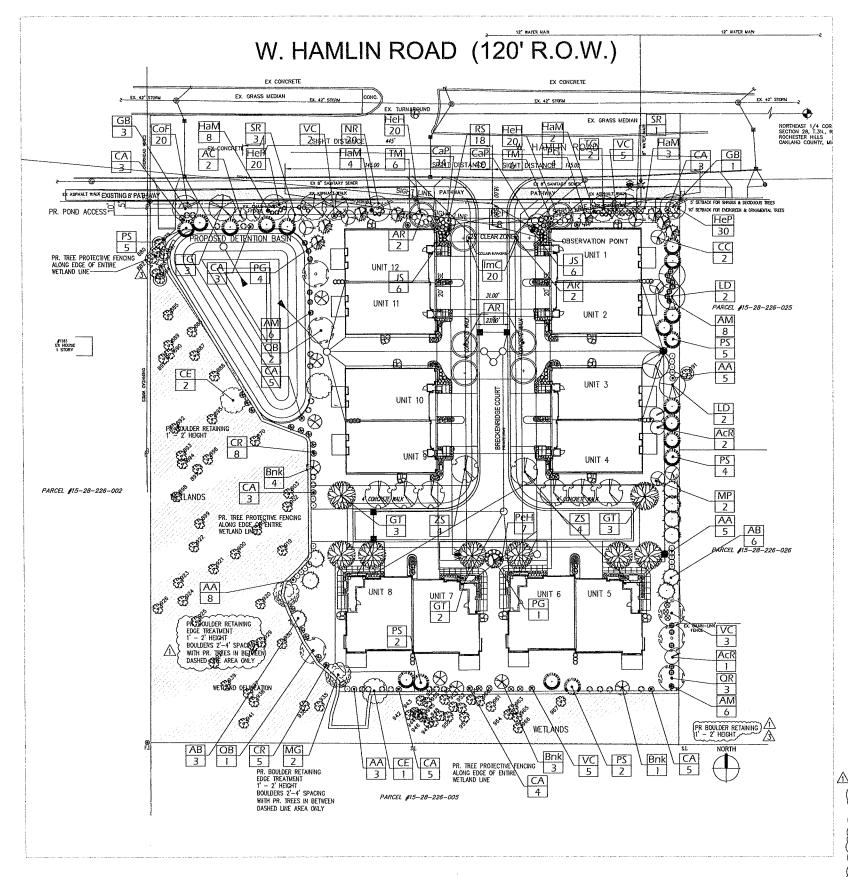

THE MATURE MAXIMUM HEIGHT FOR ALL GROUNDCOVERS AND PLANTINGS WITHIN THE 25' CLEARZONE IS 30" IN HEIGHT UNMAINTAINED.

AN AUTOMATIC IRRIGATION SYSTEM IS INCLUDED FOR ALL LANDSCAPE AREAS AS REQUIRED BY CITY OF ROCHESTER

IRRIGATION OVERSPRAY SHALL NOT BROADCAST ONTO THE CITY PATHWAY

### MATERIAL LIST:

Subtotal: Sheet LA-1.1

SHAUE	TREES			·		
QTY	KEY	BOTANICAL / COMMON NAME	SIZE	ROOT	UNIT COST	TOTAL / ITEM
8	AR	Acer rubrum 'Bowhall' / Bowhall Red Maple	3" cal	B&B	335.00	2,680.00
3	CE	Celtis occidentalis / Common Hackberry	3" cal	888	320.00	960.00
4	GB	Ginkgo biloba 'Lakeview' / Lakeview Maidenhair Tree	3" cal	88B	365.00	1,460.00
8	GT	Gleditsia triacanthos inemis / Thornless Honeylocust	3" cal	B&B	320.00	2,560.00
4	LD	Liriodendron / Tulip Tree	3" cal	888	320.00	1,280.00
2	MG	Metasequoia Glyptostrobodies / Dawn Redwood	3" cal	B&B	335.00	670.00
3	QB	Quercus bicolor / Swamp White Oak	3" cal	B&B	335.00	1,005.00
3	QR	Quercus rubra / Red Oak	3" cal	B&B	335.00	1,005.00
5	TG	Tilia cordata 'Greenspire' / Greenspire Linden	3" cal	B&B	335.00	1,675.00
8	zs	Zelkova serrata 'Musashino' / Musashino Japanese Zelkova	3" cal	888	335.00	2.680.00

L						
EVERGE	REEN TI	REES				
QTY	KEY	BOTANICAL / COMMON NAME	SIZE	ROOT	UNIT COST	TOTAL / ITEM
9	AB	Abies concolor / Concolor White Fir	10' ht x 5' sp	B&B	335.00	3,015.00
9	PG	Picea glauca / White Spruce	10' ht x 5' sp	B&B	320.00	2,880.00
18	PS	Pinus strobus / White Pine	10' ht x 5' sp	B&B	315.00	5,670.00
	~					

QTY	KEY	BOTANICAL / COMMON NAME	SIZE	ROOT	UNIT COST	TOTAL / ITEM
2	AC	Amelanchier canadensis / Shadblow Serviceberry	2" cal or 6' ht	888	250.00	500.0
3	AcR	Amelanchier canadensis 'Refzam' / ReflectionShadblow Serviceberry	2" cal or 6' ht	B&B	250.00	750.0
8	BnK	Betula nigra 'Little King' Fox Valley / Fox Valley River Birch	2" cal or 6' ht	B&B	265.00	2,120.0
2	СС	Cercis canadensis / Eastern Redbud	2" cal or 6' ht	B&B	265.00	530.
12	JS	Juniperus scopularum 'Blue Arrow' / Blue Arros Rocky Mountain Juniper	8' ht	B&B	300.00	3,600.
2	MP	Malus 'Prairifire' / Prairifire Flowering Crabapple	2" cal or 6' ht	B&B	265.00	530.0
4	SR	Syringa reticulata 'Ivory Silk' / Ivory Silk Japanese Tree Lilac	2" cal or 6' ht	8&8	265.00	1,060.

QTY	KEY	BOTANICAL / COMMON NAME	SIZE / SPACING	ROOT	UNIT COST	TOTAL / ITEM
21	AA	Aronia arbutifolia 'Brillantissima' / Brilliant Red Chokeberry	30" ht, 24" sp	No. 3 Cont.	50.00	1,050.0
20	AM	Aronia melanocarpa 'Elata' / Glossy Black Chokeberry	30" ht, 24" sp	No. 3 Cont.	45.00	900.0
31	CA	Cornus alba 'Regnzam' Red Gnome / Red Gnome Siberian Dogwood	30" ht. 24" sp	No. 3 Cont.	45.00	1,395.0
13	CR	Cornus racemosa / Gray Dogwood	30" ht, 24" sp	No. 3 Cont.	45.00	585.0
12	TM	Taxus x media 'Densiformis' / Densiformis Anglojap Hybrid Yew	30" ht, 24" sp	No. 3 Cont.	50.00	600.0
15	VC	Viburnum carlesii / Koreanspice Viburnum	30" ht, 24" sp	No. 3 Cont.	50.00	750.0

QTY	KEY	BOTANICAL / COMMON NAME	SIZE / SPACING	ROOT	UNIT COST	TOTAL / ITEM
74	CaP	Carex pennsylvanica / Pennsylvania Sedge	1' o.c.	No.1	12.00	888.00
17	HaM	Hakonechloa macra / Japanese Forest Grass	1' o.c.	No.1	15.00	255.00
20	ImC	Imperata cylindrica 'Red Baron' / Japanese Blood Grass	1' o.c.	No.1	12.00	240.0
15	PeH	Pennisetum alopecuroides 'Hameln' / 'Hameln' Dwarf Fountain Grass	1' o.c.	No.2	15.00	225.0

QTY	KEY	BOTANICAL / COMMON NAME	SIZE / SPACING	ROOT	UNIT COST	TOTAL / ITEM
20	CoF	Coreopsis 'Full Moon' / 'Full Moon' Coreopsis	1' o.c.	No. 1	12.00	240.00
40	HeH	Hemerocallis 'Happy Returns' / 'Happy Returns' Daylily	1' o.c.	No. 1	12.00	480.00
50	HeP	Hemerocallis 'Pocgzam' Pocket Full of Gold / Pocket Full of Gold Dayllly	1' 0.0.	No. 1	12.00	600.00
20	NR	Nepeta x faassenii 'Walker's Low' / Walker's Low Cat Mint	1' o.c.	No. 1	12.00	240.00
18	RS	Rudbeckia speciosa 'Little Suzy' / 'Little Suzy' Dwarf Orange Coneflower	1' o.c.	No. 1	12.00	216.00

PLANTI	NG MAT	ERIALS (Includes material needed for Sheets LA-1.1, LA-1.3 & LA-1.4)		
QTY (+/-)	UNIT	ITEM	UNIT COST	TOTAL / ITEM
31	CY	Plant Mix TBD	25.00	775.00
55.5	CY	Shredded Hardwood Mulch Installed TBD	45.00	2,497.50
	LBS	Terra-Sorb or Approved Equal (included in plant installation cost)		
LAWN	-4			•

LWANIA				
		Seed or Sod (owner's option) .	0.1	3,505.8
10,760	SF	Storm Water Seed Mix	0.25	2,690.0

	IRRIGATION	UNIT COST	TOTAL / ITEM
(	Refer to Sheet IR-1 for plan and material list prepared by SiteOne	LS	13,500.00
١.			
	LANDSCAPE PROBABLE COST SUMMARY:		

TOTAL LANDSCAPE COST	\$83,048.30
IRRIGATION COST	13,500.00
COST FOR 2 SPRUCE UNITS, Refer to sheet LA-1.4	6,292.00
COST FOR 4 ASPEN UNITS. Refer to sheet LA-1.3	8,494.00
LANDSCAPE MATERIAL PER SHEET LA-1.1	54,762.30
LANDSCAPE PROBABLE COST SUMMARY:	

NÚÑEZ DESIGN



ROCHESTER HILLS, MI PARCEL #15-28-226-023 & 024 N-01-28

BRECKENRIDGE CONDOMINIUMS

CLIENT:
HAMLIV, LLC
JIM POLYZOIS
14955 Technology Dr.,
Shelby Twp., MI 48315
Phone: 586-421-5729
FAX: 586-421-5742





nunezdesigninc@gmail.

Designed / Drawn RN

Checked / Approved RN


Job # N-01-28






Rnew what's below.
Call before you dry.
SHEET:
CITY FILE # 18-008

LA-1.1

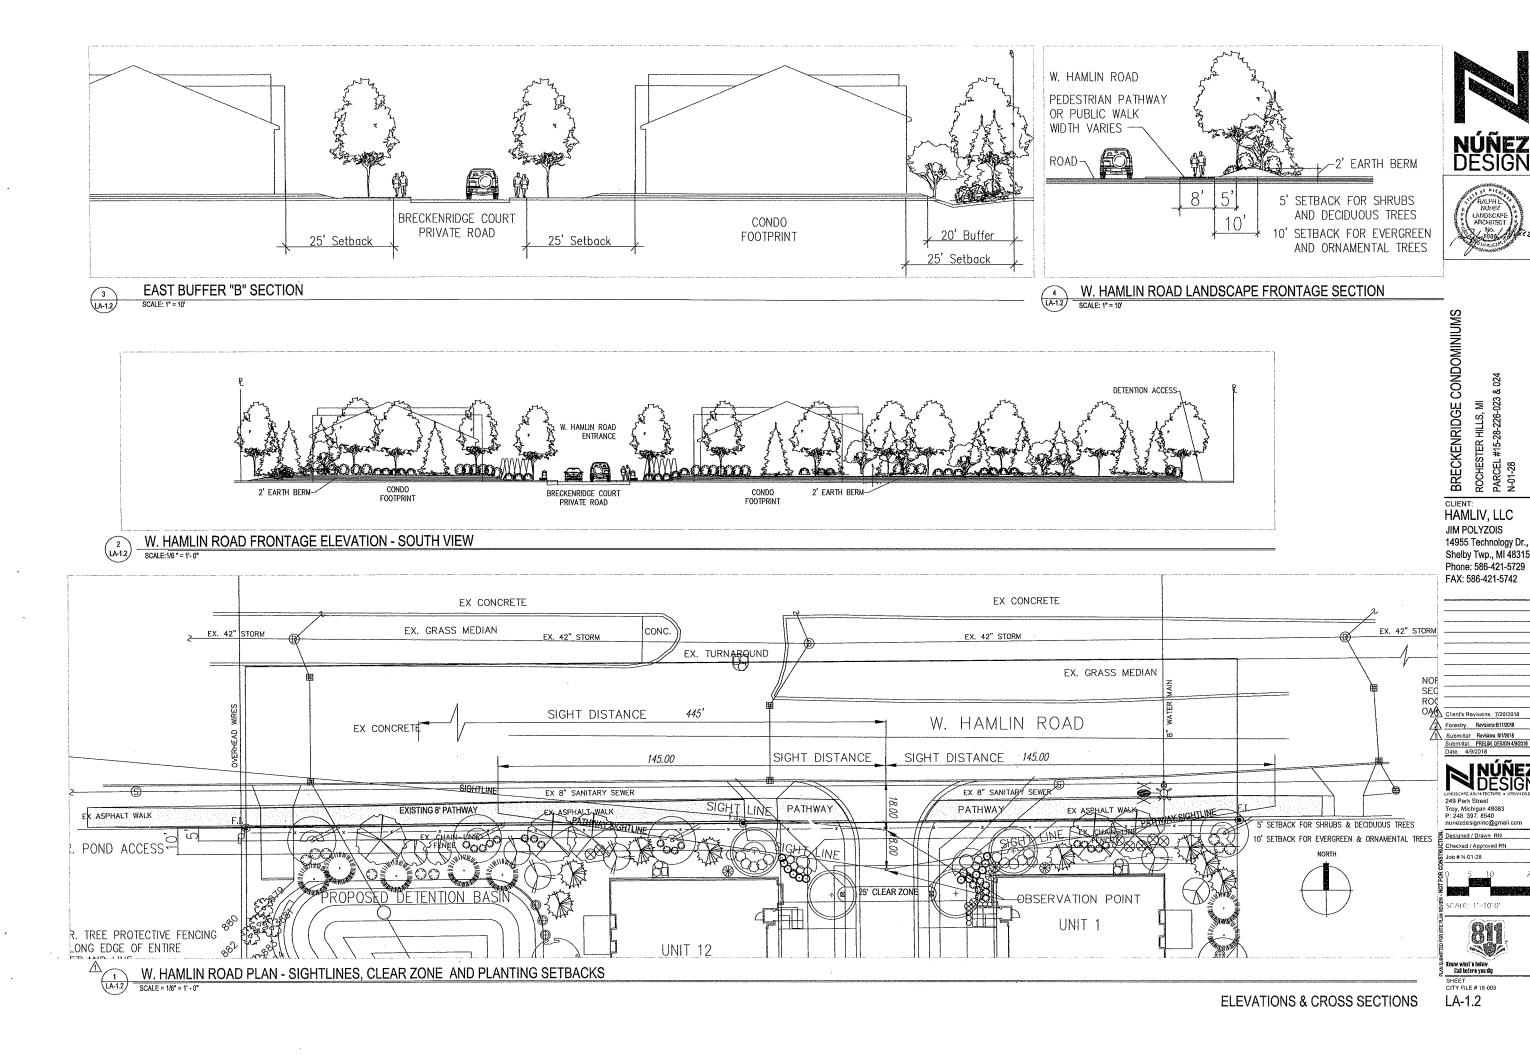

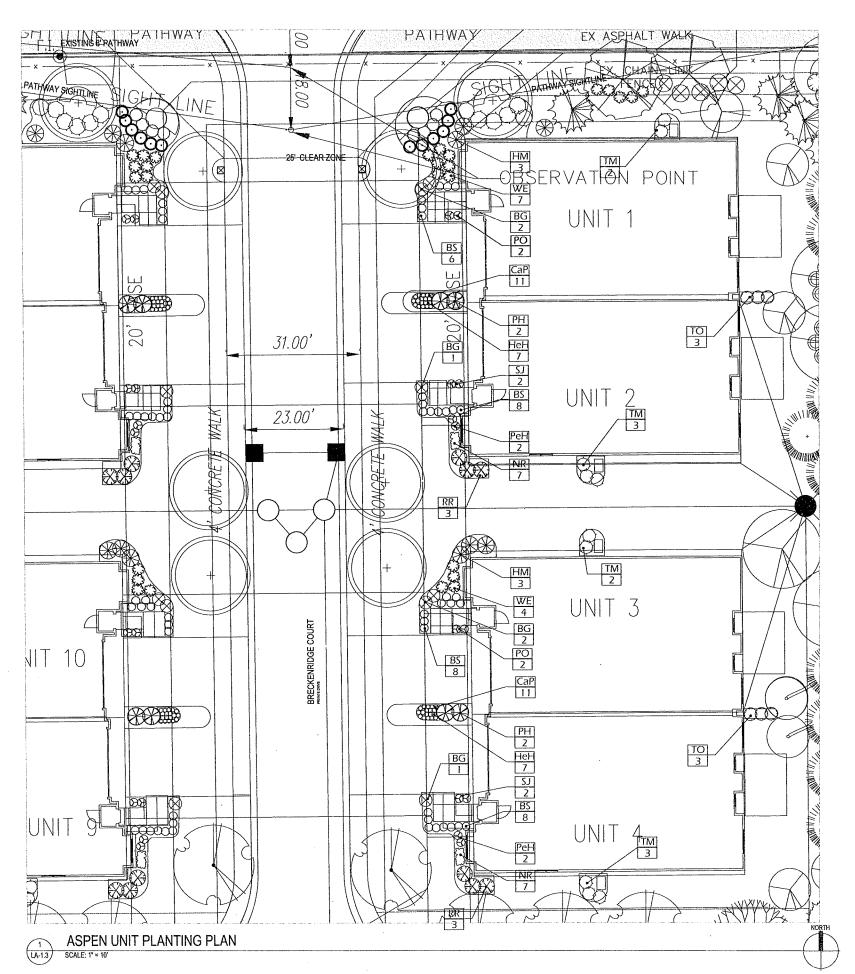

### MATERIAL LIST:

QTY	KEY	BOTANICAL / COMMON NAME	SIZE / SPACING	ROOT	UNIT COST	TOTAL / ITEM
12	BG	Buxus x 'Green Mountain' / Green Mountain Hybrid Boxwood	30" ht	24" BB	95.00	1,140.0
60	BS	Buxus sinica insularis 'Wintergreen' / Wintergreen Korean Boxwood	18' ht, 13' sp	18" BB	28.00	1,680.0
12	HM Hydrangea m . 'Glowing Embers' / Glowing Embers Hydrangea 24" ht, 24" s		24" ht, 24" sp	No. 3 Cont.	50.00	600.0
8	PH	Physocarpus o. 'Donna May' Little Devil / Little Devil Common Ninebark	4' ht, 4' sp	No. 3 Cont.	27.00	216.0
8	PO	Potentilla f. Pink Beauty / Pink Beauty Shrubby Cinquefoil	2' ht, 3' sp	No. 3 Cont.	17.50	140.0
6	RR	Rosa 'Radtko' The Double Knock Out / The Double Knock Out Rose	30" ht, 24" sp	No. 3 Cont.	50.00	300.0
4	SJ	Spiraea japonica 'Little Princess' / Little Princess Japanese Spiraea	18" ht, 18" sp	No. 3 Cont.	45.00	180.0
20	TM	Taxus x media 'Densiformis' / Densiformis Anglojap Hybrid Yew	30" ht, 24" sp	No. 3 Cont.	50.00	1,000.0
12	то	Thuja occidentalis 'Emerald' / Emerald Arborvitae	6' ht	B&B	125.00	1,500.0
22	WE	Weigela f. 'Verweig' My Monet Weigela / My Monet Weigela	2' ht, 2' sp	No. 2 Cont.	19.00	418.0
GRAS	SES &	SEDGES BOTANICAL / COMMON NAME	SIZE / SPACING	ROOT	UNIT COST	TOTAL / ITEM
44	CaP	Carex pennsylvanica / Pennsylvania Sedge	1' o.c.	No.1	12.00	528.0
8	PeH	Pennisetum alopecuroides 'Hameln' / 'Hameln' Dwarf Fountain Grass	1' o.c.	No.2	15.00	120.0
GROU	NDCO	/ERS / PERENNIALS	·			
QTY	KEY	BOTANICAL / COMMON NAME	SIZE / SPACING	ROOT	UNIT COST	TOTAL / ITEM
28	HeH	Hemerocallis 'Happy Returns' / 'Happy Returns' Daylily	1' o.c.	No. 1	12.00	336.0
28	NR	Nepeta x faassenii 'Walker's Low' / Walker's Low Cat Mint	1' o.c.	No. 1	12.00	336.0

THE ASPEN UNITS ON THE EASTERN PLANTING SCHEME (1, 2,3 & 4) WILL BE MIRRORED FOR THE WEST UNITS (9, 10, 11 & 12). THE QUANTITIES IN THE PLANT LIST ACCOUNT FOR THE TOTAL NUMBER OF PLANTS.

THE MATURE MAXIMUM HEIGHT FOR ALL GROUNDCOVERS AND PLANTINGS WITHIN THE 25' CLEARZONE IS 30" IN HEIGHT UNMAINTAINED.

AN AUTOMATIC IRRIGATION SYSTEM IS INCLUDED FOR ALL LANDSCAPE AREAS AS REQUIRED BY CITY OF ROCHESTER



ROCHESTER HILLS, MI PARCEL #15-28-226-023 8 N-01-28

BRECKENRIDGE CONDOMINIUMS CLIENT HAMLIV, LLC JIM POLYZOIS 14955 Technology Dr., Shelby Twp., MI 48315 Phone: 586-421-5729 FAX: 586-421-5742

Client's Revisions: 7/20/2018 Forestry: Revisions 6/11/2018




249 Park Street
Troy, Michigan 48083
P: 248. 397. 8540
nunezdesigninc@gmail.c

Designed / Drawn RN Checked / Approved RN Job # N-01-28





CITY FILE # 18-008 LA-1.3

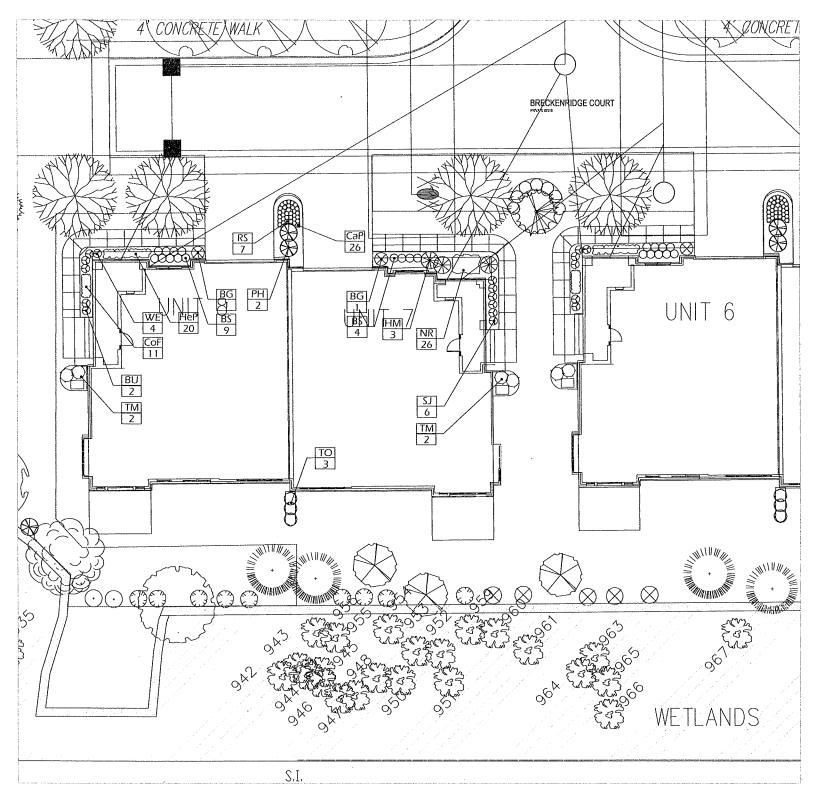

## MATERIAL LIST:

QTY	KEY	BOTANICAL / COMMON NAME	SIZE / SPACING	ROOT	UNIT COST	TOTAL / ITEM
4	BG	Buxus x 'Green Mountain' / Green Mountain Hybrid Boxwood	30" ht	24" BB	95.00	380.00
26	BS	Buxus sinica insularis 'Wintergreen' / Wintergreen Korean Boxwood	18' ht, 18' sp	18" BB	45.00	1,170.00
4	BU	Buddleia x Lo & Behold 'Pink Micro Chip' / Pink Micro Chip Hybrid Butterfly Bush	24" nt, 24" sp	No. 3 Cont.	45.00	180.00
6	НМ	Hydrangea m. 'Glowing Embers' / Glowing Embers Hydrangea	24" ht, 24" sp	No. 3 Cont.	50.00	300.00
4	PH	Physocarpus o, 'Donna May' Little Devil / Little Devil Common Ninebark	4' ht, 4' sp	No. 3 Cont.	65.00	260,0
12	SJ	Spiraea japonica 'Little Princess' / Little Princess Japanese Spiraea	18" ht, 18" sp	No. 3 Cont.	45.00	540.0
8	TM	Taxus x media 'Densiformis' / Densiformis Anglojap Hybrid Yew	30" ht, 24" sρ	No. 3 Cont.	50.00	400.00
6	то	Thuja occidentalis 'Emerald' / Emerald Arborvitae	6' ht	8&8	125.00	750.00
8 GRAS	WE SES &	Weigela f, "Verweig' My Monet Weigela / My Monet Weigela  SEDGES	2' ht, 2' sp	No. 2 Cont.	19.00	152.0
8	WE	Weigela f. 'Verweig' My Monet Weigela / My Monet Weigela	2' ht, 2' sp	No. 2 Cont.	19.00	152.0
			2' ht, 2' sp	No. 2 Cont.	19.00	TOTAL / ITEM
GRAS	SES &	SEDGES			1	TOTAL / ITEM
GRAS QTY	SES &	SEDGES BOTANICAL / COMMON NAME	SIZE / SPACING	ROOT	UNIT COST	TOTAL / ITEM
GRAS QTY 52	SES & : KEY CaP	SEDGES BOTANICAL / COMMON NAME	SIZE / SPACING	ROOT	UNIT COST	
GRAS QTY 52	SES & : KEY CaP	SEDGES BOTANICAL / COMMON NAME Carex pennsylvanica / Pennsylvania Sedge	SIZE / SPACING	ROOT	UNIT COST	TOTAL / ITEM
GRAS QTY 52 GROU	SES & : KEY CaP	SEDGES BOTANICAL / COMMON NAME Carex pennsylvanica / Pennsylvania Sedge (ERS / PERENNIALS	SIZE / SPACING 1' o.c.	ROOT No.1	UNIT COST	TOTAL / ITEM 624.0
GRAS QTY 52 GROU	SES & : KEY CaP INDCOV	SEDGES BOTANICAL / COMMON NAME Carex pennsylvanica / Pennsylvania Sedge //ERS / PERENNIALS BOTANICAL / COMMON NAME	SIZE / SPACING 1' 0.c. SIZE / SPACING	ROOT No.1	UNIT COST 12.00 UNIT COST	TOTAL / ITEM 624.0
GRAS QTY 52 GROU QTY 22	SES & : KEY CaP INDCOV KEY CoF	BEDGES BOTANICAL / COMMON NAME Carex pennsylvanica / Pennsylvania Sedge  VERS / PERENNIALS BOTANICAL / COMMON NAME Coreopsis 'Full Moon' / 'Fool Moon' Coreopsis	SIZE / SPACING 1' 0.c.  SIZE / SPACING 1' 0.c.	ROOT No.1	UNIT COST 12.00 UNIT COST 12.00	TOTAL / ITEM 624.0 TOTAL / ITEM 264.0

THE SPRUCE UNITS ON THE WESTERN PLANTING SCHEME (7 & 8) WILL BE MIRRORED FOR THE EAST UNITS (5 & 6). THE QUANTITIES IN THE PLANT LIST ACCOUNT FOR THE TOTAL NUMBER OF PLANTS.

THE MATURE MAXIMUM HEIGHT FOR ALL GROUNDCOVERS AND PLANTINGS WITHIN THE 25' CLEARZONE IS 30" IN HEIGHT UNMAINTAINED.

AN AUTOMATIC IRRIGATION SYSTEM IS INCLUDED FOR ALL LANDSCAPE AREAS AS REQUIRED BY CITY OF ROCHESTER





BRECKENRIDGE CONDOMINIUMS CLIENT: HAMLIV, LLC JIM POLYZOIS 14955 Technology Dr., Shelby Twp., MI 48315 Phone: 586-421-5729 FAX: 586-421-5742

3 Client's Revisions: 7/20/2018

Designed / Drawn RN Checked / Approved RN

Job # N-01-28

SCALE: 1'=10-0"



OREC 1: CITY FILE # 18-008 LA-1.4

#### **GENERAL NOTES**

#### CITY NOTES

- ALL PLANT MATERIAL SHALL MEET CURRENT STANDARDS OF THE AMERICAN ASSOCIATION OF NURSERYMEN AND APPROVED BY THE AMERICAN NATIONAL STANDARDS INSTITUTE, INC.
- STANDARDIZED PLANT NAMES ESTABLISHED BY THE AMERICAN JOINT COMMITTEE ON HORTICULTURAL NOMENCLATURE, OR OTHER SOURCE ACCEPTED BY THE CITY.
- 3. ALL PLANT MATERIAL SHALL B E NURSERY GROWN IN A NORTHERN CLIMATE; HARDY TO THE CLIMATE OF MICHIGAN; APPROPRIATE FOR THE SOIL; CLIMATIC AND ENVIRONMENTAL CONDITIONS; AND RESISTANT TO DISFASE AND INSECT ATTACK.
- 4. A MINIMUM FOUR (4) INCHES OF TOPSOIL SHALL BE PROVIDED FOR ALL LAWN AREAS, GROUND COVERS,
- 5. ARTIFICIAL PLANT MATERIAL IS PROHIBITED AND SHALL NOT BE USED TO MEET THE REQUIREMENTS OF
- 6. LAWN AREAS SHALL BE PLANTED IN SPECIES OF GRASS NORMALLY GROWN IN MICHIGAN. GRASS MAY BE SODDED OR HYDRO-SEEDED, PROVIDED THAT ADEQUATE MEASURES ARE TAKEN TO MINIMIZE SOIL EROSION, SOD OR SEED SHALL BE CLEAN AND FREE OF WEEDS AND NOXIOUS PESTS OR DISEAS.
- 7. A MINIMUM 4-INCH LAYER OF SHREDDED HARDWOOD BARK SHALL BE PLACED IN ALL PLANTER BEDS CONTAINING TREES OR SHRUBS AND AROUND THE BASE OF ALL TREES PLANTED WITHIN LAWN AREAS ARE TO BE PLANTED IN GROUPS AND MULCHED AS A GROUP, AND HEDGEROWS ARE TO BE MULCHED AS ONE CONTINUOUS STRIP
- 8. LIVE GROUNDCOVERS SUCH AS MYRTLE, BLUE RUG JUNIPERS, BALTIC IVY AND OTHER SIMILAR VINES AND PLANT MATERIAL SHALL BE MULCHED WITH A 2-INCH LAYER OF SHREDDED HARDWOOD BARK, ANY DEVIATIONS MUST BE APPROVED BY THE CITY'S LANDSCAPE ARCHITECT.
- 9.PLANT MATERIALS SHALL NOT BE PLACED CLOSER THAN FOUR FEET FROM THE FENCE LINE OR
- 10. DECIDUOUS AND ALL SHRUBS MAY NOT BE PLANTED WITHIN 5 FEET, AND EVERGREEN TREES MAY NOT BE PLANTED WITHIN TEN (10) FEET OF ANY CURB OR PUBLIC WALKWAY.
- 11. TREES AND SHRUBS MAY NOT BE PLANTED WITHIN 10 FEET OF A FIRE HYDRANT
- 12. WHERE PLANT MATERIALS ARE PLANTED IN TWO OR MORE ROWS, PLANTING SHALL BE STAGGERED IN
- 13. WHERE SHRUB PLANTINGS ARE REQUIRED TO FORM A CONTINUOUS HEDGE. THE PLANTS SHALL NOT BE SPACED OUT MORE THAN 36 INCHES ON CENTER AT PLANTING AND SHALL HAVE A MINIMUM HEIGHT AND SPREAD OF 30 INCHES AT PLANTING, SHRUBS THAT WILL NOT ATTAIN SUFFICIENT WIDTH TO FORM A COMPLETE HEDGE SPACED 36 INCHES ON CENTER SHALL BE PLANTED AT A SPACING THAT WILL ALLOW THEM TO FORM A COMPLETE HEDGE WITHIN TWO YEARS OF PLANTING.

#### RESPONSIBILITY NOTES

- 1. LANDSCAPE CONTRACTOR SHALL VISIT SITE, INSPECT EXISTING CONDITIONS AND REVIEW PROPOSED PLANTING AND RELATED WORK. IN CASE OF DISCREPANCY BETWEEN PLAN AND PLANT LIST, THE PLAN SHALL GOVERN QUANTITIES. CONTACT LANDSCAPE ARCHITECT WITH ANY CONCERNS
- 2. CONTRACTOR SHALL VERIFY LOCATIONS OF ALL ON-SITE UTILITIES PRIOR TO BEGINNING CONSTRUCTION ON HIS/HER PHASE OF WORK ELECTRIC, GAS, TELEPHONE, CABLE TELEVISION MAY BE LOCATED BY CALLING MISS DIG 1-800-482-7171. ANY DAMAGE OR INTERRUPTION OF SERVICES SHALL BE THE RESPONSIBILITY OF CONTRACTOR. CONTRACTOR SHALL COORDINATE ALL RELATED ACTIVITIES WITH OTHER TRADES ON THE JOB AND SHALL REPORT ANY UNACCEPTABLE JOB CONDITIONS TO OWNER'S
- 3 CONTRACTOR WILL SUPPLY FINISHED GRADE AND EXCAVATE AS NECESSARY TO SUPPLY 4" TOPSO! DEPTH IN ALL PLANTING BEDS AND 4" TOPSOIL DEPTH IN ALL LAWN AREAS USING MATERIAL FROM SPOIL
- 4. ACCEPTANCE OF GRADING AND SOD SHALL BE BY THE LANDSCAPE ARCHITECT AND/OR PROJECT REPRESENTATIVE AND AS DETERMINED BY THE CITY. THE CONTRACTOR SHALL ASSUME MAINTENANCE RESPONSIBILITY FOR A MINIMUM OF TWO (2) YEARS. MAINTENANCE SHALL INCLUDE WATERING, WEEDING, REPLACEMENTS OF WASHOUTS AND OTHER OPERATIONS NECESSARY TO KEEP SOD IN A THRIVING CONDITION. UPON FINAL ACCEPTANCE BY LANDSCAPE ARCHITECT AND/OR PROJECT REPRESENTATIVE. AND AS DETERMINED BY THE CITY. THE OWNER SHALL ASSUME ALL MAINTENANCE RESPONSIBILITIES.
- 5. THE CONTRACTOR SHALL GUARANTEE ALL LANDSCAPING FOR A PERIOD OF TWO (2) YEARS BEGI AFTER APPROVAL BY THE CITY OF ROCHESTER HILL'S LANDSCAPE ARCHITECT. THE CONTRACTOR SHALL REPLACE DURING AND AT THE END OF THE GUARANTEE PERIOD, ANY DEAD OR UNACCEPTABLE PLANTS. AS DETERMINED BY THE CITY OF ROCHESTER HILL'S LANDSCAPE ARCHITECT, WITHOUT COST TO THE
- ${\bf 6}.$  Contractor is responsible for verifying all quantities shown on landscape plan prior to pricing the work.

#### LANDSCAPING NOTES

- 1. PRIOR TO THE RELEASE OF THE PERFORMANCE BOND, THE CITY OF ROCHESTER HILLS MUST INSPECT ALL LANDSCAPE PLANTING INCLUDING BUT NOT LIMITED TO EXISTING TREES, REPLACEMENT TREES, BUFFER PLANTINGS, AND PARKING LOT ISLANDS. THE RIGHT-OF-WAY WILL BE INSPECTED BY THE FORESTRY DIVISION TO IDENTIFY ANY PLANTINGS NEW OR EXISTING THAT POSE A HAZARD TO THE SAFE USE OF THE RIGHT-OF-WAY. FORESTRY MAY REQUIRE THE DEVELOPER TO REMOVE AND POSSIBLY PROBLEMS THAT PROPERLY AND POSSIBLY PROBLEMS TO REMOVE PROBLEMS TO REMOVE AND POSSIBLY PROBLEMS TO REMOVE PROBLEMS TO R REPLACE ANY SUCH TREES
- 2. ALL TREES AND SHRUBS MUST BE PLANTED AT LEAST 10' FROM THE EDGE OF THE PUBLIC R.O.W SHADE TREES AND SHRUBS MUST BE PLANTED AT LEAST 5' FROM THE EDGE OF THE PUBLIC WALKWAY. EVERGREEN AND ORNAMENTAL TREES MUST BE PLANTED AT LEAST 10' FROM THE EDGE OF THE PUBLIC WALKWAY ALL TREES AND SHRUBS MUST BE PLANTED AT LEAST 10' FROM ANY FIRE HYDRANT. SHADI AND EVERGREEN TREES MIST BE PLANTED AT LEAST 15' FROM THE NEAREST OVERHEAD WIRE AND AT LEAST 10' FROM THE NEAREST UNDERGROUND UTILITY.
- 3. NO TREES OR SHRIBS MAY BE DIANTED WITHIN THE TRIANGULAR AREA FORMED AT THE INTERSECTION 3. REL INCES ON SHRUBS MAY BE PLANTED WITHIN THE TRIANGULAR AREA FORMED AT THE INTERSECTION OF ANY STREET RIGHT-DE-MAY AT A DISTANCE OF 25 FROM THEIR POINT OF INTERSECTION. NO TREES OR SHRUBS MAY BE PLANTED IN THE TRIANGULAR AREA FORMED AT THE INTERSECTION OF ANY DRIVEWAY WITH A PUBLIC WALKWAY AT A DISTANCE ALONG EACH LINE OF 15' FROM THEIR POINT OF INTERSECTION.
- 4. PRIOR APPROVAL IS REQUIRED TO PLANT ANY TREE OR SHRUB IN THE PUBLIC RIGHT-OF-WAY
- NO SUBSTITUTIONS OR CHANGES OF LOCATION OR PLANT TYPES SHALL BE MADE WITHOUT THE APPROVAL OF THE DEVELOPER AND THE CITY OF ROCHESTER HILLS.
- 6. THE DEVELOPER AND/OR THE CITY OF ROCHESTER HILL SHALL HAVE THE RIGHT, AT ANY STAGE OF T INSTALLATION, TO REJECT ANY WORK OR MATERIAL THAT DOES NOT MEET THE REQUIREMENTS OF THE PLANS OR SPECIFICATIONS.
- 7. REPLACEMENT TREES MAY NOT BE PLANTED WITHIN THE DRIP LINE OF EXISTING TREES
- 8 NO PLANT SUBSTITUTIONS OR CHANGES OF LOCATION OR PLANT TYPE SHALL BE MADE WITHOUT THE 8. NO PLANT SUBSTITUTIONS OR CHANGES OF LOCATION OR PLANT TYPE SHALL BE MADE WITHOUT IN APPROVAL OF THE LANDSCAPE ARCHITECT AND THE CITY'S PLANNING DEPARTMENT. ALL REQUESTS WILL RE SUBMITTED TO THE LANDSCAPE ARCHITECT IN WRITING THE REQUEST WILL INCLUDE THE REASON FOR THE REQUESTE WILL INCLUDE THE REASON FOR THE REQUESTE OF THE PROPOSED SUBSTITUTION AND HOW IT MEETS THE GRIGINAL DESIGN INTENT, SIZE, COLOR, ETC. THE LANDSCAPE ARCHITECT WILL EITHER MAKE RECOMMENDATIONS, APPROVE OR REJECT REQUESTS IF THE SUBSTITUTION IS REEDED AND APPROVED, THE LANDSCAPE ARCHITECT WILL FORWARD THE REQUEST AND HIS APPROVAL, TO THE CITY FOR THEIR APPROVAL FAILURE TO DO SO WILL RESULT IN PLANTS BEING REJECTED AND REPLACED AT CONTRACTOR'S EXPENSE.
- 9. TREES MUST BE AT LEAST 10' FROM UNDERGROUND UTILITIES AND 15' FROM OVERHEAD. UTILITIES
- 10. THESE REQUIREMENTS ARE INCORPORATED INTO THE PLAN.

CITY OF ROCHESTER HILLS NOTES 1. ALL LANDSCAPE AREAS MUST BE IRRIGATED. WATERING WILL ONLY OCCUR BETWEEN THE HOURS OF 12 AM AND 8 AM. IRRIGATION PLAN TO BE PROVIDED AT FINAL SUBMITTAL.

(2. IRRIGATION OVERSPRAY SHALL NOT BROADCAST ONTO THE CITY PATHWAY.

3. SIGNS SHALL MEET THE REQUIREMENTS OF CHAPTER 134 OF THE CITY'S CODE OF ORDINANCES.

#### TREE PROTECTION NOTES

1. THE TREE PROTECTION FENCING (TPF) SHALL BE ERECTED PER THE PLANS APPROVED BY THE CITY OF ROCHESTER HILLS PLANNING DEPARTMENT. THE TPF MUST BE IN PLACE AND BE INSPECTED BY THE CITY OF ROCHESTER HILLS PRIOR TO THE START OF ANY EARTHWORK OR CONSTRUCTION OFERATIONS IT IS THE DEVELOPER'S RESPONSIBILITY TO CONTACT THE CITY PLANNING DEPARTMENT AT 1-248-56-4660 TO SCHEDULE A TPF INSPECTION. THE TPF SHALL REMAIN IN PLACE THROUGHOUT THE ENTIRE CONSTRUCTION DROCESS. OR HUMB THE CONTACT THE ENTIRE CONSTRUCTION PROCESS OR UNTIL THE CITY AUTHORIZES THE REMOVAL OR ISSUES A FINAL CERTIFICATE OF OCCUPANCY, WHICHEVER OCCURS FIRST,

- 2. UPON COMPLETION OF GRADING AND THE INSTALLATION OF THE INFRASTRUCTURE A SECOND 2. OF ON THE THE AND THE TREES DESIGNATED FOR PRESERVATION IS REQUIRED BY THE CITY OF ROCHESTER HILLS PRIOR TO THE START OF ANY ADDITIONAL CONSTRUCTION. IT IS THE DEVELOPER'S RESPONSIBILITY TO CONTACT THE CITY PLANNING DEPARTMENT AT 1:248-65-4660 TO
- 3. UPON COMPLETION OF ALL CONSTRUCTION AND PRIOR TO THE REMOVAL OF THE CITY OF ROCHESTER HILLS MUST INSPECT ALL TREES DESIGNATED TO BE PRESERVED. THE LANDSCAPE PERFORMANCE BOND WILL NOT BE RELEASED UNITL THIS INSPECTION IS COMPLETE AND ALL RELATED ISSUES ARE RESOLVED. IT IS THE DEVELOPER'S RESPONSIBILITY TO CONTACT THE CITY PLANNING DEPARTMENT AT 1-248-656-4660 TO SCHEDULE THIS INSPECTION.
- 4. A FINAL INSPECTION BY THE CITY OF ROCHESTER HILLS IS REQUIRED AT THE END OF THE WARRANTY AND MAINTENANCE PERIOD. THE LANDSCAPE MAINTENANCE BOND WILL NOT BE RELEASED UNTIL THIS INSPECTION IS COMPLETE AND ALL RELATED ISSUES ARE RESOLVED. IT IS THE DEVELOPER'S RESPONSIBILITY TO CONTACT THE CITY PLANNING DEPARTMENT AT 1-248-656-4660 TO SCHEDULE THIS
- 5. THE TREE CONSERVATION ORDINANCE PROHIBITS ANY CONSTRUCTION OR DEVELOPMENT ACTIVITIES 5. THE IREE CONSERVATION ORDINANCE PROVIDED SAIL CONSTRUCTION ON DEVELOPMENT ACTIVITIES WITHIN THE DRIP LINE OF AND REGULATED TREES NOT APPROVED FOR REMOVAL, INCLUDING BUT NOT LIMITED TO LAND CLEARING, GRUBBING, TRENCHING, GRADING OR FILLING, NO PERSON SHALL PLACE ANY SOLVENTS, BUILDING MATERIALS, CONSTRUCTION EQUIPMENT, SOIL DEPOSITS, OR HARMFUL MATERIALS WITHIN THE DRIP LINE LIMIT OF TREES DESIGNATED FOR PRESERVATION.
- GRADING EITHER CUT OR FILL IS PERMITTED WITHIN THE DRIP LINE OF ANY TREE DESIGNATED FOR
- 7. DURING THE CONSTRUCTION PROCESS NO PERSON SHALL ATTACH ANY DEVICE OR WIRE/CABLE/CORD/ROPE TO AN EXISTING TREE DESIGNATED TO BE PRESERVED.
- 8. ALL UTILITY SERVICE REQUEST MUST INCLUDED NOTIFICATION TO THE INSTALLER THAT PROTECTED TREES MUST BE AVOIDED. ALL TRENCHING SHALL OCCUR OUTSIDE THE TPF.
- 9. SWALES SHALL BE ROUTED TO AVOID THE AREA WITHIN THE DRIP LINE OF THE ANY TREE DESIGNATED FOR PRESERVATION. SWALES SHALL BE CONSTRUCTED SO AS NOT TO DIRECT ANY ADDITIONAL FLOW INTO THE DRIP LINE A TREE DESIGNATED FOR PRESERVATION.
- 10. IF TREE PROTECTION CANNOT BE MAINTAINED FOR A TREE THROUGHOUT ENTIRE PERIOD REQUIRED. THE REPLACEMENT OF THAT TREE WILL BE REQUIRED ON AND INCH FOR INCH BASIS PRIOR TO THE ISSUANCE OF THE CERTIFICATE OF OCCUPANCY.
- 11. REGULATED TREES LOCATED OFF-SITE ON ADJACENT PROPERTIES THAT MAY BE AFFECTED BY CONSTRUCTION OPERATIONS MUST BE PROTECTED AS DEFINED HERE IN.
- DRIP LINE OF ALL TREE DESIGNATED TO BE SAVED. THIS FENCING SHALL BE SUPPORTED BY 6 FOOT METAL T-BAR POSTS 5 FEET ON CENTER AND DRIVEN A MINIMUM OF 24" INTO GROUND. THE TPF FENCING SHALL REMAIN UPRIGHT AND SECURELY IN PLACE FOR THE REQUIRED TIME AS SPECIFIED

CITY OF ROCHESTER HILLS MAINTENANCE NOTES 138-12.109

1. LANDSCAPING SHALL BE KEPT IN A NEAT, ORDERLY AND HEALTHY GROWING CONDITION, FREE FROM

CONIG AND REPORT PRUNING SHALL BE MINIMAL AT TIME OF INSTALLATION, ONLY TO REMOVE DEAD OR DISEASED BRANCHES UBSEQUENT PRUNING SHALL ASSURE PROPER MATURATION OF PLANTS TO ACHIEVE THEIR APPROVE

PURPOSE.

3. ALL DEAD, DAMAGED, OR DISEASED PLANT MATERIAL SHALL BE REMOVED IMMEDIATELY AND REPLACED WITHIN (6) SIX MONTHS AFTER IT DIES OR IN THE NEXT PLANTING SEASON, WHICH EVER COMES FIRST. THE PLANTING SEASON FOR THE DECIDIOUS PLANTS SHALL BE BETWEEN MARCH 1 AND JUNE 1. PLANT MATERIAL INSTALLED TO REPLACE DEAD OR DISEASED MATERIAL SHALL BE AS CLOSE AS PRACTICAL TO THE SIZE OF THE MATERIAL IS IS INTENDED TO REPLACE. THE CITY MAY NOTIFY PROPERTY OWNERS OF THE NEED TO REPLACE DEAD, DAMAGED, OR DISEASED MATERIAL

THE NEED TO NETHICLE UP AND ADMINISTRATE THE MEETING.

4. THE APPROVED LANDSCAFE PLAN STALL BE CONSIDERED A PERMANENT RECORD AND INTEGRAL PART
OF THE SITE PLAN APPROVAL UNLESS OTHERWISE APPROVED, ANY REVISIONS OR REMOVAL OF PLAN
MATERIALS, OR NON-COMPLIANCE WITH THE MAINTENANCE REDUIREMENTS OF SECTION 138-12 109 WILL PLACE THE PARCEL IN NON-CONFORMITY WITH THE APPROVED LANDSCAPE PLAN AND BE A VIOLATION OF

5. IF PROTECTED TREES ARE DAMAGED, A FINE SHALL BE ISSUED ON AN INCH BY INCH BASIS AT A MONETARY RATE AS DEFINED BY THE FORESTRY DEPARTMENT

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## 7 WETLAND SEED MIX DETAIL 574.586.2412 | CARDNONATIVEPLANTNURSERY.COM

CITY OF ROCHESTER HILLS FORESTRY NOTES.

I. PRIOR APPROVAL IS REQUIRED TO PLAIT ANY TREE OR SHRUB ON THE PUBLIC RIGHT-OF-VIAY. ALL TREES AND SHRUBS MUST BE PLANTED AT LEAST TO FROM THE EDGE OF THE PUBLIC ROAD, SHADE TREES AND SHRUBS MUST BE PLANTED AT LEAST TO FROM THE EDGE OF THE PUBLIC. WALKWAY, EVERGREEN AND CRIMMENTAL TREES MUST BE PLANTED AT LEAST 10' FROM THE EDGE OF THE PUBLIC WALKWAY

2 NO TREES OR SHRUBS MAY BE PLANTED WITHIN THE TRIANGULAR AREA FORMED AT THE INTERSECTION OF ANY STREET RIGHT-OF-WAY LINES AT A DISTANCE ALONG EACH LINE OF 25' FROM THEIR POINT OF INTERSECTION, ALL TREES AND SHRUBS MUST BE AT LEAST 10 FROM ANY HYDRAN SHADE AND EVERGREEN TREES MUST BE AT LEAST 15 AWAY FROM. THE NEAREST OVERHEAD WIRE, TREES MUST BE PLANTED A MINIMUM OF 5' FROM AN LINDERGROUND LITE ITY UNLESS THE CITY'S LANDSCAPE ARCHITECT REQUIRES A GREATER DISTANCE.

3 PRIOR TO THE RELEASE OF THE PERFORMANCE BOXID, THE CITY OF ROCHESTER IPLIS FORESTRY DIMSION NEEDS TO INSPECT ALL TREES, EXISTING OR PLANTED, TO IDENTIFY MAY THAT POSE A HAZARD TO THE SAFE USE OF PUBLIC RIGHT-OF-WAY, FORESTRY MAY REQUIRE THE

#### PLANTING NOTES:

- INSTALL AND MAINTAIN ALL LANDSCAPING ACCORDING TO ROCHESTER HILLS STANDARDS. IN CASE OF DISCREPANCY BETWEEN PLAN AND PLANT LIST, THE PLAN SHALL GOVERN QUANTITIES. CONTACT LANDSCAPE ARCHITECT WITH ANY
- 2. ALL PLANT MATERIAL TO BE PREMIUM GRADE NURSERY STOCK PLANT MATERIAL SHALL CONFORM TO THE GUIDELINES ESTABLISHED IN THE MOST RECENT EDITION OF THE AMERICAN STANDARD FOR NURSERY STOCK. CONTRACTOR TO SUPPLY NURSERY SOURCES FOR ALL PURCHASED MATERIAL. NO BARE ROOT OR PARK GRADE NATERIAL MAD BE ACCEPTED. MATERIAL WILL BE ACCEPTED.
- 3, SOD: IF OWNER SELECTS THIS OPTION, CONTRACTOR WILL INSTALL SOD IN ALL AREAS INDICATED AS LAWN ON PLAN SOD TO BE WELL ESTABLISHED, MINERAL GROWTH, SOD BLEND SHALL CONSIST OF A MINIMUM OF THREE (3) IMPROVED VARIETIES OF BLUEGRASS, ACCEPTANCE AND GUARANTEE NOTES SHALL APPLY TO ALL SOD.
- 5 ALL TREE PITS MUST BE TESTED FOR PROPER DRAINAGE PRIOR TO PLANTING TREES. A DRAINAGE SYSTEM MUST BE INSTALLED IF PLANTING PIT DOES NOT DRAIN SUFFICIENTLY (REQUIRED IN HEAVY CLAY SOILS).
- 6. ALL LANDSCAPE AREAS SHALL HAVE PROPER DRAINAGE THAT PREVENTS EXCESS WATER FROM STANDING ON LAWN AREAS OR AROUND TREES AND SHRUBS.
- 7. STAKES USED FOR TREE SUPPORTS SHALL POINT AWAY FROM ANY CIRCULATION ROUTES.
- 8. MULCHING AND WATERING OF ALL PLANTS AND TREES SHALL BE IMMEDIATELY OR WITHIN 16 HOURS AFTER
- 9. THE OWNER'S REPRESENTATIVE RESERVES THE RIGHT TO REJECT ANY PLANT MATERIAL NOT MEETING WOOD STAND 272728'

- 2 PER CHARGE THAN SHRUB ROOT BALLS AND THE EVANATED PLANTING HOLE PLANT TREES AND SHRUBS AT THE ONE PART TOPSOIL AND ONE PART SOIL FROM THE EXCAVATED PLANTING HOLE. PLANT TREES AND SHRUBS AT THE SAME GRADE LEVEL AT WHICH THEY WERE PLANTED AT THE NURSERY. IF WET, CLAY SOILS ARE EVIDENT, PLANT TREES
- 13. REMOVE ALL TWINE, WIRE, AND BURLAP FROM THE TOP 1/3 OF TREE AND SHRUB EARTH BALLS AND FROM TREE (LAZO)

  EVERGREEN TREE PLANTING DETAIL TRUNKS.
- 14. LAWN TREES ARE TO BE MULCHED WITH A MINIMUM OF 4' WIDE BY 4" DEEP SHREDDED BARK FOR TRUNK PROTECTION. ONLY NATURAL-COLORED SHREDDED HARDWOOD BARK MULCH WILL BE ACCEPTED.
- NATURAL-COLORED SHREDDED HARDWOOD BARK MULCH WILL BE ACCEPTED.
- 16. BACKFILL DIRECTLY BEHIND ALL CURBS AND ALONG SIDEWALKS AND COMPACT TO THE TOP OF CURB OR WALK TO SUPPORT VEHICLE AND PEDESTRIAN WEIGHT WITHOUT SETTLING.
- 17. ALL LANDSCAPE AREAS. SPECIAL PARKING LOT ISLANDS AND LANDSCAPE BEDS NEXT TO BUILDINGS SHALL BE EXCAVATED OF ALL BUILDING MATERIALS AND POOR SOILS TO A DEPTH OF 12"-18" AND BACK-FILLED WITH GOOD MEDIUM TEXTURED PLANTING SOIL (LOAM OR LIGHT YELLOW CLAY). ADD 4"-6" OF TOPSOIL OVERFILL MATERIAL AND CROWN A MINIMUM OF 6" ABOVE TOP OF CURBS AND/OR WALKS AFTER EARTH SETTLING UNLESS OTHERWISE NOTED ON
- 18. CONVERSION OF ALL ASPHALT AND GRAVEL AREAS TO LANDSCAPE SHALL BE DONE IN THE FOLLOWING MANNER:
  A. REMOVE ALL ASPHALT, GRAVEL AND COMPACTED EARTH TO A DEPTH OF 6"-18" DEPENDING ON THE DEPTH OF THE
- 18. CONVERSION OF ALL ASPHALT, AND GRAVEL AREAS TO LANDSCAPE SHALL BE JUDIE IN THE LOCATION OF ALL ASPHALT, GRAVEL AND COMPACTED EARTH TO A DEPTH OF 6"-18" DEPENDING ON THE DEPTH OF THE SUB-BASE AND DISPOSE OF OFF SITE.

  B. REPLACE EXCAVATED MATERIAL WITH GOOD, MEDIUM TEXTURES PLANTING SOIL (LOAM OR LIGHT YELLOW CLAY)
  ADJACENT CURB AND WALK AFTER EARTH SETTLING UNLESS OTHERWISE NOTED ON THE LANDSCAPE PLAN
  IF CONVERSION TO LANDSCAPE OCCURS IN AN EXISTING (OR BETWEEN) LANDSCAPE AREAS, REPLACE EXCAVATED
  MATERIAL TO 4"-6" BELOW ADJACENT EXISTING GRADES WITH GOOD MEDIUM TEXTURED PLANTING SOIL (LOAM OR LIGHT
  VEIL OWN CLAY) AND AND ADD 4"-6" OF TOPSOIL TO MEET EXISTING GRADES AFTER EARTH SETTLING.
- 19. ALL PLANT MATERIAL TO RECEIVE TERRA-SORB SUPER ABSORBENT POLYMER OR APPROVED EQUAL BY LANDSCAPE ARCHITECT, FOLLOW MANUFACTURER'S SPECIFICATIONS.


#### MAINTENANCE NOTES

5 TREE PROTECTION FENCE DETAIL

- 1. THE CLEAR ZONE SHALL BE MAINTAINED AT ALL INTERSECTIONS THAT INGRESS AND EGRESS TO THE SITE. IT IS THE OWNERS RESPONSIBILITY TO MAINTAIN THE PLANT MATERIAL AT A HEIGHT OF NOT OVER THIRTY (30) INCHES ABOVE PAVEMENT AND PROVIDE UNOBSTRUCTED SIGHT DISTANCE FOR DRIVERS IN VEHICLES APPROACHING THE
- 2. VERTICAL CLEARANCE OF AT LEAST EIGHTY (80) INCHES MUST BE PROVIDED ABOVE WALKS AT ALL TIMES. IT IS THE OWNERS RESPONSIBILITY TO MAINTAIN TREES AND OTHER OVERHANGING OBJECTS TO PROVIDE ADEQUATE HEADROOM TO COMPLY WITH ADA GUIDELINES.

#### IMPORTANT:

ALL TREES ON ADJACENT PROPERTIES MUST BE PROTECTED. THE TREE PROTECTIVE FENCING MAY BE PLACED ALL TREES ON ADJACENT PROPERTIES MUST BE PROTECTED. THE TREE PROTECTIVE FENCING MAY BE PLACED ALONG THE ACTUAL PROPERTY LINE IF THE BRANCHES OF THE TREES ON THE ADJACENT POPERTIES DO NOT OVERHANG ONTO THE SITE BEING DEVELOPED. IF THE BRANCHES OVERHANG ONTO THE AREA OF THE SITE BEING DEVELOPED THE TREE PROTECTIVE FENCING MUST BE PLACED AT THE ACTUAL DRIP LINE OF THESE TREES. IT SHOULD ALSO BE NOTED THAT THE SILT FENCING MUST BE PLACED ON THE DEVELOPMENT SIDE OF THE TREE PROTECTIVE FENCING. IF ANY REGULATED TREES ARE DAMAGED ON THE ADJACEN PROPERTIES THE DAMAGED TREES WILL BE EITHER REPLACED ON THE OWNERS PROPERTY ON AN INCH FOR INCH BASIS OR A FINE IN THE SUM \$122.00 PER CALIPER INCH WILL BE ISSUED AGAINST THE DEVELOPMENT. THIS FINE WILL BE DUE PRIOF THE BUILDING PERMITS BEING ISSUED. IF YOU HAVE ANY QUESTIONS OR NEED ADDITI. AL INFORMATION CALL THE CITY'S PLANNING DEPARTMENT

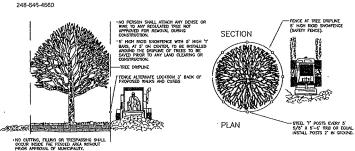

 EACH TREE TO RECEIVE TERRA—SORB SUPERABSORBATT POLYMER, MX IN BACKFILL PER MANUFACTURER'S SPECIFICATIONS. · CONTRACTOR TO VERIFY PERCOLATION OF PLANT FIT FRIOR TO INSTALLATION STAKE TREES UNDER 4" CAUPER STANCE TREES UNDER 4" CAUPER
THEE BALL SHALL BEAR SME
RELATIONSHIP TO FRISH GRADE AS IT
BORE ORIGINATE
PRUNE TO THIN AND SHAPE CANCEY
USE ONLY ONE STANCE FOR TREES UNDER
4" HT.
SET STANCES VERTICALLY AND EVENLY


SET STAKES YERITALLI AND ENDAL

STAKE TREES JUST BELOW FIRST BRANCH
WITH 2"-3" WHOE BELT LIKE WILDN OR
PLASTIC STRAPS (CONNECT FROM TREE
TO STAKE OPPOSITE FROM EACH OTHER,
THE THE BOS DIRE THE PRINCE, DO TREE WRAP FROM TOP DOWN.
REMOVE AFTER FIRST WINTER. MOUND TO FORM SAUCER


PLANTING SOL MIX SCARIFY TO A" DEPTH AND RECOMPACE
STAKES TO EXTEND 18" BELOW TREE
PIT IN UNIXSTURBED GROUND

DECIDUOUS TREE PLANTING DETAIL

 PRUNE ONLY TO REMOVE DAMAGED OR BROKEN BRANCHES ALL HON-BODEGRADABLE MATERIALS TO BE REMOVED FROM ROOT BALL BEFORE PLANTING AND BACKFILLING. STACE TREES JUST BOLOW FIRST BRANCH WITH 2"-3" WOD BOLT UNC MYLON OR PLUSTIC STRUPS (CONNECT FROM TREE I STATE OPPOSITE FROM EACH OTHER AND ALLOW FOR SOME "FLEDRICH"). DO NOT WIRE OR ROPE THROUGH A HOSE. REM AFTER FRIST WHITER. FINISH GRADE

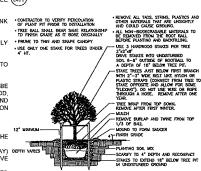

 EACH SHRUB TO RECENE TERRA-SORB
 SUPERABSORBANT POLYMER, MX IN BACKFELL
 PER MANUFACTURER'S SPECIFICATIONS. CONTRACTOR TO VERFY PERCOLATION
 OF PLANT PIT PRIOR TO INSTALLATION PLANT SHALL BEAR SAVE RELATIONSHIP TO FRASH GRADE AS IT BORE ORGANALY · ALL NON—BODEGRABLE MATERIALS TO BE REMOVED BEFORE PLANTING AND BACKFILLING - MOUND TO FORM SAUCER · REMOVE COLLAR FROM FIBER CONTAINER REMOVE BURLAP AND THINE FROM TOP 1/3 OF BALL PLANT MEXTURE.

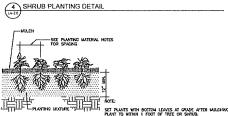

5 ANNUAL, PERENNIAL, GROUND COVER PLANTING DETAIL

RALPH L NUMEZ LANDECAPE ARCHITECT

CONDOMINIUMS

024 BRECKENRIDGE HILLS, PARCEL N-01-28


CLIENT HAMLIV, LLC JIM POLYZOIS 14955 Technology Dr., Shelby Twp., Mi 48315 Phone: 586-421-5729 FAX: 586-421-5742

Submittal: Revisions 7/20/2018 No Change Submittat: Revisions 5/23/2018
Submittat: PREUM DES/GN 4/9/2018

NÚÑEZ DESIGN 249 Park Street Michigan 48083 P: 248. 397. 8540 Designed / Drawn RN Checked / Approved RN Job # N-01-28

SCALC: 11=3010

CITY FILE # 18-008

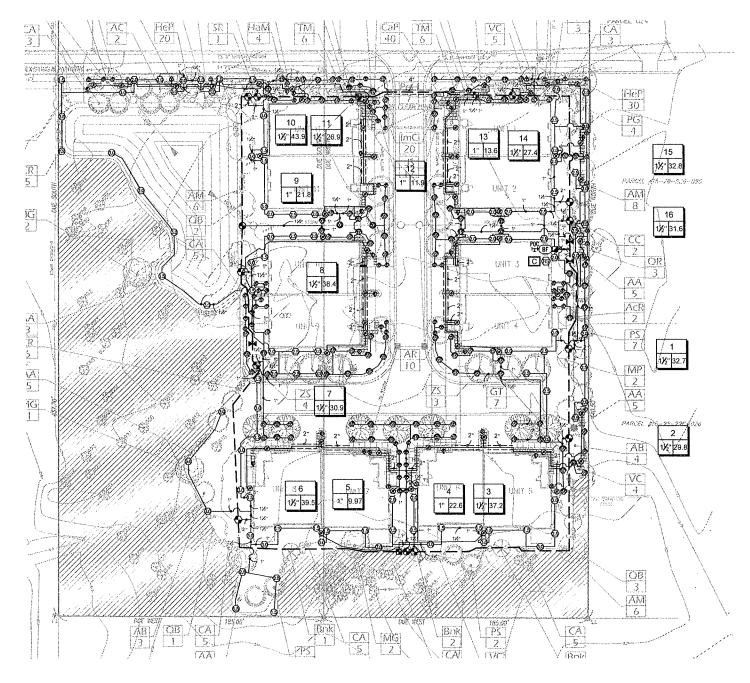

### IRRIGATION SCHEDULE

INTOATION SCHEDOLL					
SYMBOL	MANUFACTURER/MODEL	QTY			
& & & & & &	Hunter PROS-04 5' strip spray	21			
<b>8888888888888888888888888888888888888</b>	Hunter PROS-04 8' radius	65			
စွဲ စုံ စုံ စု	Hunter PROS-04 10' radius	18			
<i>စ</i> စ်စုစုစုစု	Hunter PROS-04 12' radius	21			
999999	Hunter PROS-04 15' radius	85			
SYMBOL	MANUFACTURER/MODEL	QTY			
(.5)	Hunter PGP-04	22			
99	Hunter PGP-04	25			
<b>@</b>	Hunter PGP-04-LA	35			
<b>3</b>	Hunter PGP-04-LA	20			
SYMBOL	MANUFACTURER/MODEL	QTY			
<b>::</b>	Rain Bird XCZ-100-PRF 1"	3			
◉	Pipe Transition Point	53			
Ф	Flush Valve	23			
Φ	Drip Air Relief Valve	3			
	Area to Receive Dripline Netafim TLDL-06-12	3,549 l.f.			
SYMBOL	MANUFACTURER/MODEL	QTY			
•	Hunter PGV-101G 1"	2			
◆	Hunter PGV-151 Globe 1-1/2"	11			
	Hunter HQ-5RC 1"	1			
¥	Isolation Valve Mainline Size	3			
®F)	Febco 765 1-1/2"	1			
C	Hunter IC-1800-PL	1			
€	Hunter Solar-Sync	1			
д. 600	POC 1 1/2"	1			
CASSON CONTRACTOR CONTRACTOR CONTRACTOR CONTRACTOR	Irrigation Lateral Line: Polyethylene Pipe 100 PSI 1"	3,500 l.f.			
essar smores transported askings officially shutched any provisions	Irrigation Lateral Line: Polyethylene Pipe 100 PSI 1 1/2"	725.7 l.f.			
Section is according to constitution on the state of the	Irrigation Lateral Line: Polyethylene Pipe 100 PSI 2"	60.0 I.f.			
	Irrigation Mainline: PVC Class 160 SDR 26 2*	1,179 l.f.			
COURT COURT SENS AND SENSY LOCAL SENS SELECT SOURCE AND SELECT COURT WARE SENSY LOCAL TO THE	Pipe Sleeve: PVC Class 160 SDR 26 2*	247.3 l.f.			
Security season service season service secure secur	Pipe Sleeve; PVC Class 160 SDR 26 4" Volve Collout	32.3 l.f.			
# •	Vaive Number				
#" #•	Volve Flow  Volve Size				

#### IRRIGATION SPECIFICATIONS

- 1. IRRIGATION SYSTEM DESIGN BASED ON 44 GPM AT 55 PSI.
- 2. IRRIGATION DESIGN IS FROM THE POINT OF CONNECTION(POC)ONLY. THE DESIGN IS BASED ON GALLONS PER MINUTE(GPM)AND POUNDS PER SQUARE INCH(PSI)FURNISHED BY OTHERS.
- 3. IRRIGATION CONTRACTOR IS TO VERIFY POINT OF CONNECTION IN THE FIELD. INSTALLER IS TO CONFIRM THE MINIMUM DISCHARGE REQUIREMENTS OF THE POINT OF CONNECTION AS INDICATED ON THE LEGEND PRIOR TO INSTALLATION.
- 4. THE PRESSURE REQUIREMENT AT THE POINT OF CONNECTION IS BASED ON NO MORE THAN 5 FEET OF ELEVATION CHANGE IN THE AREAS OF
- 5. ALL PRODUCTS SHALL BE INSTALLED IN ACCORDANCE WITH THE MANUFACTURER'S RECOMMENDATIONS AND ACCORDING TO LOCAL BUILDING, ELECTRICAL, AND PLUMBING CODES.
- 6. IRRIGATION CONTRACTOR WILL ARRANGE INSPECTIONS REQUIRED BY LOCAL AGENCIES AND ORDINANCES DURING THE COURSE OF CONSTRUCTION
  AS REQUIRED. ALL WIRING TO BE PER LOCAL CODE. BACKFLOW PREVENTION TO BE PER LOCAL CODE.
- 7. LOCATION OF IRRIGATION COMPONENTS SHOWN ON DRAWING IS APPROXIMATE. ACTUAL PLACEMEN \* MAY VARY SLIGHTLY AS REQUIRED TO ACHIEVE FULL, EVEN COVERAGE.
- 8. ALL SPRINKLER HEADS SHALL BE INSTALLED PERPENDICULAR TO FINISH GRADES. EXCEPT AS OTHERWISE INDICATED.
- 9. INSTALL IRRIGATION MAINS WITH A MINIMUM 18" OF COVER BASED ON FINISH GRADES. INSTALL IRRIGATION LATERALS WITH MINIMUM 12" OF COVER BASED ON FINISH GRADES.
- 10. PIPE LOCATIONS ARE DIAGRAMMATIC. VALVES AND MAINLINE SHOWN IN PAVED AREAS ARE FOR GRAPHIC CLARITY ONLY.
- 11. THE IRRIGATION CONTRACTOR SHALL COMPLY WITH PIPE SIZES AS INDICATED.
- 12. ALL WIRE SPLICES OR CONNECTIONS SHALL BE MADE WITH APPROVED WATERPROOF WIRE CONNECTIONS AND BE IN A VALVE OR SPLICE BOX.
- 13. ALL CONTROL WIRING DOWNSTREAM OF THE CONTROLLER IS TO BE 14 AWG, UL APPROVED DIRECT BURY,
- 14. THE DESIGN IS BASED ON THE SITE INFORMATION AND/OR DRAWING SUPPLIED WITH THE DESIGN CRITERIA BEING SET(AREA TO BE IRRIGATED,
  EQUIPMENT MANUFACTURER AND MODEL TO BE USED, WATER SOURCE INFORMATION, ELECTRICAL POWER AVAILABILITY. ETC...). SITEONE
  LANDSCAPE SUPPLY BEARS NO RESPONSIBILITY OR LIABILITY FOR ANY ERRORS IN DESIGN OR INSTALLATION THAT ARISE DUE TO INACCURACIES IN
  THE ABOVE REFERENCED INFORMATION SUPPLIED TO SITEONE LANDSCAPE SUPPLY LANDSCAPES IN RELATION TO THIS PROJECT, UNLESS
  OTHERWISE NOTED.





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Project Name:

BRECKENRIDGE CONDOMINIUMS

ROCHESTER HILLS, MI, 48309

Customer Nan

Design Date

Checker

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REVISIONS					
Description	Date				
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05/14/18

DK C.GRAHAM

Drawing Title:
IRRIGATION DESIGN

CITY FILE# 18-008


1" = 30"

Drawing Scale:

Project Services Number: 157830

Sheet Number:

IR-1

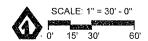

# Breckenridge: Aspen Unit Duplex

Plan 'B'





ELEVATION CONCEPT SCALE: 1/4"= 1'-0"

HAMLIV, LLC


City File #

Aspen Unit Elevation A-1.0





Plan 'B'

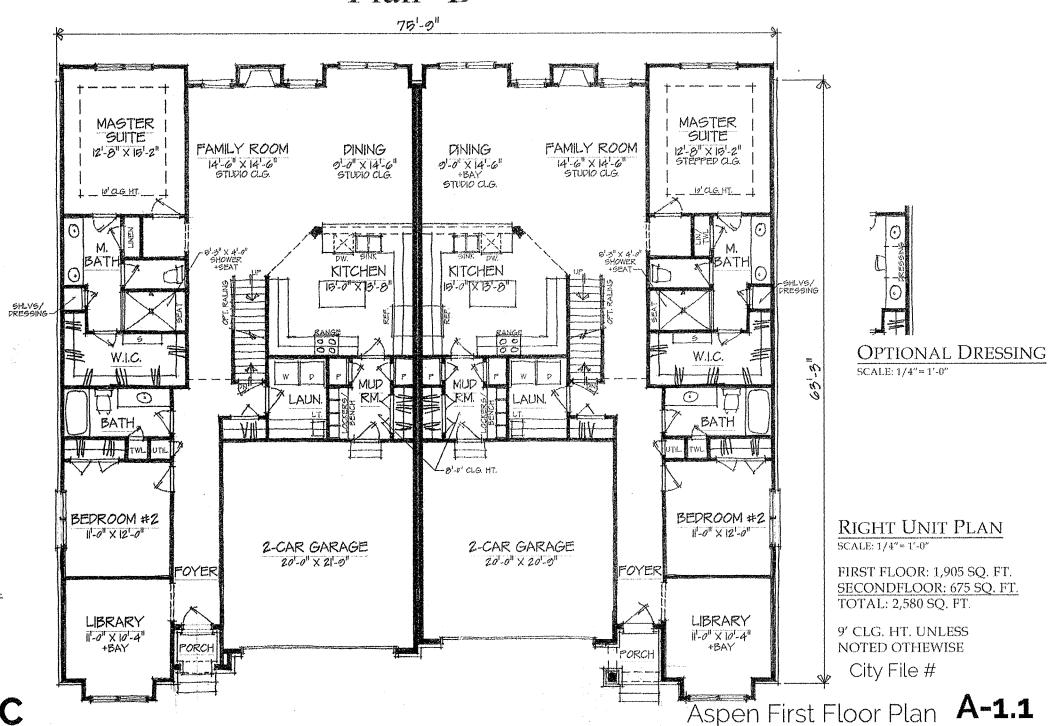

LEFT UNIT PLAN SCALE: 1/4" = 1'-0"

FIRST FLOOR: 1,905 SQ. FT. SECONDFLOOR: 675 SQ. FT. TOTAL: 2,580 SQ. FT.

9' CLG. HT. UNLESS **NOTED OTHERWISE** 


HAMLIV, LLC

Hamlin/Livernois Duplex

## Breckenridge: Aspen Unit Duplex

Plan 'B'



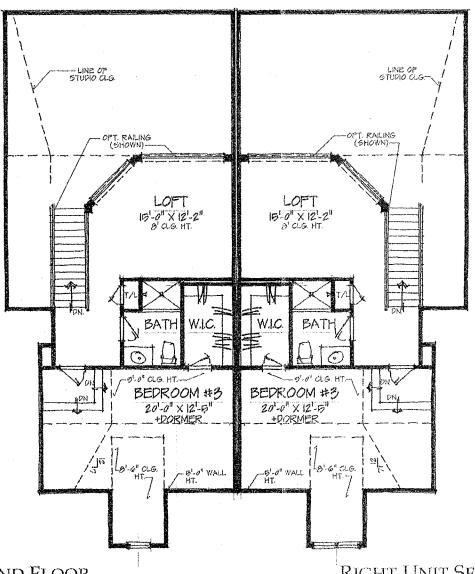

LEFT UNIT SECOND FLOOR SCALE: 1/4"= 1'-0"

RIGHT UNIT SECOND FLOOR SCALE: 1/4"= 1'-0"


City File #

HAMLIV, LLC

Aspen Second Floor Plan A-1.2

# Breckenridge: Spruce Duplex Unit



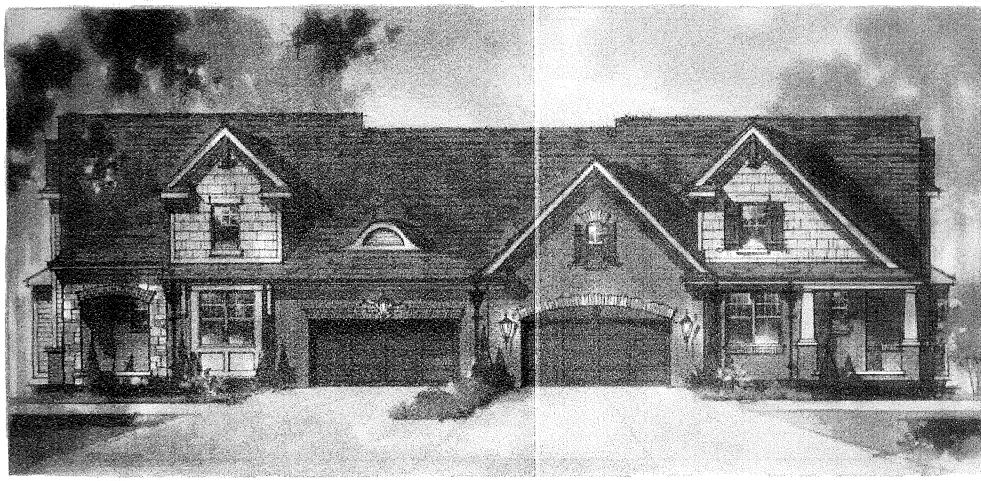

UNIT A

ELEVATION CONCEPT
SCALE: 1/4"= 1'-0"


UNIT B

Hamlin, LLC

City File #
Spruce Elevation **A-2.0** 

## **Breckenridge: Spruce Duplex Unit**



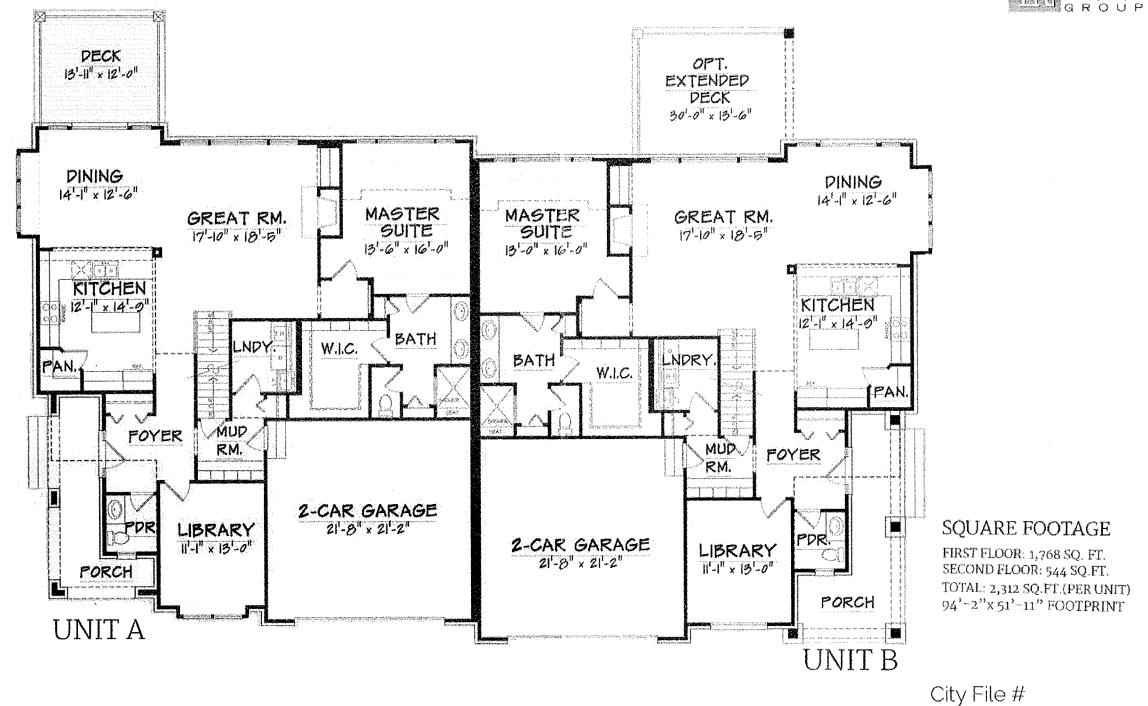


Hamlin, LLC


Spruce First Floor Plan **A-2.1** 

## **Breckenridge: Spruce Duplex Unit**



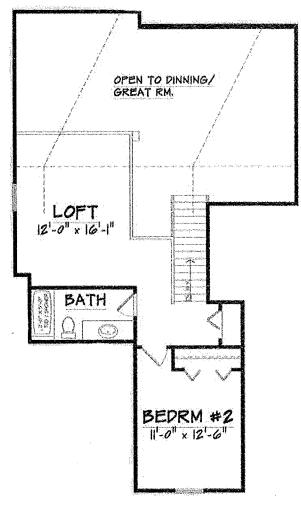

UNIT A & B

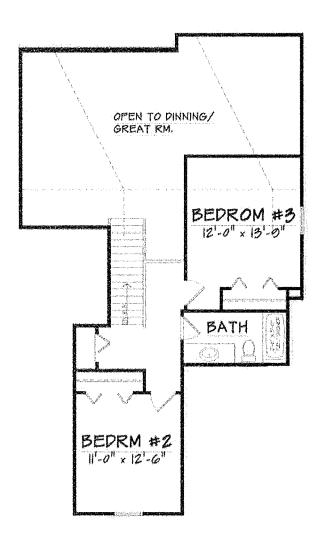

UNITA&B w/ Opt. 3BEDRM.

City File # Spruce Second Floor Plan A-2.2

Hamlin, LLC

or Plan