

FRONT ELEVATION - AREA OF RENOVATION



SIDE ELEVATION - AREA OF MODIFICATIONS




REAR ELEVATION - AREA OF ADDITION



SIDE ELEVATION - AREA OF ADDITION

LIST OF DRAWINGS:

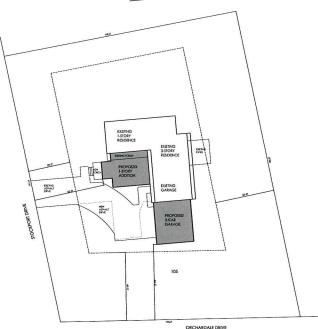

Google

Google Maps 281 Orchardale Dr

SITE PLAN (AS PROVIDED BY OWNER)

LOCATION MAP (from www.google.com)

## EGRESS WINDOW REQUIREMENTS: MINIMUM NET CLEAR OPENING 5.7 SQUARE FEET MINIMUM NET CLEAR HEIGHT 24 MINIMUM NET CLEAR WIDTH 20' MAXIMUM SILL HEIGHT 44'

## TEMPERED GLASS AREAS: - FIXED AND SUDING DOOR PANELS

- SHOWER AND BATHTUB DOOR ENCLOSURES
- PANELS OF GLAZING IN EXCESS OF 9 SQUARE FEET WITH LOWEST EDGE LESS THAN 18' ABOVE FINISHED FLOOR LEVEL
- ANY OTHER AREA PER CODE NOT LISTED

#### DO NOT SCALE DRAWINGS USE FIGURED DIMENSIONS ONLY

#### MECHANICAL NOTES:

- I. ALL WORK TO CONFORM TO A.S.H.R.A.E. REQUIREMENTS.
- 2. DUCT WORK TO BE BLOWN OUT OR VACUUMED AFTER FABRICATION AND INSTALLATION AND PRIOR TO OWNER

#### ELECTRICAL NOTES:

- I. ALL WORK TO BE IN ACCORDANCE WITH THE LATEST EDITION OF THE N.E.C.
- 2. CONTRACTOR TO LOCATE TRANSFORMER OR COORDINATE SERVICE WITH DETROIT EDISON.
- 3. ELECTRICAL PANEL, CIRCUIT BREAKER TYPE, PAINTED STEEL CABINET AND DOOR WITH EACH CIRCUIT LABELED

#### WOOD SPECIFICATIONS:

- I. WOOD CONSTRUCTION TO BE GOVERNED BY THE LATEST EDITION OF THE ATC MANUAL AND NDS (NATIONAL DESIGN STANDARDS) AS PUBLISHED BY THE AMERICAN FOREST AND PAPER ASSOCIATION)
- 2. LAMINATED VENEER LUMBER SHALL HAVE THE FOLLOWING PROPERTIES: Fb=2,600 psi, Fv=285 psi, E=1,900,000 psi, Fc=750 psi, UNO.
- 3. LAMINATED WOOD BEAMS (Glulams) SHALL BE VISUALLY GRADED WESTERN SPECIES 24F-V8 AITC DESIGNATION WITH THE FOLLOWING STRUCTURAL PROPERTIES:  $F_b = 2,400 \text{ ps}$ ,  $F_{Y} = 165 \text{ ps}$ , E = 1,800,000 ps.
- 4. STUDS SHALL BE SPF/STUD (WWPA) OR BETTER GRADE (UNO) AT MOISTURE CONTENT (MC) 19% MAXIMUM.
- 5. STRUCTURAL DIMENSIONED LUMBER SUCH AS HEADERS AND JOISTS SHALL BE A MINIMUM OF #2 Hem Fir AT MC 19%
- 6. AT EACH WALL OFENING ADD ONE HALF OF THE TOTAL NUMBER OF STUDS DISPLACED TO EACH SIDE OF THE OPENING (FULL HEIGHT AND USE ONE TRIMMER STUD BELOW THE HEADER AT EACH END (INFO).
- 7. COLUMNS AND CONCENTRATED LOADS SHALL EXTEND TO SOUD BEARING. REPEAT COLUMNS ON LOWER FLOORS BELOW UPPER COLUM (UNO). BLOCK SOUD BELOW ALL COLUMNS TO
- 8. NOTCHING OR DRILLING STRUCTURAL MEMBERS IS PROHIBITED WITHOUT PRIOR WRITTEN CONSENT OF THE ENGINEER.
- 9. CONNECTION NOT NOTED ON THE DRAWINGS SHALL BE MADE WITH PREFABRICATED STEEL HANGERS SIZED FOR THE CARRED LOAD AND THE MEMBER SIZE AND INSTALLED IN ACCORDANCE WITH THE MANUFACTURERS SPECIFICATIONS (e. A DOUBLE 24 TO MUST HAVE A SIMPSON U-21 O-2 HANGER (OR EQUAL), ITEL).
- IO. ALL EXTERIOR WALL AND ROOF SHEATHING SHALL BE APA RATED SHEATHING, DYDOSURE 1, WITH FROPER SFAN INDEX AND INSTALLED PER APA INSTALLATION GUIDE REQUIREMENTS (NATING, SPACING, BLOCKING, STORAGE, HANDING AND FROTECTION, ETC.) (UND).
- 11. FRESSURE PRESERVATION TREATMENT:
  A ALL STRUCTURAL LUMBER BIL CONTACT WITH
  CONCARTE OR MASONINY, OR LESS THAN 8' ABOVE GRADE,
  OR DYFOSED TO WEATHER, SHALL BE PRESSURE TREATED
  TO A MINEMAN OF AND FOLIAGO FER CUSE FOR TREATED
  RETENTION WITH ANOINGNAT COPPER ASSISTANT (ACA).
  TOLAIL STREATMENT. RASIDIATE (COA), OR AFROYDE
  TOLAIL STEATMENT.
- B. ALL LUMBER AT OR BELOW GRADE SHALL BE PRESSURE TATED TO A MINIMUM OF 0.60 FOUNDS PER CUBIC FOOT RETEITION WITH AMMONIACAL COPPER ARSENATE (ACA), OR CHROMATE COPPER ARSENATE (CCA), OR APPROVED EQUAL TREATMENT.
- C. ALL TREATED LUMBER WHICH IS CUT, DRILLED OR NOTCHED SHALL BE TREATED (BRUSHED ON EXPOSED SURFACES) BY ONE OF THE FRESERVATIVES LISTED ABOVE.
- 12. THIS PLAN DOES NOT RELIEVE THE CONTRACTOR FROM RESPONSIBILITY FOR FOLLOWING MINIMUM GUIDELINES SET FORTH IN TEH CURRENT MICHIGAN BUILDING CODE.

#### GENERAL NOTES:

- I. ALL WORK TO COMPLY WITH ALL APPLICABLE NATIONAL. STATE AND LOCAL CODES, ORDINANCES AND REGULATIONS, WHERE INCONSISTENT, MOST STRINGENT CODE APPLIES.
- 2. CONTRACTOR SHALL BE RESPONSIBLE FOR OBTAINING ALL
- 3. CONTRACTOR SHALL BE RESPONSIBLE FOR FIELD VERIFINIS ALL ENSTRING CONDITIONS, INCLUDING SIZE, LOCATION, LEVATION, AND DEFIALS THAT AFFECT THE WORK, AND SHALL INFORM THE OWNER, ARCHITECT AND/OR ENGINEER OF ANY CONDITIONS THAT DIFFER FROM TO PROCEEDING WITH THE WORK.
- 4. CONTRACTOR WILL FAMILIARIZE HIMSELF WITH THE CONSTRUCTION DOCUMENTS AND SHALL INFORM THE OWNER, ARCHITECT AND/OR ENGINEER OF ANY DISCREPANCIES IN DIMENSIONS, LOCATIONS AND/OR SIZES FRIOR TO THE START OF WORK.
- 5. CONTRACTOR WILL FAMILIARIZE HIMSELF WITH ALL EXISTING CONDITIONS OF THE CONSTRUCTION, INCLUDING BUT NOT LIMITED TO UTILITIES AND SERVICES, AND SHALL BE FULLY RESPONSIBLE FOR ANY UNMAINTHORIZED DISSUFFION. TO THE OWNERS NORMAL USE OF UTILITIES AND SERVICES.
- 6. CONTRACTOR SHALL PROVIDE ALL SHORING, BRACING AND UNDERPINNING AND ANY OTHER MEANS REQUIRED TO PROTECT AND MAINTAIN THE SAFETY, STABILITY AND INTEGRITY OF ALL NEW CONSTRUCTION.
- 7. CONTRACTOR SHALL INDEMNIFY THE ARCHITECT AND ENGINEER FROM ERRORS AND OMISSIONS WHICH CAN OR MAY OCCUR DURING THE PREPARATION OF THESE CONTRACTOR.
- 8. THE PURPOSE OF THESE DOCUMENTS IS TO OBTAIN FRIMARY BUILDING FERMITS. ALL OTHER CONSTRUCTION TRADES SHALL OBTAIN THEIR OWN PERMIT FOR ANY OTHER AFFLICABLE TRADES, SUCH AS ELECTRICAL, MECHANICAL, PLUMBING, ETC.

#### FOUNDATION NOTES:

- I. SOIL BEARING FRESSURE IS ASSUMED AT 1,500 P.S.F. IF ADVERSE CONDITIONS ARE FOUND, NOTIFY OWNER, ARCHITECT AND/OR ENGINEER IMMEDIATELY.
- 2. CONCRETE TO BE 3.000 P.S.I AT 28 DAYS.
- 3. ALL BUILDING FOUNDATIONS TO BE 42' MINIMUM DEPTH AND DOWN TO UNDISTURBED SOIL.
- 4. ALL FABRICATIONS AND PLACING OF REINFORCING BARS SHALL FOLLOW THE A.C.I. MANUAL STANDARD PRACTICE FOR DETAUNG REINFORCED CONCRETE STRUCTURES (ACI 315 LATEST A319 REINFORCING BARS ARE TO BE DEFORMED, NEW BILLET STELL MEETING ASTM AG15 GRGO.

#### STRUCTURAL NOTES:

- 1. ALL FRAMING LUMBER TO BE 'CONSTRUCTION GRADE' 1,200 P.S.I. OR BETTER.
- 2. ALL PRE-ENGINEERED WOOD TO BE 2,800 P.S.I. OR
- 3. ROOF TRUSS DIAGRAMS/SHOPS TO BE SUBMITTED TO CONTRACTOR AND ARCHITECT OR ENGINEER FOR REVIEW PRIOR TO FABRICATION. 4. ALL WALLS TALLER THAN 10' SHALL BE FRAMED IN 2x6 STUDS.

#### PLUMBING NOTES:

- I. PLUMBING SUBCONTRACTOR RESPONSIBLE FOR LOCATING PIPING RUND. FIXTURES ARE SHOWN FOR LOCATION ONLY, AND SHOULD BE COORDINATED IN THE FIELD DURING CONSTRUCTION.
- 2. PITCH ALL DRAIN LINES & PER FOOT UNLESS NOTED
- 3. ALL PIPING SHALL RUN CONCEALED UNLESS NOTED OTHERWISE
- 4. ALL PVC PIPING TO BE SCHEDULE 40.

#### COVER DEMOLITION PLAN D-1 FOUNDATION A-1 FIRST FLOOR PLAN A-2 ROOF AND SECOND FLOOR PLAN A-3 **ELEVATIONS A-4 ELEVATIONS A-5** SECTION A-6 SECTION AND DETAILS A-7

ELECTRICAL AND POWER PLAN E-1

# SOUARE FOOTAGE: DISTING FIRST FLOOR AND GARAGE: 1,583 gef FIRST FLOOR ADDITION: 510gef NEW GARAGE ADDITION: 545 gef


2,6384sf = GROSS SQUARE FOOTAGE ESTIMATED LOT: 23,942sf

## GENERAL NOTES AND SPECIFICATIONS

## APPLICABLE CODE: 2009 MICHIGAN RESIDENTIAL CODE

# SITE NOTES: 1. CONTRACTOR TO CONTACT MISS DIG 1-800-482-7171, 72 HRS PRIOR TO EXCAVATION

- 2. CONTRACTOR MUST INSTALL SOIL EROSION PROTECTION PRIOR TO ISSUANCE OF PERMIT. MAINTAIN DURING CONSTRUCTION. PROTECT EXISTING TREES TO REMAIN.
- 3. GENERAL CONTRACTOR IS RESPONSIBLE FOR LOCATING 3. GERCAL CONTRACTION IS REPORTABLE FOR LIDATING ALL OFF-SITE UTILITY CONNECTIONS AND THEIR LEADS, AND INSTALLING THEM INTO NEW BUILDING. CONTRACTOR TO ATTAIN ALL REQD FERMITS TAP FEES. COORDINATE ALL REQD SERVES AT FOOTINGS OR FOUNDATION WALLS.
- 4. GENERAL CONTRACTOR MUST REVIEW SITE PRIOR TO SUBMITTING STIMATE TO REVIEW DISTRING STIE CONDITIONS. GENERAL CONTRACTOR MUST PROVIDE STAKE OUT OF FOOTPRINT BY REG. LIMD SURVEYOR, GENERAL CONTRACTOR IN SEPTONSIELE FOR REMOVAL OR PROTECTION OF ALL TIZES AND VESCITATION AT HOUSE AS DIRECTED BY COMER.
- 5. EXACT HOUSE PLACEMENT (STAKE-OUT) TO BE APPROVED BY OWNER PRIOR TO EXCAVATION.
- 6. GENERAL CONTRACTOR MUST 'GRUB' SITE AS REQUIRED AND SAVE ALL TOP SOIL. REMOVE EXCESS DIRT AND SPOILS.
- 7. ANY HIDDEN CONDITIONS DISCOVERED DURING CONSTRUCTION INCLUDING BUT NOT LIMITED TO INADEQUATE SOLIS IS TO BE REPORTED INVAEDIATELY AND CONSTRUCTION IN THE AFFECTED AREA HALTED.
- 8. DEWATERING: PREVENT SURFACE WATER AND SUBSURFACE OR GROUND WATER FROM FLOWING INTO EXCAVATIONS AND FROM FLOODING PROJECT SITE.
  REMOVE WATER TO PREVENT SOIL CHANGES DETRIMENTAL TO STABILITY OF SUBGRADES AND FOUNDATIONS. FROVIDE AND MAINTAIN FUNDES AND OTHER DEWATERING SYSTEM COMPONENTS NECESSARY TO CONNEY WATER AWAY FROM ECCAYATIONS. DO NOT USE TRENCH EXCAYATIONS AS TEMPORARY DRAINAGE DITCHES.
- 9. CONTRACTOR SHALL PROVIDE SOIL BORINGS TO VERIFY THE EXACT MAXE-UP AND COMPRESSIVE STRENGTH OF SOILS PRIOR TO ANY FIELD WORK OR EXCAVATIONS

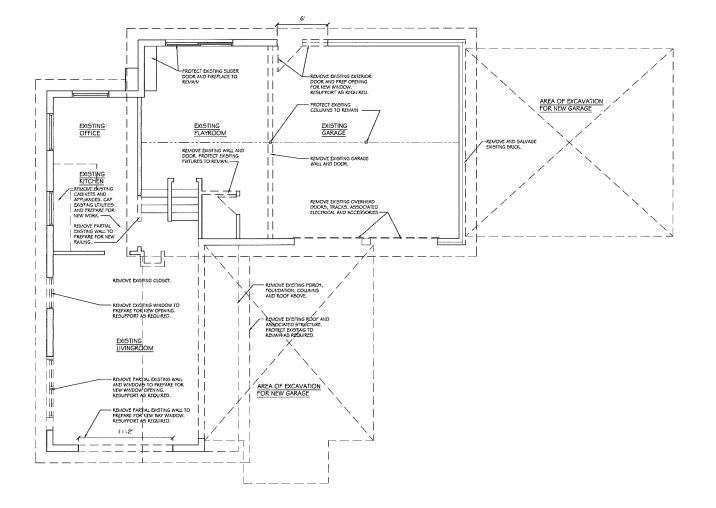

#### SCOPE OF DEMOLITION:

REMOVE SECTIONS OF WALL AS INDICATED TO FREFARE FOR ADDITIONAL CONSTRUCTION TO SESTION PROJECT DESTINA GRANGE WILL SECONE PLATE OF THE CONSTRUCTION TO SESTION PROJECT PLATE OF THE TOORFRANT ON DOLUME EBBASED PRANT SERON, BURN SECON, REDUCTED SECONE PLATE SECONE PLA

PREPARE SITE FOR NEW CONSTRUCTION, PROTECT ALL EXISTING TO REMAIN, ENSURE SAFETY OF EXISTING STRUCTURE AND UTILITIES, COORDINATE WITH CITY AND OTHER LOCAL AUTHORITIES AS REQUIRED.

II. PROVIDE BRACING AND SHORING AS REDUIRED TO MAINTAIN SIDES AND TO PROTECT ADJACENT STRUCTURES. PROVIDE BARRICADESY WARNING LIGHTS AS REQUIRED BY LOCAL AUTHORITIES.

12. THE BUILDING DESIGN ENGINEER/ DESIGNER ASSUMES NO RESPONSIBILITY FOR THE DESIGN OR PROPER INSTALLATION OF TEMPORARY BUILDING BRACING OR SHORING

REQUIRED TO REMOVE THE DESIGNATED PORTION OF THE PROJECT. THE CONTRACTOR AND HIS ENGINEER ARE RESPONSIBLE FOR THE

FRE-ENSPICERED TRUSSESY STE BAX JOISTS IS STRICTLY FROMIBITED WITHOUT EXPRESSED PRIOR WRITTEN CONSENT AND DETAILS FROM A LICENSED FROFESSIONAL STRUCTURAL ENGRIER ENTERENCED IN TRUSSY BAR JOIST DETAILS AND ADDRESS OF THE

14. DISPOSE OF EXCESS MATERIALS AND DEBRIS IN A LEGAL MANNER. PROVIDE TEMPORARY SUFFORT/ BRACING AND ENCLOSURE AS REQUIRED.

15. IN-ORGANIC MATERIAL SHALL NOT BE LEFT TO BE COVERED WITH NEW BACKFILL. 16. BACKFILL EXCAVATIONS AS PROMPTLY AS WORK PERMITS, USE GRANULAR SOIL MATERIAL, DO NOT BACKFILL AGAINST

INSTITUTE TO DECEMBER SEASONS
OPERATIONS ARE TO OCCUR PRIOR TO NEW
WALL CONSTRUCTION, CONTRACTOR MUST
TEMPORABILY SHORE AND BRACE
ACCORDINGLY.

17. GRADANG: UNIFORMLY GRADE AREAS AS INDICATED. GRADE AREAS ADJACENT TO BUILDING UNEST OD DRAIN AWAY FROM STRUCTURE AND TO PREVENT PONDING (5% SLOPE MANAGUA - VERIFY IN FIELD) ALLOW FOR AT PLACEMENT OF TOPSOL. PROVIDE NEW

SUB-GRADE DRAINAGE AND CATCH BASINS AS REOD TO PROVIDE ADEQUATE ON-SITE

18. CONTRACTOR TO PATCH, REPAIR AND/OR REPLACE ANY EXISTING CONSTRUCTION DAMAGED DURING OR DUE TO REMOVATION WITH MATERIALS AND PINISHES TO MATCH EXISTING ADJACENT MATERIALY PINISH

DESIGN AND MODIFICATIONS.

### **DEMOLITION NOTES:**

I. GENERAL CONTRACTOR MUST VERIFY ALL EXISTING UTILITY LOCATIONS PRIOR

- 2. GENERAL CONTRACTOR MUST VISIT SITE TO BECOME FAMILIAR WITH EXISTING CONDITIONS PRIOR TO SUBMITTING ESTIMATE.
- 3. GENERAL CONTRACTOR MUST OSTAIN ALL REQUIRED PERMITS, TAP FEES, BOXDING, AND INSURANCES (WORKERS, VEHICLES, GENERAL PROPERTY), FROVIDE VERHELATION TO OWNER.
- AND HIS DISCRETE ARE RESPONSIBLE FOR THE DESIGN AND FROPER INSTITUTION OF ALL TEXT OWNERS HE SHOULD REAL TO SHO A. GENERAL COMPRACTOR MUST
  MARKAIN A SAFE, CLEAN WORKSTIL.
  MARKAIN A SAFE, CLEAN WORKSTIL.
  MARKAIN A SAFE, CLEAN WORKSTIL.
  MIST REFE STREET FREE OF DEEPS AND
  DISPOSE OF ALL DEERS IN A TIVELY.
  MUST KEEP STREET FREE OF DEEPS AND
  DISPOSE OF ALL DEERS IN A TIVELY.
  MUST KEEP STREET FREE OF DEEPS AND
  OWNERANCE AS TAKING DO'N STILL.
  MUST KE CONTRACTOR IS PROOP OF ACCEPTANCE OF
  THE ASON EMPORED THE STREET
  MUST KEEP STREET AND THE SAFE OF THE ASON EMPORTATION OF
  THE ASON EMPORTED THE SAFE OF THE ASON EMPORTED THE SAFE OF THE THE SURROUNDING NEIGHBORS.
- 5. GENERAL CONTRACTOR INUST OBTAIN AUTHORIZATION BY DOMER FOR MY EXTERIOR METER LOCATIONS AND COOKDINATE WITH UTILITY COMPANIES, FROVIDE SCREENING AS READ BY LOCAL ORDINANCE.
- G. ALL WORK MUST CONFORM TO ALL STATUTES OF THE INTERNATIONAL BUILDING CODE (EDITION IN EFFECT AT THE TIME OF FERMIN, ALL STATE, COUNTY AND LOCAL DORDINANCES AND CURRENT BARRER FREE REGULATIONS. IF DISCREPANCES IN DRAWNSOS AFFERR, WORK MUST BE FERFORMED FOR CODE.
- 7. GENERAL CONTRACTOR IS RESPONSIBLE TO PROVIDE AND MARITAN ALL TEMPORARY PACULITYS, ELECTRICAL SERVICE, HEATING LINITS, WEATHER PROTECTION, TOILET UNIT, FIRE EXTINGUISHERS, CRUSHED CONCRETE STAGING DRIVE, SAFETY BARRICADES AND

8. ALL UTILITIES TO BE CUT, CAPPED, LABELED AND RELOCATED AS REQUIRED.

- 9. VERLEY ALL POINTS OF DIGT. BRG
  AND FROVADE TELEPORARY SUPPORT,
  SHORING AS REOD UNITL ALL EXISTING
  BEARING CONDITIONS ARE INSTALLED AND
  TRANSFERRED TO PERMANENT SUPPORT.
  VERHEY CAPACITY OF EXIST. LOAD
  CARRYING MEMBERS.
- 10. PROTECT EXISTING FACILITIES ON OWNERS PROPERTY IN A MAINER AS TO NOT ADVERSELY AFFECT THE FACILITIES OPERATIONS AND ADJOINING PROPERTY.

PROJECT

## Bunch Residence

Renovation/ Addition

281 Orchordale Road Rochester Hills, MI

SHEET TITLE

DEMOLITION PLANS

02-05-17 75% OWNER REVIEW 02-19-17 90% OWNER REVIEW 04-06-17 BIDS AND PERMITS


> DO NOT SCALE DRAWINGS USE FIGURED **DIMENSIONS** ONLY


1612

SHEET NO.

D-1

DEMOLITION BASEMENT PLAN

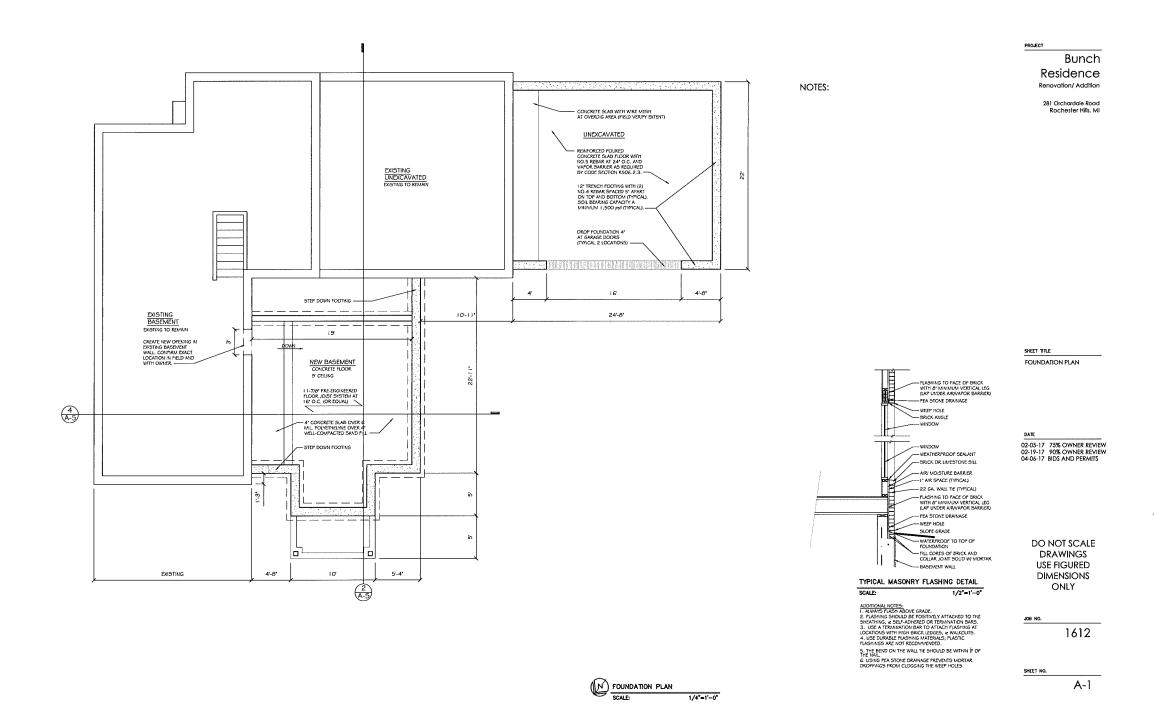

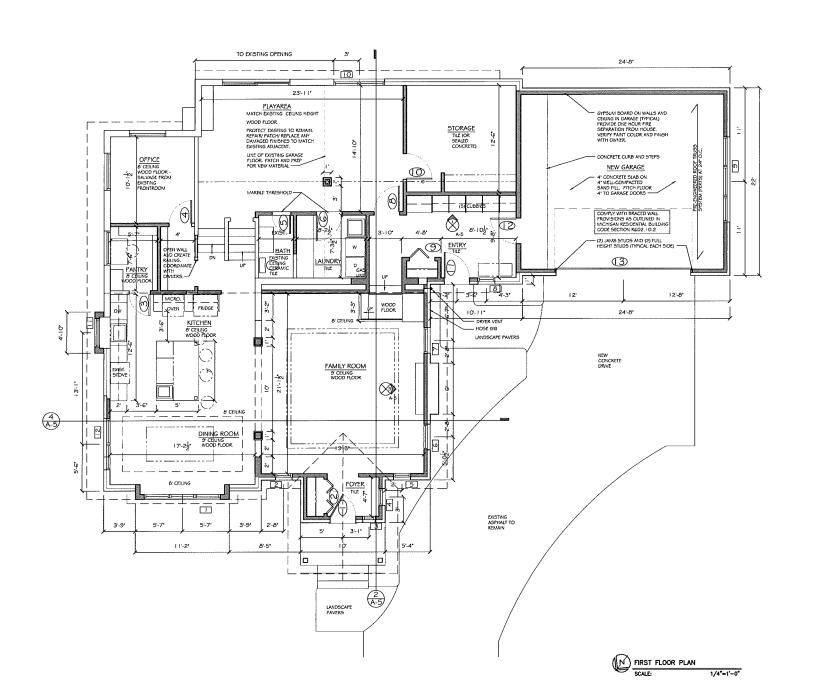

DABrazen Designs Deborah Brazen 586-322-4785

DOOR SCHEDULE 3-0 X G-8" EXTERIOR DOOR 4-0 X G-8" WOOD BI-FOLD DOOR 

PROJECT

## Bunch Residence

Renovation/ Addition

281 Orchardale Road Rochester Hills, MI

WALL LEGEND

3/4" GYPSUM BOARD BOTH SIDES OF 2x4 AT 16' O.C. USE & WATER RESISTENT GYPSUM BOARD IN RESISTENT GYPSUM BOARD IN BATHROOMS.

NOTE: FROVIDE WOOD BLOCKING IN WALLS TO RECEIVE APPLIED FATURED, RAUNGS, CADNETS, ETC. NOTE ON PLAYS WHERE 216 STUDS ARE USED.

4' NOM. BRICK, I' AIR SPACE, 2/6
WOOD STUDS AT 16' O.C. WITH CELLILOSE INSULATION AND 2 GYPSUM BOARD ONE SIDE

\$ GYFSUM BOARD BOTH SIDES OF 246 AT 16' O.C. WITH CELLULOSE INSULATION FOR A 1-HOUR FIRE-RATED WALL

APPROVED SMOKE DETECTOR REQUIRED IN ALL SLEEPING AREAS, ADJACENT TO ALL SLEEPING AREAS AND ON ALL LEVELS, INTERCONNECTED WITH BATTERY BACK-UP, PER SECTION 314.3.

PROVIDE CARBON MONOXIDE DETECTORS PER SECTION R315.1.

FROVIDE ATTIC ACCESS IN LOCATION PER OWNERS DIRECTION

ROOF - SHINGLES TO MATCH EXISTING

SHAKE -

BRICK - MATCH EXISTING

STONE - CONFIRM FINAL SELECTION WITH OWNER

WINDOW TRIM AT SHAKES TO BE SAME COLOR AS THE SHAKES; PROVIDE STONE SURROUND AT WINDOWS IN STONE

SHEET TITLE FIRST FLOOR PLAN

02-05-17 75% OWNER REVIEW 02-19-17 90% OWNER REVIEW 04-06-17 BIDS AND PERMITS


DO NOT SCALE DRAWINGS **USE FIGURED DIMENSIONS** ONLY

JOB NO.

1612

SHEET NO.

A-2

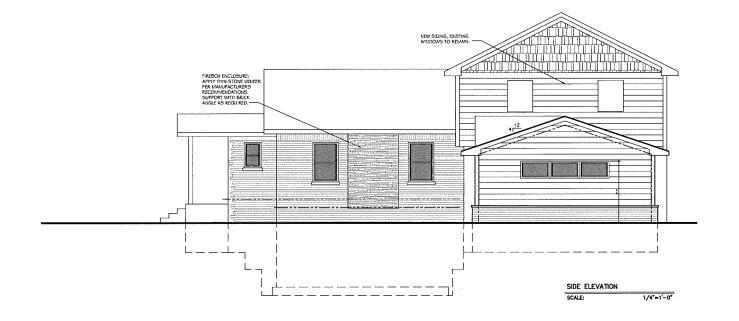


Bunch Residence

PROJECT

Renovation/ Addition

281 Orchardale Road Rochester Hills, MI

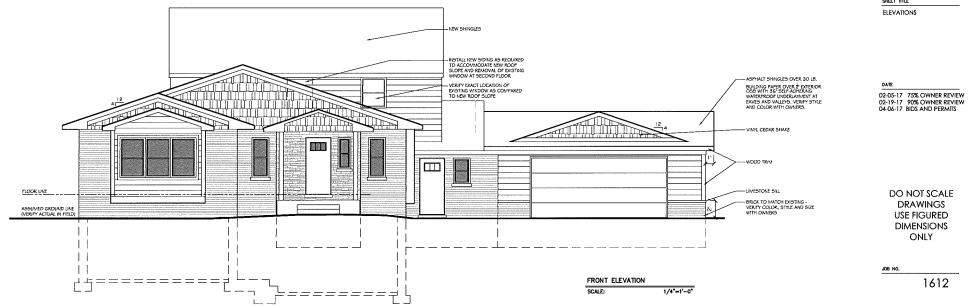

SHEET TITLE

DO NOT SCALE DRAWINGS **USE FIGURED** DIMENSIONS

1612

SHEET NO.


A-3

Bunch

Residence
Renovation/ Addition

281 Orchardale Road
Rochester Hills, MI

PROJECT

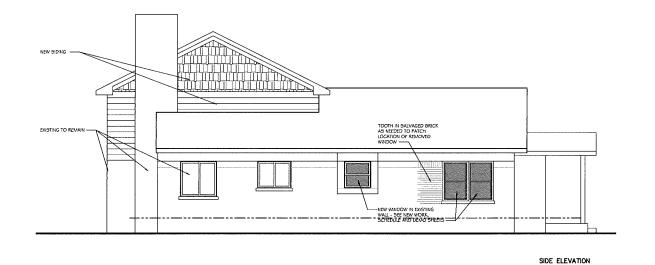

NEW SIDING AND TRIM

ASPHALT SHINGLES OVER 30 LB.

ASTRACT SHIPS OVER \$\frac{1}{2} EXTERIOR OSS WITH 3G\* SELF-ADHERING WATERFROOT UNDERLAYMENT AT EAVES AND VALLEYS, VERIFY STILE AND COLOR WITH OWNERS.

BRICK TO MATCH EXISTING -VERIFY COLOR, STYLE AND SIZE WITH OWNERS EXISTING TO REMAIN

1/4"=1'-0"

DO NOT SCALE DRAWINGS USE FIGURED DIMENSIONS ONLY

02-05-17 75% OWNER REVIEW 02-19-17 90% OWNER REVIEW 04-06-17 BIDS AND PERMITS


SHEET TITLE ELEVATIONS


1612

SHEET NO. A-4

FRONT ELEVATION
SCALE: 1/4\*=1\*-0\*

SCALE:

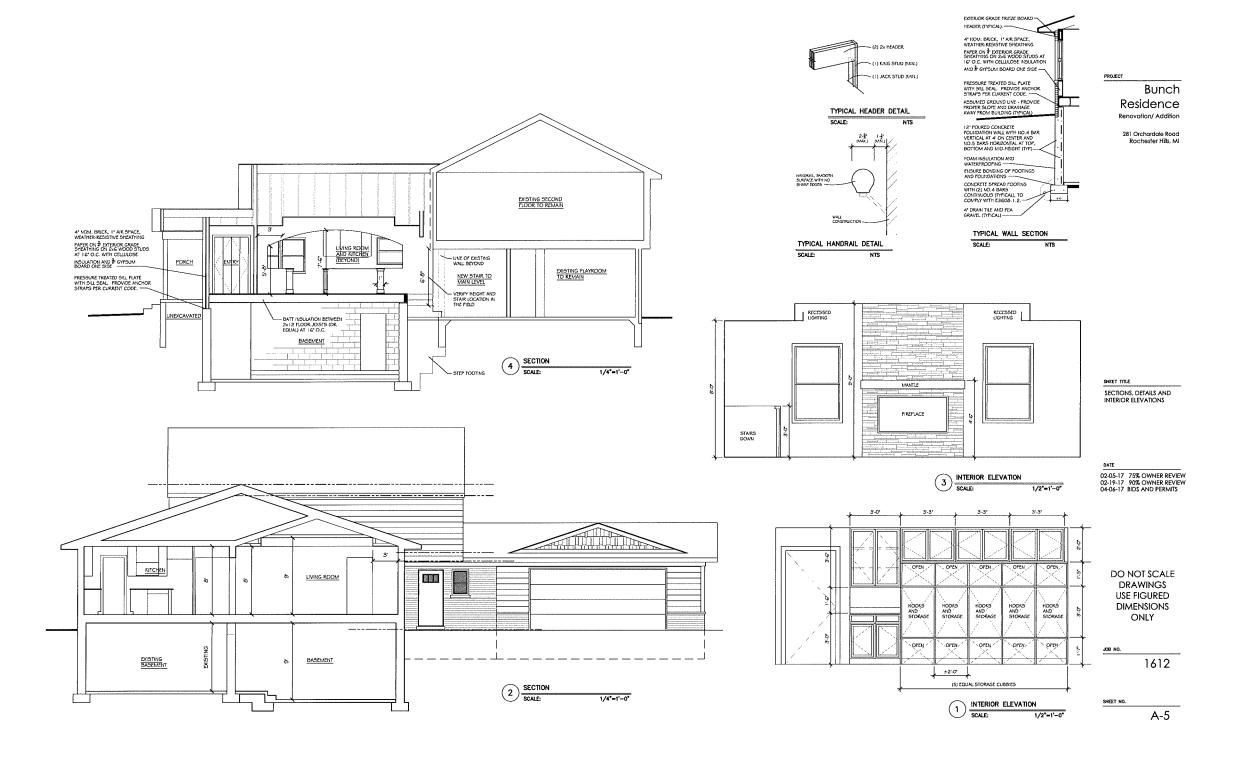

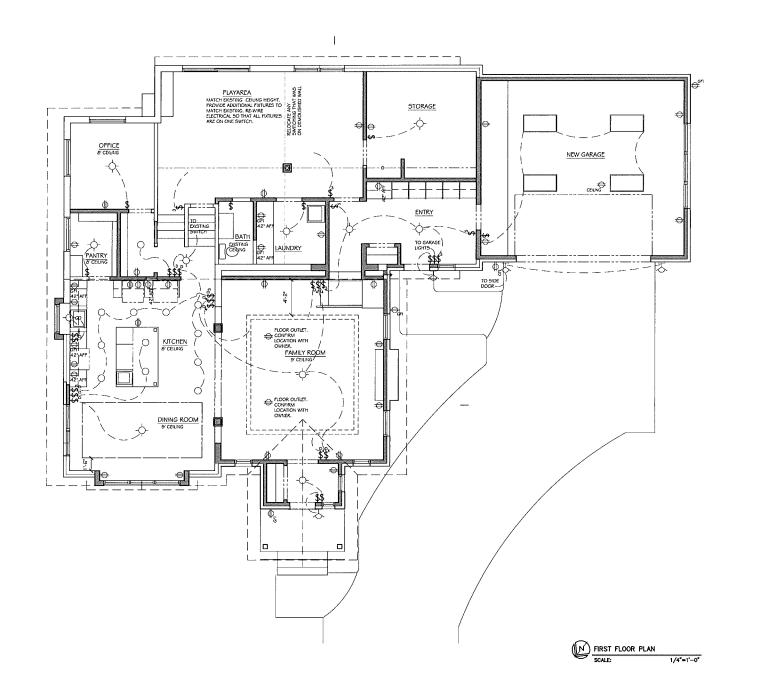

DABrazen Designs Deborah Brazen 586-322-4785

POWER/LIGHTING LEGEND NOTE: VERIFY ALL FIXTURES WITH OWNER PRIOR TO INSTALLATION

∰ WALL-MOUNTED FIXTURE CEILING FAN WITH INTEGRAL LIGHTING FIXTURE; SWITCH FAN AND LIGHT SEPARATELY

- CEIUNG-MOUNTED FIXTURE
- O RECESSED LIGHTING
- O FIXTURE AFFROVED FOR INSTALLATION IN SHOWER/CLOSET COUNG

FIXTURE APPROVED FOR INSTALLATION IN GARAGE - VERIFY WITH OWNER

- O EXHAUST FAN
- ◆ DUPLEX OUTLET OUAD OUTLET
- GFI OUTLET: MOUNT AT 42' A.F.F.
  \$ SWITCH

APPROVED SMOKE DETECTOR REQUIRED IN ALL BEDROOMS, INTERCONNECTED WITH BATTERY BACKUP

PROJECT

## Bunch Residence

Renovation/ Addition

281 Orchordale Road Rochester Hills, MI

SHEET TITLE

FIRST FLOOR POWER AND ELECTRICAL PLAN

02-05-17 75% OWNER REVIEW 02-19-17 90% OWNER REVIEW 04-06-17 BIDS AND PERMITS

DO NOT SCALE DRAWINGS **USE FIGURED** DIMENSIONS ONLY

JOB NO.

1612

SHEET NO.

E-1