Statistics							
Description	Symbol	Avg	Max	Min	Max/Min	Avg/Min	Avg/Max
PARKING AND DRIVES	Ж	1.2 fc	5.0 fc	0.3 fc	16.7:1	4.0:1	0.2:1
PL		0.1 fc	0.3 fc	0.0 fc	N/A	N/A	0.3:1
SITE	+	0.7 fc	5.6 fc	0.0 fc	N/A	N/A	0.1:1

chedule		•	_			-			•
Symbol	Label	QTY	Manufacturer	Catalog Number	Description	Lamp	Lumens per Lamp	LLF	Wattage
	A1	3	Lithonia Lighting	DSX1 LED P4 40K T5W MVOLT	DSX1 LED P4 40K T5W MVOLT	LED	14943	0.9	125
	A2	2	Lithonia Lighting	DSX1 LED P4 40K T5W MVOLT	DSX1 LED P4 40K T5W MVOLT	LED	14943	0.9	250
	В	7	Lithonia Lighting	DSX1 LED P2 40K BLC MVOLT	DSX1 LED P2 40K BLC MVOLT	LED	7293	0.9	70
	DW	13	Lithonia Lighting	WDGE1 LED P1 40K 90CRI VF	WDGE1 LED WITH P1 - PERFORMANCE PACKAGE, 4000K, 90CRI, VISUAL COMFORT FORWARD OPTIC	LED	1086	0.9	10.0002
	WP	21	Lithonia Lighting	DSXW1 LED 10C 700 40K TFTM MVOLT	DSXW1 LED WITH (1) 10 LED LIGHT ENGINES, TYPE TFTM OPTIC, 4000K, @ 700mA.	LED	2808	0.9	26.2

Power Statistics				
Description	# Luminaires	Total Watts	Area	Density
Power Density Zone # 2	46	2045.203 W	221371.500 ft ²	0.009 W/ft ²

General Note

- 1. SEE SCHEDULE FOR LUMINAIRE MOUNTING HEIGHT
- 2. CALCULATIONS ARE SHOWN IN FOOTCANDLES AT: 0' 0"
- 3. LIGHTING ALTERNATES REQUIRE NEW PHOTOMETRIC CALCULATION AND RESUBMISSION TO CITY FOR APPROVAL.
- 4. PROVIDE GLARE SHIELDS ON ALL EXTERIOR LIGHTING

THE ENGINEER AND/OR ARCHITECT MUST DETERMINE APPLICABILITY OF THE LAYOUT TO EXISTING / FUTURE FIELD CONDITIONS. THIS LIGHTING LAYOUT REPRESENTS ILLUMINATION LEVELS CALCULATED FROM LABORATORY DATA TAKEN UNDER CONTROLLED CONDITIONS IN ACCORDANCE WITH ILLUMINATING ENGINEERING SOCIETY APPROVED METHODS. ACTUAL PERFORMANCE OF ANY MANUFACTURER'S LUMINAIRE MAY VARY DUE TO VARIATION IN ELECTRICAL VOLTAGE, TOLERANCE IN LAMPS, AND OTHER VARIABLE FIELD CONDITIONS. MOUNTING HEIGHTS INDICATED ARE FROM GRADE AND/OR FLOOR UP.


THESE LIGHTING CALCULATIONS ARE NOT A SUBSTITUTE FOR INDEPENDENT ENGINEERING ANALYSIS OF LIGHTING SYSTEM SUITABILITY AND SAFETY. THE ENGINEER AND/OR ARCHITECT IS RESPONSIBLE TO REVIEW FOR MICHIGAN ENERGY CODE AND LIGHTING QUALITY COMPLIANCE.


UNLESS EXEMPT, PROJECT MUST COMPLY WITH LIGHTING CONTROLS REQUIRMENTS DEFINED IN ASHRAE 90.1 2013. FOR SPECIFIC INFORMATION CONTACT GBA CONTROLS GROUP AT ASG@GASSERBUSH.COM OR 734-266-6705.


FOR ORDERING INQUIRIES CONTACT GASSER BUSH AT QUOTES@GASSERBUSH.COM OR 734-266-6705.

THIS DRAWING WAS GENERATED FROM AN ELECTRONIC IMAGE FOR ESTIMATION PURPOSE ONLY LAYOUT TO BE VERIFIED IN FIELD BY OTHERS.

MOUNTING HEIGHT IS MEASURED FROM GRADE TO FACE OF FIXTURE. POLE HEIGHT SHOULD BE CALCULATED AS THE MOUNTING HEIGHT LESS BASE HEIGHT.

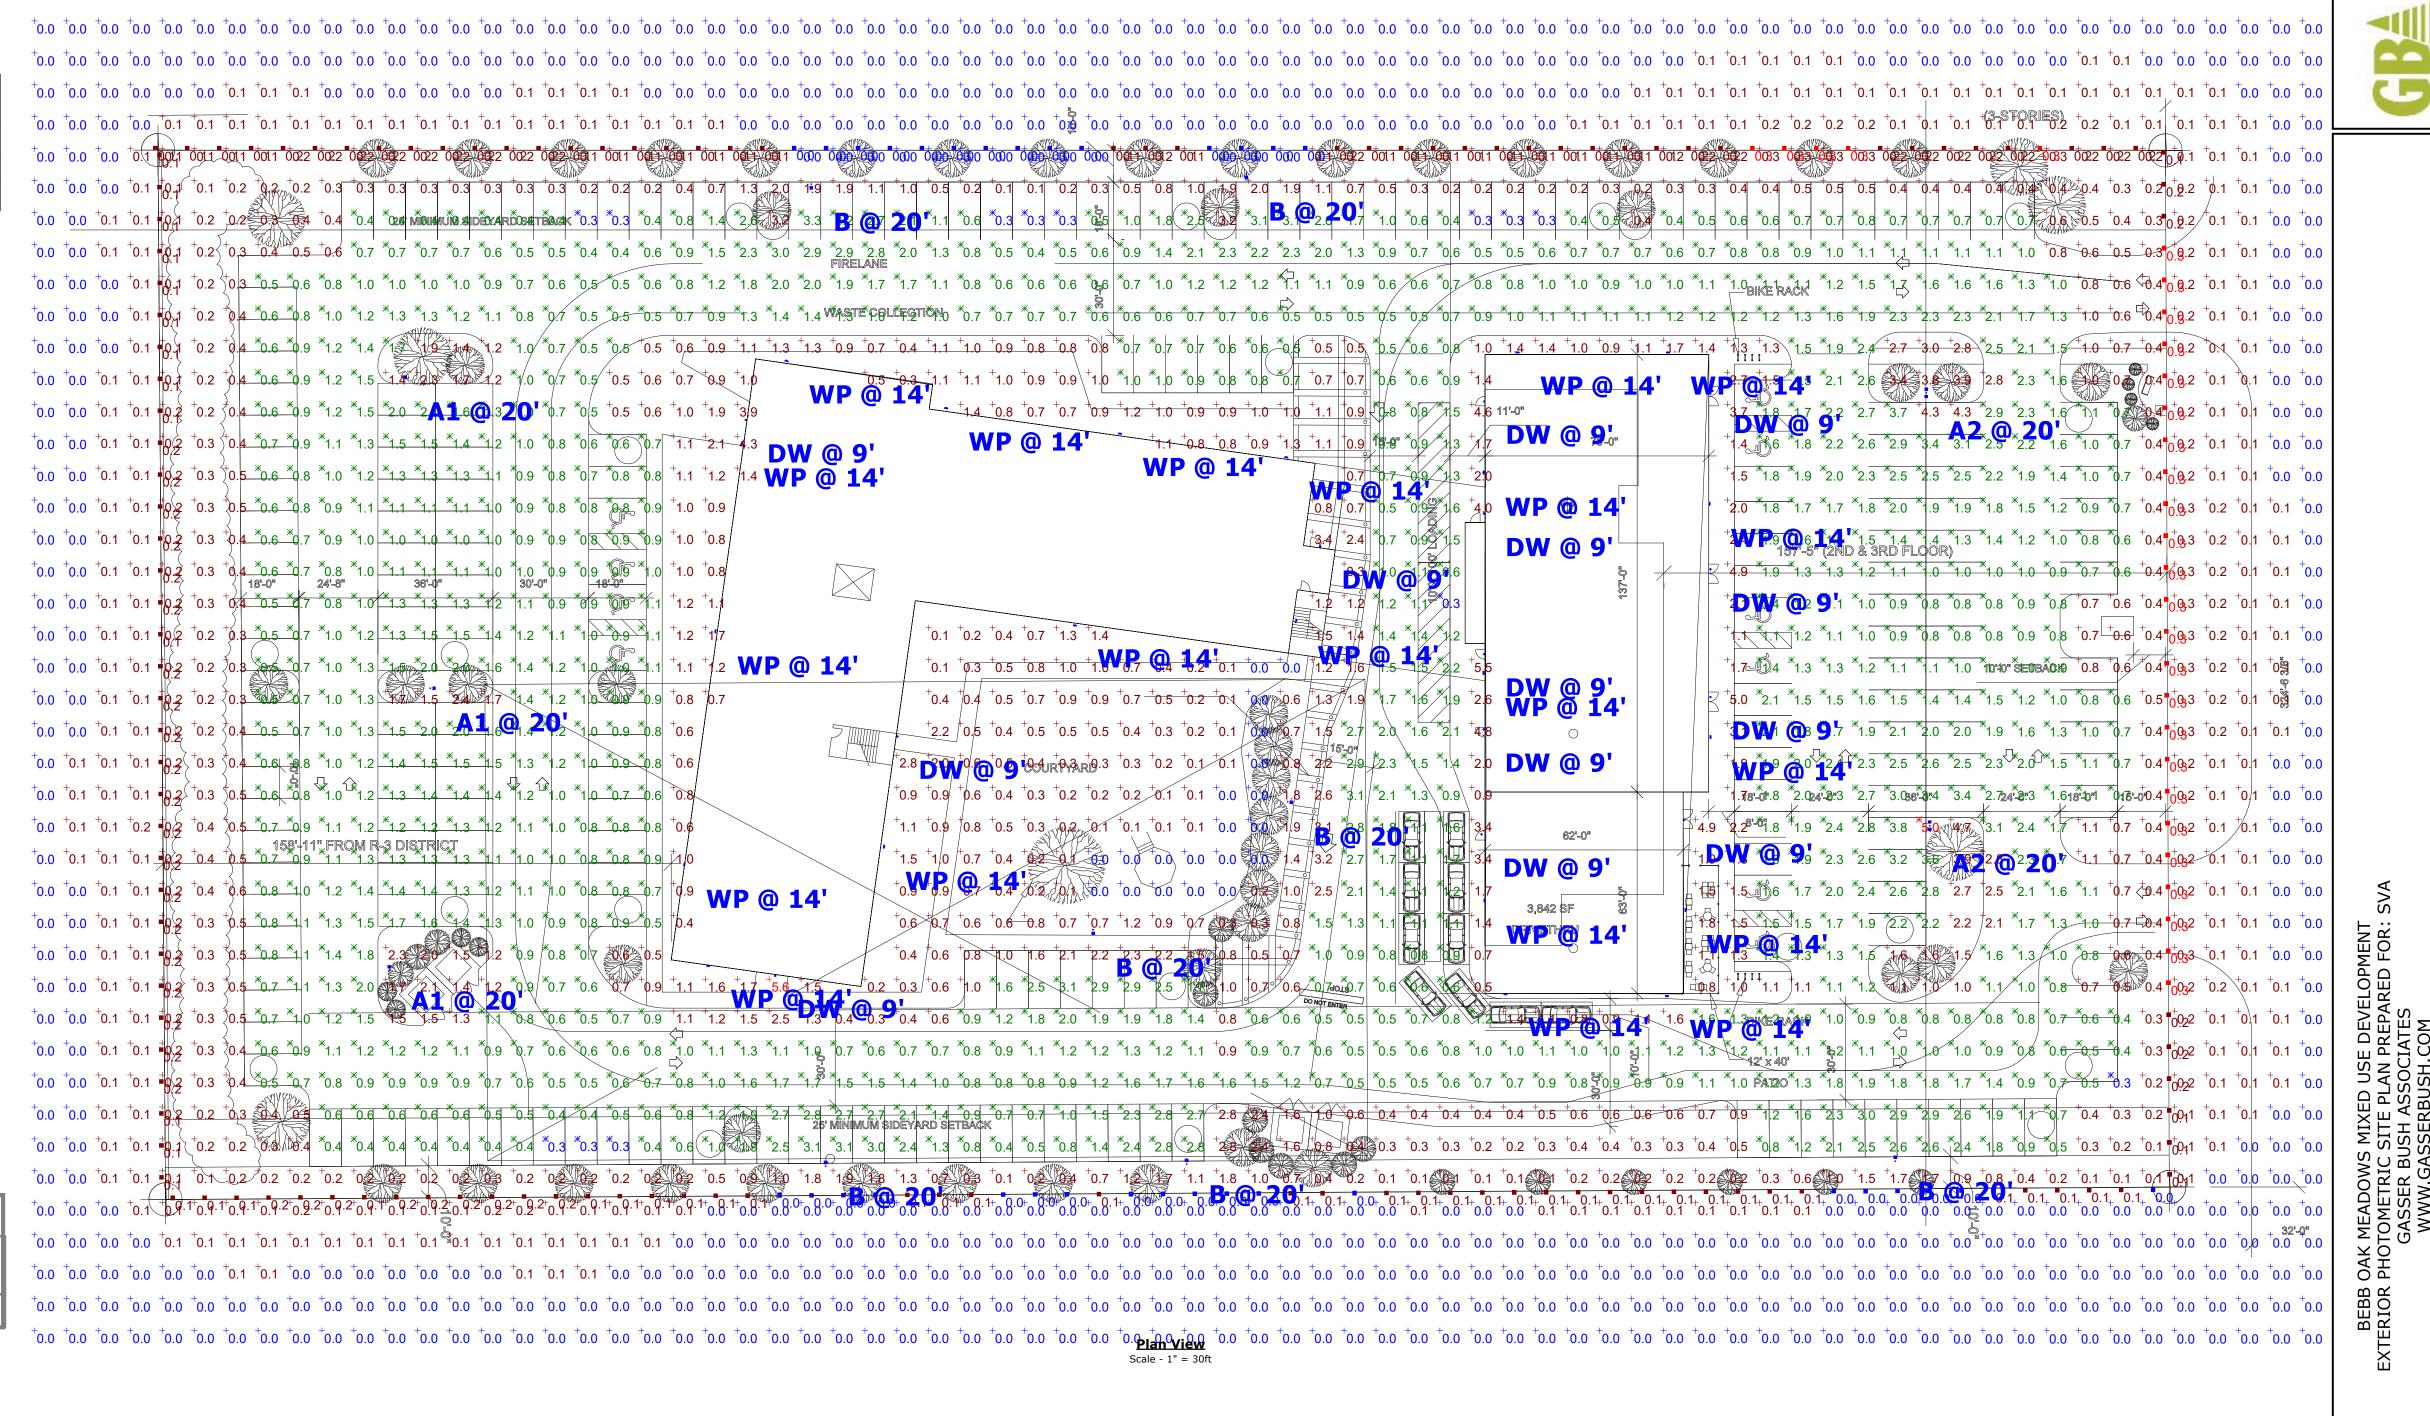


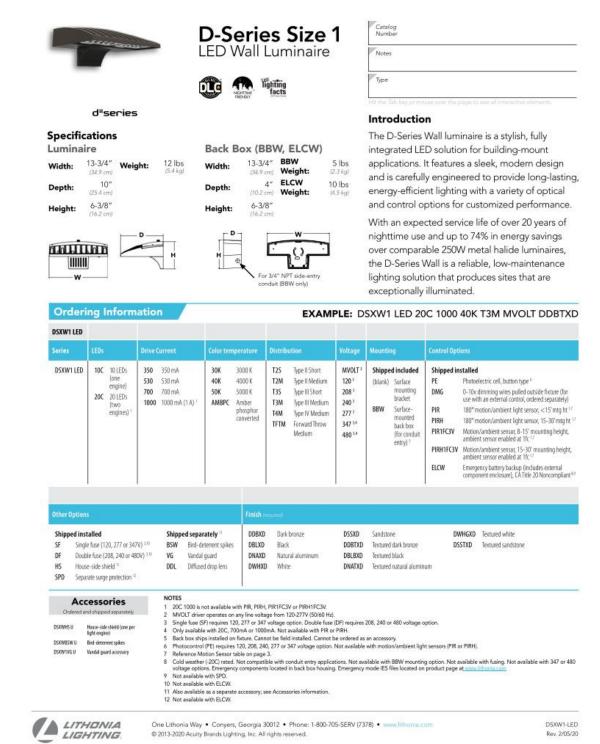

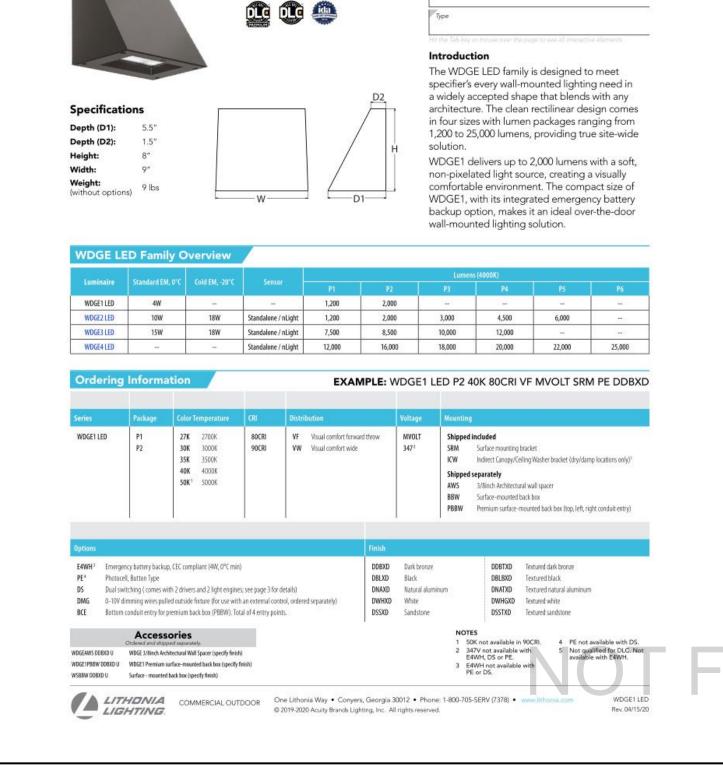

WDGE1 LED

Architectural Wall Sconce

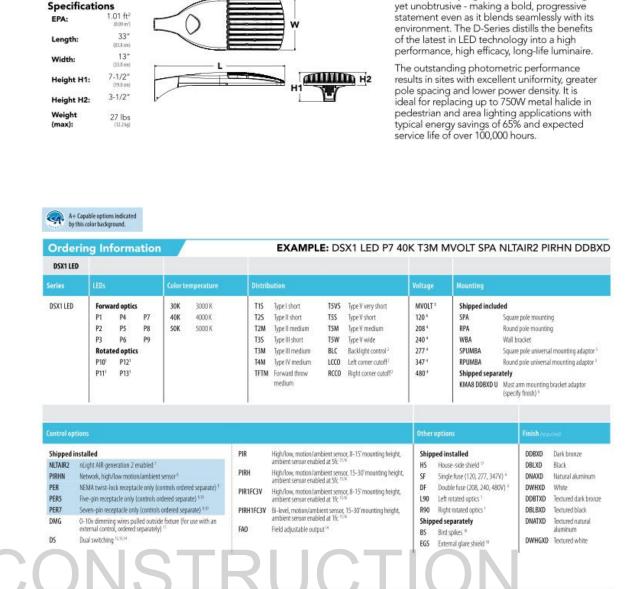

D-Series Size 1

LED Area Luminaire

Introduction

The modern styling of the D-Series is striking



NO
REVISIONS
09.14.21

Designer nae
Date
REV.6/1/2021
Scale
Not to Scale
Drawing No.
#21-50170 V1

SL.1

Rev. 09/17/19

Page 1 of 8

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LANDSCAPE ARCHITECTURE

& ASSOCIATES, INC

212 DAINES STREET

BIRMINGHAM

MICHIGAN 48009

P 248 644 3410

F 248 644 0819

www.mjdul.com

EXISTING TREE CALCULATIONS	OVERALL SITE	INSIDE BUILDING ENVELOPE	
EXISTING TREES:			
TOTAL EXISTING TREES 6" CALIPER OR GREATER:	18	5/18	13/18
TOTAL EXISTING TREES LESS THAN 6" CALIPER:	6	5/6	1/6
TOTAL EXISTING TE	REES: 24		
REGULATED TREE PRESERVATION:			
TOTAL EXISTING REGULATED TREES, 6-8" CALIPER:	12	5/12	7/12
TOTAL EXISTING REGULATED TREES, 9"+ CALIPER:	6	1/6	5/6
EXISTING REGULATED TREES TO BE REMOVED, 6-8" CALIPER:	12	5/12	7/12
EXISTING REGULATED TREES TO BE REMOVED, 9"+ CALIPER:	1	Ø/I	1/1
EXISTING REGULATED TREES TO REMAIN, 6-8" CALIPER:	Ø/12	0/5	<i>ø</i> л
EXISTING REGULATED TREES TO REMAIN, 9"+ CALIPER:	5/6	Ø	5/6
TREE PRESERVATION, 6-8" CALIPER:	Ø%	0%	<i>0</i> %
TREE PRESERVATION, 9"+ CALIPER:	83%		83%
TREE PRESERVATION, OVERALL:	28%	0%	38%
REPLACEMENT TREES:			
TOTAL TREES REQUIRED TO BE			
REPLACED WITH 2" CALIPER REPLACEMENT TREES:			8.

*SEE PROPOSED PARKING LOT TREE SCHEDULE FOR BREAKDOWN

REQUIRED PARKING LOT TREES:	1011000
TOTAL PROPOSED VEHICULAR USE AREA:	104 <i>60</i> 9 SF
TOTAL INTERIOR LANDSCAPE REQUIRED (5% OF PROP. VEHICULAR AREA):	523Ø SF
TOTAL TREES REQUIRED, I TREE PER 150	-,
S.F. OF REQUIRED INTERIOR LANDSCAPE:	35 REQ. TREES
I TREE FOR EACH PARKING LOT ISLAND:	14 REQ. TREES
PERIMETER LANDSCAPING, FIRST 100' FROM	
ROCHESTER ROAD, TREES 25' O.C.	8 REQ. TREES
PERIMETER LANDSCAPING, NORTH AND SOUTH	
ADJACENT LOTS ARE ZONED B-3	Ø REQ. TREES
51 T	OTAL REQUIRED TREES
PROPOSED PARKING LOT TREES:	
TOTAL INTERIOR LANDSCAPE PROVIDED	
TOTAL INTERIOR LANDSCAPE PROVIDED AROUND PROPOSED 4 STORY BUILDING:	16,144 SF
TOTAL INTERIOR LANDSCAPE PROVIDED AROUND PROPOSED 4 STORY BUILDING: TOTAL TREES PROVIDED AROUND	
TOTAL INTERIOR LANDSCAPE PROVIDED AROUND PROPOSED 4 STORY BUILDING: TOTAL TREES PROVIDED AROUND PROPOSED 4 STORY BUILDING:	21 TREES
TOTAL INTERIOR LANDSCAPE PROVIDED AROUND PROPOSED 4 STORY BUILDING: TOTAL TREES PROVIDED AROUND	21 TREES
TOTAL INTERIOR LANDSCAPE PROVIDED AROUND PROPOSED 4 STORY BUILDING: TOTAL TREES PROVIDED AROUND PROPOSED 4 STORY BUILDING: TOTAL TREES PROVIDED IN PARKING LOT ISLANDS: TOTAL TREES PROVIDED IN PERIMETER	21 TREES 16 TREES
TOTAL INTERIOR LANDSCAPE PROVIDED AROUND PROPOSED 4 STORY BUILDING: TOTAL TREES PROVIDED AROUND PROPOSED 4 STORY BUILDING: TOTAL TREES PROVIDED IN PARKING LOT ISLANDS: TOTAL TREES PROVIDED IN PERIMETER LANDSCAPING FIRST 100' FROM ROCHESTER:	21 TREES 16 TREES
TOTAL INTERIOR LANDSCAPE PROVIDED AROUND PROPOSED 4 STORY BUILDING: TOTAL TREES PROVIDED AROUND PROPOSED 4 STORY BUILDING: TOTAL TREES PROVIDED IN PARKING LOT ISLANDS: TOTAL TREES PROVIDED IN PERIMETER LANDSCAPING FIRST 100' FROM ROCHESTER: TOTAL TREES PROVIDED IN PERIMETER	18 TREES
TOTAL INTERIOR LANDSCAPE PROVIDED AROUND PROPOSED 4 STORY BUILDING: TOTAL TREES PROVIDED AROUND PROPOSED 4 STORY BUILDING: TOTAL TREES PROVIDED IN PARKING LOT ISLANDS: TOTAL TREES PROVIDED IN PERIMETER LANDSCAPING FIRST 100' FROM ROCHESTER:	21 TREES

RIGHT OF WAY TREE CALCULATIONS

REQUIRED RIGHT OF WAY TREES:	
TOTAL REQUIRED CANOPY TREES:	10 TREE
TOTAL REQUIRED ORNAMENTAL TREES:	13 TREE
	23 TOTAL REQUIRED TREE
PROPOSED RIGHT OF WAY TREES:	
PROPOSED RIGHT OF WAY TREES: TOTAL PROPOSED CANOPY TREES:	
	6 TREE

WEST BUFFER TREE CALCULATIONS

REQUIRED TYPE 'D' BUFFER TREES (328 L.F.):	
TOTAL REQUIRED CANOPY TREES:	9 TREES
TOTAL REQUIRED ORNAMENTAL TREES:	5 TREES
TOTAL REQUIRED EVERGREEN TREES:	IT TREES
	31 TOTAL REQUIRED TREES
DOODOGED TYPE IN RUTTER THERE (220 E)	

PROPOSED TYPE 'D' BUFFER TREES (328 L.F.): TOTAL PROVIDED CANOPY TREES:

6 TREES 2 TREES TOTAL EXISTING CANOPY TREES TO REMAIN IN BUFFER: 5 TREES TOTAL PROVIDED ORNAMENTAL TREES: 18 TREES TOTAL PROVIDED EVERGREEN TREES:

31 PROVIDED TREES

TOTAL TREES

TOTAL REQUIRED TREES: RIGHT OF WAY + PARKING LOT + BUFFER	III TREES
TOTAL PROVIDED TREES: RIGHT OF WAY + PARKING LOT + BUFFER	III TREE: (106 PROPOSED 5 EXISTING

TREE NOTES:

(2) RIGHT-OF-WAY TREE PLANTINGS ARE LIMITED DUE TO SITE UTILITIES (OVERHEAD UTILITY LINES AND UNDERGROUND GAS LINE). THE ADDITIONAL TREES REQUIRED FOR RIGHT-OF-WAY TREE PLANTINGS

(3) 8' EVERGREEN TREES HAVE BEEN SUBSTITUTED FOR CANOPY/ORNAMENTAL TREE REQUIREMENTS DUE TO SITE LIMITATIONS

(1) SEE PLAN FOR REQUIRED SHRUB PLANTINGS

ARE ADDED INTO PARKING LOT TREE QUANTITIES.

Know what's below. Call before you dig. DRAWN: CHECKED: DATE: REVISIONS:

PROJECT NUMBER:

1"=30'-0"

June 29, 2021

21105

M. Dul

T. Shoemaker

March 10, 2021

March 18, 2021

June 1, 2021

LANDSCAPE DEVELOPMENT NOTES

I.) ALL EXISTING AND/OR PROPOSED SITE UTILITIES SHALL BE FIELD LOCATED, FLAGGED, AND VERIFIED PRIOR TO ANY LANDSCAPE CONSTRUCTION. 2.) ALL SPECIFIED AND INSTALLED PLANT MATERIAL SHALL BE IN FULL AND STRICT ACCORDANCE WITH AMERICAN NURSERYMAN STANDARDS (LATEST EDITION) AND BE:

- A.) NURSERY GROWN.
- B.) STATE DEPARTMENT OF AGRICULTURE INSPECTED AND APPROVED.
- C.) NO. 1 GRADE WITH STRAIGHT, UNSCARRED TRUNKS & WELL-DEVELOPED UNIFORM CROWNS ON TREES.
- D.) WARRANTED FOR A MIN. I YEAR FROM DATE OF ACCEPTANCE
- 3.) SPECIFIED PLANTING SOIL MIXTURE FOR ALL SPECIFIED BEDS & PLANTS SHALL BE THREE (3) PARTS IMPORTED WELL-DRAINED, SCREENED ORGANIC TOPSOIL, TO ONE (1) PART IMPORTED CLEAN SAND, TO ONE (1) PART CANADIAN SPHAGNUM PEAT MOSS, TO ONE (1) PART NATURAL COMPOST (WEED-FREE)-COMPLETE WITH 1% NATURAL POULTRY MANURE. INSTALL 12" MIN. DEPTH IN ALL PERENNIAL, GROUNDCOVER, ANNUAL, AND SHRUB BEDS. ALL BEDS MUST BE EXCAVATED, REMOVE AND DISPOSE (OFF-SITE) EX. EARTH/SOIL TO ACCEPT PROPOSED PLANT MIXTURE.
- 4.) PROPOSED SHREDDED HARDWOOD BARK MULCH SHALL BE SEASONED FOR A MINIMUM 6 MONTHS, DARK BROWN IN COLOR, AND INSTALLED 4" DEEP UNDER ALL PROPOSED TREES (INCLUDED IN UNIT COST), 4" DEEP IN ALL SHRUB AND TREE BEDS, AND 3" DEEP IN ALL PERENNIAL AND GROUNDCOVER BEDS, 5.) THE LANDSCAPE CONTRACTOR SHALL KEEP THE STREET AND DRIVE CLEAN AND FREE OF DIRT AND DEBRIS AT ALL TIMES, AND SHALL THOROUGHLY SWEEP AND/OR WASH THE DRIVE AT THE END OF EACH WORK DAY.
- 6.) ALL DEAD AND UNACCEPTABLE PLANT MATERIALS SHALL BE REPLACED BY THE LANDSCAPE CONTRACTOR DURING THE WARRANTY PERIOD. THE WARRANTY PERIOD SHALL BE ONE (1) YEAR FROM THE ACCEPTANCE OF INSTALLATION.
- 1.) PRIOR APPROVAL IS REQUIRED TO PLANT ANY TREE OR SHRUB ON THE PUBLIC RIGHT-OF-WAY. ALL TREES AND SHRUBS MUST BE PLANTED AT LEAST 10' AWAY FROM THE EDGE OF THE PUBLIC ROAD. (TREES MUST BE PLANTED AT LEAST 15' AWAY FROM CURB OR ROAD EDGE WHERE THE SPEED LIMIT IS MORE THAN 35 MPH.) SHADE TREES AND SHRUBS MUST BE PLANTED AT LEAST 5' AWAY FROM THE EDGE OF PUBLIC WALKWAY. EVERGREEN AND ORNAMENTAL TREES MUST BE PLANTED AT LEAST 10' FROM EDGE OF THE PUBLIC WALKWAY. NO TREES OR SHRUBS MAY BE PLANTED WITHIN THE TRIANGULAR AREA FORMED AT THE INTERSECTION OF ANY STREET RIGHT-OF-WAY LINES AT A DISTANCE ALONG EACH LINE OF 25' FROM THEIR POINT OF INTERSECTION. NO TREES OR SHRUBS MAY BE PLANTED IN THE TRIANGULAR AREA FORMED AT THE INTERSECTION OF ANY DRIVEWAY WITHIN PUBLIC WALKWAY AT A DISTANCE ALONG EACH LINE OF 15' FROM THEIR POINT OF INTERSECTION. ALL TREES AND SHRUBS MUST BE PLANTED AT LEAST 10' AWAY FROM ANY FIRE HYDRANT. SHADE AND EVERGREEN TREES MUST BE PLANTED AT LEAST 15' AWAY FROM THE NEAREST OVERHEAD WIRE. TREES MUST BE PLANTED A MINIMUM OF 5' FROM AN UNDERGROUND UTILITY, UNLESS THE CITY'S LANDSCAPE ARCHITECT REQUIRES A GREATER DISTANCE. PRIOR TO RELEASE OF THE PERFORMANCE BOND, THE CITY OF ROCHESTER HILLS FORESTRY UNIT NEEDS TO INSPECT ALL TREES, EXISTING OR PLANTED, TO IDENTIFY ANY THAT POSE A HAZARD TO THE SAFE USE OF THE PUBLIC RIGHT-OF-WAY. FORESTRY MAY REQUIRE THE DEVELOPER TO REMOVE, AND POSSIBLY REPLACE, ANY SUCH TREES. THE ABOVE REQUIREMENTS ARE INCORPORATED INTO THE PLAN.
- 9.) PRUNING SHALL BE MINIMAL AT THE TIME OF INSTALLATION, ONLY TO REMOVE DEAD OR DISEASED BRANCHES. SUBSEQUENT PRUNING SHALL ASSURE PROPER MATURATION OF PLANTS TO ACHIEVE THEIR APPROVED PURPOSE.
- 10.) ALL DEAD, DAMAGED, OR DISEASED PLANT MATERIAL SHALL BE REMOVED IMMEDIATELY AND REPLACED WITHIN SIX (6) MONTHS AFTER IT DIES OR IN THE NEXT PLANTING SEASON, WHICHEVER COMES FIRST. FOR PURPOSES OF THIS SECTION, THE PLANTING SEASON FOR DECIDUOUS PLANTS SHALL BE MARCH I TO JUNE I AND OCTOBER UNTIL THE PREPARED SOIL BECOMES FROZEN. THE PLANTING SEASON FOR EVERGREEN PLANTS SHALL BE BETWEEN MARCH I AND JUNE I. PLANT MATERIAL INSTALLED TO REPLACE DEAD OR DISEASED MATERIAL SHALL BE AS CLOSE AS PRACTICAL TO THE SIZE OF THE MATERIAL IT IS INTENDED TO REPLACE. THE CITY MAY NOTIFY PROPERTY OWNERS OF THE NEED TO REPLACE DEAD, DAMAGED, OR DISEASED MATERIAL.
- 11.) THE APPROVED LANDSCAPE PLAN SHALL BE CONSIDERED A PERMANENT RECORD AND INTEGRAL PART OF THE SITE PLAN APPROVAL. UNLESS OTHERWISE APPROVED IN ACCORDANCE WITH THE AFOREMENTIONED PROCEDURES, ANY REVISIONS TO OR REMOVAL OF PLANT MATERIALS, OR NON-COMPLIANCE WITH THE MAINTENANCE REQUIREMENTS OF SECTION 138-12.109 WILL REPLACE THE PARCEL IN NON-CONFORMITY WITH THE APPROVED LANDSCAPE PLAN AND BE A VIOLATION OF THE ORDINANCE.
- 12.) IF PROTECTED TREES ARE DAMAGED, A FINE SHALL BE ISSUED ON AN INCH-BY-INCH BASIS AT A MONETARY RATE AS DEFINED BY THE FORESTRY DEPARTMENT.

13.) PRIOR TO RELEASE OF PERFORMANCE BOND, THE CITY OF ROCHESTER HILLS MUST INSPECT AND APPROVE ALL LANDSCAPE PLANTINGS.

IRRIGATION NOTES

- 1.) INSTALL UNDERGROUND AUTOMATIC IRRIGATION SYSTEM FOR ALL LAWN AND PLANTING BEDS. 2.) USE SEPARATE ZONES FOR LAWN, DECIDUOUS
- SHRUBS, AND EVERGREEN SHRUBS.

 3.) WATER SOURCED FROM CITY WATER/BUILDING TAP


 4.) OWNER TO DECIDE IRRIGATION CONTROLLER


 LOCATION.
- 5.) WATERING SHALL ONLY OCCUR BETWEEN THE HOURS OF 12AM AND 5AM PER CITY ORDINANCE.


LAWN SCHEDULE


OVERALL SITE


4,000 SY. Supply and install Class 'A' Blended Blue Grass Sod on minimum 3" imported screened topsoil

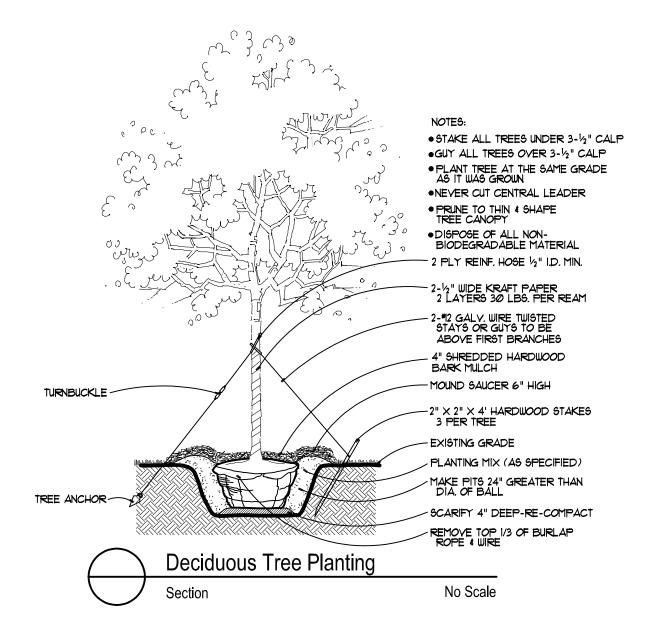

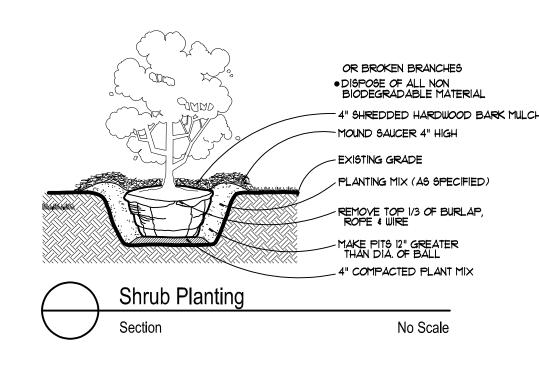

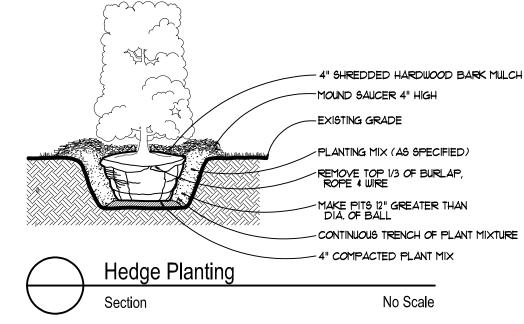

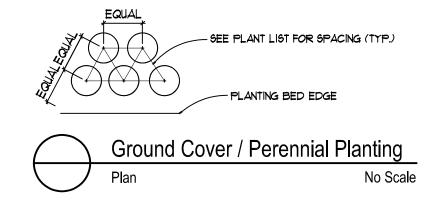

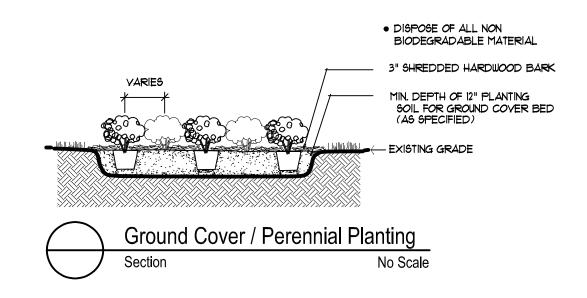

TREE PROTECTION NOTES

1) ALL TREES PROPOSED TO BE REMOVED SHALL BE MARKED IN THE FIELD WITH FLUORESCENT SPRAY PAINT (CHALK BASED) OR BY FLUORESCENT FLAGGING TAPE.
2) 4' HT. PLASTIC SNOW FENCING SHALL BE INSTALLED AT OR BEYOND THE DRIPLINE, UNLESS MORE SUBSTANTIAL FENCING IS REQUIRED.

3) STAKES SHALL BE METAL "T" POLES SPACED NO FURTHER APART THAN 10' ON CENTER
4) FENCING SHALL BE INSTALLED FIVE (5) FEET OUTSIDE THE TREE DRIP LINE UNLESS IT CAN
BE DEMONSTRATED THAT THIS IS NOT PRACTICAL.

5) FENCING SHALL BE ERECTED PRIOR TO CONSTRUCTION. THE CITY SHALL BE NOTIFIED ONCE THE FENCING IS INSTALLED FOR INSPECTION.

6) TREE PROTECTION SHALL REMAIN IN ITS APPROVED LOCATION UNTIL SUCH TIME REMOVAL IS AUTHORIZED BY THE LANDSCAPE ARCHITECT.

1) NO ACTIVITY SHALL BE CONDUCTED WITHIN TEN (10) FEET OF THE TREE DRIP LINE, INCLUDING BUT NOT LIMITED TO PLACING OF ANY SOLVENTS, MATERIALS, CONSTRUCTION MACHINERY, VEHICLES OR SOIL.

8) THE LOCATION OF FENCING MAY BE ADJUSTED, AS APPROVED BY THE LANDSCAPE ARCHITECT, IN THE FIELD TO ACCOMMODATE SITE-SPECIFIC CONDITIONS/CONSTRAINTS
9) DURING CONSTRUCTION, NO PERSON SHALL ATTACH A DEVICE OR WIRE TO ANY REMAINING TREE, EXCEPT TO CORDON OFF PROTECTED AREAS AS REQUIRED.

4' HIGH SNOW FENCE
 TO BE INSTALLED AROUND
 DRIP LINE OF TREES PRIOR
 TO ANY LAND CLEARING
 OR CONSTRUCTION

 NO CUTTING, FILLING, OR TRESPASSING
 SHALL OCCUR INSIDE THE FENCED AREA

TREE DRIP LINE

TREE DRIP LINE

FENCE - ALTERNATE LOCATION 3'
BACK OF PROPOSED WALKS, DRIVES & CURBS
AS APPROVED BY LANDSCAPE ARCHITECT

FENCE 5' AWAY FROM
TREE DRIP LINE

FINISH GRADE

MIN.



LANDSCAPE ARCHITECTURE

MICHAEL J. DUL & ASSOCIATES, INC

> 212 DAINES STREET BIRMINGHAM MICHIGAN 48009

> > P 248 644 3410 F 248 644 0819

www.mjdul.com

Bebb Oak Meadows
2800 Rochester Road
Rochester Hills, MI

PROJECT

Preliminary
Landscape Plan
Specifications & Details

SHEETTILE



See Details

SCALE

PROJECT NUMBER: 21105


DRAWN: T. Shoemaker


CHECKED: M. Dul

DATE: June 1, 2021

REVISIONS: NO REVISIONS 09.14.21



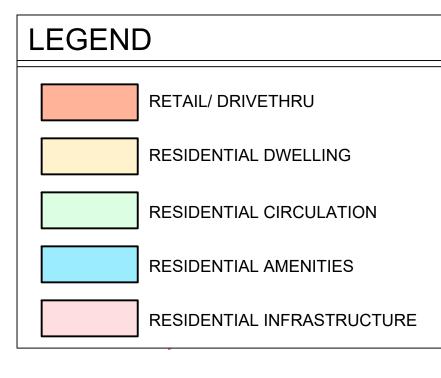

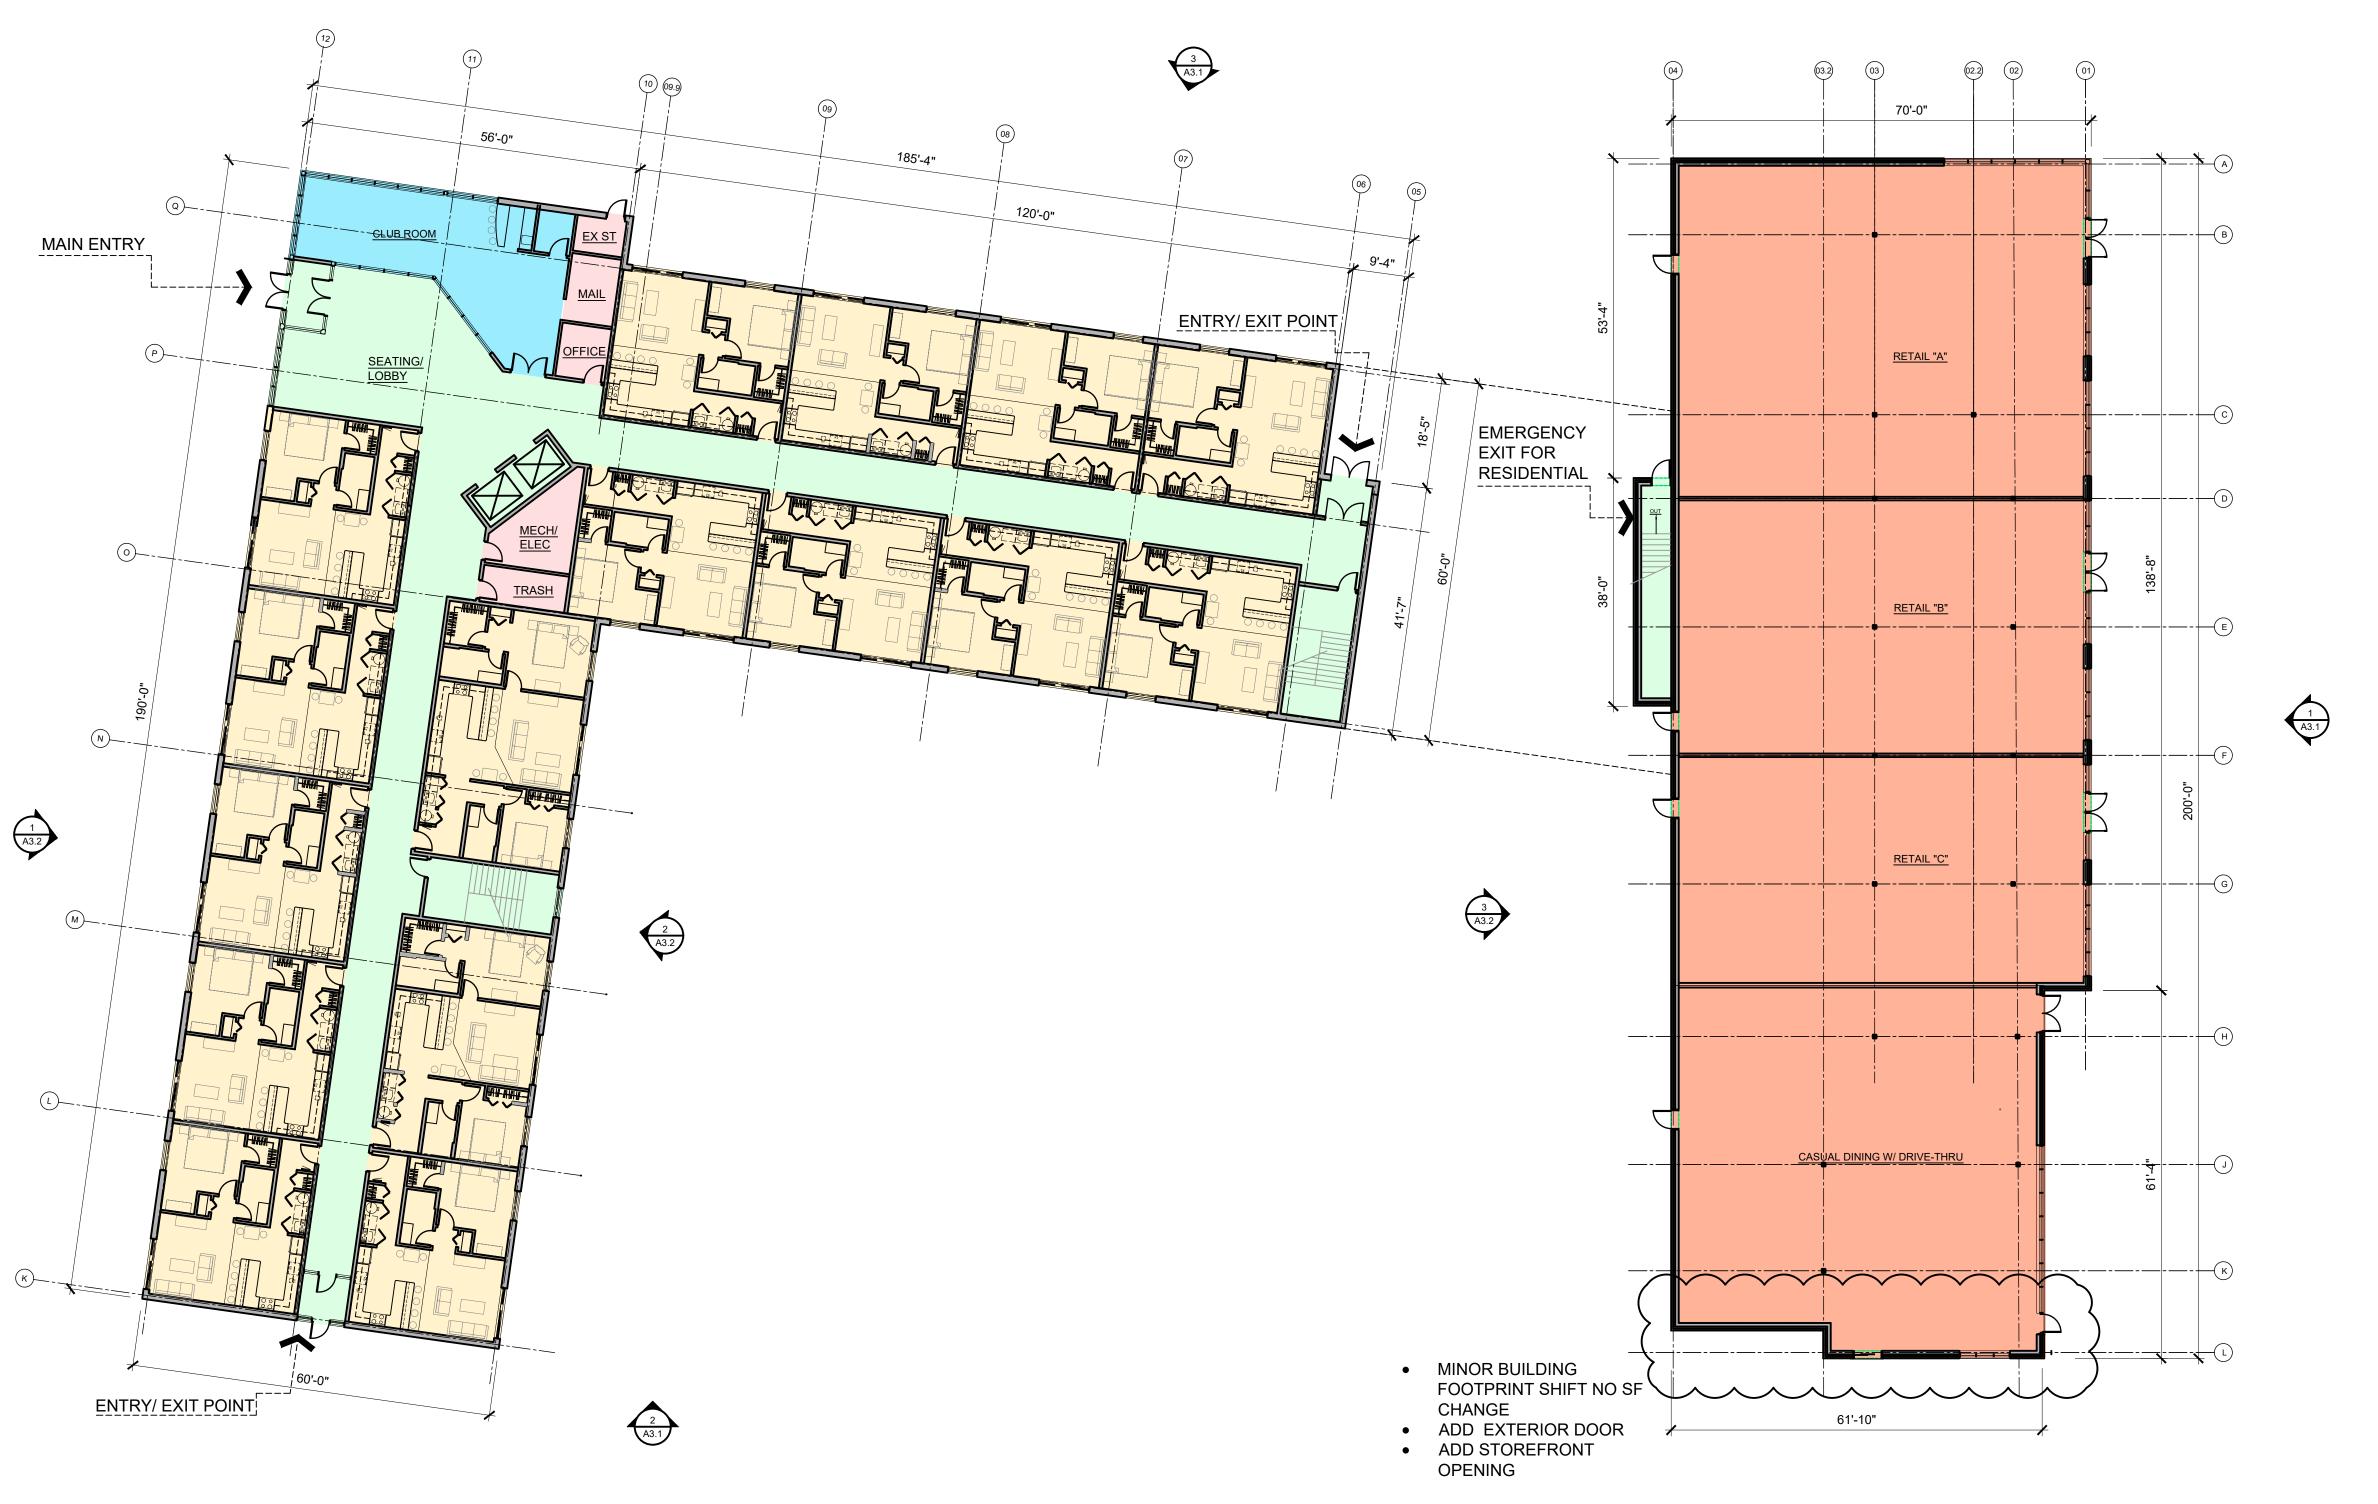

5



NOT2FOR CONSTRUCTION

STUCKY VITALE ARCHITECTS 27172 WOODWARD AVENUE ROYAL OAK, MI 48067-0925 P. 248.546.6700 F. 248.546.8454 W W W . STUCKYVITALE.COM

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Consultants:

BEBB OAK MEADOWS MIXED USE DEVELOPMENT 2800 S. ROCHESTER ROAD ROCHESTER HILLS, MI 4830

Issued for:

SPA SUBMITTAL 03.19.21

NO REVISIONS 06.01.21

NO REVISIONS 06.29.21


SPA REVIEW REV. 09.14.21




Drawn by : SVA Checked by : SVA

Sheet Title : FIRST FLOOR PLAN

Project No. : 2020.137

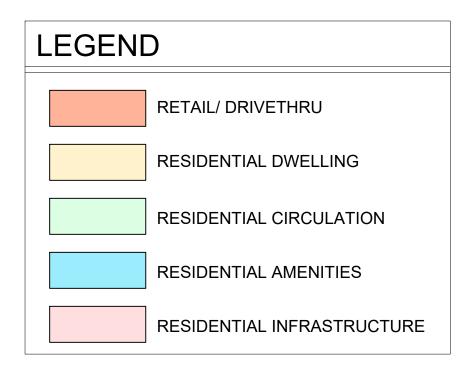

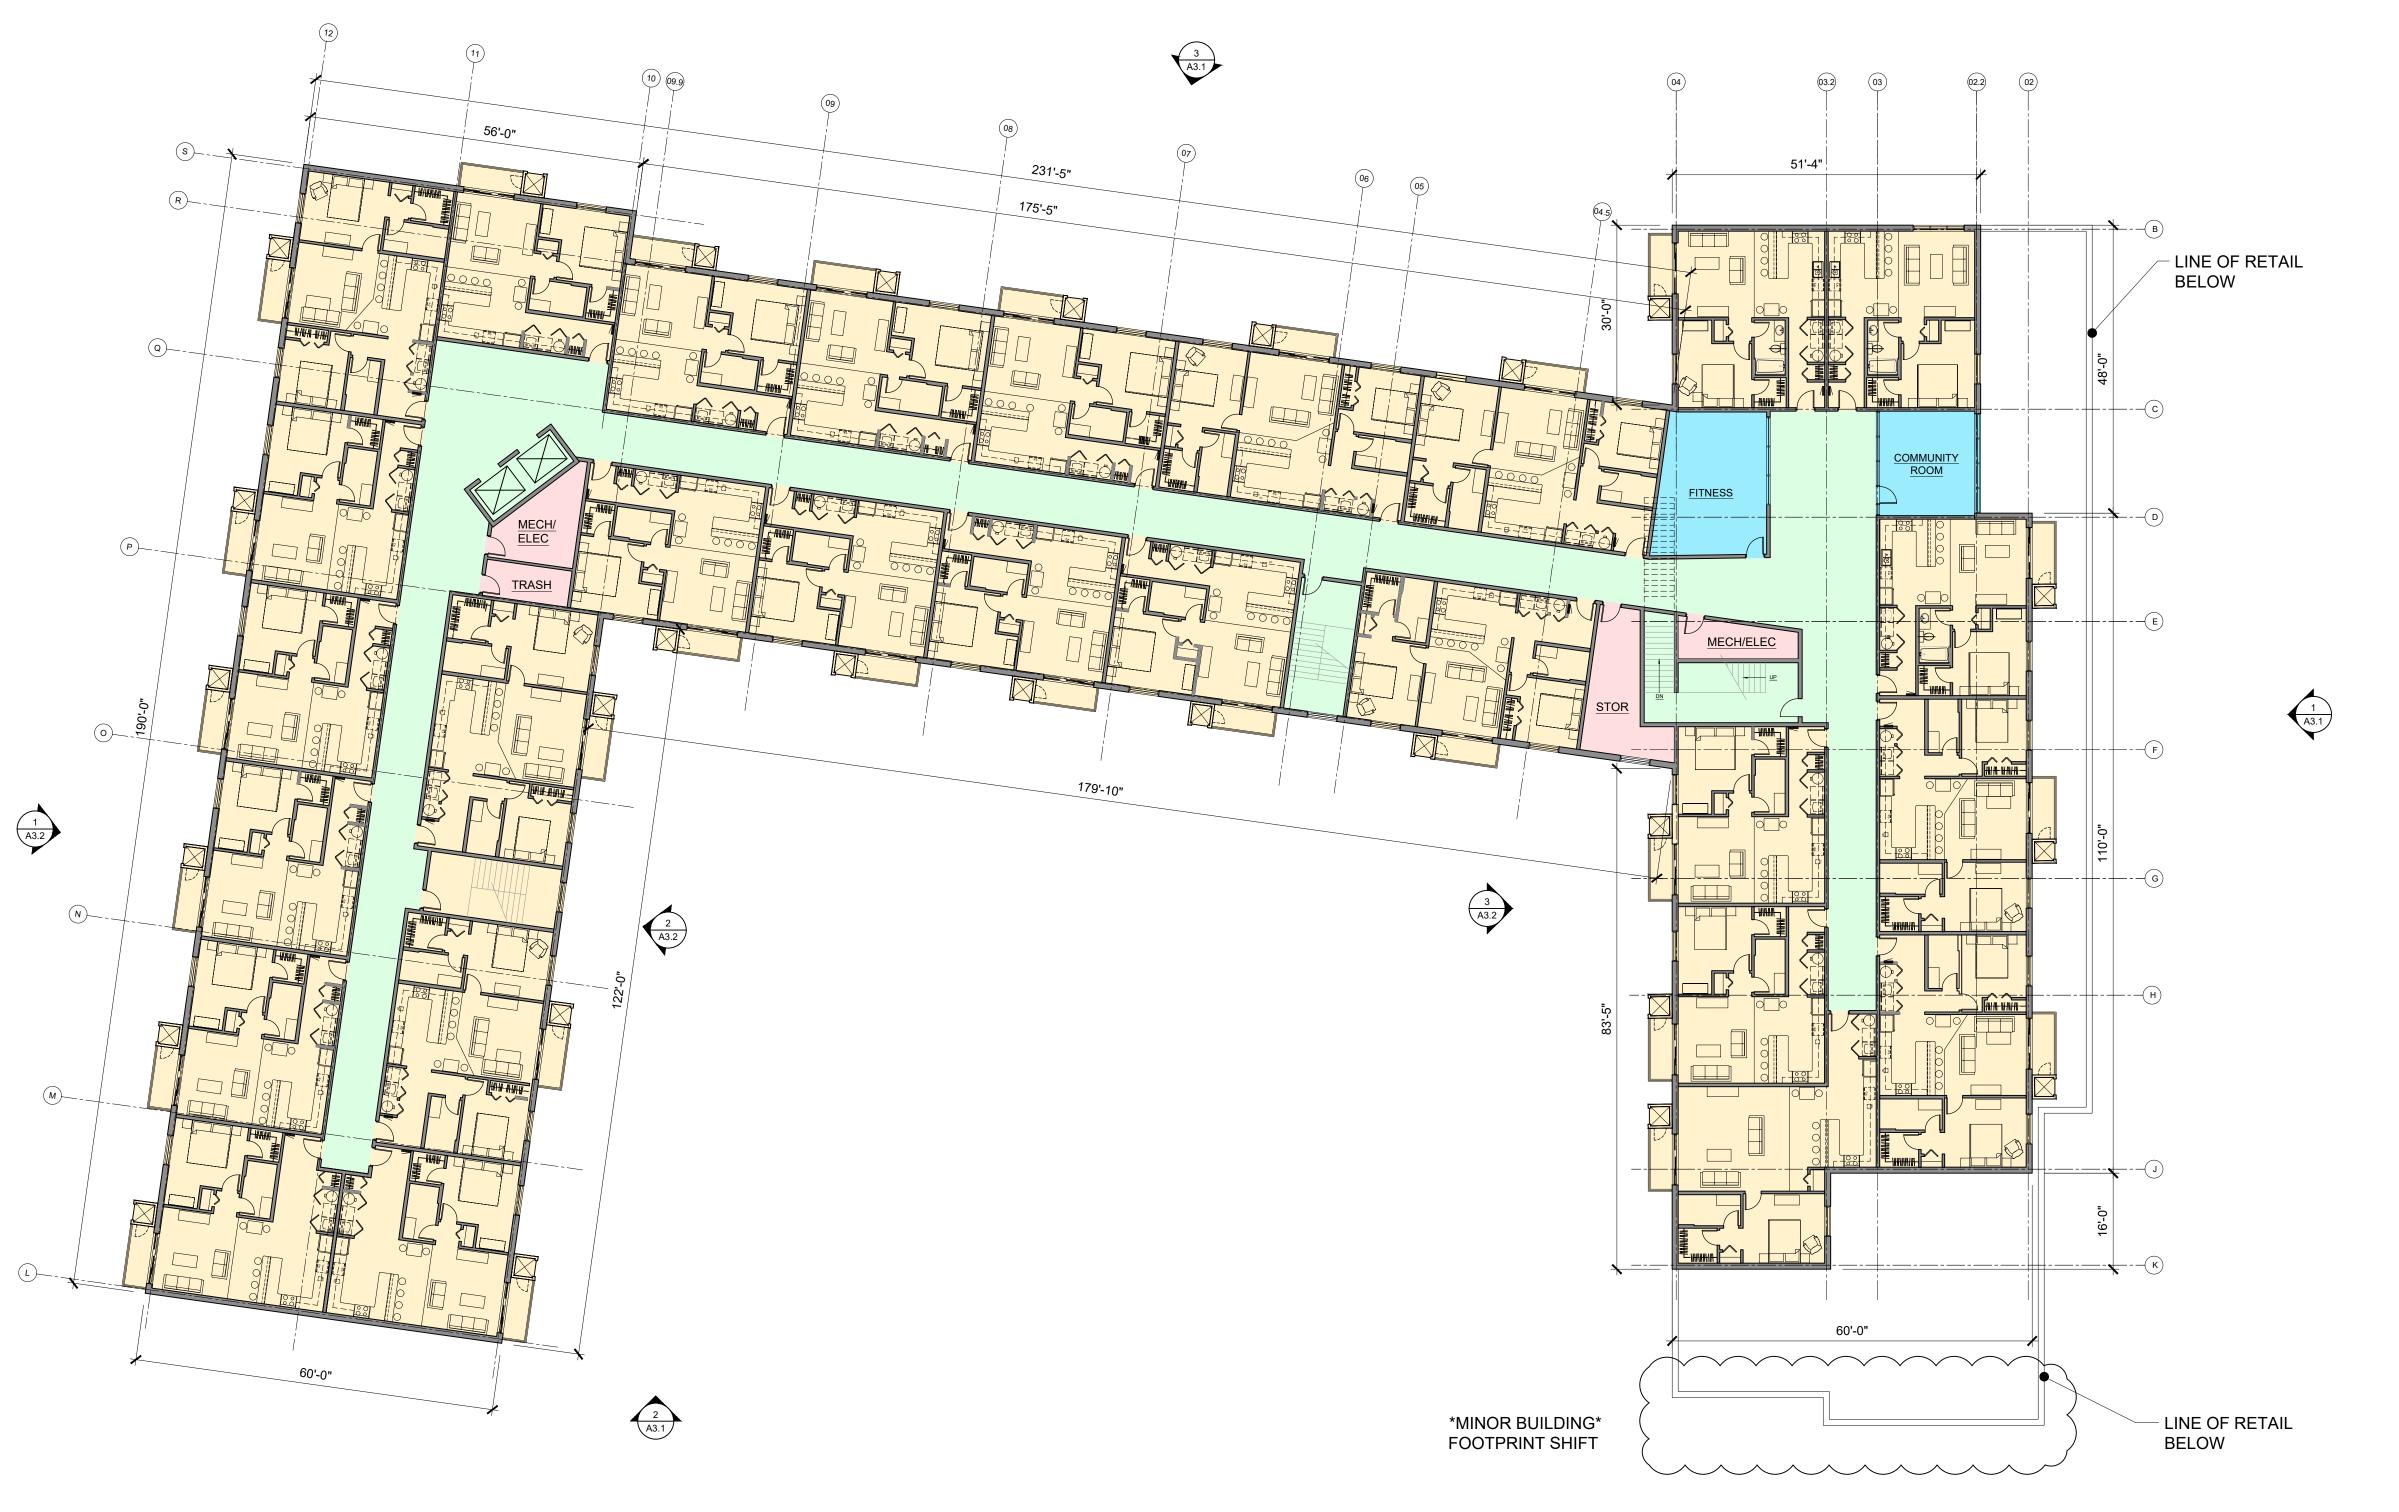

3

SECOND FLOOR PLAN

SCALE: 1/16"=1'-0'

NOT2FOR CONSTRUCTION OF TRUE TO THE PROPERTY OF THE PROPERTY O



STUCKY VITALE ARCHITECTS
27172 WOODWARD AVENUE
ROYAL OAK, MI 48067-0925
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F. 248.546.8454
WWW.STUCKYVITALE.COM

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Consultants:

Project:

BEBB OAK MEADOWS
MIXED USE DEVELOPMENT
2800 S. ROCHESTER ROAD
ROCHESTER HILLS, MI 4830

Issued for :

SPA SUBMITTAL 03.19.21
NO REVISIONS 06.01.21
NO REVISIONS 06.29.21
SPA REVIEW REV. 09.14.21



Drawn by : SVA Checked by : SVA

Sheet Title : SECOND FLOOR PLAN

Project No. : 2020.137

A1.2