PRELIMINARY SITE PLANS FOR

ROCHESTER RETAIL

N.E.C. OF ROCHESTER ROAD AND AVON ROAD

CITY OF ROCHESTER HILLS, OAKLAND COUNTY, MICHIGAN





A CONDITIONAL USE PERMIT IS REQUIRED FOR THE DRIVE-THROUGH

Refer to Section 138-1.203 of the Zoning Ordinance for conditional use signage requirements. Signs advertising a conditional use is proposed for the property must be posted 15 days prior to the public hearing.

DEVELOPER:

ROCHESTER AVON PARTNERS, LLC 251 EAST MERRILL STREET, SUITE #205 BIRMINGHAM, MI, 48009 CONTACT: DORAID MARKUS PHONE: (248) 892-2222 EMAIL: DMARKUS@MARKUSLLC.COM

ARCHITECT:


ROGVOY ARCHITECTS 32500 TELEGRAPH ROAD, SUITE #250 BINGHAM FARMS, MI, 48025 CONTACT: MARK DRANE PHONE: (248) 540-7700 FAX: (248) 540-2710

<u>CIVIL ENGINEER:</u>

PEA GROUP 2430 ROCHESTER COURT, SUITE 100 TROY, MI, 48083 CONTACT: RACHEL L. SMITH, PE PHONE: (248) 689-9090 EXT. 1165 FAX: (248) 689-1044 EMAIL: RACHEL.SMITH@PEAGROUP.COM

LANDSCAPE ARCHITECT:

PEA GROUP 7927 NEMCO WAY, SUITE 115 BRIGHTON, MI 48116 CONTACT: JEFF SMITH, R.L.A., LEED AP PHONE: (517) 546-8583 FAX: (517) 546-8973 EMAIL: JSMITH@PEAGROUP.COM

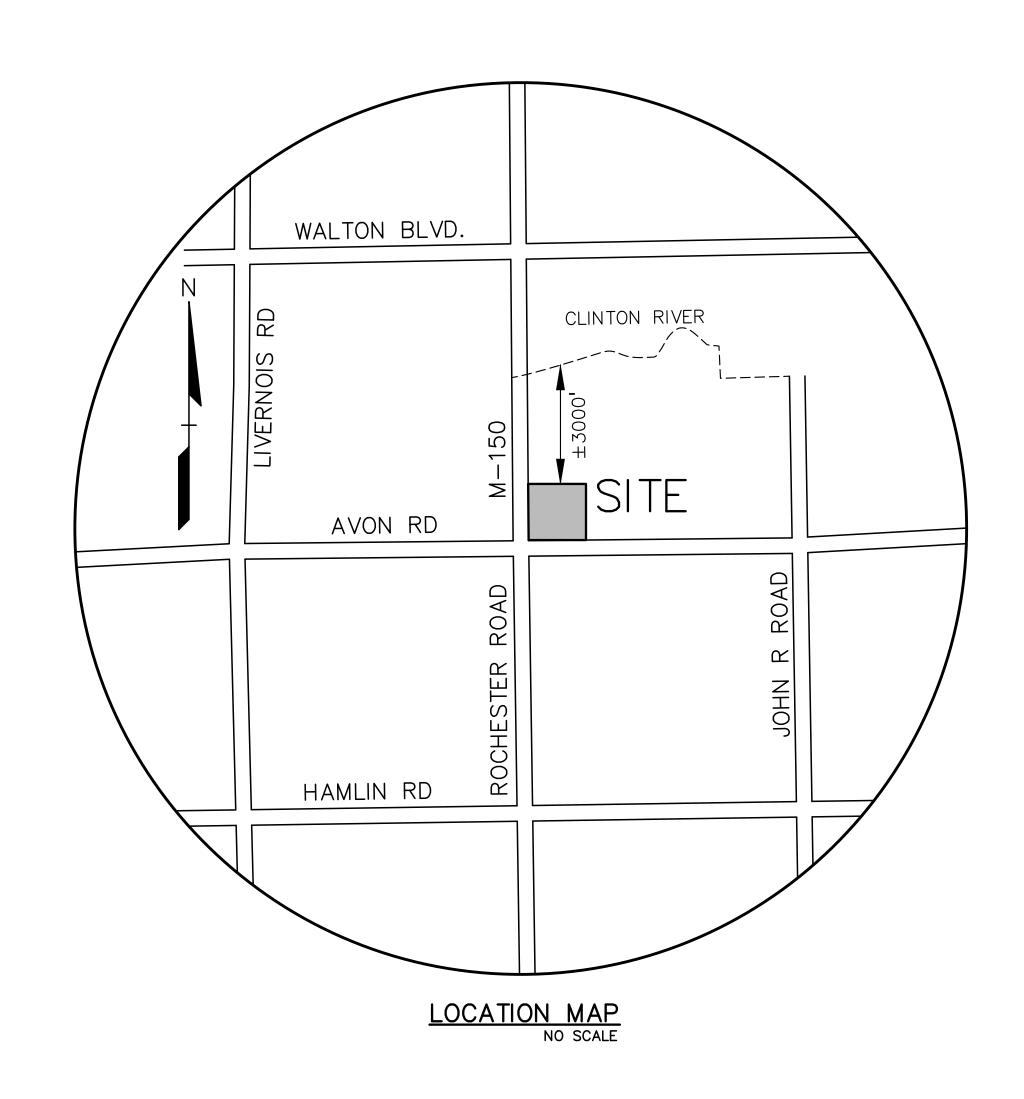

S	Site Plan Review		
Reviewed f	or compliance to the City Ord Building and Fire Codes	dinance,	
Department	Reviewer	Approved	
Planning	Kristen Kapelanski 248-841-2772 KapelanskiK@RochesterHills.org	Yes	
Building	Mark Artinian 248-841-2446 ArtinianM@RochesterHills.org	Yes	C. McEwen for M. Artinian
Engineering	Jason Boughton 248-841-2490 BoughtonJ@RochesterHills.org	Yes	
Nat. Resources	Matt Einheuser 248-841-2551 EinheuserM@RochesterHills.org	Yes	
Fire	Lt. Ann Echols 248-841-2701 EcholsA@RochesterHills.org	Yes	
	City of Rochester Hills hing & Economic Developme and mark-ups noted throughout the plan set addressed prior to final approval.		



INDEX OF DRAWINGS:

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TREE PRESERVATION PLAN

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PHOTOMETRIC PLANS: SHEET 1 OF 2 LED SITE LAYOUT SHEET 2 OF 2 LED SITE LAYOUT CLIENT

ROCHESTER AVON PARTNERS, LLC 251 EAST MERRILL STRÉET, SUITE #205

PROJECT TITLE

REVISIONS

RETAIL REDEVELOPMENT N.E.C. ROCHESTER ROAD & AVON ROAD


CITY COMMENTS	6/16/21
CITY COMMENTS	7/21/21


DRAWING TITLE **COVER SHEET**


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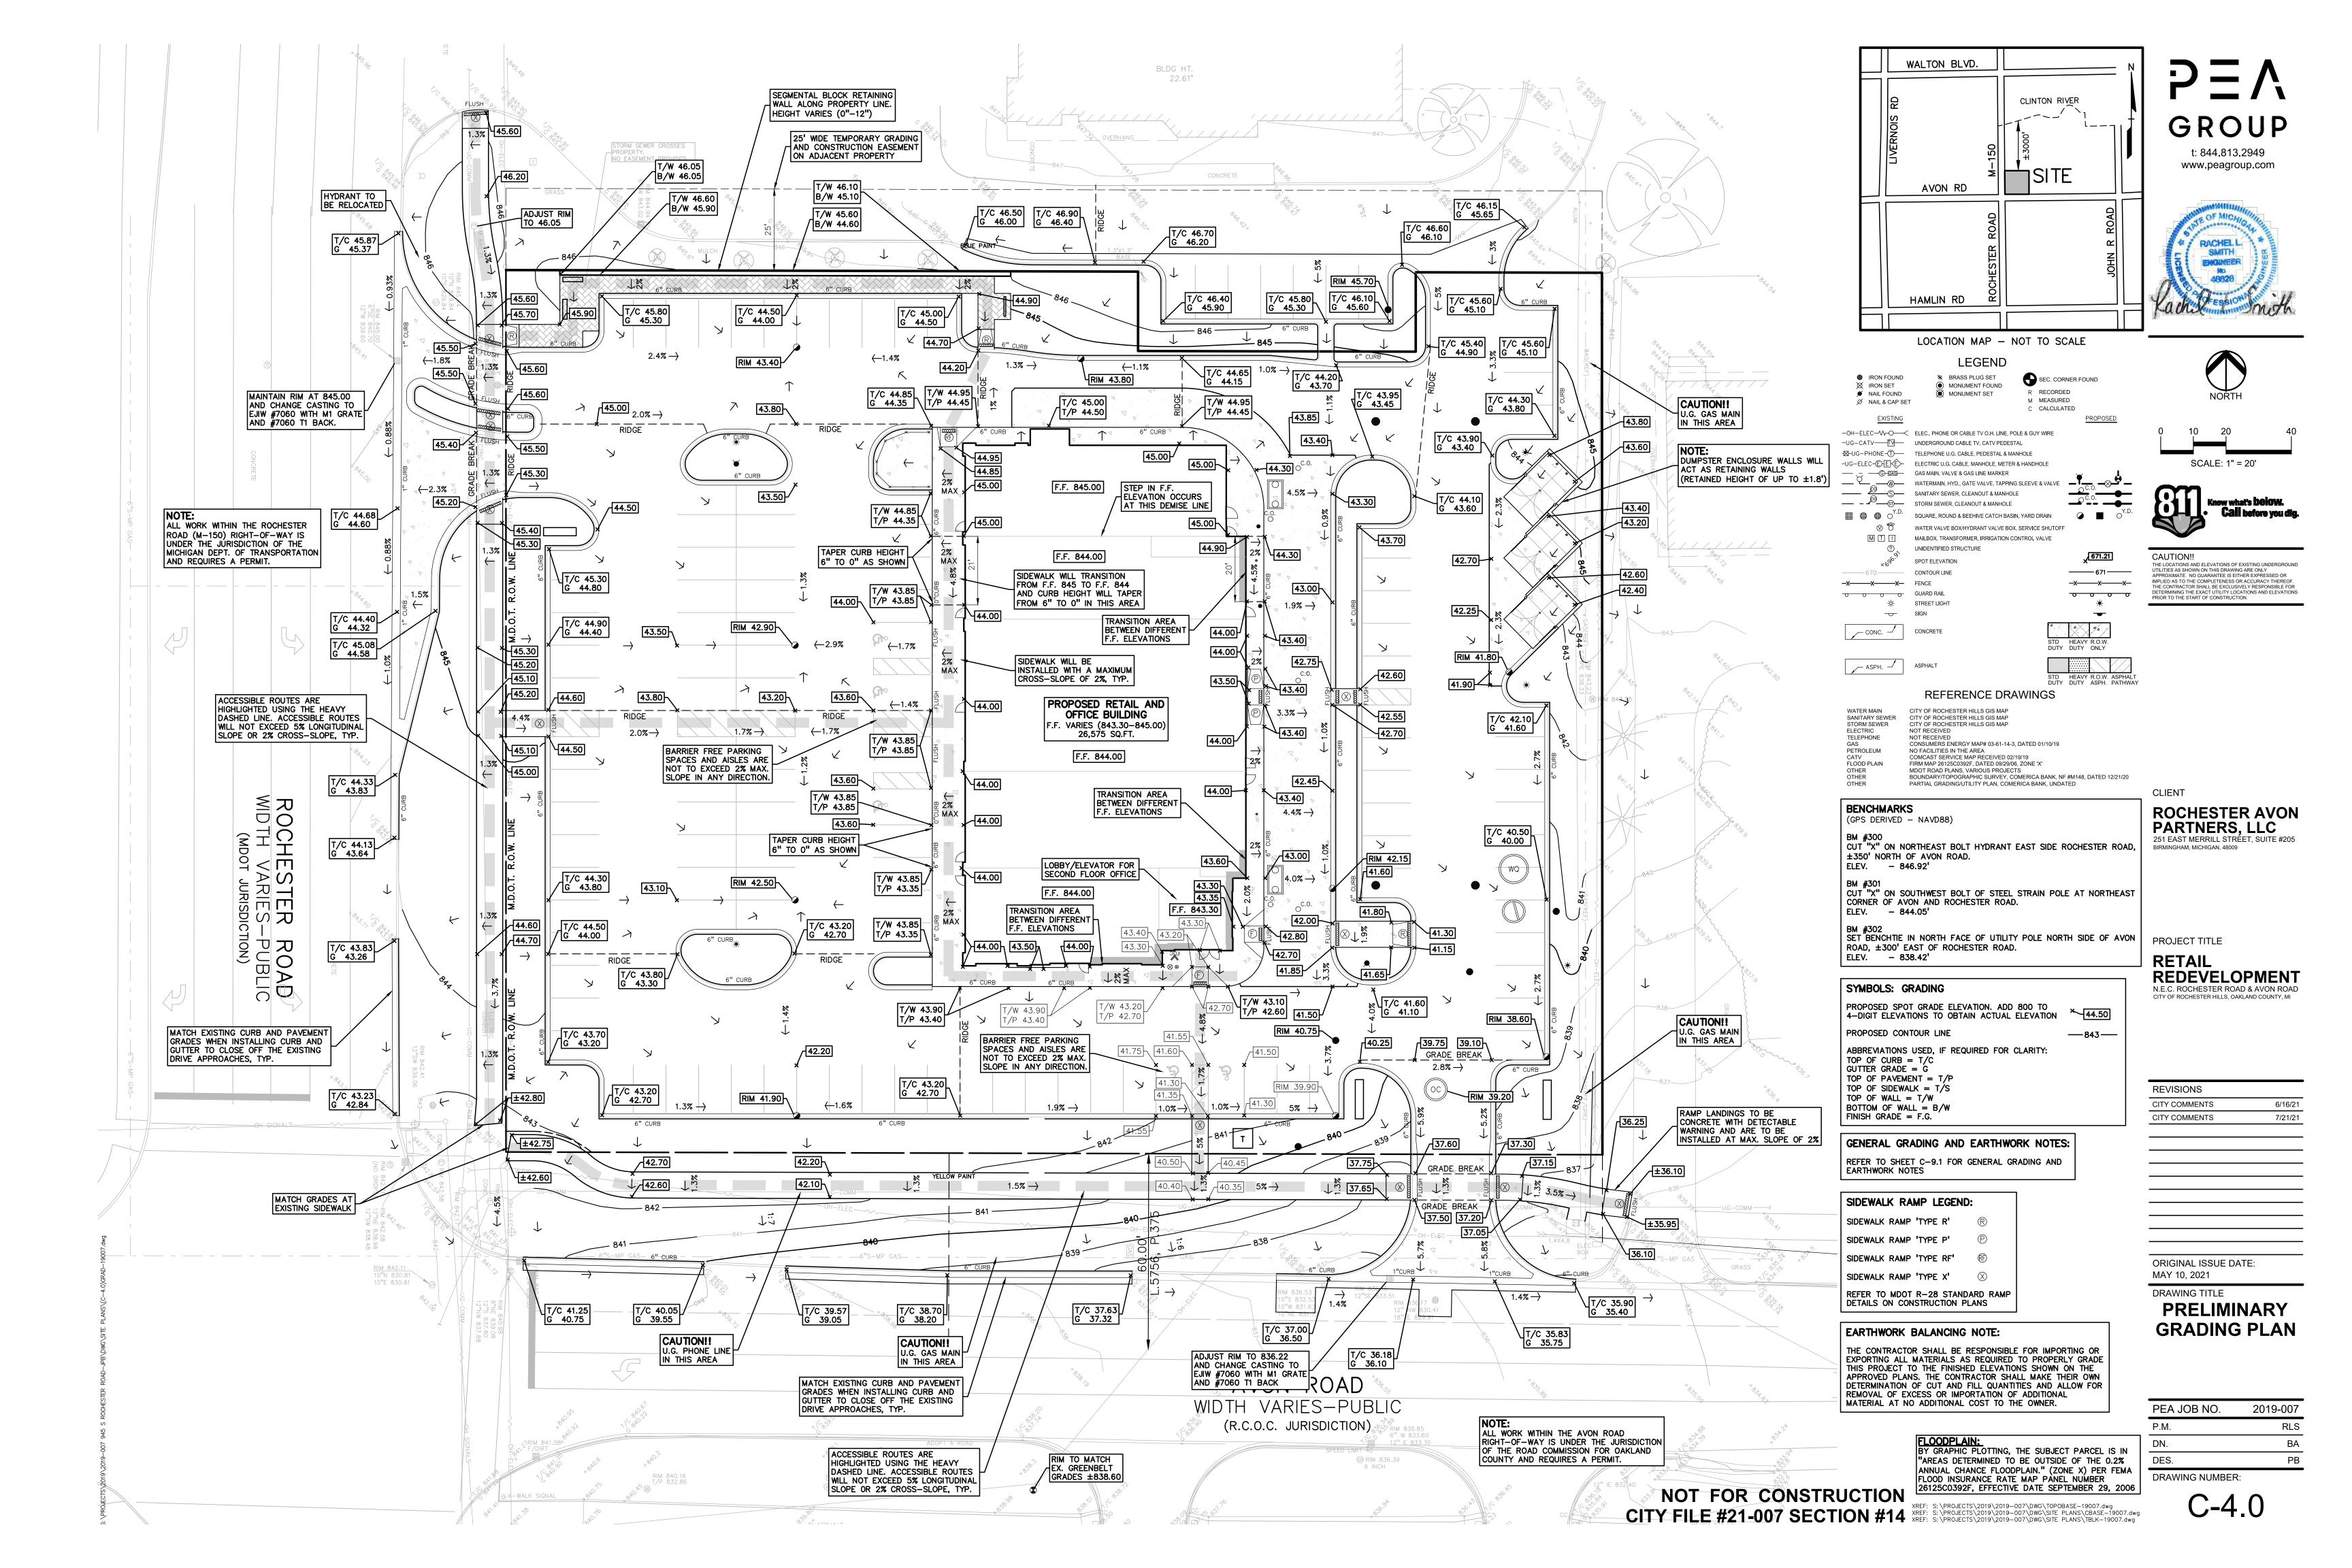
MAY 10, 2021


PEA JOB NO.	2019-007
P.M.	RLS
DN.	ВА
DES.	РВ
DRAWING NUMBER:	




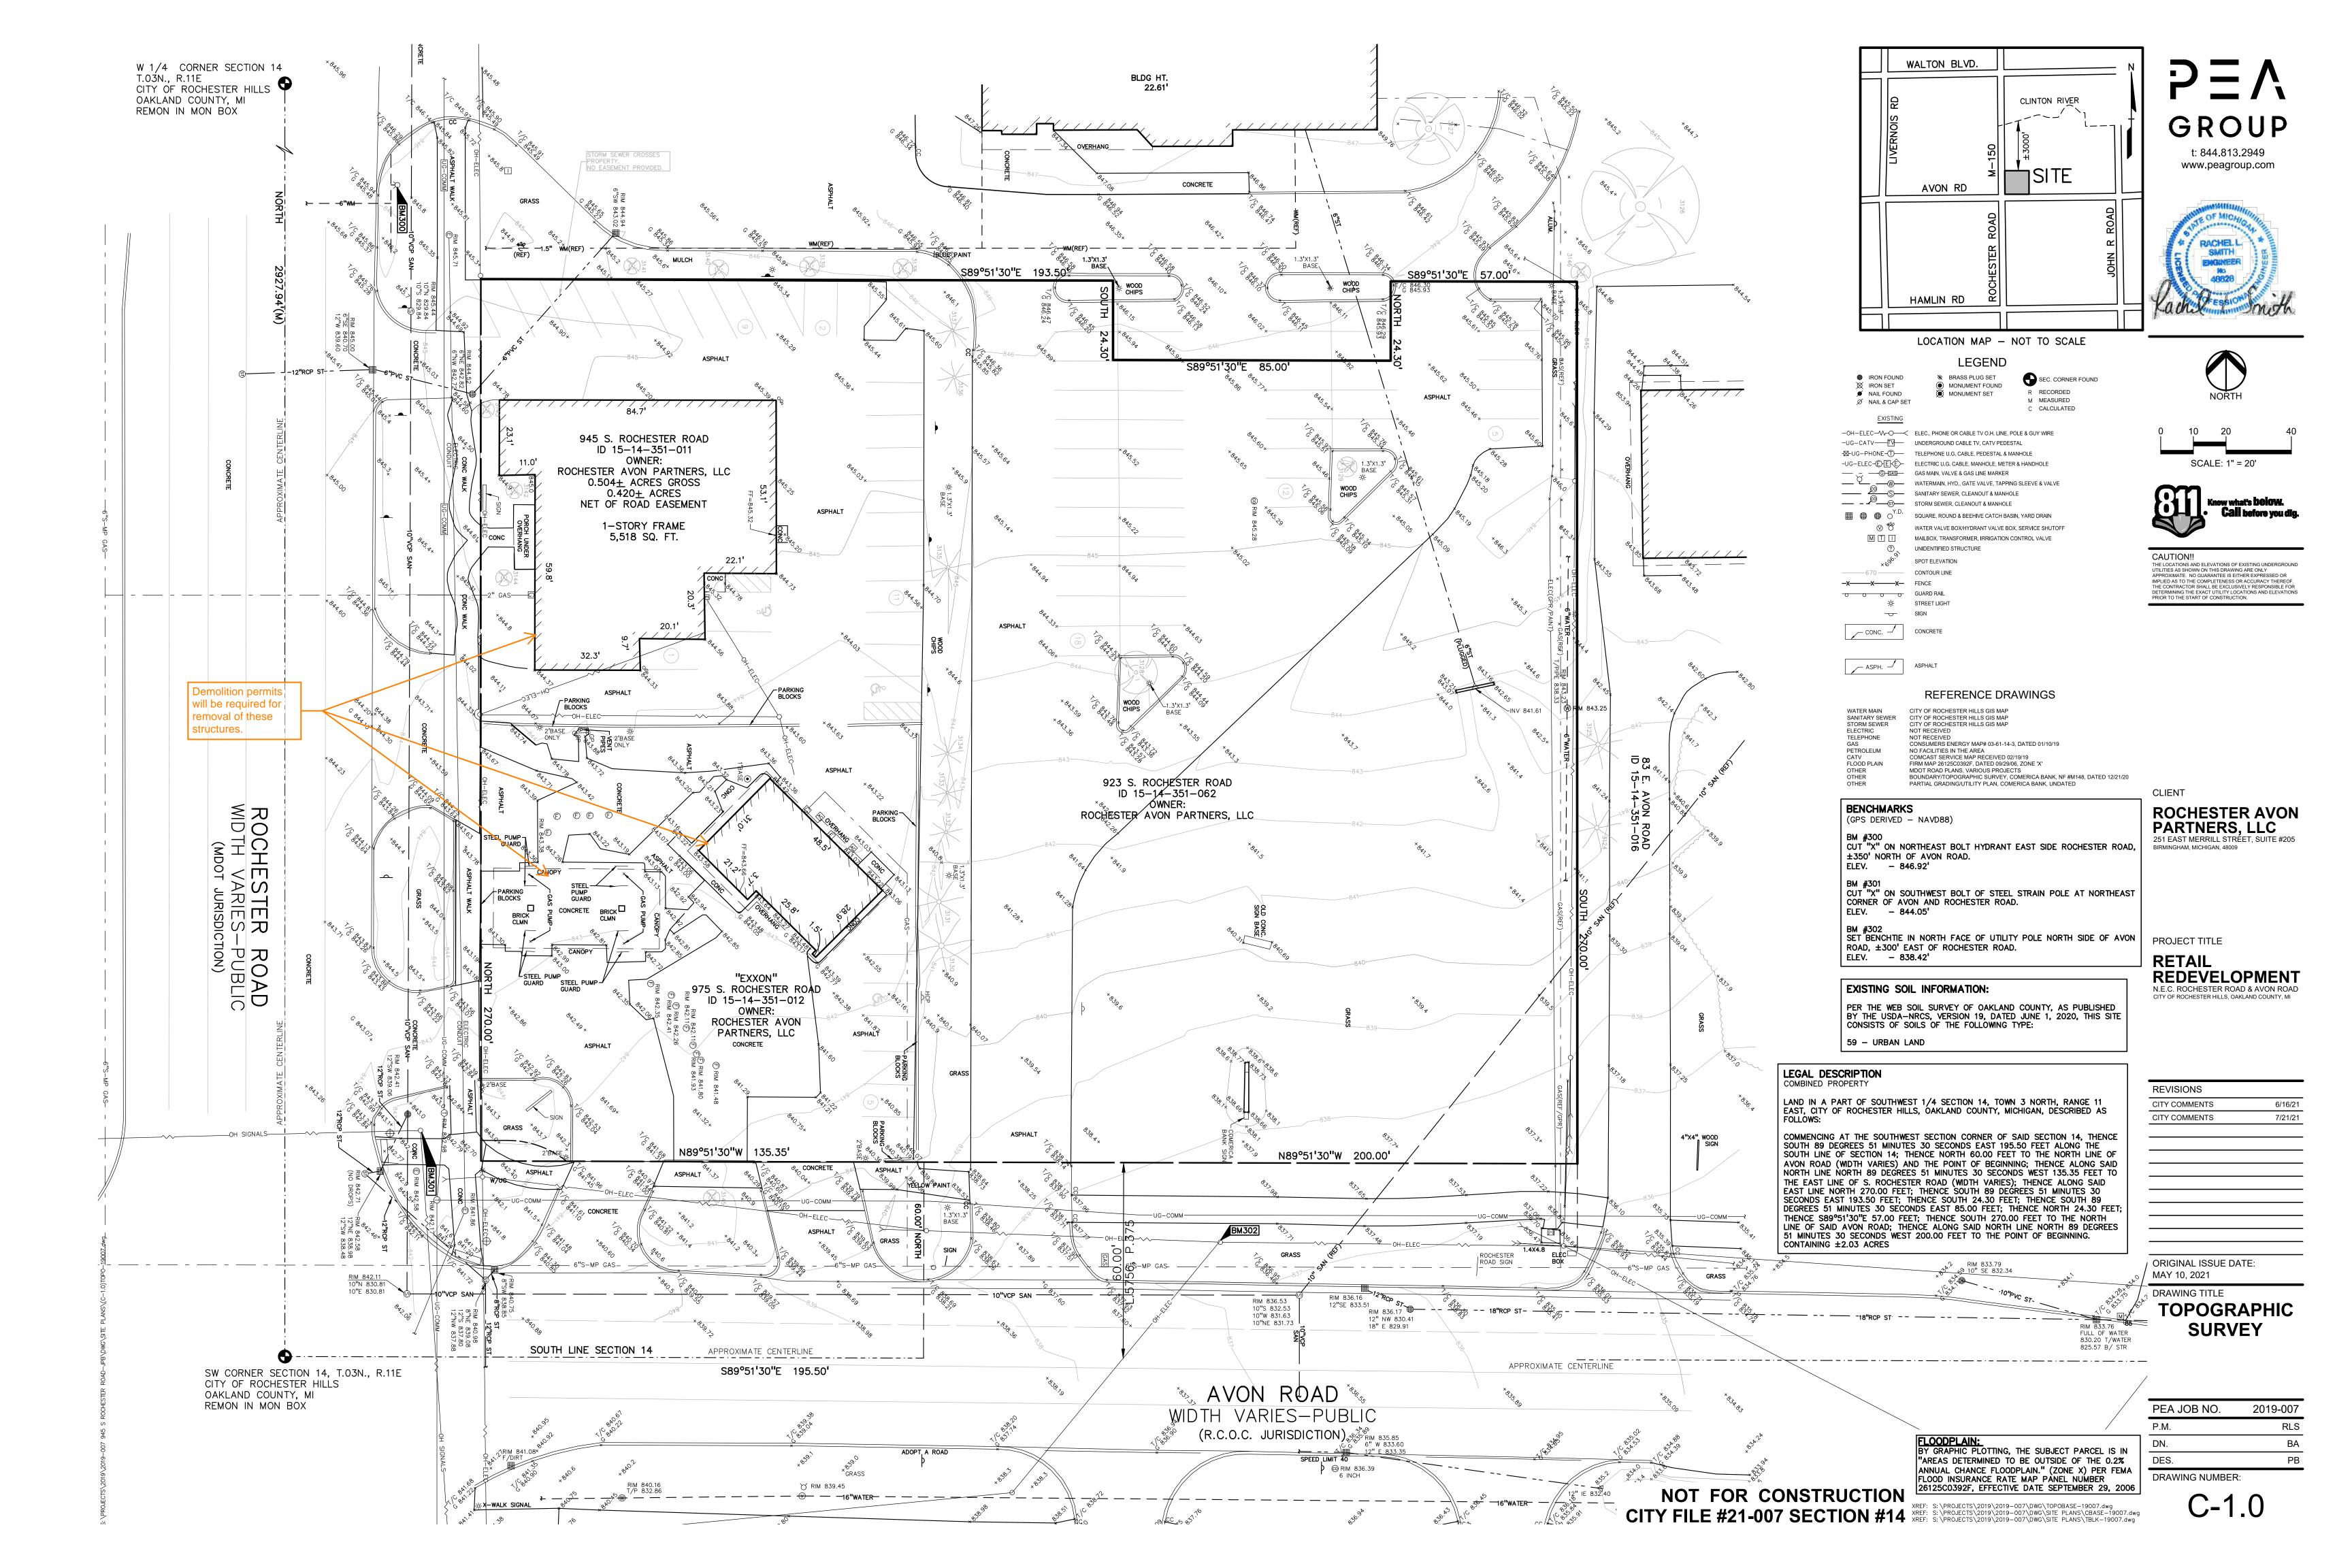

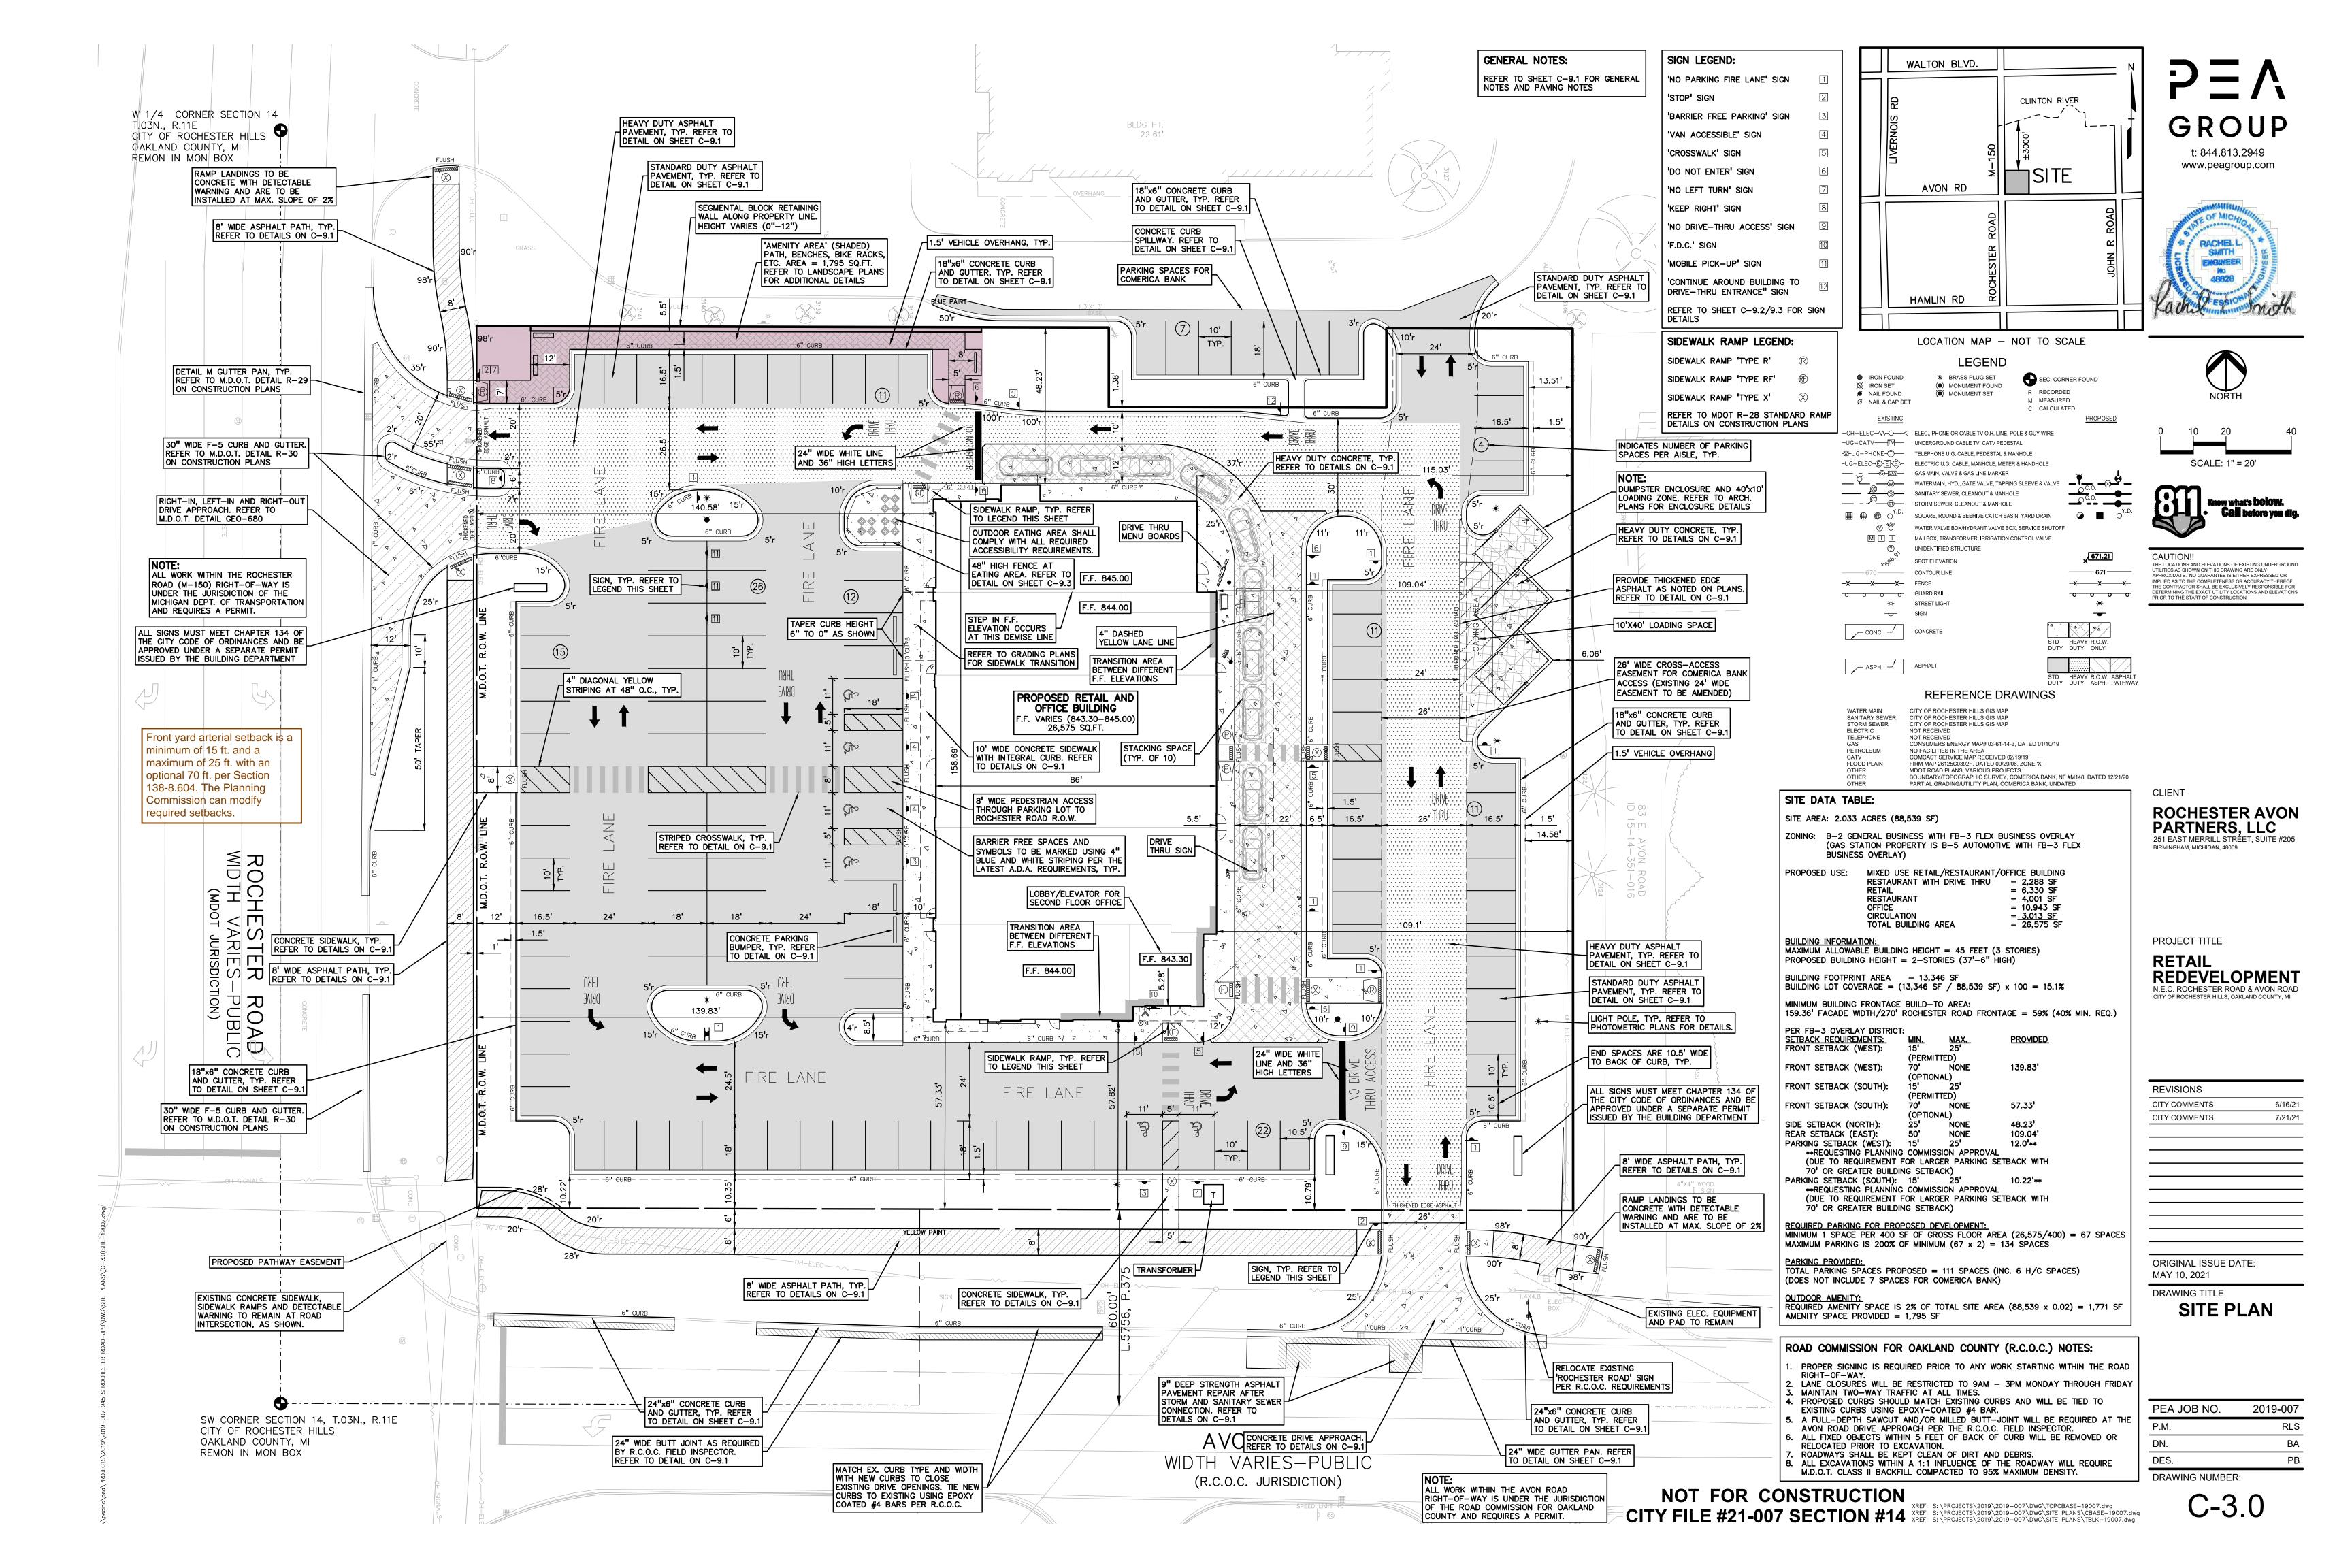


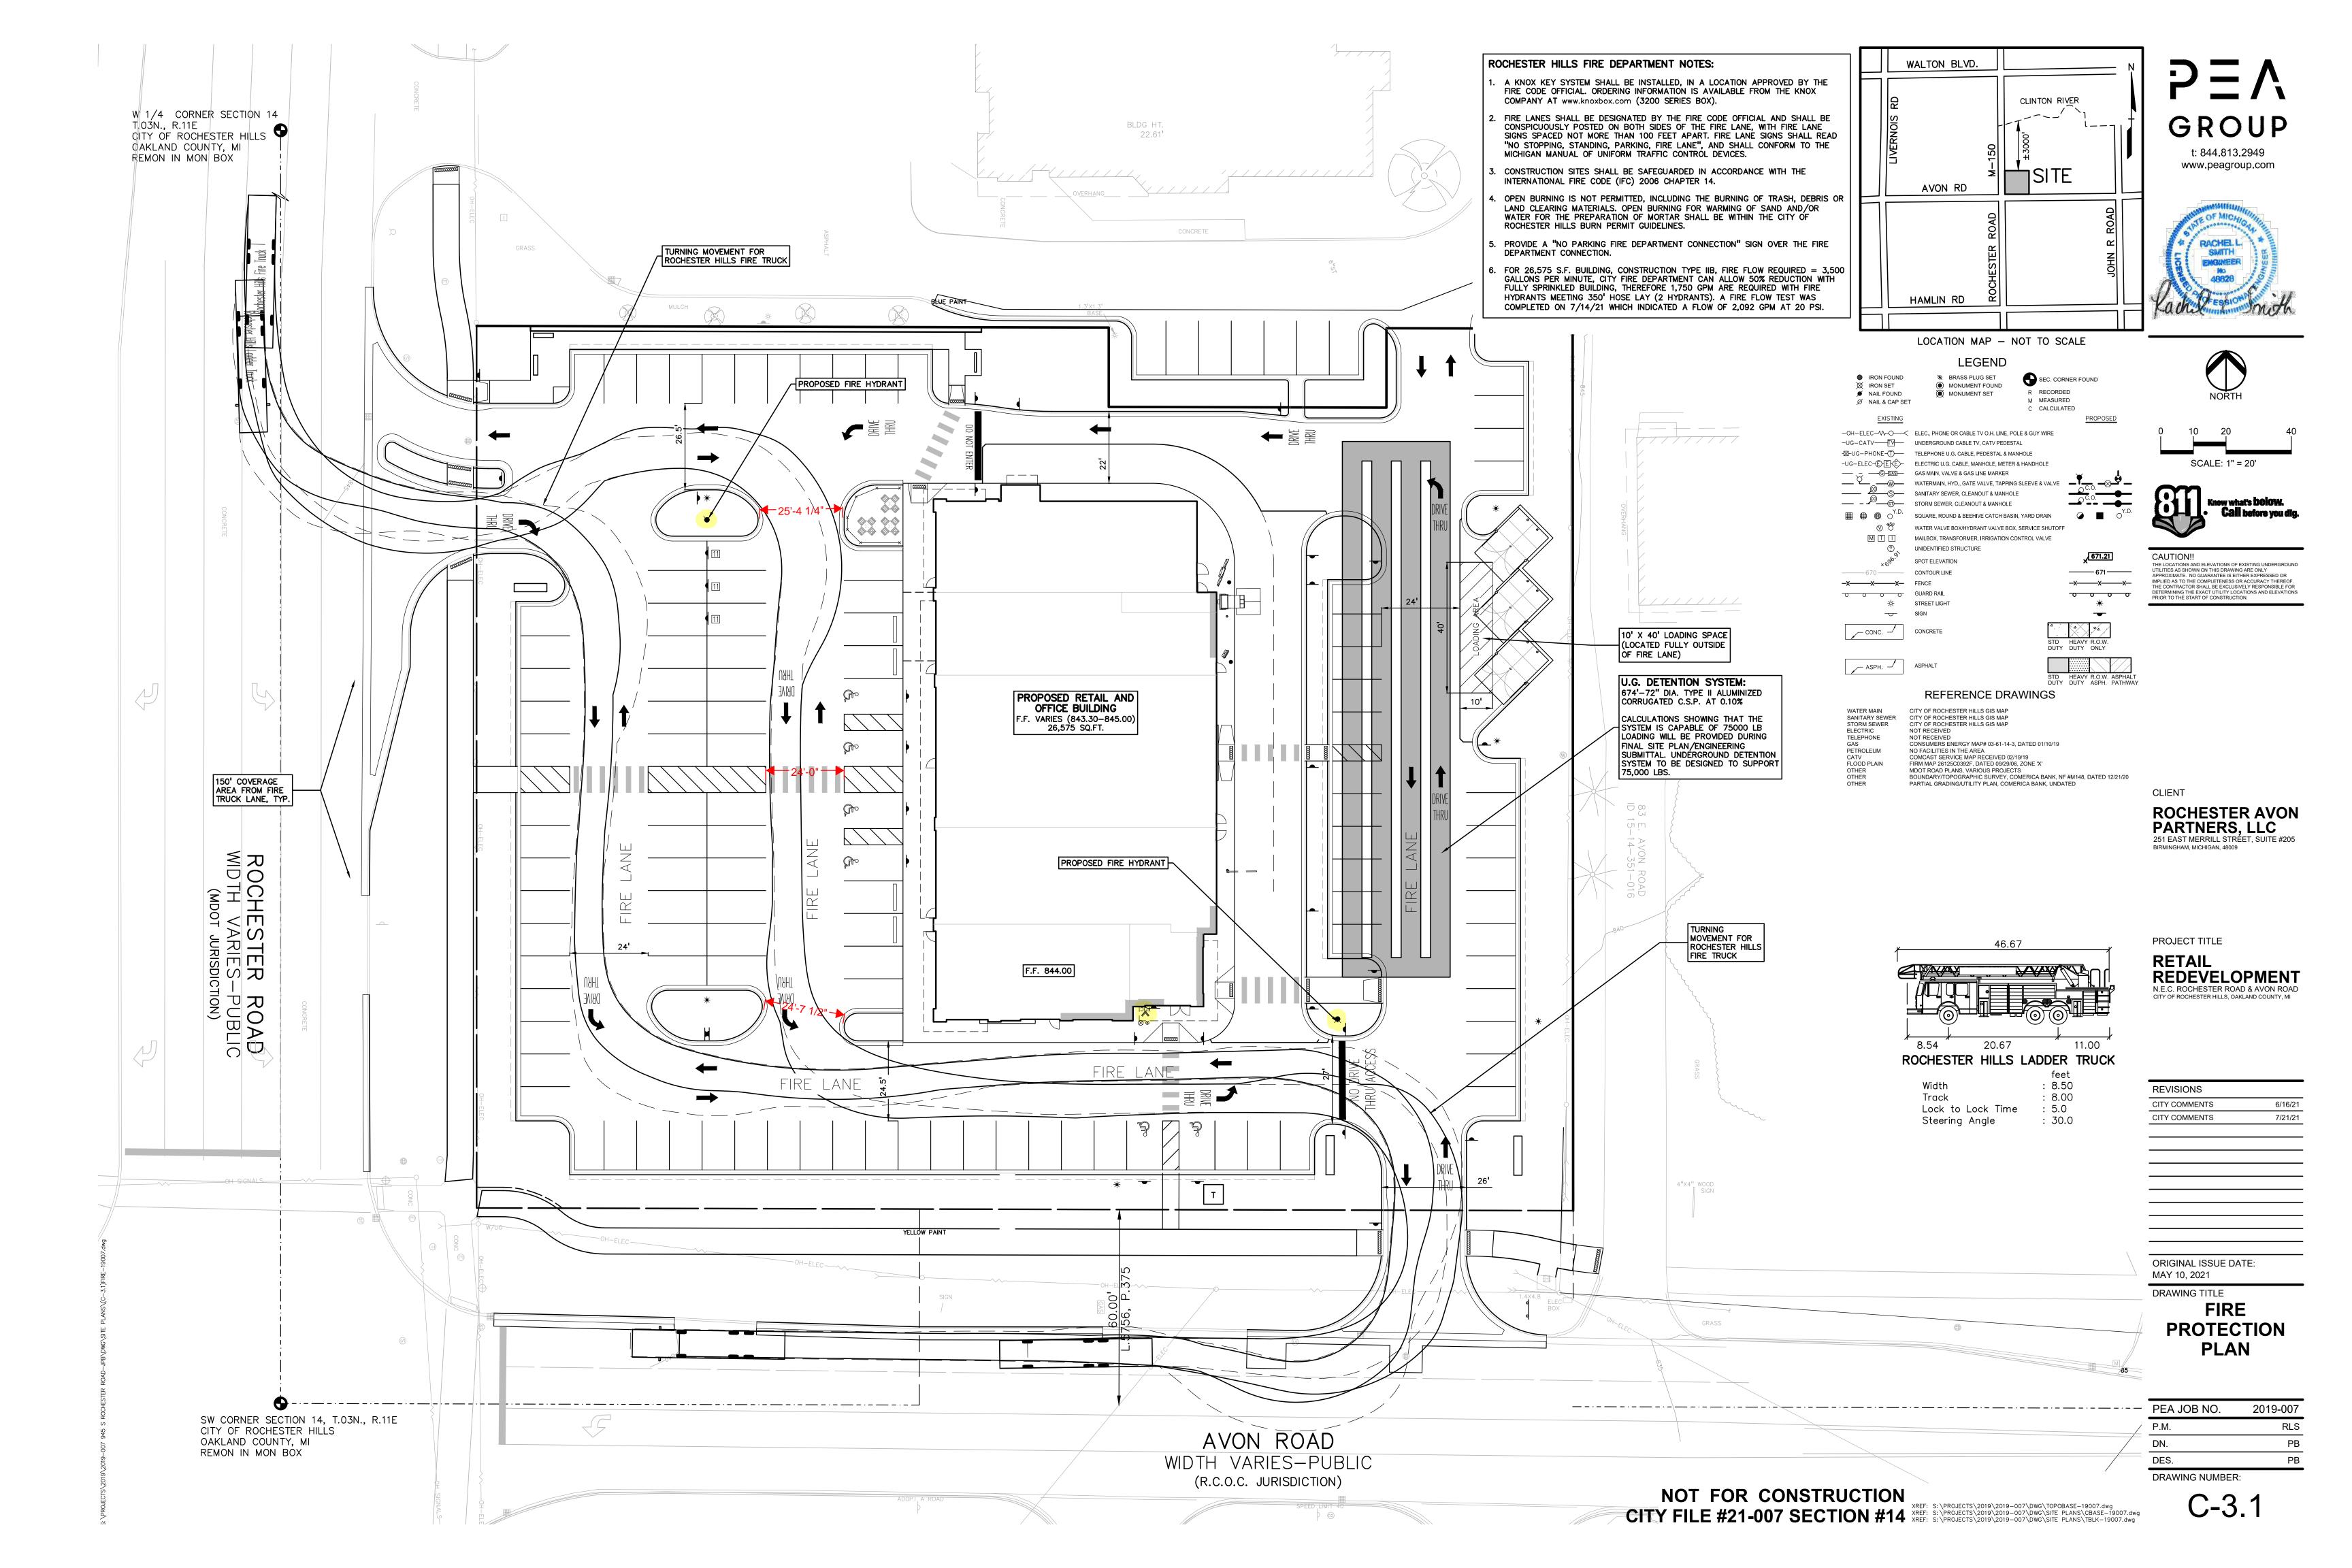

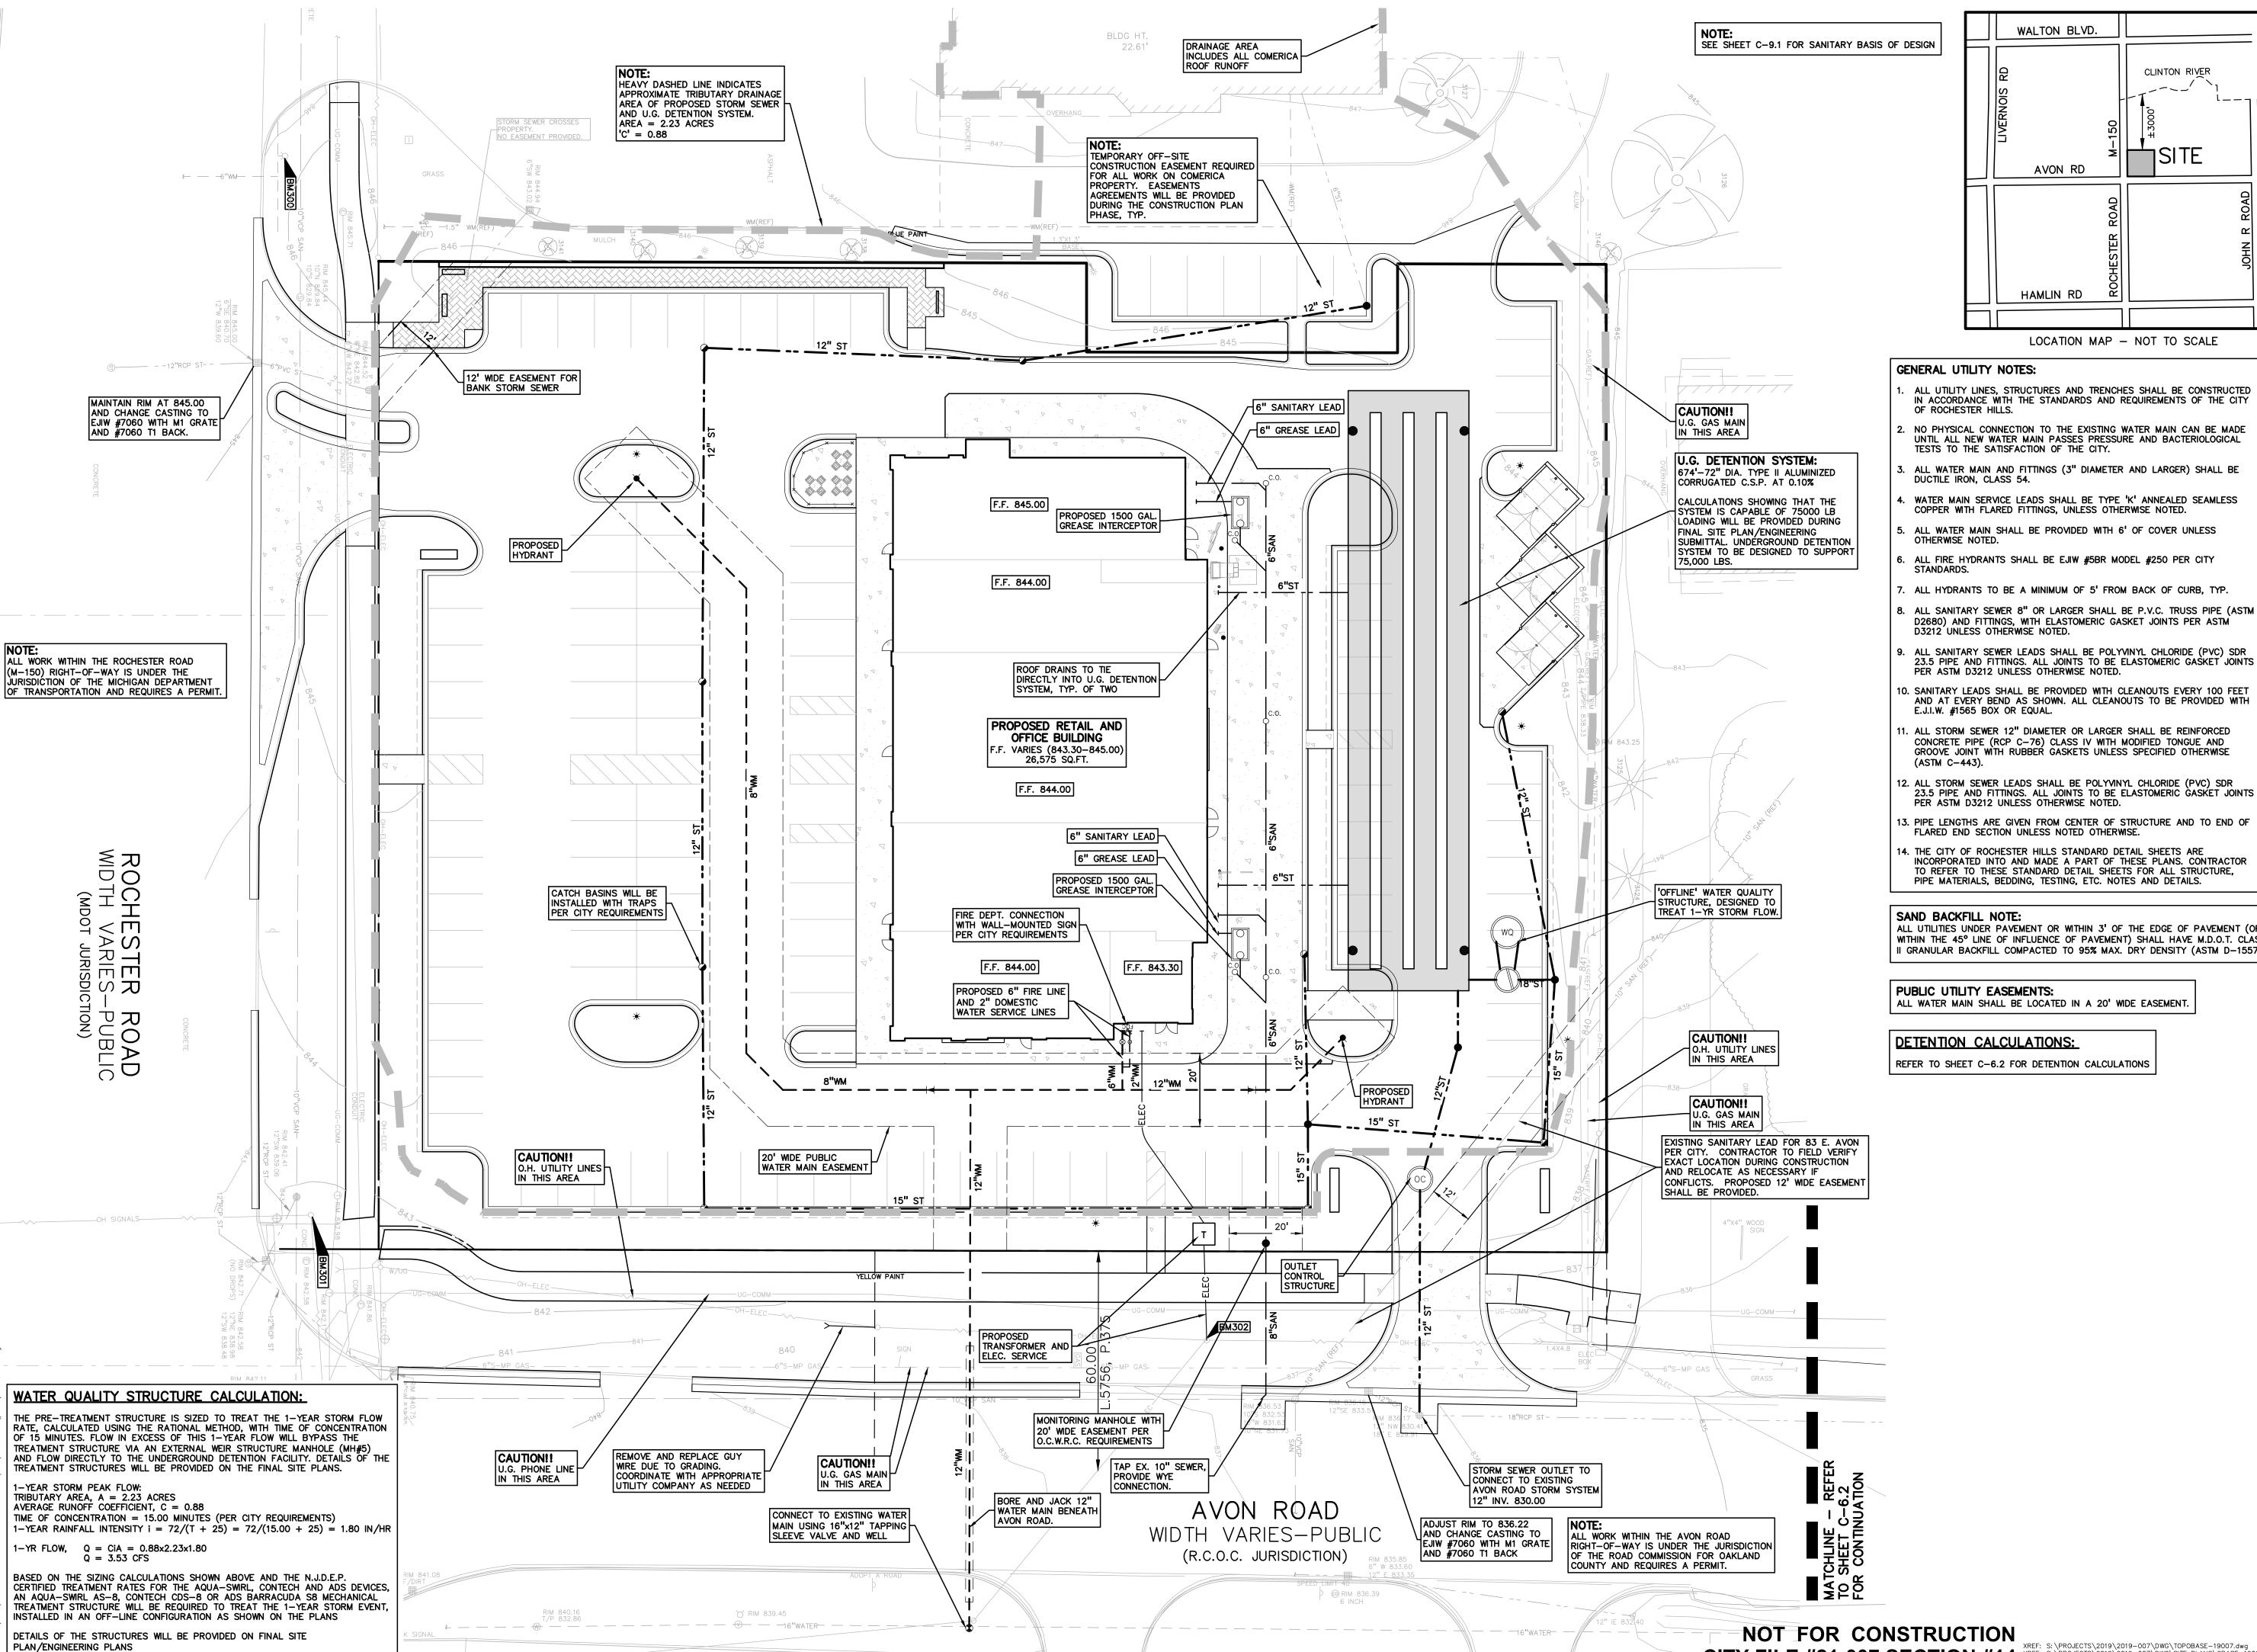

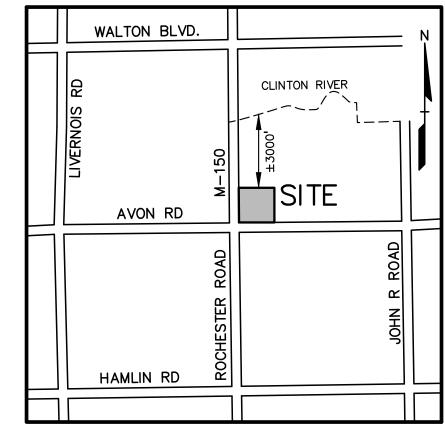

LOCATION MAP - NOT TO SCALE

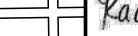

- ALL UTILITY LINES, STRUCTURES AND TRENCHES SHALL BE CONSTRUCTED IN ACCORDANCE WITH THE STANDARDS AND REQUIREMENTS OF THE CITY
- NO PHYSICAL CONNECTION TO THE EXISTING WATER MAIN CAN BE MADE UNTIL ALL NEW WATER MAIN PASSES PRESSURE AND BACTERIOLOGICAL TESTS TO THE SATISFACTION OF THE CITY.
- ALL WATER MAIN AND FITTINGS (3" DIAMETER AND LARGER) SHALL BE DUCTILE IRON, CLASS 54.
- WATER MAIN SERVICE LEADS SHALL BE TYPE 'K' ANNEALED SEAMLESS COPPER WITH FLARED FITTINGS, UNLESS OTHERWISE NOTED.
- ALL WATER MAIN SHALL BE PROVIDED WITH 6' OF COVER UNLESS
- ALL FIRE HYDRANTS SHALL BE EJIW #5BR MODEL #250 PER CITY
- ALL HYDRANTS TO BE A MINIMUM OF 5' FROM BACK OF CURB, TYP.
- 3. ALL SANITARY SEWER 8" OR LARGER SHALL BE P.V.C. TRUSS PIPE (ASTM D2680) AND FITTINGS, WITH ELASTOMERIC GASKET JOINTS PER ASTM D3212 UNLESS OTHERWISE NOTED.
- 3. ALL SANITARY SEWER LEADS SHALL BE POLYVINYL CHLORIDE (PVC) SDR 23.5 PIPE AND FITTINGS. ALL JOINTS TO BE ELASTOMERIC GASKET JOINTS PER ASTM D3212 UNLESS OTHERWISE NOTED.
- 10. SANITARY LEADS SHALL BE PROVIDED WITH CLEANOUTS EVERY 100 FEET
- . ALL STORM SEWER 12" DIAMETER OR LARGER SHALL BE REINFORCED CONCRETE PIPE (RCP C-76) CLASS IV WITH MODIFIED TONGUE AND GROOVE JOINT WITH RUBBER GASKETS UNLESS SPECIFIED OTHERWISE
- 12. ALL STORM SEWER LEADS SHALL BE POLYVINYL CHLORIDE (PVC) SDR 23.5 PIPE AND FITTINGS. ALL JOINTS TO BE ELASTOMERIC GASKET JOINTS
- PER ASTM D3212 UNLESS OTHERWISE NOTED.
- 13. PIPE LENGTHS ARE GIVEN FROM CENTER OF STRUCTURE AND TO END OF FLARED END SECTION UNLESS NOTED OTHERWISE.
- 14. THE CITY OF ROCHESTER HILLS STANDARD DETAIL SHEETS ARE INCORPORATED INTO AND MADE A PART OF THESE PLANS. CONTRACTOR TO REFER TO THESE STANDARD DETAIL SHEETS FOR ALL STRUCTURE. PIPE MATERIALS, BEDDING, TESTING, ETC. NOTES AND DETAILS.

ALL UTILITIES UNDER PAVEMENT OR WITHIN 3' OF THE EDGE OF PAVEMENT (OR WITHIN THE 45° LINE OF INFLUENCE OF PAVEMENT) SHALL HAVE M.D.O.T. CLASS II GRANULAR BACKFILL COMPACTED TO 95% MAX. DRY DENSITY (ASTM D-1557).

PUBLIC UTILITY EASEMENTS:

DETENTION CALCULATIONS:


REFER TO SHEET C-6.2 FOR DETENTION CALCULATIONS



t: 844.813.2949

www.peagroup.com



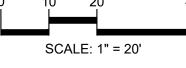



CAUTION!! THE LOCATIONS AND ELEVATIONS OF EXISTING UNDERGR JTILITIES AS SHOWN ON THIS DRAWING ARE ONLY PPROXIMATE. NO GUARANTEE IS EITHER EXPRESSED OR IMPLIED AS TO THE COMPLETENESS OR ACCURACY THEREOF. THE CONTRACTOR SHALL BE EXCLUSIVELY RESPONSIBLE FOR DETERMINING THE EXACT UTILITY LOCATIONS AND ELEVATIONS PRIOR TO THE START OF CONSTRUCTION.

ROCHESTER AVON PARTNERS, LLC 251 EAST MERRILL STREET, SUITE #205 BIRMINGHAM, MICHIGAN, 48009

PROJECT TITLE **RETAIL** REDEVELOPMENT

N.E.C. ROCHESTER ROAD & AVON ROAD

REVISIONS CITY COMMENTS CITY COMMENTS 7/21/21

ORIGINAL ISSUE DATE: MAY 10, 2021

DRAWING TITLE **PRELIMINARY UTILITY PLAN -WEST**


PEA JOB NO. 2019-007 RLS DES. DRAWING NUMBER:

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XREF: S:\PROJECTS\2019\2019-007\DWG\SITE PLANS\TBLK-19007.dwg

SAND BACKFILL NOTE: ALL UTILITIES UNDER PAVEMENT OR WITHIN 3' OF THE EDGE OF PAVEMENT (OR WITHIN THE 45° LINE OF INFLUENCE OF PAVEMENT) SHALL HAVE M.D.O.T. CLASS


II GRANULAR BACKFILL COMPACTED TO 95% MAX. DRY DENSITY (ASTM D-1557).

PUBLIC UTILITY EASEMENTS: ALL WATER MAIN SHALL BE LOCATED IN A 20' WIDE EASEMENT.

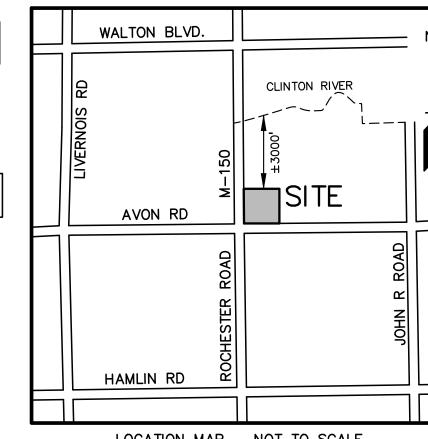





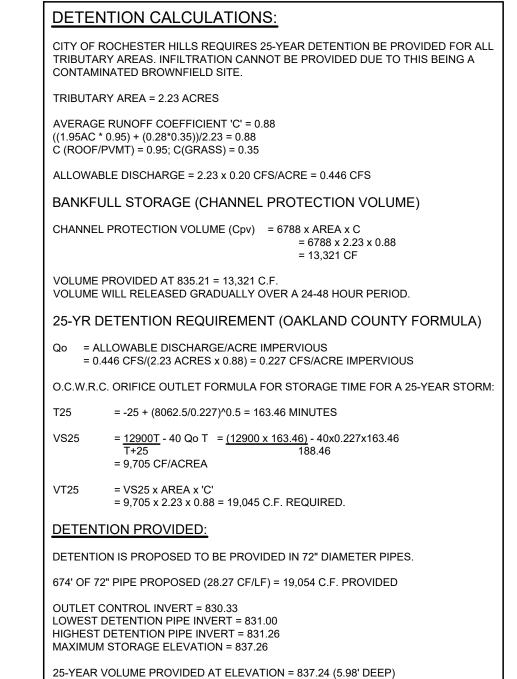

AVERAGE RUNOFF COEFFICIENT 'C' = 0.88 ALLOWABLE OUTLET FLOW (0.20 CFS PER ACRE) = 0.446 CFS 25-YEAR STORAGE VOLUME = 19,045 CF 25-YEAR STORAGE ELEVATION = 837.24 CHANNEL PROTECTION VOLUME = 13,321 CF CHANNEL PROTECTION ELEVATION = 835.21 EXTENDED WATER QUALITY RELEASE: PER CITY REQUIREMENTS, THE CHANNEL PROTECTION VOLUME SHOULD BE DISCHARGED OVER 24 TO 48 HOURS. WHEN SIZING THE OUTLET RESTRICTION, THE AVERAGE FLOW RATE SHOULD ASSUME THE SYSTEM HAS HALF THE Cpv VOLUME STORED (6661 CF). AVERAGE DISCHARGE RATE = 13,321 CF / 36 HOURS = 0.103 C.F.S. STORAGE ELEVATION OF HALF Cpv VOLUME (6661 CF) = 833.54 OUTLET RESTRICTION INVERT = 830.33 HEAD OVER ORIFICE RESTRICTIONS (833.54 - 830.33) = 3.21 FEET ORIFICE FLOW EQUATION, FLOW Q = 0.62 x A x (2g x HEAD OVER ORIFICE)^0.5 WHERE FLOW Q = 0.103 CFS WHERE HEAD H = 3.21 FEET SOLVING FOR AREA OF ORIFICE 'A' = 0.01155 SQ.FT. (1.664 SQ.IN) THEREFORE PROVIDE, ONE (1) 1.5" DIA. HOLE (0.01227 SQ.FT.) AT 830.33

OUTLET RESTRICTION SIZING:

PEAK FLOW RESTRICTION:

Qcpv = 0.160 CFS

TOTAL DRAINAGE AREA FOR NORTH BASIN = 2.23 ACRES

THIS CONDITION IS MET WHEN SYSTEM IS STORING AT THE MAXIMUM ELEVATION OF 837.24: CHANNEL PROTECTION RESTRICTION, 1.5" HOLE AT 830.33 ORIFICE FLOW EQUATION, FLOW Q = 0.62 x A x (2g x HEAD OVER ORIFICE)^0.5 WHERE FLOW A = 0.01227 SQ.FT. WHERE HEAD H = 6.91 FEET

THEREFORE, A SECOND ORIFICE IS REQUIRED TO DISCHARGE THE REMAINDER OF THE ALLOWABLE OUTFLOW (0.446-0.160) 0.286 CFS. THIS SECOND ORIFICE WILL BE INSTALLED AT THE CHANNEL PROTECTION VOLUME STORAGE ELEVATION OF 835.21

A 1.5" DIA. ORIFICE WOULD DE-WATER THE DETENTION SYSTEM IN ±33.8 HOURS (>24 HRS)

DISCHARGE FROM THE SYSTEM CAN NOT EXCEED 0.446 CFS. CALCULATIONS BELOW VERIFY

ORIFICE FLOW EQUATION, FLOW Q = 0.62 x A x (2g x HEAD OVER ORIFICE)^0.5 WHERE FLOW Q = 0.286 CFS (MAX.)

WHERE HEAD H = (837.24-835.21) = 2.03 FEET SOLVING FOR AREA OF ORIFICE 'A' = 0.0403 SQ.FT. (5.810 SQ.IN) THEREFORE PROVIDE, ONE (1) 2.7" DIA. HOLE (0.0398 SQ.FT.) AT 835.21

USING ABOVE ORIFICE EQUATION AND USING THE HEAD 'H' AND AREA 'A' VALUES PROVIDED FOR BOTH SETS OF RESTRICTIONS, GIVES THE MAXIMUM FLOW FROM EACH SET OF ORIFICES:

MAX. OUTLET FLOW FROM Cpv RESTRICTION = 0.160 CFS MAX. OUTLET FLOW FROM 25-YEAR RESTRICTION = 0.282 CFS

COMBINED MAXIMUM OUTLET FLOW (0.160 + 0.282) = 0.442 CFS (LESS THAN 0.446 ALLOWABLE) **REFER TO OUTLET CONTROL DETAIL ON SHEET C-9.3 FOR ADDITIONAL DETAILS**



CAUTION!! THE LOCATIONS AND ELEVATIONS OF EXISTING UNDERGROU UTILITIES AS SHOWN ON THIS DRAWING ARE ONLY APPROXIMATE. NO GUARANTEE IS EITHER EXPRESSED OR IMPLIED AS TO THE COMPLETENESS OR ACCURACY THEREOF. THE CONTRACTOR SHALL BE EXCLUSIVELY RESPONSIBLE FOR DETERMINING THE EXACT UTILITY LOCATIONS AND ELEVATIONS PRIOR TO THE START OF CONSTRUCTION.

CLIENT

ROCHESTER AVON PARTNERS, LLC 251 EAST MERRILL STRÉET, SUITE #205

PROJECT TITLE

REVISIONS

CITY COMMENTS

RETAIL REDEVELOPMENT N.E.C. ROCHESTER ROAD & AVON ROAD

CITY COMMENTS	7/21/2
ORIGINAL ISSUE DATE: MAY 10, 2021	
DRAWING TITLE	

PRELIMINARY UTILITY PLAN -EAST

EA JOB NO.	2019-007
M.	RLS
٧.	ВА
ES.	РВ
RAWING NUMBER:	

GENERAL NOTES:

THESE NOTES APPLY TO ALL CONSTRUCTION ACTIVITIES ON THIS PROJECT.


- ALL CONSTRUCTION, WORKMANSHIP AND MATERIALS SHALL BE IN ACCORDANCE WITH CURRENT OSHA, MDOT AND MUNICIPALITY STANDARDS AND REGULATIONS.
- THE CONTRACTOR SHALL NOTIFY THE CITY ENGINEER AND/OR THE AUTHORITY HAVING JURISDICTION 3 BUSINESS DAYS PRIOR TO THE BEGINNING OF CONSTRUCTION.
- THE CONTRACTOR MUST CONTACT THE ENGINEER SHOULD THEY ENCOUNTER ANY DESIGN ISSUES DURING CONSTRUCTION. IF THE CONTRACTOR MAKES DESIGN MODIFICATIONS WITHOUT THE WRITTEN DIRECTION OF THE DESIGN ENGINEER, THE CONTRACTOR DOES SO AT HIS OWN RISK.
- ALL NECESSARY PERMITS, TESTING, BONDS AND INSURANCES ETC., SHALL BE PAID FOR BY THE CONTRACTOR. THE OWNER SHALL PAY FOR ALL CITY INSPECTION FEES.
- THE CONTRACTOR SHALL NOTIFY THE APPROPRIATE 811/ONE CALL UTILITY LOCATING CENTER, THE CITY ENGINEER AND/OR THE AUTHORITY HAVING JURISDICTION 3 BUSINESS DAYS PRIOR TO THE BEGINNING OF CONSTRUCTION, IF NO NOTIFICATION IS GIVEN AND DAMAGE RESULTS. SAID DAMAGE WILL BE REPAIRED AT SOLE EXPENSE OF THE CONTRACTOR. IF EXISTING UTILITY LINES ARE ENCOUNTERED THAT CONFLICT IN LOCATION WITH NEW CONSTRUCTION, THE CONTRACTOR SHALL NOTIFY THE DESIGN ENGINEER SO THAT THE CONFLICT MAY BE RESOLVED.
- CONTRACTOR TO VERIFY THAT THE PLANS AND SPECIFICATIONS ARE THE VERY LATEST PLANS AND SPECIFICATIONS AND FURTHERMORE. VERIFY THAT THESE PLANS AND SPECIFICATIONS HAVE BEEN APPROVED. ALL ITEMS CONSTRUCTED BY THE CONTRACTOR PRIOR TO RECEIVING FINAL APPROVAL, HAVING TO BE ADJUSTED OR RE-DONE SHALL BE AT THE CONTRACTORS EXPENSE. SHOULD THE CONTRACTOR ENCOUNTER A CONFLICT BETWEEN THESE PLANS AND/OR SPECIFICATIONS, THEY SHALL SEEK CLARIFICATION IN WRITING FROM THE ENGINEER BEFORE COMMENCEMENT OF CONSTRUCTION. FAILURE TO DO SO SHALL BE AT SOLE EXPENSE TO THE CONTRACTOR
- ANY WORK WITHIN THE STREET OR HIGHWAY RIGHTS-OF-WAY SHALL BE PERFORMED IN ACCORDANCE WITH THE REQUIREMENTS OF THE AGENCIES HAVING JURISDICTION AND SHALL NOT BEGIN UNTIL ALL NECESSARY PERMITS HAVE BEEN ISSUED FOR THE WORK.
- ALL PROPERTIES OR FACILITIES IN THE SURROUNDING AREAS, PUBLIC OR PRIVATE, DESTROYED OR OTHERWISE DISTURBED DUE TO CONSTRUCTION, SHALL BE REPLACED AND/OR RESTORED TO THE ORIGINAL CONDITION BY THE
- PROTECT THE WORK AND SAFELY MAINTAIN TRAFFIC IN ACCORDANCE WITH LOCAL REQUIREMENTS AND THE MANUAL OF UNIFORM TRAFFIC CONTROL DEVICES (LATEST EDITION). THE DESIGN ENGINEER, OWNER, CITY AND STATE SHALL NOT BE HELD LIABLE FOR ANY CLAIMS RESULTING FROM ACCIDENTS OR DAMAGES CAUSED BY THE CONTRACTOR'S FAILURE TO COMPLY WITH TRAFFIC AND PUBLIC SAFETY REGULATIONS DURING THE CONSTRUCTION PERIOD.
- 10. IT SHALL BE THE RESPONSIBILITY OF THE CONTRACTOR TO ADJUST THE TOP OF ALL EXISTING AND PROPOSED STRUCTURES (MANHOLES, CATCH BASINS, INLETS, GATE WELLS ETC.) WITHIN GRADED AND /OR PAVED AREAS TO FINAL GRADE SHOWN ON THE PLANS. ALL SUCH ADJUSTMENTS SHALL BE INCIDENTAL TO THE JOB AND WILL NOT BE PAID FOR SEPARATELY.

PAVING NOTES:

- IN AREAS WHERE NEW PAVEMENTS ARE BEING CONSTRUCTED, THE TOPSOIL AND SOIL CONTAINING ORGANIC MATTER SHALL BE REMOVED PRIOR TO PAVEMENT CONSTRUCTION.
- . PROVIDE EXPANSION JOINTS AND JOINT SEALANT AT TWO "END-OF-RADIUS" LOCATIONS (OPPOSITE SIDES AT EACH LONG END) OF CONCRETE CURB ISLANDS.
- 5. REFER TO ARCHITECTURAL PLANS FOR DETAILS OF FROST SLAB AT EXTERIOR BUILDING DOORS.
- CONSTRUCTION TRAFFIC SHOULD BE MINIMIZED ON THE NEW PAVEMENT. IF CONSTRUCTION TRAFFIC IS ANTICIPATED ON THE PAVEMENT STRUCTURE, THE INITIAL LIFT THICKNESS COULD BE INCREASED AND PLACEMENT OF THE FINAL LIFT COULD BE DELAYED UNTIL THE MAJORITY OF THE CONSTRUCTION ACTIVITIES HAVE BEEN COMPLETED. THIS ACTION WILL ALLOW REPAIR OF LOCALIZED FAILURE, IF ANY DOES OCCUR, AS WELL AS REDUCE LOAD DAMAGE ON THE
- CONCRETE PAVEMENT JOINTING UNLESS SHOWN OTHERWISE IN THE PLANS OR REQUIRED BY THE AUTHORITY HAVING JURISDICTION:
- 5.1. WHERE PROPOSED CONCRETE ABUTS A STRUCTURE PROVIDE A MINIMUM 1/2" EXPANSION JOINT WITH SEALANT, THE JOINT FILLER BOARD MUST BE AT LEAST THE FULL DEPTH OF THE CONCRETE AND HELD DOWN A 1/2 INCH TO
- ALLOW FOR SEALING 5.2. WHERE PROPOSED CONCRETE ABUTS EXISTING CONCRETE OR IN BETWEEN POURS OF PROPOSED CONCRETE (CONSTRUCTION JOINT) PROVIDE 5/8" DOWELS EVERY 30" CENTER TO CENTER HALF WAY ALONG THE THICKNESS OF THE PROPOSED PAVEMENT. ALTERNATE DOWELS SIZES AND SPACING MUST BE APPROVED THE ENGINEER PRIOR TO COMMENCING WORK AND VIA THE SUBMITTAL PROCESS.
- 5.3. WHERE PROPOSED CONCRETE ABUTS EXISTING OR PROPOSED SIDEWALK PROVIDE A MINIMUM 1/2" EXPANSION JOINT WITH SEALANT
- 5.4. WHERE PROPOSED CONCRETE ABUTS EXISTING OR PROPOSED CURBING PROVIDE A MINIMUM 1/2" EXPANSION JOINT WITH SEALANT
- 5.5. CONTROL, LONGITUDINAL AND/OR TRANSVERSE JOINTS SHALL BE PLACED TO PROVIDE PANELS WITHIN THE PAVEMENT AS SQUARE AS POSSIBLE WITH THE FOLLOWING MAXIMUM SPACING PARAMETERS; 5.5.1. 6-INCH THICK CONCRETE PAVEMENT: 12' X 12'
- 5.5.2. 8-INCH THICK CONCRETE PAVEMENT: 15' X 15' 5.6. IRREGULAR-SHAPED PANELS MAY REQUIRE THE USE OF REINFORCING MESH OR FIBER MESH AS DETERMINED BY
- THE ENGINEER. THE USE OF MESH MUST BE APPROVED THE ENGINEER PRIOR TO COMMENCING WORK AND VIA THE SUBMITTAL PROCESS. IF A JOINT PLAN IS NOT PROVIDED IN THE PLANS, THE CONTRACTOR SHALL SUBMIT ONE TO THE ENGINEER FOR REVIEW PRIOR TO COMMENCING WORK AND VIA THE SUBMITTAL PROCESS.
- . CONCRETE CURBING JOINTING UNLESS SHOWN OTHERWISE IN THE PLANS OR REQUIRED BY THE AUTHORITY HAVING
- 6.1. WHERE PROPOSED CONCRETE CURBING ABUTS A STRUCTURE PROVIDE A MINIMUM 1/2" EXPANSION JOINT WITH SFALANT
- 6.2. WHERE PROPOSED CONCRETE ABUTS EXISTING OR PROPOSED SIDEWALK PROVIDE A MINIMUM 1/2" EXPANSION JOINT WITH SEALANT
- 6.3. WHERE PROPOSED CONCRETE ABUTS EXISTING CURBING PROVIDE A MINIMUM 1/2" EXPANSION JOINT WITH SEALANT 6.4. IN BETWEEN POURS OF PROPOSED CONCRETE CURBING (CONSTRUCTION JOINT) CARRY THE REBAR CONTINUOUSLY BETWEEN POURS
- IF THE REBAR IS NOT LONG ENOUGH TO CARRY CONTINUOUSLY THEN TIE TWO PIECES OF REBAR PER THE
- LATEST MDOT SPECIFICATIONS 6.5. CONTROL JOINTS SHALL BE PLACED A MAXIMUM 10' CENTER TO CENTER AND AT ALL RADIUS RETURNS

GENERAL GRADING AND EARTHWORK NOTES:

- THESE NOTES APPLY TO ALL CONSTRUCTION ACTIVITIES ON THIS PROJECT
- CONTRACTOR TO FIELD VERIFY ALL EXISTING TREES AND BRUSH AND REMOVE ALL THAT ARE NECESSARY TO GRADE
- . ALL GRADES ARE TO TOP OF PAVEMENT UNLESS OTHERWISE NOTED.
- THE STAGING OF CONSTRUCTION ACTIVITIES SHALL OCCUR ONLY WITHIN THE SITE BOUNDARIES. ANY CONSTRUCTION ACTIVITIES OUTSIDE OF THE SITE BOUNDARIES SHALL BE AT THE SOLE RESPONSIBILITY AND RISK OF THE
- ALL SOIL EROSION AND SEDIMENTATION CONTROL MEASURES SHALL MEET THE REQUIREMENTS OF THE AUTHORIZED PUBLIC AGENCY OF JURISDICTION. AN EROSION CONTROL PERMIT MUST BE SECURED FROM OAKLAND COUNTY PRIOR
- . ALL EARTHWORK AND GRADING OPERATIONS SHALL BE PERFORMED IN ACCORDANCE WITH THE SOILS INVESTIGATION AND REPORT.
- REFER TO SOIL EROSION CONTROL PLAN FOR ADDITIONAL SOIL EROSION AND SEDIMENTATION CONTROL MEASURES AND NOTES (WILL BE PART OF FINAL SITE PLAN/ENGINEERING PLANS).
- ALL SLOPES EXCEEDING 1:6 MUST BE STABILIZED BY SODDING OR BY PLACING A MULCH BLANKET PEGGED IN PLACE OVER SEED.
- ALL DISTURBED AREAS SHALL BE SEEDED AND MULCHED OR SODDED IN ACCORDANCE WITH THE LANDSCAPE PLANS. PROVIDE A MINIMUM OF 4" OF TOPSOIL IN THESE AREAS UNLESS OTHERWISE NOTED.
- . THE CONTRACTOR SHALL NOTE EXISTING UNDERGROUND UTILITIES WITHIN AND ADJACENT TO THE SITE. BACKFILL FOR EXISTING UTILITY TRENCHES SHALL BE EXAMINED CRITICALLY. ANY TRENCHES FOUND TO HAVE SOFT, UNSTABLE OR UNSUITABLE BACKFILL MATERIAL, IN THE OPINION OF THE THIRD PARTY TESTING COMPANY. THAT ARE TO BE WITHIN THE ZONE OF INFLUENCE OF PROPOSED BUILDINGS OR PAVEMENT SHALL BE COMPLETELY EXCAVATED AND BACKFILLED WITH SUITABLE MATERIAL.
- 10. ON-SITE FILL CAN BE USED IF THE SPECIFIED COMPACTION REQUIREMENTS CAN BE ACHIEVED. IF ON-SITE SOIL IS USED, IT SHOULD BE CLEAN AND FREE OF FROZEN SOIL, ORGANICS, OR OTHER DELETERIOUS MATERIALS.
- 11. THE FINAL SUBGRADE/EXISTING AGGREGATE BASE SHOULD BE THOROUGHLY PROOFROLLED USING A FULLY LOADED TANDEM AXLE TRUCK OR FRONT END LOADER UNDER THE OBSERVATION OF A GEOTECHNICAL/PAVEMENT ENGINEER. LOOSE OR YIELDING AREAS THAT CANNOT BE MECHANICALLY STABILIZED SHOULD BE REINFORCED USING GEOGRIDS OR REMOVED AND REPLACED WITH ENGINEERED FILL OR AS DICTATED BY FIELD CONDITIONS.
- 12. SUBGRADE UNDERCUTTING, INCLUDING BACKFILLING SHALL BE PERFORMED TO REPLACE MATERIALS SUSCEPTIBLE TO FROST HEAVING AND UNSTABLE SOIL CONDITIONS. ANY EXCAVATIONS THAT MAY BE REQUIRED BELOW THE TOPSOIL IN FILL AREAS OR BELOW SUBGRADE IN CUT AREAS WILL BE CLASSIFIED AS SUBGRADE UNDERCUTTING.
- 13. SUBGRADE UNDERCUTTING SHALL BE PERFORMED WHERE NECESSARY AND THE EXCAVATED MATERIAL SHALL BECOME THE PROPERTY OF THE CONTRACTOR. ANY SUBGRADE UNDERCUTTING SHALL BE BACKFILLED AS RECOMMENDED IN THE GEOTECHNICAL ENGINEERING REPORT FOR THE PROJECT.
- 14. ANY SUB-GRADE WATERING REQUIRED TO ACHIEVE REQUIRED DENSITY SHALL BE CONSIDERED INCIDENTAL TO THE

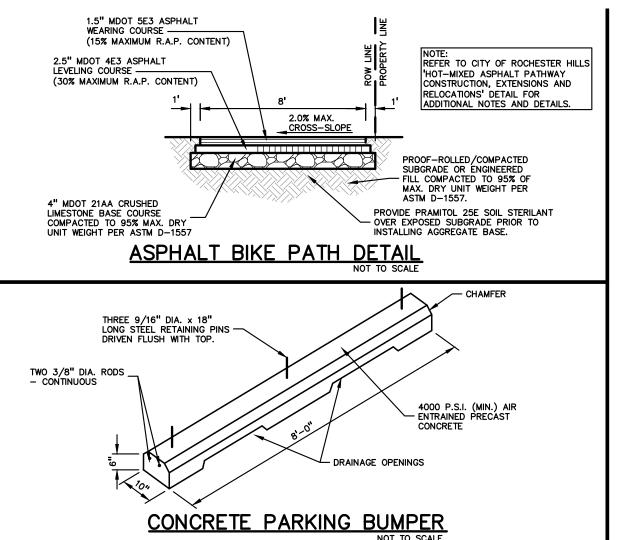

PROPOSED SANITARY SEWER BASIS OF DESIGN

Square Footage

Population (P) (2.44 PEOPLE/EDU)

Population (P) (2.44 PEOPLE/EDU)

Population (P) (2.44 PEOPLE/EDU)

Quick Service Restaurants

Unit Factor

Unit Factor

Number of units

Unit Factor

TOTAL

Retail

(Unit Factors Based on Oakland County Unit Assignment Factors)

Average Flow (100 GPCPD)

PF = (18+sqrt(P))/(4+sqrt(P))

Peaking Factor (PF)

Peak Flow (G.D.P.)

Peak Flow (C.F.S.)

P (1000s)

6" Pipe Capacity Provided 0.665 C.F.S.

10,943 S.F.

4.4

6,330

10.7 People

0.04 per 1000 s

0.6 People

1 per unit

4.9 People

16 People

1,618 G.P.D.

0.003 C.F.S.


7,106 G.P.D.


0.011 C.F.S.


0.016

4.39

0.4 per 1000 st

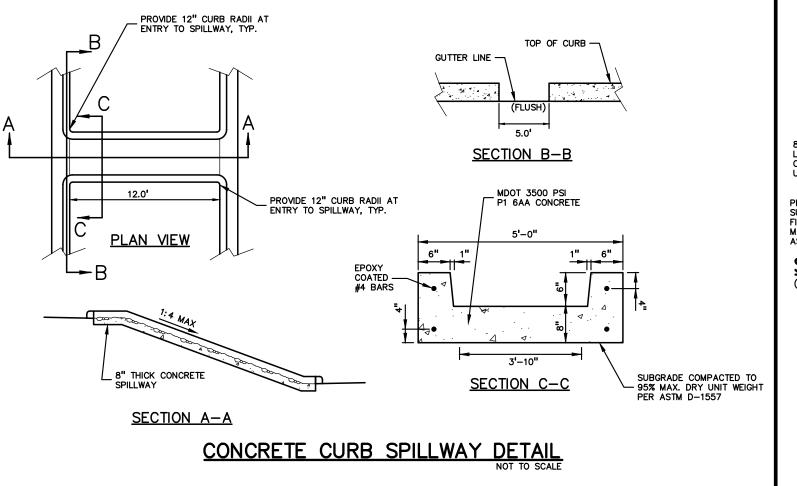

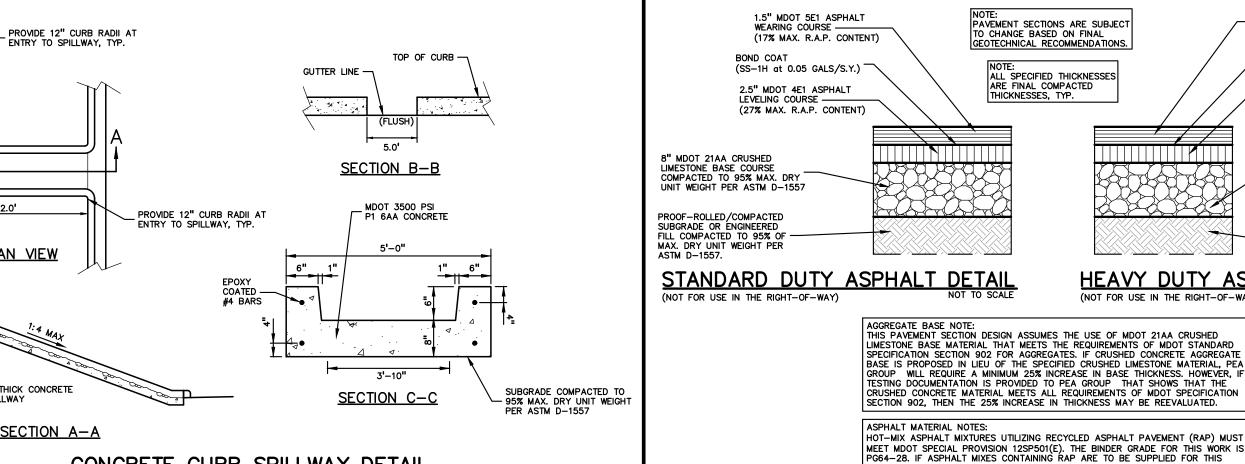

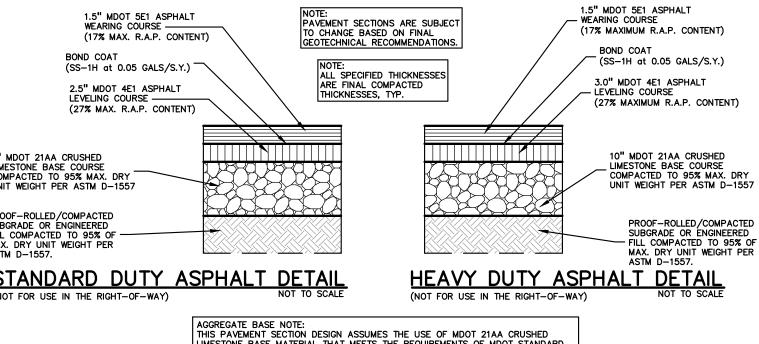

PROJECT, THE ASPHALT BINDER MUST BE REVISED PER MDOT 'TIER 1' OR 'TIER 2

REQUIREMENTS (RAP CONTENT UP TO 27% MAXIMUM). TIER 3 MIXES ARE NOT ACCEPTABLE ON THIS PROJECT. AN ASPHALT MIX DESIGN FOR ALL SPECIFIED MIXES SHOULD BE FORWARDED TO PEA GROUP FOR REVIEW PRIOR TO CONSTRUCTION



CAUTIONII

THE LOCATIONS AND ELEVATIONS OF EXISTING UNDERG TILITIES AS SHOWN ON THIS DRAWING ARE ONLY

PRIOR TO THE START OF CONSTRUCTION.


BIRMINGHAM, MICHIGAN, 48009

PROXIMATE. NO GUARANTEE IS EITHER EXPRESSED OR

MPLIED AS TO THE COMPLETENESS OR ACCURACY THEREO

ERMINING THE EXACT UTILITY LOCATIONS AND ELEVATION



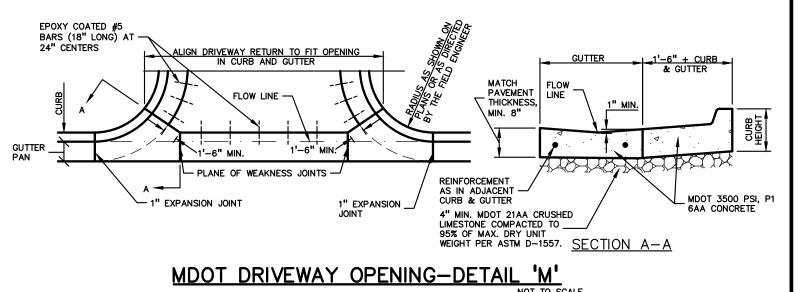

6" DIAMETER SCH 40 STEEL PIPE FILLED

PAVEMENT

THICKEN ASPHALT EDGE TO MATCH CONCRETE PAVEMENT SECTION THICKNESS

 $\triangle \triangleleft$

CONCRETE PAVEMENT

ENGINEERED FILL COMPACTED TO 95% OF MAX. DRY UNIT WEIGHT PER ASTM D-1557.

PROOF-ROLLED/COMPACTED

MAX. DRY UNIT WEIGHT PER

ILL COMPACTED TO 95% OF

18" DIA, CONC. BASE

WAY THROUGH PIPE

SUBGRADE OR ENGINEERED

W/CONC. PAINT WITH
REFLECTIVE YELLOW PAINT
OR PROVIDE YELLOW
HDPE GUARD POST COVER

1" WASH

6" DIA. GUARD POST DETAIL

-MA-MA

REDUCED ASPHALT THICKNESS

TO TYPICAL PAVEMENT SECTION
USING A 5' TRANSITION

ASPHALT THICKENED

SECTION (MULTIPLE LIFTS DEPENDANT O

THICKENED EDGE ASPHALT DETAIL

MIX AND THICKNESS


ASPHALT WEARING


ASPHALT LEVELING COURSE


REFER TO DETAIL ON - THIS SHEET FOR TYPICAL

AGGREGATE BASE COURSE COMPACTED TO 95% MAX. DRY UNIT WEIGHT PER ASTM D-155


PAVEMENT SECTION

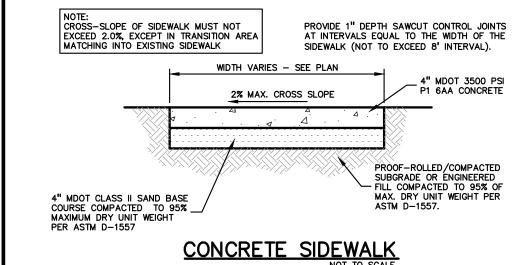


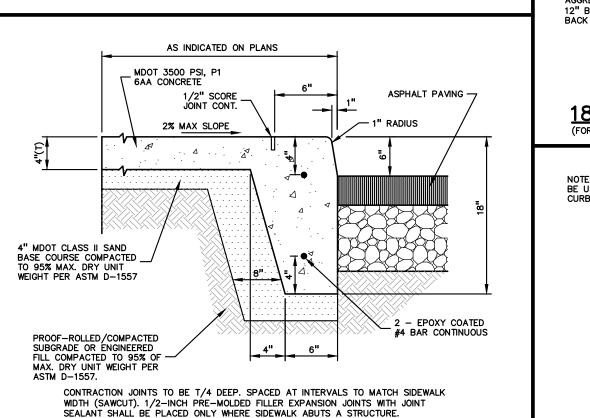


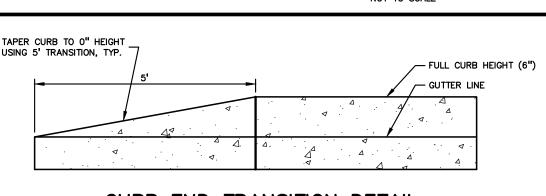



INTEGRAL CURB AND SIDEWALK

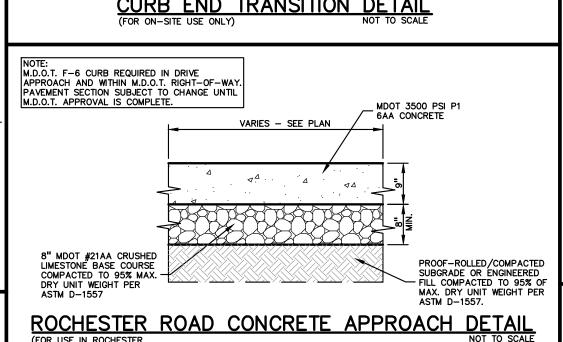


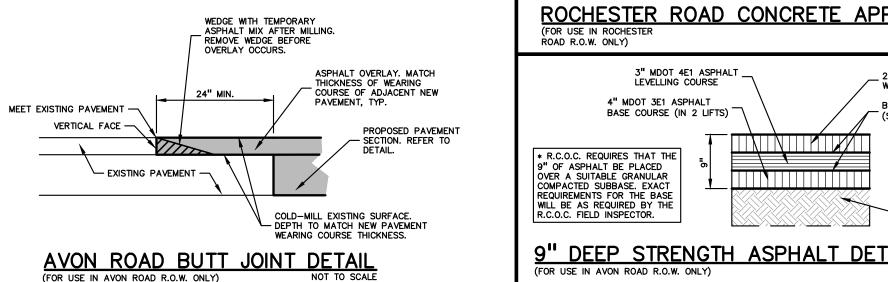

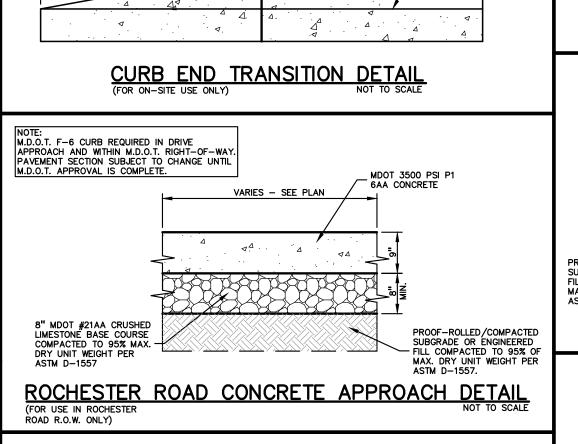


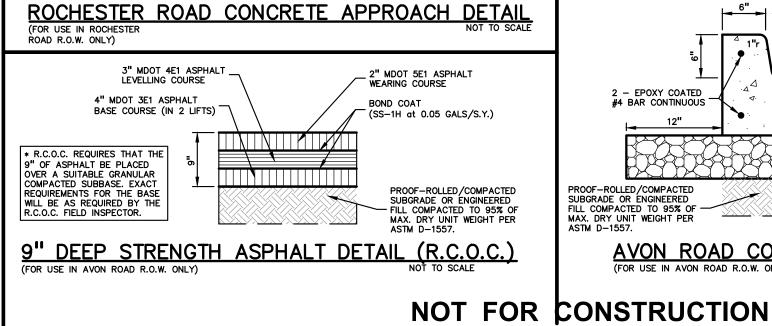


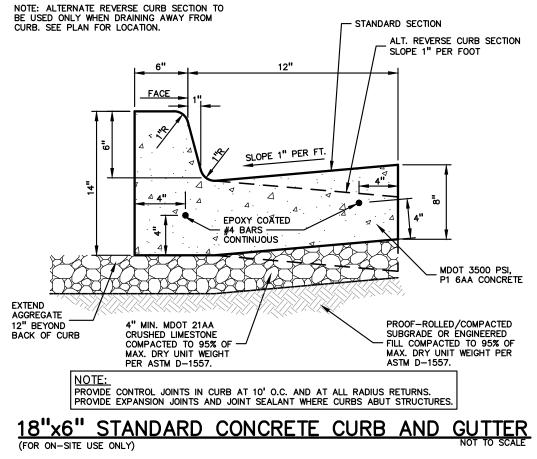


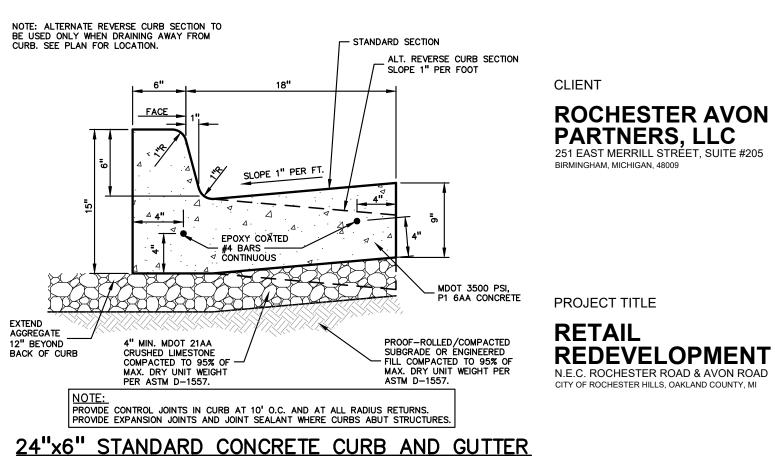

(FOR USE IN AVON ROAD R.O.W. ONLY

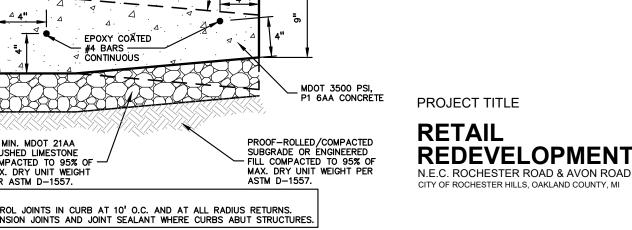

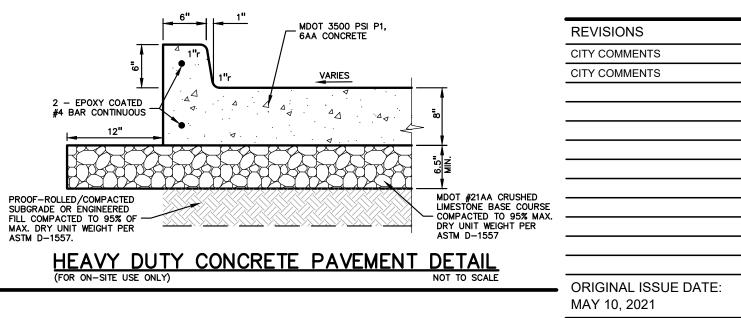

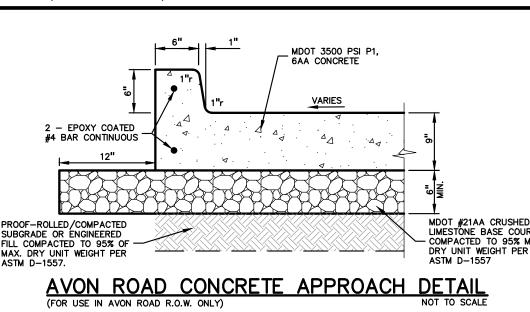

CITY FILE #21-007 SECTION #14 XREF: S: \PROJECTS\2019\2019\-007\DWG\SITE PLANS\CBASE-19007.dwg

XREF: S: \PROJECTS\2019\2019\-007\DWG\SITE PLANS\CBASE-19007.dwg

XREF: S: \PROJECTS\2019\2019\-007\DWG\SITE PLANS\TBLK-19007.dwg



6/16/21

7/21/21

PEA JOB NO.	2019-007
P.M.	RLS
DN.	ВА
DES.	РВ
DRAWING NUMBER:	

GENERAL BARRIER FREE NOTES:

- THE FOLLOWING NOTES PROVIDE AN OUTLINE OF SOME OF THE REQUIREMENTS CONTAINED WITHIN THE "STANDARDS FOR ACCESSIBLE DESIGN - AMERICANS WITH DISABILITIES ACT 2010", AND "ACCESSIBLE AND USEABLE BUILDINGS AND FACILITIES", ICC/ANSI A117.1-2009. THE CONTRACTOR IS RESPONSIBLE FOR ALL OF THE REQUIREMENTS PRESENTED WITHIN THESE DOCUMENTS, WHICH ARE AVAILABLE IN FULL UPON REQUEST.
- 1. AN ACCESSIBLE ROUTE CONSISTS OF WALK SURFACES, CURB RAMPS AND RAMPS. AT LEAST ONE ACCESSIBLE ROUTE SHALL BE PROVIDED WITHIN THE SITE FROM ACCESSIBLE PARKING SPACES, ACCESSIBLE PASSENGER LOADING ZONES, PUBLIC STREETS AND SIDEWALKS, AND PUBLIC TRANSPORTATION STOPS TO THE BUILDING OR FACILITY ENTRANCE THEY SERVE. 2. THE RUNNING SLOPE OF ALL WALKING SURFACES SHALL NOT EXCEED 5% (1:20) AND THE CROSS-SLOPE SHALL NOT EXCEED
- 3. WALKING SURFACES MUST BE LEVEL WITH PERMITTED VERTICAL CHANGES IN LEVEL NOT TO EXCEED 1/4", OR BEVELED CHANGES IN LEVEL NOT TO EXCEED 1/2". REFER TO DETAIL ON THIS SHEET. ANY CHANGE IN LEVEL GREATER THAN 1/2"
- 4. TURNING SPACES ALONG ACCESSIBLE ROUTES MUST BE AT LEAST 5 FEET WIDE IN ALL DIRECTIONS AND NOT EXCEED 2% SLOPE (1:48) IN ANY DIRECTION.
- 5. ACCESSIBLE ROUTES WILL BE DESIGNED TO BE A MINIMUM OF 5 FEET WIDE. THE MINIMUM CLEAR WIDTH IS 3 FEET. 6. RAMPS ALONG ACCESSIBLE ROUTES WILL HAVE A RUNNING SLOPE GREATER THAN 5% (1:20) AND LESS THAN 8.3% (1:12).
- 7. THE CROSS-SLOPE OF RAMP RUNS SHALL NOT EXCEED 2% (1:48) 8. THE MINIMUM CLEAR WIDTH OF ANY RAMP IS 36 INCHES.
- 9. THE MAXIMUM RISE FOR ANY RAMP (NOT INCLUDING CURB RAMPS) SHALL NOT EXCEED 30 INCHES. LANDINGS ARE REQUIRED AT THE TOP AND BOTTOM OF EACH RAMP. LANDINGS SHALL HAVE A CROSS-SLOPE NOT EXCEEDING 2% (1:48), SHALL BE 5 FEET LONG AND AT LEAST AS WIDE AS THE RAMP CLEAR WIDTH. IF THERE IS A CHANGE OF DIRECTION AT A LANDING, THEN THE LANDING MUST BE AT LEAST 5 FEET WIDE AND 5 FEET LONG.
- 10. HANDRAILS ARE REQUIRED FOR ANY RAMP (NOT INCLUDING CURB RAMPS) WITH A RISE GREATER THAN 6 INCHES. ALL HANDRAILS ARE REQUIRED TO HAVE EDGE PROTECTION UNLESS ADJOINING ANOTHER ACCESS POINT OR IF THE VERTICAL DROP-OFF AT THE EDGE OF THE RAMP DOES NOT EXCEED 1/2" IN 10 FEET. EDGE PROTECTION CAN BE PROVIDED BY MEANS OF A 4" MIN. CURB OR BARRIER.
- 11. CURB RAMPS ALONG ACCESSIBLE ROUTES SHALL NOT BE STEEPER THAN 8.3% (1:12). APPROACHING SLOPES TO THE RAMP CANNOT EXCEED 5%, WHICH INCLUDES SIDEWALKS, PAVEMENT, GUTTERS ETC.
- 12. IF CURB RAMP SIDES ARE FLARED, THE FLARES SHALL NOT BE STEEPER THAN 10% (1:10)...
- 13. CURB RAMPS SHALL BE LOCATED OR PROTECTED TO PREVENT THEIR OBSTRUCTION BY PARKED VEHICLES. 14. HANDRAILS ARE NOT REQUIRED ON CURB RAMPS.
- 15. WHERE DETECTABLE WARNING IS REQUIRED AT CURB RAMPS, THE DETECTABLE WARNING SHALL BE 24" MINIMUM IN DEPTH AND SHALL EXTEND THE FULL WIDTH OF THE RAMP. THE DETECTABLE WARNING SHALL BE LOCATED SO THE EDGE NEAREST THE CURB IS 6 INCHES MINIMUM AND 8 INCHES MAXIMUM FROM THE CURB LINE.
- 16. FOR EVERY SIX OR FRACTION OF SIX ACCESSIBLE PARKING SPACES, ONE VAN ACCESSIBLE SPACE SHALL BE PROVIDED.


 17. ACCESSIBLE PARKING SPACES SHALL BE LOCATED ON THE SHORTEST ACCESSIBLE ROUTE FROM PARKING TO A BUILDING
- 18. BARRIER FREE CAR PARKING SPACES SHALL BE A MINIMUM OF 11 FEET WIDE WITH AN ACCESS AISLE 5 FEET WIDE MINIMUM. 19. SURFACE SLOPES WITHIN THE PARKING SPACES AND AISLES SHALL NOT EXCEED 2% (1:48) 20. ACCESSIBLE AREAS INCLUDING PARKING SPACES, AISLES AND PATHWAYS, REQUIRE A MINIMUM VERTICAL CLEARANCE OF 98
- 21. ACCESSIBLE PARKING SPACES ARE REQUIRED TO BE IDENTIFIED BY SIGNS. THE SIGNS SHALL INCLUDE THE INTERNATIONAL SYMBOL OF ACCESSIBILITY. VAN PARKING SPACES ARE REQUIRED TO BE DESIGNATED AS "VAN ACCESSIBLE". REFER TO

HEAVY DUTY CAS IRON HOUSING W/ SECURED COVER — E.J.I.W. #1565 OR APPROVED EQUAL

RECESSED CLEANOUT


4"-45° BEND -


WYE FITTING OF

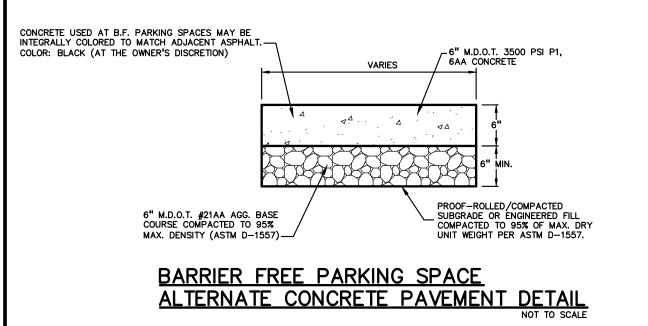

SIDEWALK NOT TO EXCEED - 2% SLOPE WITHIN 5' OF BUILDING ENTRANCES **BUILDING** LONGITUDINAL SLOPE (RUNNING LANDING/TURNING SPACE. LANDINGS MUST NOT EXCEED 2% IN ANY __ SLOPE) OF SIDEWALK IS NOT TO EXCEED 5.0% LEAST 5' IN EACH DIRECTION CROSS-SLOPE OF SIDEWALK IS NOT TO EXCEED 2.0% 5.0% (MAX) NOTE: THE GUTTER PAN PORTION OF THE SIDEWALK RAMP. TARGET SLOPE OF 5%-7%. MAXIMUM -ALLOWABLE SLOPE 8.3% PARKING SPACE DIMENSION. REFER TO DETAIL ON THIS SHEET FOR MODIFIED CURB AND GUTTER SECTION 2.0%(MAX) 2.0%(MAX) DETECTABLE WARNING (AS 2.0%(MAX) 2.0%(MAX) REQUIRED). REFER TO PLANS FOR DETECTABLE WARNING LOCATIONS 6 2.0%(MAX) 2.0%(MAX)

PARKING SPACE GRADING INFORMATION

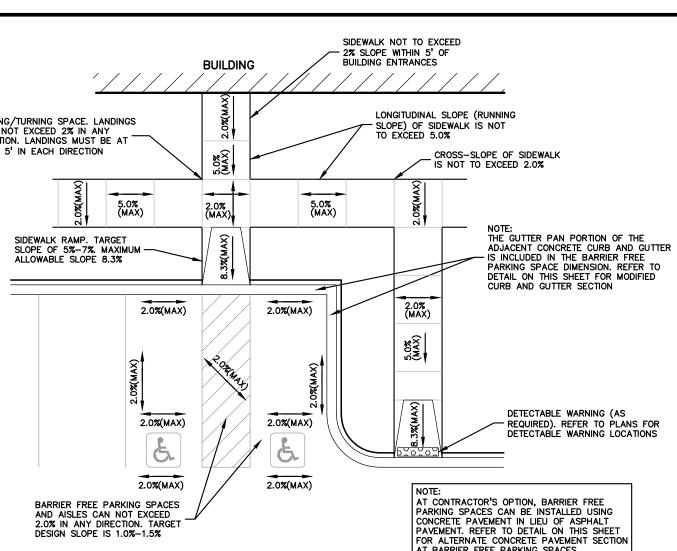

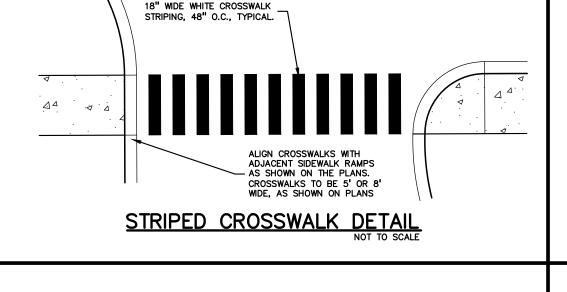

IF END OF LINE, PLUG BELL WY 4" SPUR

TOP SHOWN FOR CONC. PVMT. \downarrow TOP SHOWN FOR BIT. PVMT.

SECTION


CLEANOUT



12" x 18" RED ON WHITE REFLECTORIZED 7'-0" MOUNTING HEIGHT NO PARKING-FDC SIGN DETAIL



7'-0" MOUNTING HEIGHT NO DRIVE THRU ACCESS SIGN DETAIL NOT TO SCALE

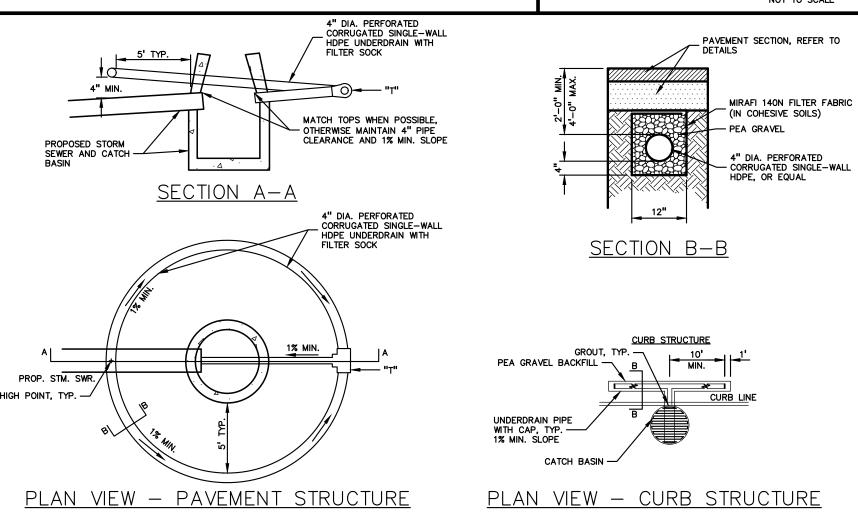


PAVEMENT INLET/CATCH BASIN UNDERDRAIN DETAIL

18" DIA. CONC. COLLAR

(IN ASPHALT PAVEMENT)




CROSSWALK SIGN DETAIL

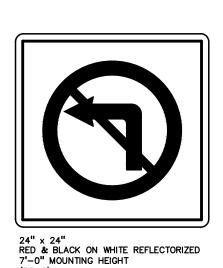

NO LEFT TURN SIGN DETAIL



KEEP RIGHT SIGN DETAIL

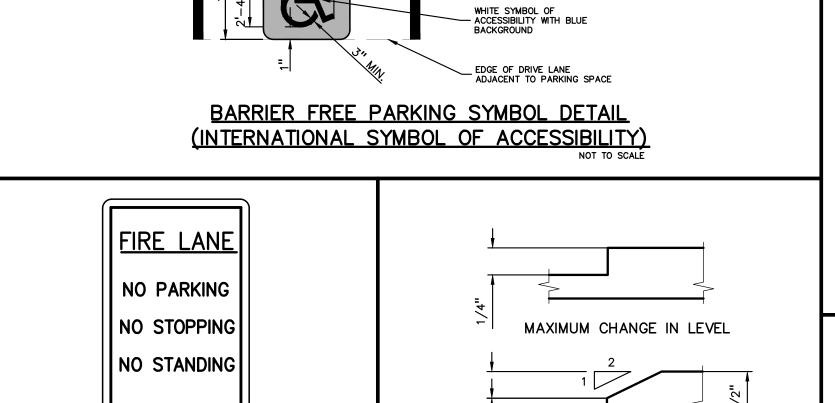

5'-0" MIN

UNIVERSAL BARRIER FREE PARKING STALL DETAIL

WIDTH OF 3"

4" WIDE BLUE PARKING STRIPI

- 3" (MIN.) WIDE WHITE BORDER

WITHIN ACCESSIBLE SPACES.

BARRIER FREE SIGNS AND POSTS, TYP

PROVIDE SIGN LOCATIONS PER PLAN)

OF PARKING

SPACE

ALL DIMENSIONS ARE TO CENTER O

PARKING STRIPE

11'+0" MIN. VAN ACCESSIBLE

STALL WIDTH

2'-9"

2' MIN.

VAN ACCESSIBLE SPACES MUST BE LOCATED TO THE LEFT OF

THE 5' STRIPED ACCESS AISLE

STRIPE UNLESS OTHERWISE INDICATED

OF PARKING

SPACE

© OF PARKING

ℚ SPACE

11'-0" MIN.

STALL WIDTH

THE BARRIER FREE PARKING SYMBOL SHALL BE

CONTRACTOR SHALL ADHERE TO LOCAL/STATE


JURISDICTIONAL REQUIREMENTS FOR ALL PAINTING

LOCATED IN THE CENTER OF THE PARKING SPACE AND

ALONG THE EDGE OF THE ADJACENT DRIVE AISLE, TYP. PARKING SYMBOL STRIPING SHALL HAVE A MINIMUM

4" WIDE BLUE PARKING STRIPES

BARRIER FREE PARKING SYMBOL, TYP. AT EACH SPACE. REFER TO DETAIL ON THIS SHEET

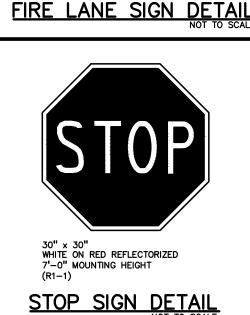

FIRE LANE SIGNS: APPROVED "NO PARKING FIRE LANE" SIGN MUST BE INSTALLED AND MAINTAINED IN COMPLIANCE WITH THE CRITERIA SET FORTH IN THE MICHIGAN MANUAL OF UNIFORM TRAFFIC CONTROL DEVICES. SOME OF THE CRITERIA IS AS FOLLOWS:

SHALL READ, "FIRE LANE. NO PARKING. NO STOPPING. NO


SIGN SHALL BE RED LETTERING ON WHITE BACKGROUND AND

SIGNS SHALL BE SPACED NO FURTHER THAN 100 FEET APART. SIGNS SHALL BE INSTALLED AT A RIGHT ANGLE 90° TO CURB

SIGN SHALL BE SEVEN (7) FEET FROM THE BOTTOM OF SIGN TO GRADE

SIGNS SHALL BE DOUBLE FACED WHERE SHOWN ON PLANS.
SIGNS SHALL BE 12 INCHES IN WIDTH AND 18 INCHES IN

RED ON WHITE REFLECTORIZED 7'-0" MOUNTING HEIGHT DO NOT ENTER SIGN DETAIL

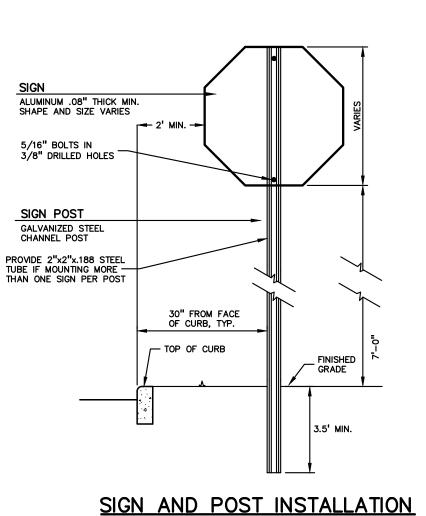

MAXIMUM BEVELED CHANGE IN LEVEL

BARRIER FREE SURFACE

CHANGE IN LEVEL TOLERANCE

IN LANDSCAPED AREAS

BARRIER FREE SIGN NOTES: 1. ONE SIGN IS REQUIRED AT EACH BARRIER FREE PARKING SPACE.

2. ALL SIGNS SHALL COMPLY WITH THE LATEST STANDARDS OF THE MICHIGAN MANUAL OF UNIFORM TRAFFIC CONTROL DEVICES (MMUTCD). 3. WHEN TWO BARRIER FREE PARKING SPACES ARE ADJACENT AND FACING EACH OTHER, TWO SIGNS ARE REQUIRED, BUT CAN BE MOUNTED ON THE SAME POST.

4. SIGN POSTS SHALL BE 2" NOM. SQUARE 14-GAUGE GALVANIZED STEEL TUBE WITH 7/16" HOLES AT 1" CENTERS. POSTS SHALL TELESCOPE INSIDE ANCHOR POSTS A

5. ANCHOR POSTS SHALL BE 2.25" NOM. SQUARE 12-GAUGE GALVANIZED STEEL POST,

A MINIMUM OF 3 FEET LONG. 6. IF THESE NOTES AND DETAILS CONFLICT WITH LOCAL CODES AND ORDINANCES, THE STRICTER REQUIREMENT SHOULD BE USED.

APPLICABLE.

PER JURISDICTIONAL

18" DIA. CONCRETE FOOTING USING

- M.D.O.T. 'P1' CONCRETE, 3500 PSI,

INSTALL BREAKAWAY TUBE POST

- IN SIGN LOCATIONS WHERE PIPE BOLLARD IS NOT REQUIRED.

6AA OR APPROVED EQUAL

AND LOCAL REQUIREMENTS.

7. ALTERNATE MATERIALS MAY BE USED IF IN COMPLIANCE WITH A.D.A. GUIDELINES 12"x18" x 0.080" ALUMINUM BARRIER FREE PARKING SIGN (R7-8), BOLT SIGN TO STEEL TUBE WITH %" CADMIUM PLATED BOLTS, NUTS, AND WASHERS. 6"x12" x 0.080" ALUMINUM VAN - ACCESSIBLE SIGN (R7-8P) WHERE SECONDARY/PENALTY SIGNAGE REQUIREMENTS WHERE APPLICABLE 2"x2"x.188" GALVANIZED STEEL TUBE. EXTEND INTO CONCRETE FILLED PIPE BOLLARD A MINIMUM OF 2'-0". 6" DIA, SCHEDULE 40 GALVANIZED STEEL PIPE FILLED WITH CONCRETE (WHEN SIGN IS LOCATED IN PAVED AREA OR SIDEWALK). PROVIDE ROUNDED WASH AT TOP OF CONCRETE FILL WITH 1% FINISHED SLOPE. PAINT BOLLARD WITH 2 COATS OF SAFETY YELLOW PAINT, OR PROVIDE YELLOW BOLLARD SLEEVE...

t: 844.813.2949

www.peagroup.com

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CAUTION!!

BARRIER FREE SIGN AND POST DETAIL

RESERVED RESERVED PARKING PARKING 12" x 18" (R7–8) GREEN BORDER AND LEGEND WHITE SYMBOL, BLUE BACKGROUND REFLECTORIZED MAY ONLY BE USED AT 11' WIDE SPACES LOCATED ON THE LEFT SIDE OF A 5' WIDE AISLE, OR 8' WIDE SPACES LOCATED TO THE ONLY LEFT OF 8' WIDE AISLES 12" x 18" (R7-8) GREEN BORDER AND LEGEND WHITE SYMBOL, BLUE BACKGROUND. REFLECTORIZED GREEN BORDER AND ACCESSIBL REFLECTORIZED **BARRIER FREE** PARKING SIGN DETAIL PARKING SIGN DETAIL

NOTE: ALTERNATE REVERSE CURB SECTION TO

FACE _

BE USED ONLY WHEN DRAINING AWAY FROM CURB. SEE PLANS FOR LOCATION.

EXTEND
AGGREGATE
12" BEYOND
BACK OF CURB

ROCHESTER AVON

PARTNERS, LLC 251 EAST MERRILL STREET, SUITE #205 REDUCE GUTTER PAN SLOPE TO 1.0% TARGET SLOPE (2.0% MAX) AT BARRIER FREE PARKING SPACE LOCATIONS - STANDARD SECTION - ALT. REVERSE CURB SECTION SLOPE AT 1.0% PROJECT TITLE OR 1/8" PER FT. **RETAIL** REDEVELOPMENT N.E.C. ROCHESTER ROAD & AVON ROAD

PROOF-ROLLED/COMPACTED
SUBGRADE OR ENGINEERED FILL
COMPACTED TO 95% OF MAX. DR
UNIT WEIGHT PER ASTM D-1557. MODIFIED CURB AND GUTTER SECTION FOR BARRIER FREE PARKING AREAS SIDEWALK RAMP AT LEAST 5%-7% SLOPE ROLLED CURB, TAPER FROM — ZERO TO 6" CURB HEIGHT ALONG RAMP LENGTH (MAX. SLOPE 8.3%) STANDARD 6" HIGH CONCRETE CURB AND —/ GUTTER SECTION STANDARD 6" HIGH — CONCRETE CURB AND GUTTER SECTION TRANSITION FROM STANDARD CURB TRANSITION FROM STANDARD CURB SECTION TO MODIFIED CURB SECTION REQUIRED AT BARRIER FREE AREAS SECTION TO MODIFIED CURB SECTION REQUIRED AT BARRIER FREE AREAS DETECTABLE WARNING (AS REQUIRED). REFER TO PLANS FOR — DETECTABLE WARNING LOCATIONS MODIFIED CONCRETE CURB AND GUTTER - SECTION WITH REDUCED GUTTER SLOPE TO MEET A.D.A. REQUIREMENTS TYPICAL SIDEWALK RAMP PLAN VIEW (A) THE STANDARD A.D.A. PARKING SPACE WIDTH OF 8.0' SHALL BE MEASURED FROM CENTER OF STRIPING AND/OR TO THE CURB

FACE (WHERE SPACES ARE DIMENSIONED TO THE CURB FACE). ENSURE THE PARKING SURFACE IS A.D.A. COMPLIANT BY PROVIDING THE MODIFIED CURB AND GUTTER SECTION ABOVE (B) THE A.D.A. PARKING SPACE LENGTH SHALL BE MEASURED FROM CENTER OF STRIPING AND/OR TO THE CURB FACE. TO ENSURE THE PARKING SPACE IS A.D.A. COMPLIANT. REFER TO MODIFIED CURB AND GUTTER DETAIL ABOVE TYPICAL BARRIER FREE PARKING SPACES

MODIFIED 18"x6" CONCRETE CURB AND GUTTER

DETAIL TO BE USED IN BARRIER FREE AREAS NOT FOR CONSTRUCTION

CITY FILE #21-007 SECTION #14 XREF: S: \PROJECTS\2019\2019\-007\DWG\SITE PLANS\CBASE-19007.dwg


REVISIONS CITY COMMENTS 6/16/21 CITY COMMENTS 7/21/21 ORIGINAL ISSUE DATE: MAY 10, 2021

DRAWING TITLE


PEA JOB NO. 2019-007 RLS

DETAILS

DES. DRAWING NUMBER:

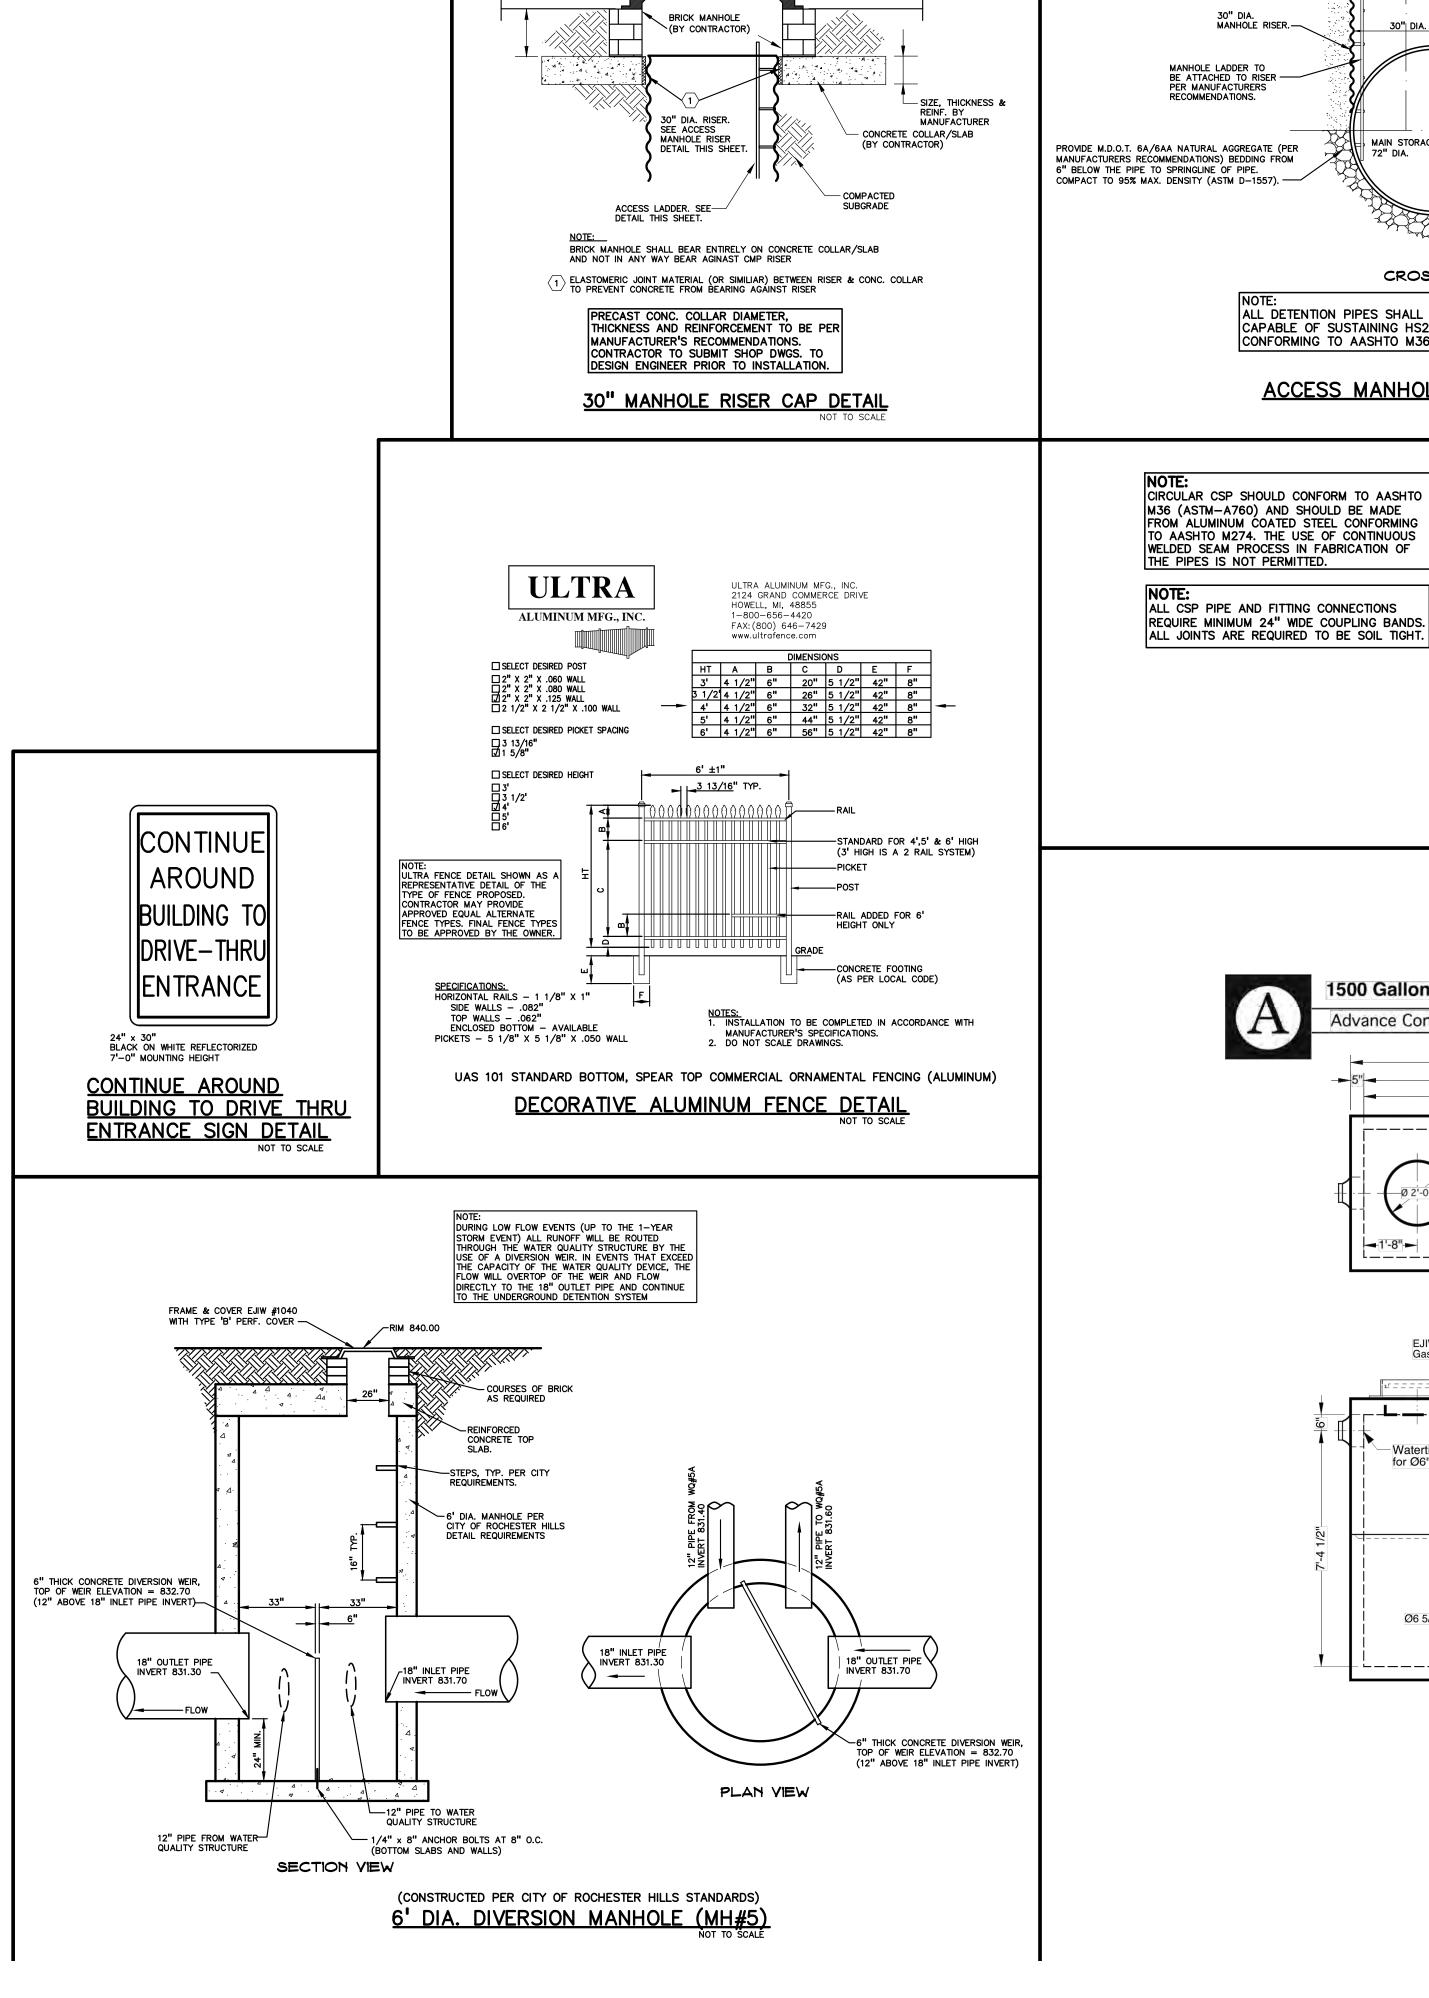



PROPOSED GRADE

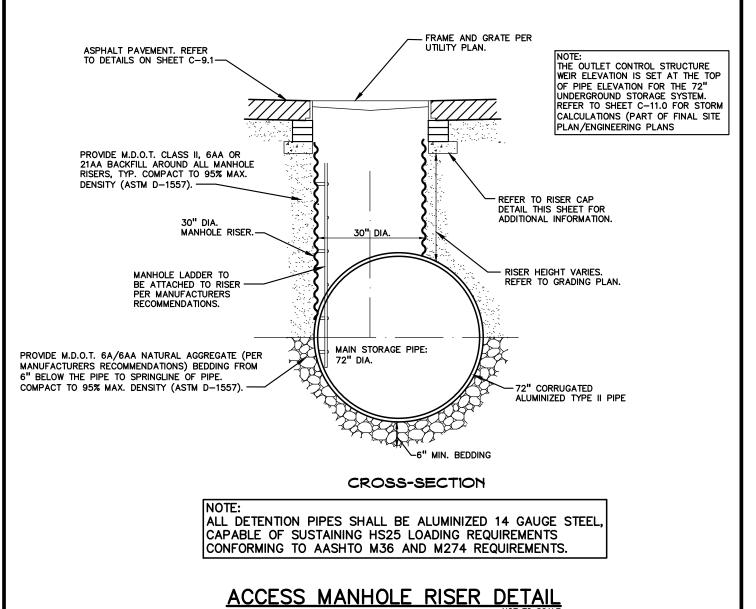

EXTEND FABRIC TO-TOP OF STONE

72" TYPE 2 ALUMINIZED CORRUGATED STEEL PIPE (CSP) -

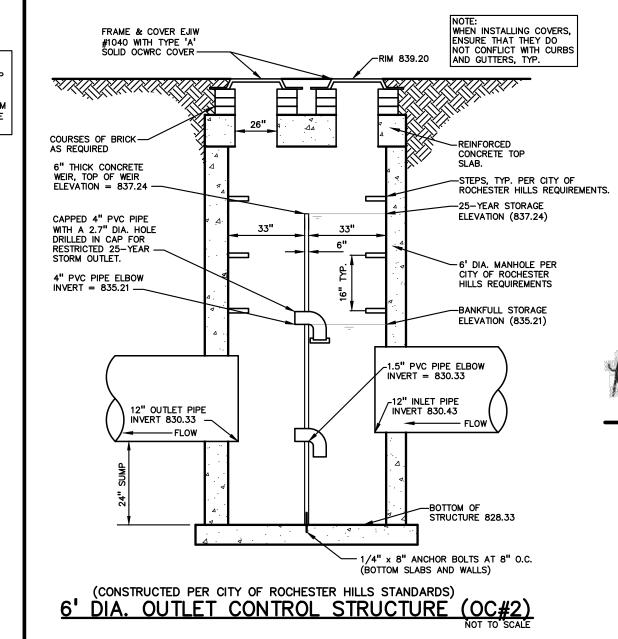

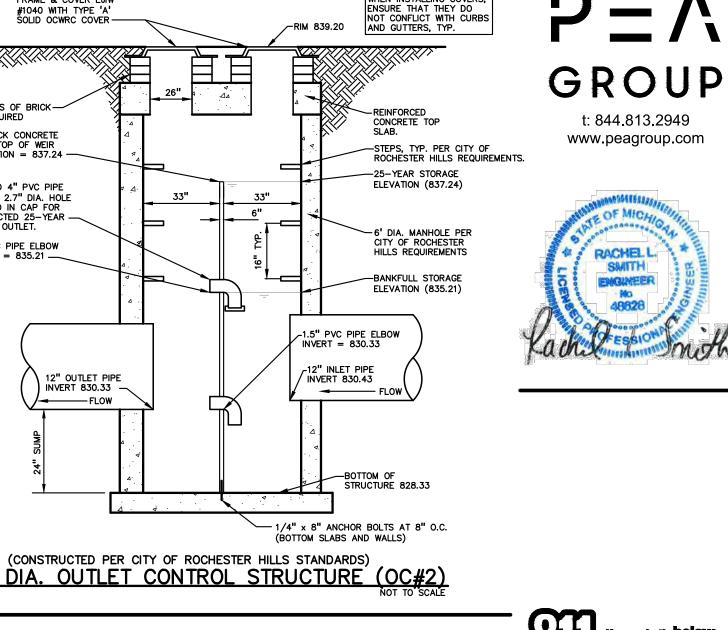

M.D.O.T. CLASS II COMPACTED
TO 95% MAX. DRY DENSITY PER

LIFTS, MAX.)

ASTM D-1557 (COMPACT IN 12"

M.D.O.T. 6A/6AA NATURAL AGGREGATE COMPACTED TO 95% MAX. DRY DENSITY PER

ASTM D-1557 (COMPACT IN 12" LIFTS, MAX.)

PROVIDE MIRAFI
500X FABRIC OVER
SUBGRADE

CAUTION!! THE LOCATIONS AND ELEVATIONS OF EXISTING UNDERGROUND UTILITIES AS SHOWN ON THIS DRAWING ARE ONLY APPROXIMATE. NO GUARANTEE IS EITHER EXPRESSED OR IMPLIED AS TO THE COMPLETENESS OR ACCURACY THEREOF. THE CONTRACTOR SHALL BE EXCLUSIVELY RESPONSIBLE FOR

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ROCHESTER AVON PARTNERS, LLC 251 EAST MERRILL STRÉET, SUITE #205 BIRMINGHAM, MICHIGAN, 48009

CLIENT

PCA 1500 Gallon Interceptor - 8' x 4' x 7'-10 1/2" Advance Concrete Products Company (800) 824-8351 (248) 887-4173 Fax: (248) 887-2755 All Concrete Shall Have A 28 Day Compressive Strength Of 4500 PSI. Reinforcing Steel Shall Comply With ASTM A615 Grade 60 Rebar. Bar Bending And Placement Shall Comply With The Latest ACI Standards. 5'-4" 2'-8" Standard Structural Design Based On AASHTO HS 20 Wheel Loading. Butyl Rubber Rope Mastic Is Provided For Placement Between Top And Bottom Sections Of Vault. If Function Of Interceptor Is Oil, Gas, or Water Separation, Fuel Resistant Rope Mastic Is Recommended & Can Be Provided. Available Options -Grade Adjustment Rings Cast Iron Frames & Covers Custom Opening Locations Watertight Boots in Variety of Sizes Double, Triple or Quadruple Compartments --1'-8" -- Approximate Weight Total: ±20,900 Lbs.


Bottom Section: ±9,300 Lbs. Top Section: ±9,300 Lbs.

Divider Wall: ±2,300 Lbs. PLAN VIEW

— TOP OF ASPHALT PAVEMENT. GRADING PER PLAN

3.30 MIN

SECTION THRU DETENTION SYSTEM

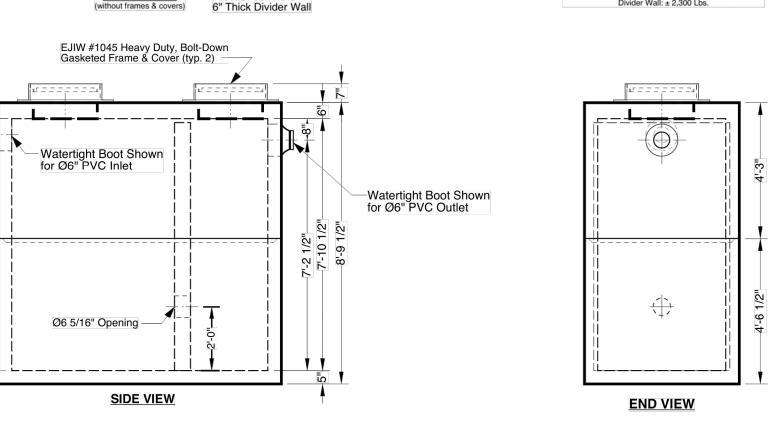

GREASE INTERCEPTOR


PROJECT TITLE **RETAIL** REDEVELOPMENT N.E.C. ROCHESTER ROAD & AVON ROAD REVISIONS CITY COMMENTS 6/16/21 CITY COMMENTS 7/21/21


> ORIGINAL ISSUE DATE: MAY 10, 2021 DRAWING TITLE **DETAILS**

PEA JOB NO. 2019-007 RLS DES. DRAWING NUMBER:

NOT FOR CONSTRUCTION CITY FILE #21-007 SECTION #14

XREF: S:\PROJECTS\2019\2019-007\DWG\TOPOBASE-19007.dwg
XREF: S:\PROJECTS\2019\2019-007\DWG\SITE PLANS\CBASE-19007.dwg
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XREF: S:\PROJECTS\2019\2019-007\DWG\SITE PLANS\TBLK-19007.dwg

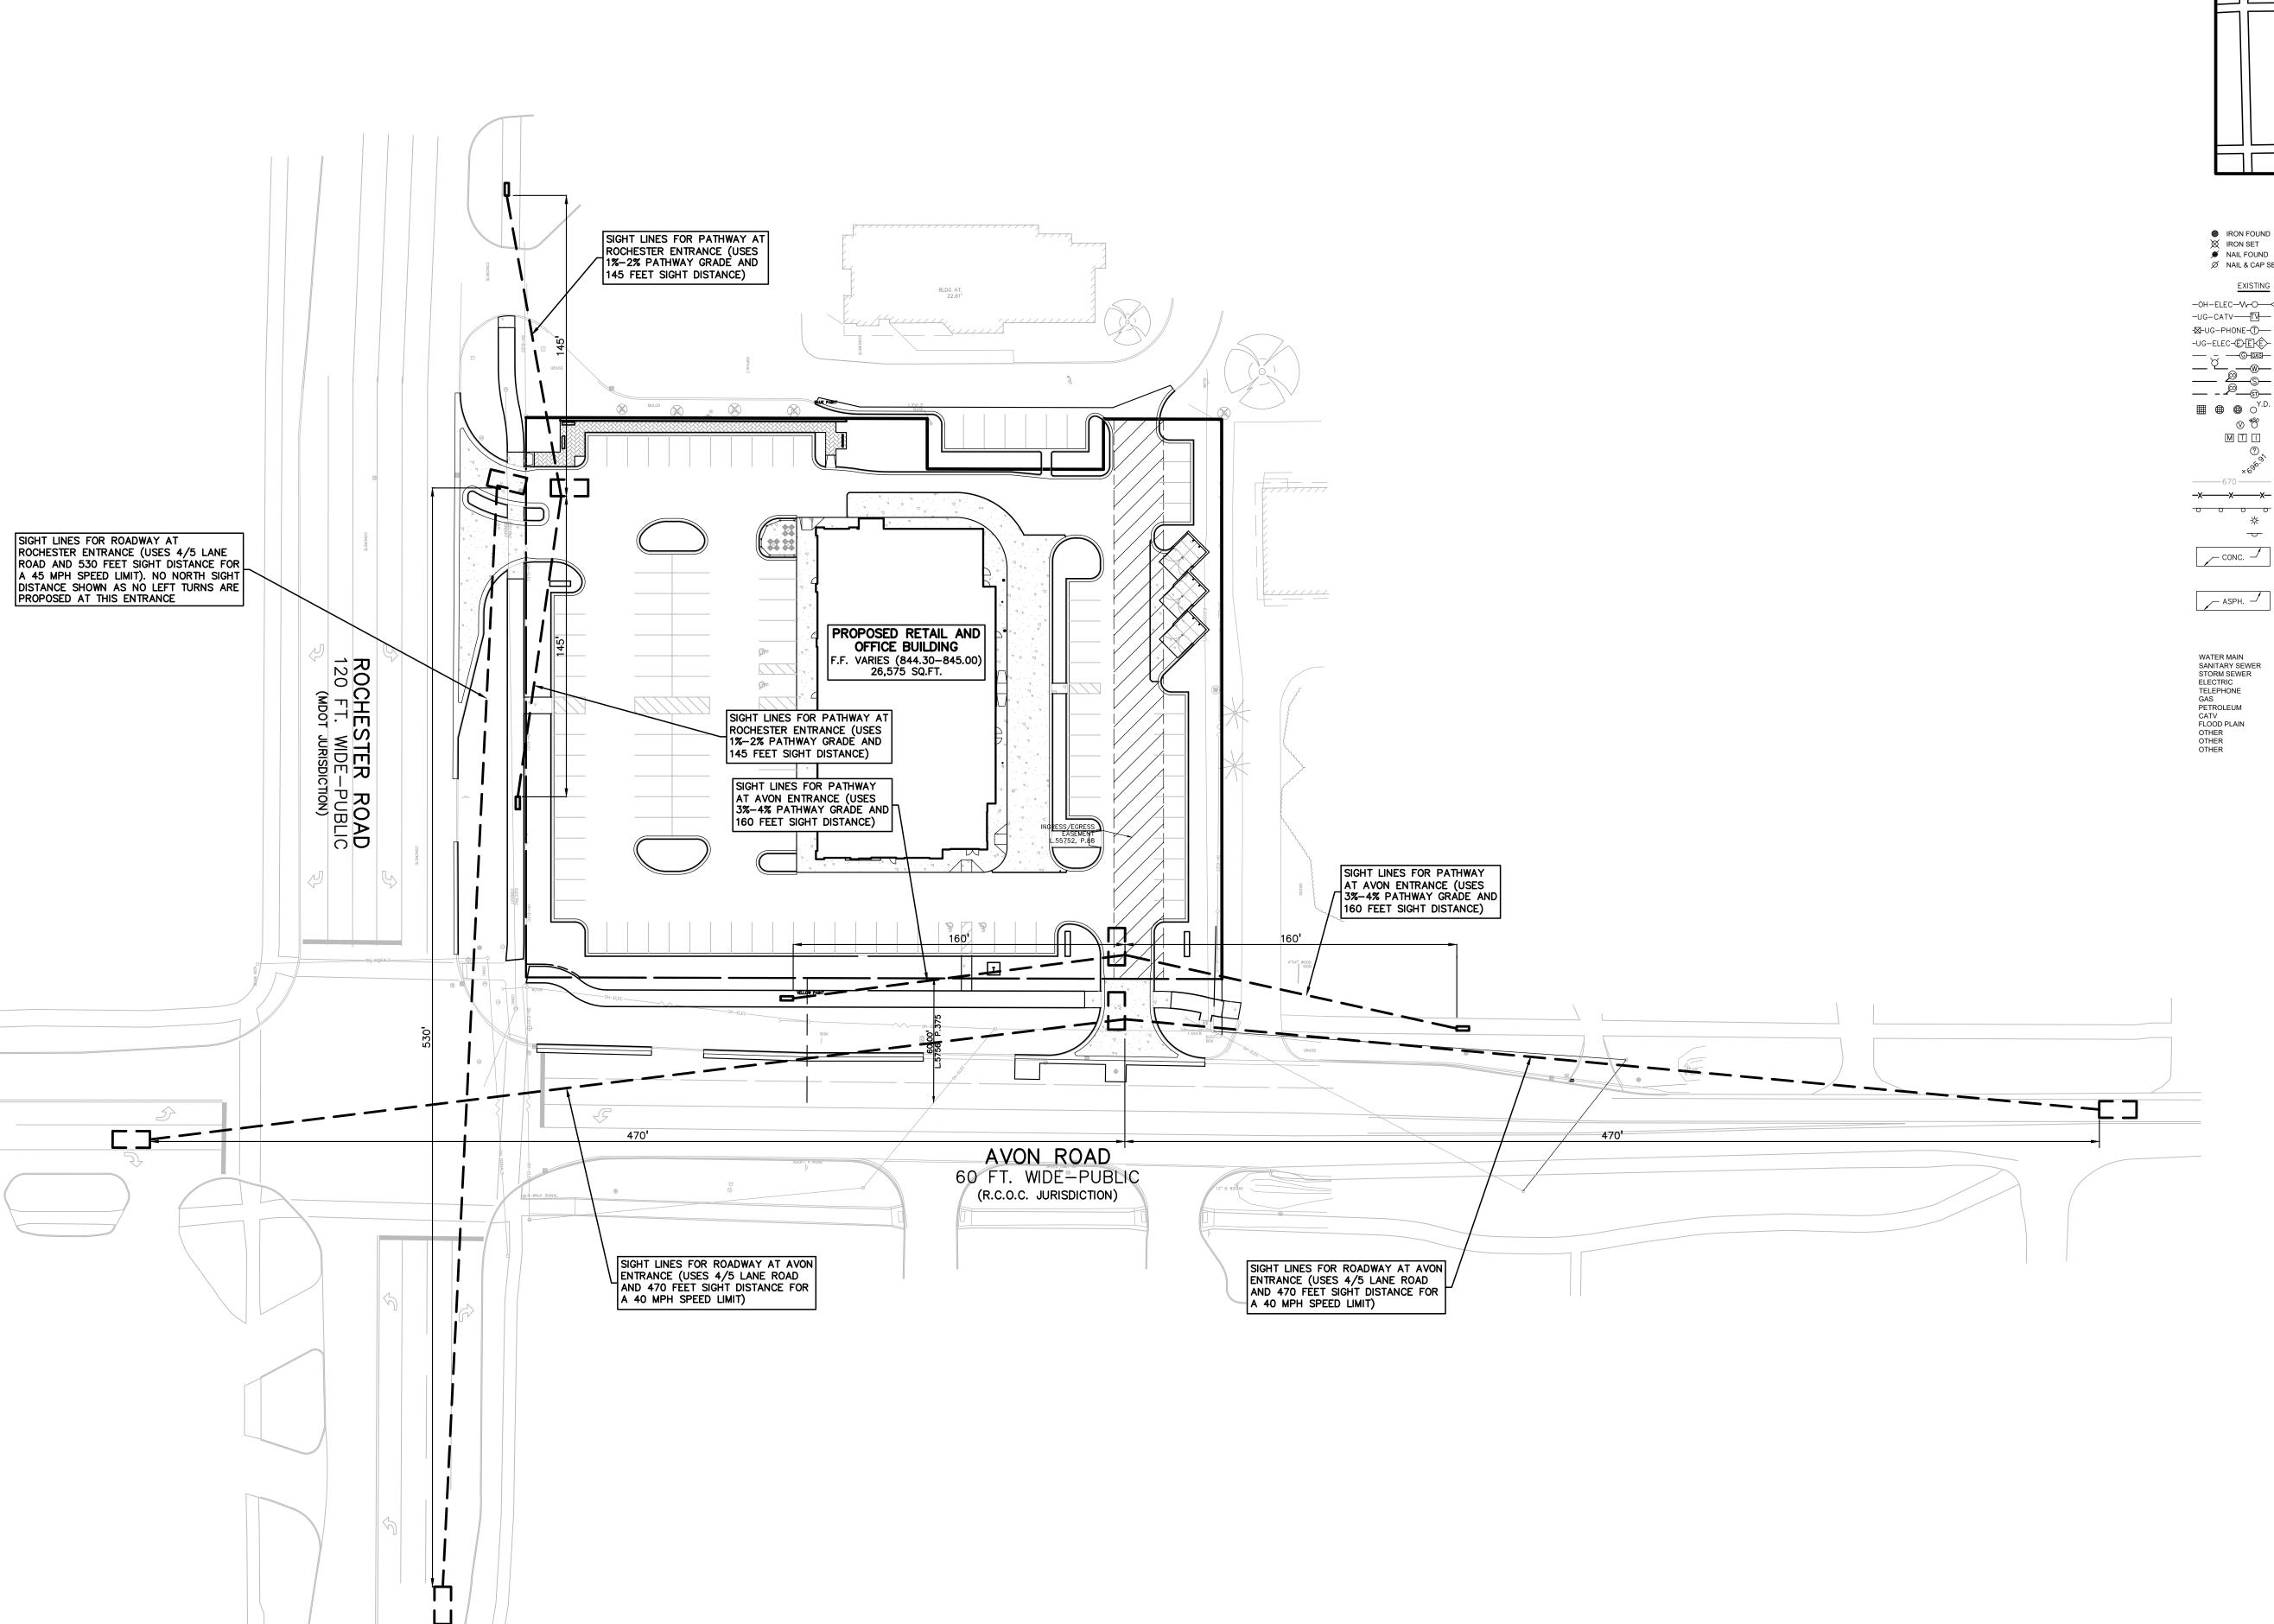

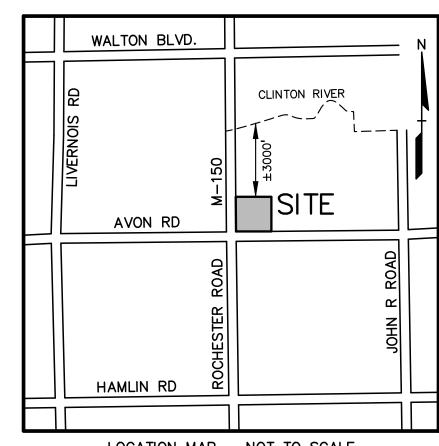

GROUP t: 844.813.2949 www.peagroup.com



SCALE: 1" = 40'

THE LOCATIONS AND ELEVATIONS OF EXISTING UNDERGROUND UTILITIES AS SHOWN ON THIS DRAWING ARE ONLY APPROXIMATE. NO GUARANTEE IS EITHER EXPRESSED OR IMPLIED AS TO THE COMPLETENESS OR ACCURACY THEREOF. THE CONTRACTOR SHALL BE EXCLUSIVELY RESPONSIBLE FOR DETERMINING THE EXACT UTILITY LOCATIONS AND ELEVATIONS PRIOR TO THE START OF CONSTRUCTION.


LOCATION MAP - NOT TO SCALE

LEGEND © BRASS PLUG SET © MONUMENT FOUND

N FOUND	Ø	BRASS PLUG SET		SEC. CORNER F
N SET		MONUMENT FOUND	•	
L FOUND	(®)	MONUMENT SET	R	RECORDED
L & CAP SET	,		M	MEASURED
			С	CALCULATED
EXISTING				

CONC. CONCRETE

ASPH. ASPHALT

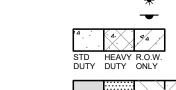

REFERENCE DRAWINGS

CITY OF ROCHESTER HILLS GIS MAP
WER CITY OF ROCHESTER HILLS GIS MAP
CITY OF ROCHESTER HILLS GIS MAP
NOT RECEIVED
NOT RECEIVED

DNE NOT RECEIVED
CONSUMERS ENERGY MAP# 03-61-14-3, DATED 01/10/19
EUM NO FACILITIES IN THE AREA
COMCAST SERVICE MAP RECEIVED 02/19/19
LAIN FIRM MAP 26125C0392F, DATED 09/29/06, ZONE 'X'
MDOT ROAD PLANS, VARIOUS PROJECTS
BOUNDARY/TOPOGRAPHIC SURVEY, COMERICA BANK, NF #M148, DATED 12/21/20
PARTIAL GRADING/UTILITY PLAN, COMERICA BANK, UNDATED

CLIENT

CAUTION!!

ROCHESTER AVON PARTNERS, LLC
251 EAST MERRILL STREET, SUITE #205 BIRMINGHAM, MICHIGAN, 48009

PROJECT TITLE

RETAIL REDEVELOPMENT N.E.C. ROCHESTER ROAD & AVON ROAD CITY OF ROCHESTER HILLS, OAKLAND COUNTY, MI

REVISIONS

CITY COMMENTS 6/16/21


CITY COMMENTS 7/21/21


ORIGINAL ISSUE DATE:
MAY 10, 2021

DRAWING TITLE

SIGHT DISTANCE PLAN

PEA JOB NO. 2019-007
P.M. RLS
DN. BA
DES. PB
DRAWING NUMBER:

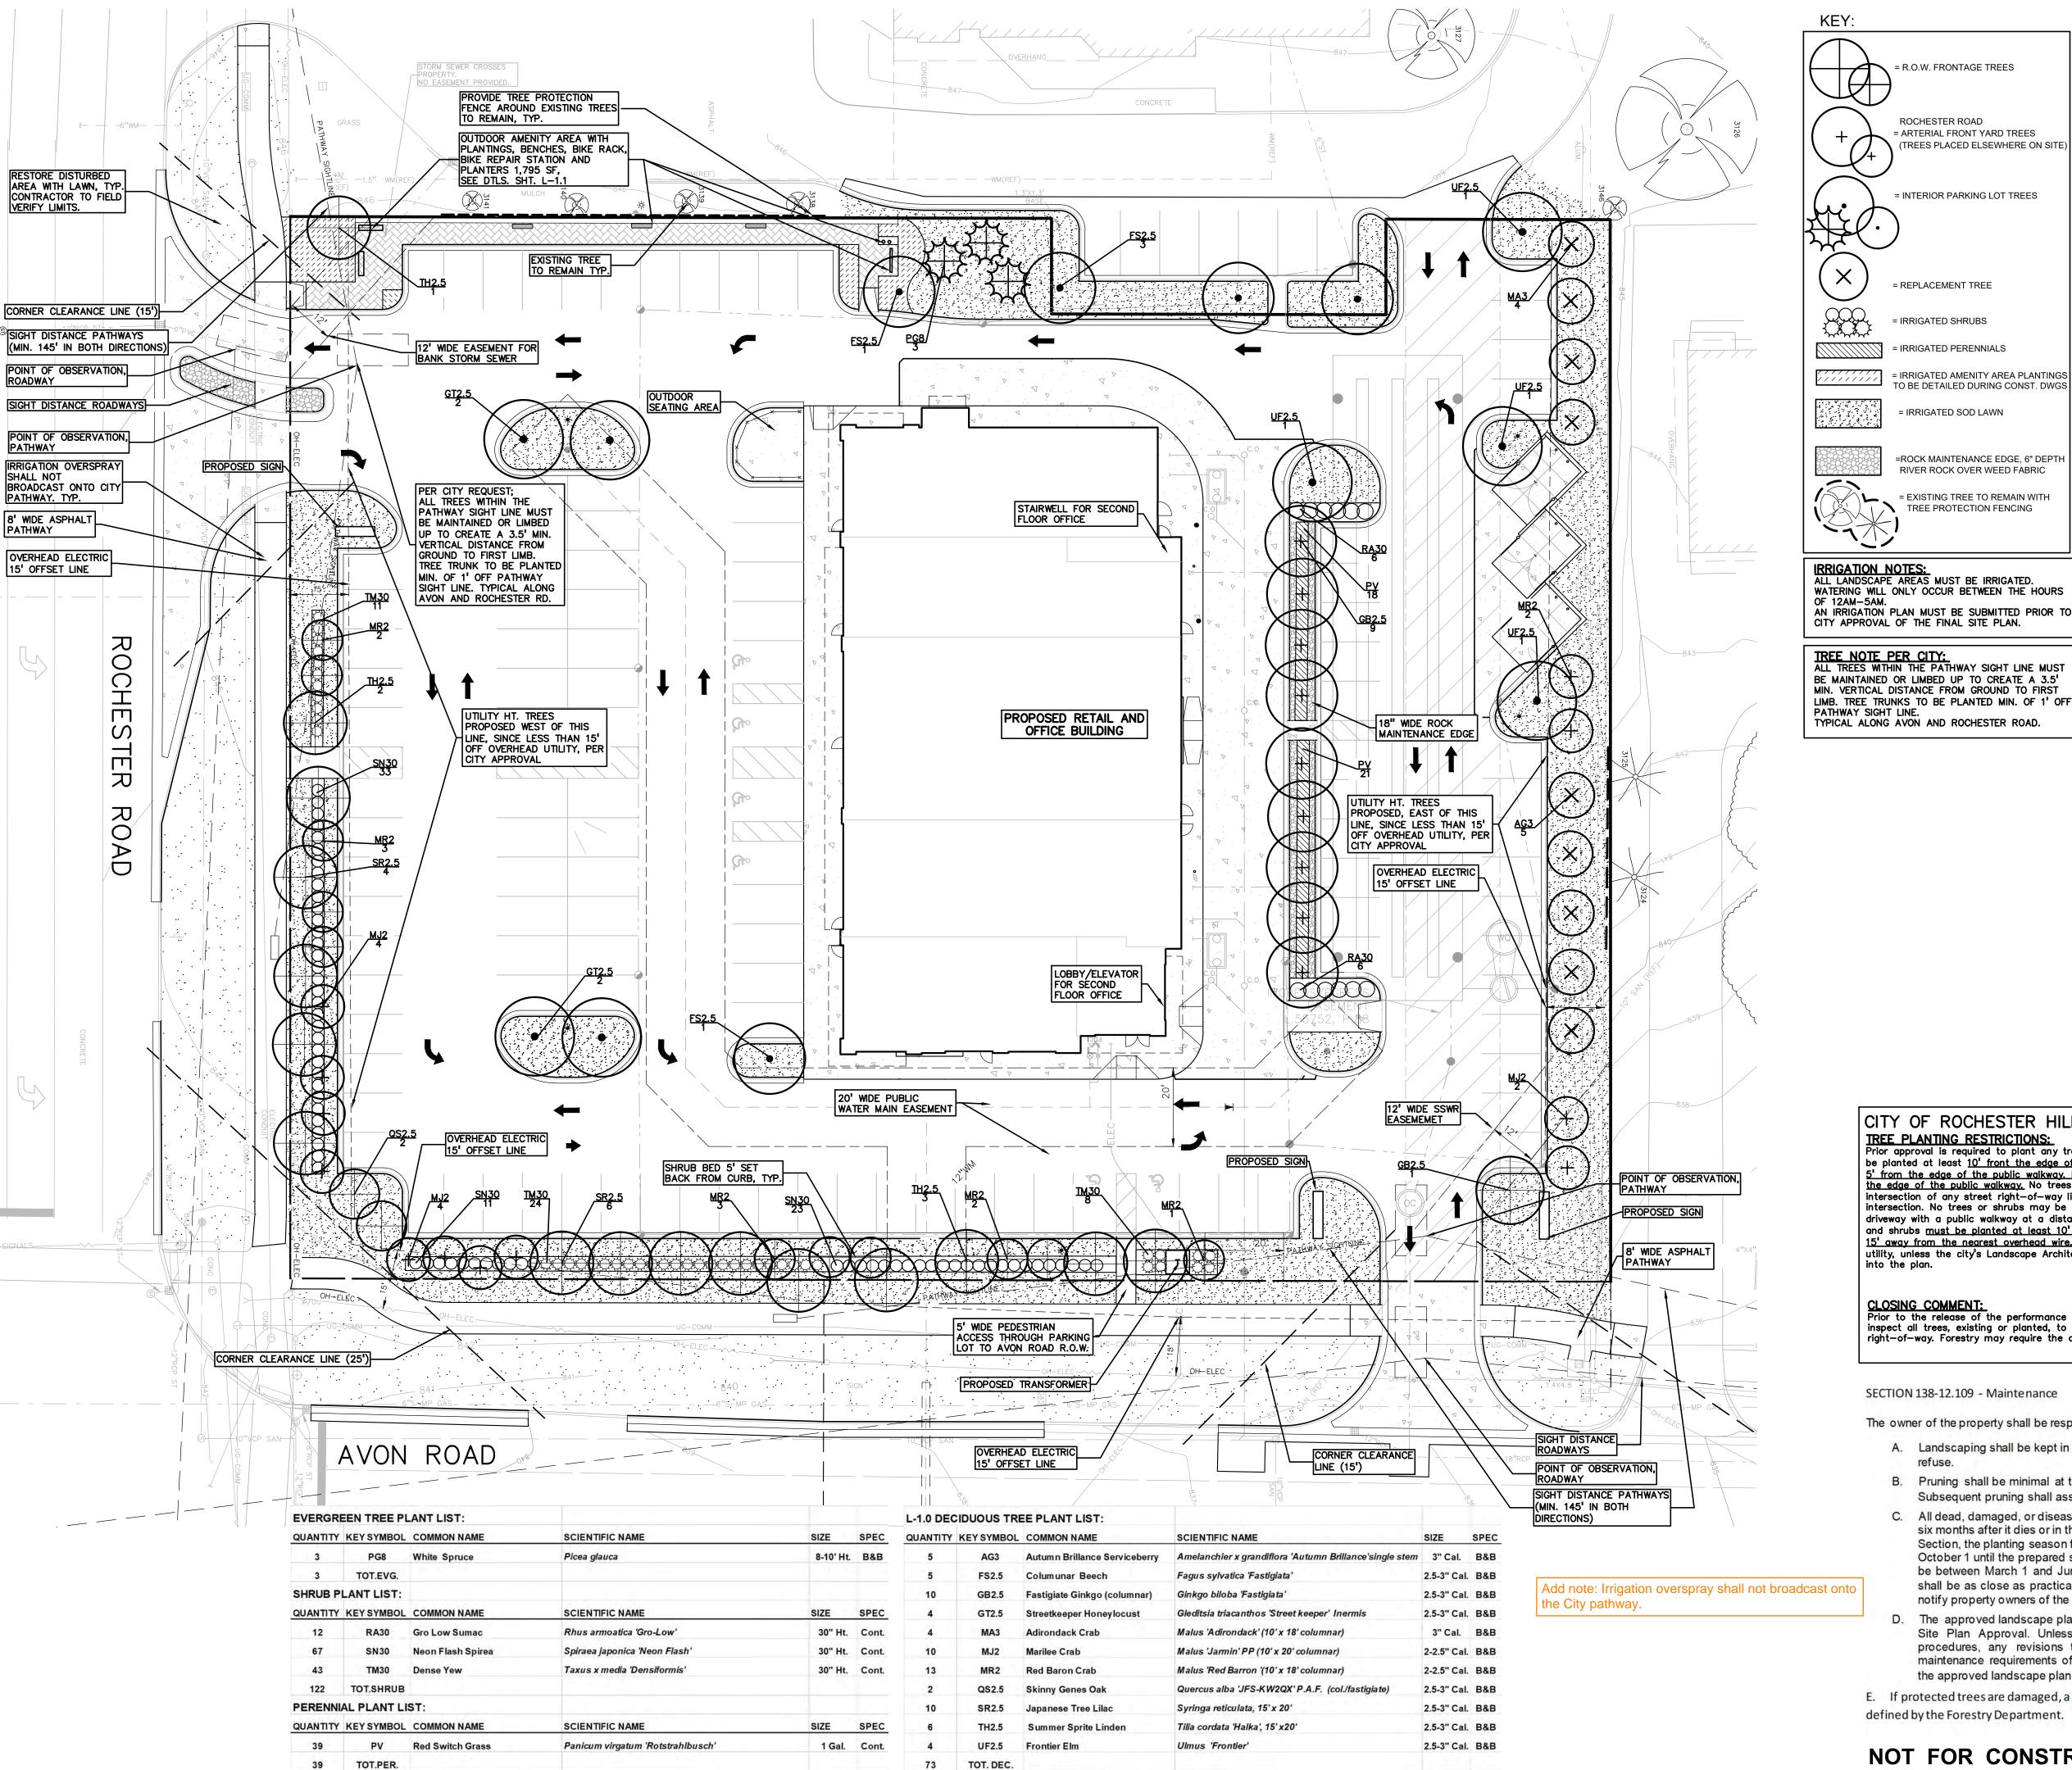

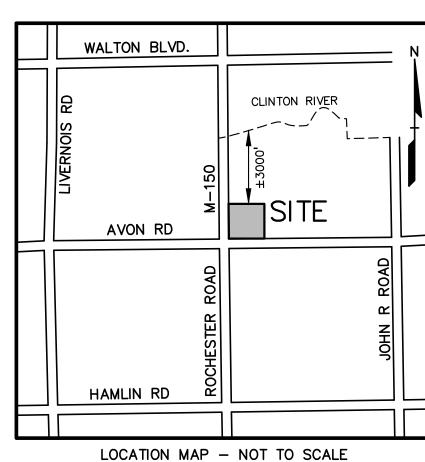

LANDSCAPE CALCULATIONS:
PER CITY OF ROCHESTER HILLS ZONING ORDINANCE, ZONED B-2 WITH

REQUIRED: 1 DEC OR EVG/ 35LF AND 1 ORN TREE/ 60LF OF ROW.

ROCHESTER RD: 290'/35 = 9 DEC OR EVG AND 290'/60 = 5 ORN

REQUIRED: 3 DEC, 4 ORN, 15 SHRUBS/ 100LF OF ROW. (15' WIDE)

ROCHESTER RD: 290'/100 = 9 DEC, 12 ORN. AND 44 SHRUBS

INTERIOR PARKING LANDSCAPE
REQUIRED: MINIMUM 5% OF THE VEHICLE USE AREA TO BE

GROSS LAND AREA: 88,539 SF *.02 = 1,771 SF REQUIRED

TREE REPLACEMENT CALCULATIONS
PER CITY OF ROCHESTER HILLS ZONING ORDINANCE

REQUIRED: 18, 3" OR 8' EVG. REPLACEMENT TREES

SEE SHEET T-1.0 FOR TREE PRESERVATION PLAN

PROVIDED: 1.795 SF OF AMENITY SPACE. WITH PLANTINGS AND

REQUIRED: 1, 2" DEC. TREE OR 8' EVG PER REGULATED TREE REMOVED. 2" TREE REPLACEMENT CREDIT FOR EACH SPECIMEN

(9 REMAINING TREES TO BE PUT INTO TREE FUND DUE TO SPACE

PROVIDED: 9 TREES AT DRIVE THRU, 4 ORN. AT ROCHESTER RD,

4 ORN. AT AVON RD., 4 ORN. AT EAST P/L AND 44 SHRUBS AT

(NOT ENOUGH ROOM TO BE PLACED IN ROCHESTER RD. ROW, TREES

LANDSCAPED AREA. 1 DEC. TREE FOR EVERY 150 SF OF REQUIRED

5% OF THE 47,274 SF VEHICLE USE AREA = 2364 /150 = 16 TREES

PROVIDED: 13 DEC. AND 3 EVG. TREES, SHRUB HEDGE AT PARKING

OUTDOOR AMENITY SPACE
REQUIRED: MINIMUM 2% GROSS LAND AREA OF THE DEVELOPMENT TO

AVON RD: 335'/35 = 10 DEC OR EVG AND 335'/60 = 6 ORN.

FB-3 FLEX BUSINESS OVERLAY DISTRICT

AVON RD: 10 DEC. AND 6 ORN.

ROCHESTER RD: 9 DEC. AND 5 ORN.

ARE LOCATED ELSEWHERE ON SITE)

SPACES ADJ. TO AVON AND ROCHESTER RD.

INTERIOR LANDSCAPE.

2,390 SF LANDSCAPE AREA

BE OUTDOOR AMENITY SPACE.

REPLACEMENT TREES:

PROVIDED: 9, 3" DEC. TREES

LIMITATIONS, $304.00 \times 9 = $2,736.00$

TREE PRESERVED.

BENCHES, BIKE RACK AND PLANTERS.

FB OVERLAY — ARTERIAL ST. ROCHESTER RD FRONT YARD LANDSCAPING

t: 844.813.2949 www.peagroup.com

CAUTION!! THE LOCATIONS AND ELEVATIONS OF EXISTING UNDE JTILITIES AS SHOWN ON THIS DRAWING ARE ONLY PPROXIMATE. NO GUARANTEE IS EITHER EXPRESSED OR DETERMINING THE EXACT UTILITY LOCATIONS AND ELEVATIONS PRIOR TO THE START OF CONSTRUCTION.

ROCHESTER AVON PARTNERS, LLC 251 EAST MERRILL STRÉET, SUITE #205

REDEVELOPMENT

N.E.C. ROCHESTER ROAD & AVON ROAD

7/21/21

BIRMINGHAM, MICHIGAN, 48009

PROJECT TITLE

RETAIL

REVISIONS CITY COMMENTS CITY COMMENTS

CITY OF ROCHESTER HILLS NOTES:

TREE PLANTING RESTRICTIONS:

Prior approval is required to plant any tree or shrub on the public right—of—way. All trees and shrubs must be planted at least <u>10' front the edge of the public roa</u>d. <u>Shade trees and shrubs must be planted at least</u> 5' from the edge of the public walkway. Evergreen and ornamental trees must be planted at least 10' from the edge of the public walkway. No trees or shrubs may be planted within the triangular area formed at the intersection of any street right-of-way lines at a distance along each line of 25' from their point of intersection. No trees or shrubs may be planted in the triangular area formed at the intersection of any driveway with a public walkway at a distance along each line of 15' from their point of intersection. All trees and shrubs <u>must be planted at least 10' from any fire hydrant</u>, <u>Shade and evergreen trees must be at least</u> 15' away from the nearest overhead wire. Trees must be planted a minimum of 5' from an underground utility, unless the city's Landscape Architect requires a greater distance. These requirements are incorporated

Prior to the release of the performance bond, the City of Rochester Hills Forestry Division needs to inspect all trees, existing or planted, to identify any that pose a hazard to the safe use of the public right—of—way. Forestry may require the developer to remove, and possibly replace, any such trees.

SECTION 138-12.109 - Maintenance

The owner of the property shall be responsible for all maintenance of site landscaping, as follows:

- A. Landscaping shall be kept in a neat, orderly and healthy growing condition, free from debris and
- B. Pruning shall be minimal at the time of installation, only to remove dead or diseased branches.
- Subsequent pruning shall assure proper maturation of plants to achieve their approved purpose.
- C. All dead, damaged, or diseased plant material shall be removed immediately and replaced within six months after it dies or in the next planting season, whichever occurs first. For purposes of this Section, the planting season for deciduous plants shall be between March 1 and June 1 and from October 1 until the prepared soil becomes frozen. The planting season for evergreen plants shall be between March 1 and June 1. Plant material installed to replace dead or diseased material shall be as close as practical to the size of the material it is intended to replace. The City may notify property owners of the need to replace dead, damaged, or diseased material.
- D. The approved landscape plan shall be considered a permanent record and integral part of the Site Plan Approval. Unless otherwise approved in accordance with the aforementioned procedures, any revisions to or removal of plant materials, or non-compliance with the maintenance requirements of this Section 138-12.109 will place the parcel in non-conformity with the approved landscape plan and be a violation of this ordinance.
- E. If protected trees are damaged, a fine shall be issued on an inch-by-inch basis at a monetary rate as defined by the Forestry Department.

NOT FOR CONSTRUCTION CITY FILE #21-007 SECTION #14

XREF: S:\PROJECTS\2019\2019-007\DWG\TOPOBASE-19007.dwg
XREF: S:\PROJECTS\2019\2019-007\DWG\SITE PLANS\CBASE-19007.dwg
XREF: S:\PROJECTS\2019\2019-007\DWG\SITE PLANS\TBLK-19007.dwg

PLAN PEA JOB NO. 2019-007

DRAWING NUMBER:

ORIGINAL ISSUE DATE:

LANDSCAPE

MAY 10, 2021

DES.

DRAWING TITLE

LANDSCAPING

PLAN				
QUANTITY	UNIT	DESCRIPTION	UNIT PRICE	ITEM PRICE
1,705	S.Y.	SOD LAWN	\$6.00	\$10,230.00
23	EA.	SUB CANOPY ORNAMENTAL TREES AT 2" CAL.	\$350.00	\$8,050.00
50	EA.	DECIDUOUS TREES AT 2.5" CAL.	\$550.00	\$27,500.00
3	EA.	EVERGREEN TREES AT 8' HT.	\$450.00	\$1,350.00
17	C.Y.	MULCH 3"	\$50.00	\$850.00
34	C.Y.	PLANT MIX FOR BEDS (6" DEPTH)	\$55.00	\$1,870.00
760	L.F.	ALUMINUM EDGING	\$5.00	\$3,800.00
10	C.Y.	RIVER ROCK	\$85.00	\$850.00
39	EA.	PERENNIALS	\$20.00	\$780.00
122	EA.	SHRUBS	\$55.00	\$6,710.00
9	EA.	TREES TO BE PAID INTO THE TREE FUND	\$304.00	\$2,736.00
1	AC.	IRRIGATION (COMMERCIAL BUILDING)	\$21,000.00	\$21,000.00
1	25%	CONTINGENCY	\$19,070.00	\$19,070.00
		TOTAL LANDSCAPING		\$104,796.00

NOTE: ESTIMATE DOES NOT INCLUDE SITE FURNITURE, AND PLANTINGS WITHIN AMENITY AREA.

- EXISTING SITE CONDITIONS AND REVIEW PROPOSED PLANTING AND RELATED WORK. IN CASE OF SHALL GOVERN QUANTITIES. CONTACT LANDSCAPE
- UTILITIES PRIOR TO BEGINNING CONSTRUCTION ON OF SERVICES SHALL BE THE RESPONSIBILITY OF CONTRACTOR. CONTRACTOR SHALL COORDINATE ALL AND SHALL REPORT ANY UNACCEPTABLE JOB CONDITIONS TO OWNER'S REPRESENTATIVE PRIOR TO
- ALL PLANT MATERIAL TO BE PREMIUM GRADE NURSERY STOCK AND SHALL SATISFY AMERICAN ASSOCIATION OF NURSERYMEN STANDARD FOR NURSERY STOCK. ALL LANDSCAPE MATERIAL SHALL BE NORTHERN GROWN, NO.
- CONTRACTOR IS RESPONSIBLE FOR VERIFYING ALL QUANTITIES SHOWN ON LANDSCAPE PLAN PRIOR TO PRICING THE WORK.
- THE OWNER'S REPRESENTATIVE RESERVES THE RIGHT TO REJECT ANY PLANT MATERIAL NOT MEETING SPECIFICATIONS.
- . ALL SINGLE STEM SHADE TREES TO HAVE STRAIGHT
- ALL SINGLE TRUNK SHADE TREES TO HAVE A CENTRAL LEADER; TREES WITH FORKED OR IRREGULAR TRUNKS WILL NOT BE ACCEPTED.
- 8. ALL MULTI STEM TREES SHALL BE HEAVILY BRANCHED AND HAVE SYMMETRICAL CROWNS. ONE SIDED TREES OR THOSE WITH THIN OR OPEN CROWNS SHALL NOT BE
- 9. ALL EVERGREEN TREES SHALL BE HEAVILY BRANCHED AND FULL TO THE GROUND, SYMMETRICAL IN SHAPE AND NOT SHEARED FOR THE LAST FIVE GROWING
- 10. ALL TREES TO HAVE CLAY OR CLAY LOAM BALLS,
- 1. NO MACHINERY IS TO BE USED WITHIN THE DRIP LINE
- 12. ALL TREE LOCATIONS SHALL BE STAKED BY LANDSCAPE CONTRACTOR AND ARE SUBJECT TO THE APPROVAL OF THE LANDSCAPE ARCHITECT PRIOR TO INSTALLATION OF THE PLANT MATERIAL.
- AWAY FROM ALL BUILDINGS.
- HARDWOOD BARK MULCH WITH PRE EMERGENT. SEE SPECIFICATIONS. SHREDDED PALETTE AND DYED MULCH WILL NOT BE ACCEPTED.
- 15. ALL LANDSCAPED AREAS SHALL RECEIVE 4" COMPACTED
- REQUIREMENTS, PLANTING PROCEDURES AND WARRANTY
- 7. CONTRACTOR SHALL NOT INSTALL PLANTS UNDER BUILDING OVERHANG AND SHALL NOTIFY LANDSCAPE ARCHITECT IF DRAWINGS CONFLICT WITH BUILDING



BENCH: 72" PLAINWELL, ALUMINUM PHONE: 800-521-2546 COLOR: BLACK, POWDER COATED, OWNER TO SELECT/APPROVE COLOR QUANTITY: 2, QTY. TO BE APPROVED BY OWNER



BIKE FIX IT STATION AND PUMP:

BY: DERO OR APPROVED EQUAL

COLOR: BLACK, POWDER COATED, OWNER TO

PHONE: 888-337-6729

SELECT/APPROVE COLOR

STATION: FIX IT, QTY 1

PUMP: AIR KIT, QTY 1

BIKE RACK: BRCS-103 (3 LOOPS, 5 BIKES) (CYCLE SENTRY COLLECTION) SURFACE MOUNT BY: VICTOR STANLEY OR APPROVED EQUAL PHONE: 800-368-2573

COLOR: POWDER COAT GALV. BLACK OWNER TO SELECT/APPROVE COLOR QUANTITY: 1



COLOR: MATT BLACK OWNER TO SELECT/APPROVE COLOR QUANTITY: 3 (NOT RECOMMENDED TO REMAIN OUTSIDE DURING WINTER MONTHS)





- LANDSCAPE CONTRACTOR SHALL VISIT SITE, INSPECT DISCREPANCY BETWEEN PLAN AND PLANT LIST, PLAN ARCHITECT WITH ANY CONCERNS.
- CONTRACTOR SHALL VERIFY LOCATIONS OF ALL ON SITE HIS/HER PHASE OF WORK. ELECTRIC, GAS, TELEPHONE, CABLE TELEVISION MAY BE LOCATED BY CALLING MISS DIG 1-800-482-7171. ANY DAMAGE OR INTERRUPTION RELATED ACTIVITIES WITH OTHER TRADES ON THE JOB
- TRUNKS AND SYMMETRICAL CROWNS.


- TREES WITH SAND BALLS WILL BE REJECTED.
- OF EXISTING TREES; HAND GRADE ALL LAWN AREAS WITHIN THE DRIP LINE OF EXISTING TREES.
- 13. IT IS MANDATORY THAT POSITIVE DRAINAGE IS PROVIDED
- 4. ALL PLANTING BEDS SHALL RECEIVE 4" SHREDDED
- 16. SEE SPECIFICATIONS FOR ADDITIONAL COMMENTS,



BY: LANDSCAPE FORMS OR APPROVED EQUAL



PLANTER: URBAN LONG PLANTER (FIBERGLASS, 12" WIDE X 60" LONG X 24" HT.) BY: VICTOR STANLEY OR APPROVED EQUAL PHONE: 800-368-2573

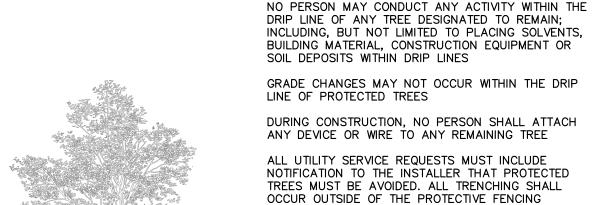

PERMALOC ALUMINUM EDGING OR APPROVED

EQUAL WITH BLACK FINISH

- COMPACTED SUBGRADE

LANDSCAPE BED EDGING SHALL BE ALUMINUM AS MANUFACTURED BY

8' OR 16' SECTIONS SHALL BE USED WITH ONE STAKE PER 38" OF

EDGING SHALL BE 3" THICK X 4" DEPTH WHEN ADJ. TO MULCH AND

STAKE SHALL SECURELY ENGAGE EDGING AND SHALL BE ENTIRELY

EDGING SHALL HAVE A MINIMUM OF 2" OF INTERLOCKING OVERLAP

INSTALL AS PER MANUFACTURER'S SPECIFICATIONS WITH TOP OF

EDGING $\frac{1}{4}$ " - $\frac{1}{2}$ " ABOVE COMPACTED FINISH GRADE. FINISH GRADE TO BE COMPACTED ON BOTH SIDES OF EDGING TO MAINTAIN STABILITY

PLANT PERENNIALS EQUAL DISTANCE IN

UNLESS NOTED OR GRAPHICALLY SHOWN

3" SHREDDED BARK MULCH. DO NOT

PILE MULCH AGAINST PLANT STEMS

SHOVEL CUT EDGE OR ALUMINUM

EDGING AS INDICATED ON PLAN

- SPECIFIED PLANTING MIX

NOTE: REMOVE ALL CONTAINERS PRIOR

PLANT SO THAT TOP OF ROOT BALL IS

SHREDDED HARDWOOD BARK MULCH 3"

_DEEP AND LEAVE 3" CIRCLE OF BARE

SOIL AROUND TRUNK. DO NOT PLACE

SPECIFIED PLANTING MIX. WATER AND

REMOVE ALL BURLAP FROM TOP 1 OF

NON-BIODEGRADABLE MATERIAL OFF SITE

PLACE ROOTBALL ON UNEXCAVATED OR

TAMP TO REMOVE AIR POCKETS

-ROOTBALL. DISCARD ALL

TAMPED SOIL

MULCH IN CONTACT WITH TRUNK

FLUSH TO GRADE OR 1-2" HIGHER IF

DO NOT COVER TOP OF ROOTBALL

FORM SAUCER WITH 4" HIGH

IN POORLY DRAINED SOILS

WITH SOIL

CONTINUOUS RIM

— FINISH GRADE

ALL SPACING IS TO BE TRIANGULAR

ALL DIRECTIONS

OTHERWISE

TO PLANTING

급" THICK X 5 ½" DEPTH WHEN ADJ. TO ROCK, FINISH: BLACK

SPECIFICATIONS FOR LANDSCAPE BED EDGING:

PERMALOC 1.800.356.9660

DURAFLEX MEETING AAMA 2603

BELOW TOP SURFACE OF EDGING

SPECIES SEE

PLAN FOR

QUANTITY

BETWEEN SECTIONS

LUMINUM EDGE DETAIL

VARIES PER SPECIES SEE

PLAN FOR

QUANTITY

PLAN VIEW

SECTION VIEW

SCALE: 1'' = 2'-0''

VARIES ON CONTAINER

SHRUB PLANTING DETAIL

OR BALL SIZE

SCALE: 1'' = 2'-0''

PERENNIAL PLANTING DETAIL

TREES LOCATED ON ADJACENT PROPERTY THAT MAY BE AFFECTED BY CONSTRUCTION ACTIVITIES MUST BE TREES TO BE PRESERVED SHALL BE IDENTIFIED WITH FLAGGING PRIOR TO THE TREE CLEARING

PROVIDE FENCE AROUND CRITICAL ROOT ZONE OF

TREE PROTECTION WILL BE ERECTED PRIOR TO START OF CONSTRUCTION ACTIVITIES AND SHALL

REMAIN IN PLACE UNTIL CONSTRUCTION IS COMPLETE

FENCE SHALL BE PLACED IN A CIRCLE WITH A MINIMUM RADIUS OF 1' PER 1" DIAMETER OF THE TREE MEASURED AT 4.5' ABOVE GROUND

4'HIGH PROTECTIVE FENCING WITH STEEL POSTS - 10' O.C. - EXISTING SOIL

TREE PROTECTION DETAIL

SCALE: 1'' = 3'-0''

STAKING/GUYING

LOCATION

MIN. TYP.

SCALE: 1'' = 3'-0''



GROUP

t: 844.813.2949

www.peagroup.com

ARCHITECT

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THREE 2"X2" HARDWOOD STAKES OR STEEL T-POSTS DRIVEN A MIN. OF 18" DEEP FIRMLY INTO SUBGRADE PRIOR TO SHREDDED HARDWOOD BARK MULCH TO DRIPLINE. 3" DEEP AND LEAVE 3" CIRCLE OF CLIENT BARE SOIL AROUND TREE TRUNK. DO NOT PLACE MULCH IN CONTACT WITH TREE TRUNK. FORM SAUCER WITH 4" HIGH

PLANT SO THAT TOP OF ROOT BALL IS

POORLY DRAINED SOILS

FLUSH TO GRADE OR 1-2" HIGHER IF IN

STAKE JUST BELOW BRANCHES WITH 2"-3"

WIDE NYLON OR PLASTIC STRAPS. CONNECT

FLEXIBILITY. REMOVE AFTER (1) ONE YEAR.

FROM TREE TO STAKE AND ALLOW FOR

(DO NOT USE WIRE & HOSE)

CONTINUOUS RIM

- FINISH GRADE SPECIFIED PLANTING MIX. WATER & TAMP TO - REMOVE AIR POCKETS, ÁMEND SOIL PER SITE CONDITIONS & TREE REQUIREMENTS EXPOSE ROOT FLARE OF TREE. CONTRACTOR MAY HAVE TO REMOVE EXCESS SOIL FROM TOP OF ROOTBALL. REMOVE ALL BURLAP FROM TOP 3 OF ROOTBALL. DISCARD ALL NON-BIODEGRADABLE MATERIAL OFF SITE

PLACE ROOTBALL ON UNEXCAVATED OR



6/16/21

7/21/21

2019-007

RLS

REVISIONS


CITY COMMENTS

CITY COMMENTS

ROCHESTER AVON

PARTNERS, LLC

BIRMINGHAM, MICHIGAN, 48009

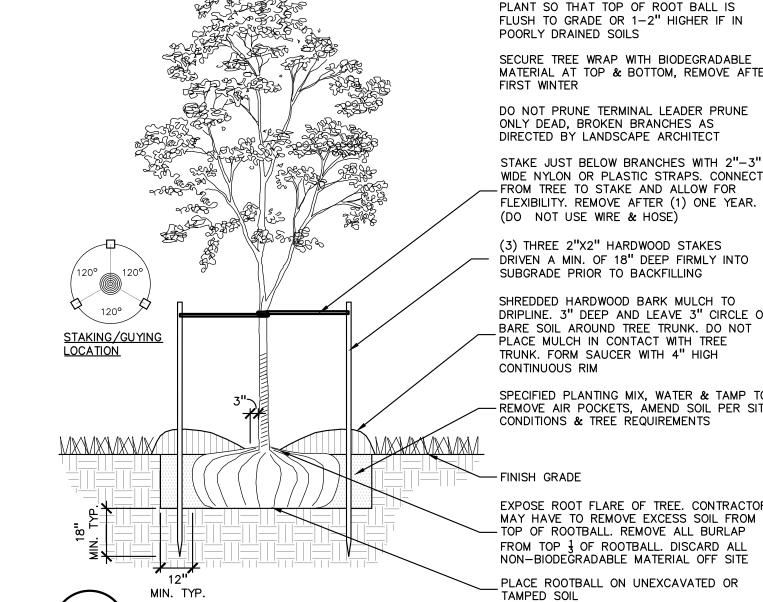

EVERGREEN TREE PLANTING DETAIL

PLANT SO THAT TOP OF ROOT BALL IS FLUSH TO GRADE OR 1-2" HIGHER IF IN POORLY DRAINED SOILS SECURE TREE WRAP WITH BIODEGRADABLE

MATERIAL AT TOP & BOTTOM, REMOVE AFTER FIRST WINTER DO NOT PRUNE TERMINAL LEADER PRUNE

ONLY DEAD, BROKEN BRANCHES AS DIRECTED BY LANDSCAPE ARCHITECT

FLEXIBILITY. REMOVE AFTER (1) ONE YEAR. (DO NOT USE WIRE & HOSE) (3) THREE 2"X2" HARDWOOD STAKES

DRIVEN A MIN. OF 18" DEEP FIRMLY INTO SUBGRADE PRIOR TO BACKFILLING

SHREDDED HARDWOOD BARK MULCH TO DRIPLINE. 3" DEEP AND LEAVE 3" CIRCLE OF BARE SOIL AROUND TREE TRUNK. DO NOT PLACE MULCH IN CONTACT WITH TREE TRUNK. FORM SAUCER WITH 4" HIGH CONTINUOUS RIM

SPECIFIED PLANTING MIX, WATER & TAMP TO - REMOVE AIR POCKETS, AMEND SOIL PER SITE CONDITIONS & TREE REQUIREMENTS

-FINISH GRADE EXPOSE ROOT FLARE OF TREE. CONTRACTOR MAY HAVE TO REMOVE EXCESS SOIL FROM - TOP OF ROOTBALL. REMOVE ALL BURLAP

FROM TOP 3 OF ROOTBALL. DISCARD ALL NON-BIODEGRADABLE MATERIAL OFF SITE PLACE ROOTBALL ON UNEXCAVATED OR

DN. DES. DRAWING NUMBER:

ORIGINAL ISSUE DATE:

LANDSCAPE

DETAILS

MAY 10, 2021


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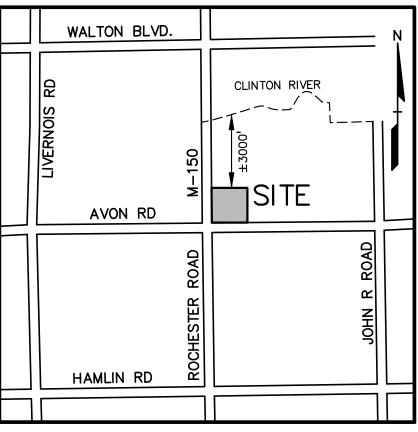
PEA JOB NO.

P.M.


DECIDUOUS TREE PLANTING DETAIL

NOT FOR CONSTRUCTION CITY FILE #21-007 SECTION #14 XREF: S:\PROJECTS\2019\2019-007\DWG\SITE PLANS\CBASE-19007.dwg
XREF: S:\PROJECTS\2019\2019-007\DWG\SITE PLANS\TBLK-19007.dwg



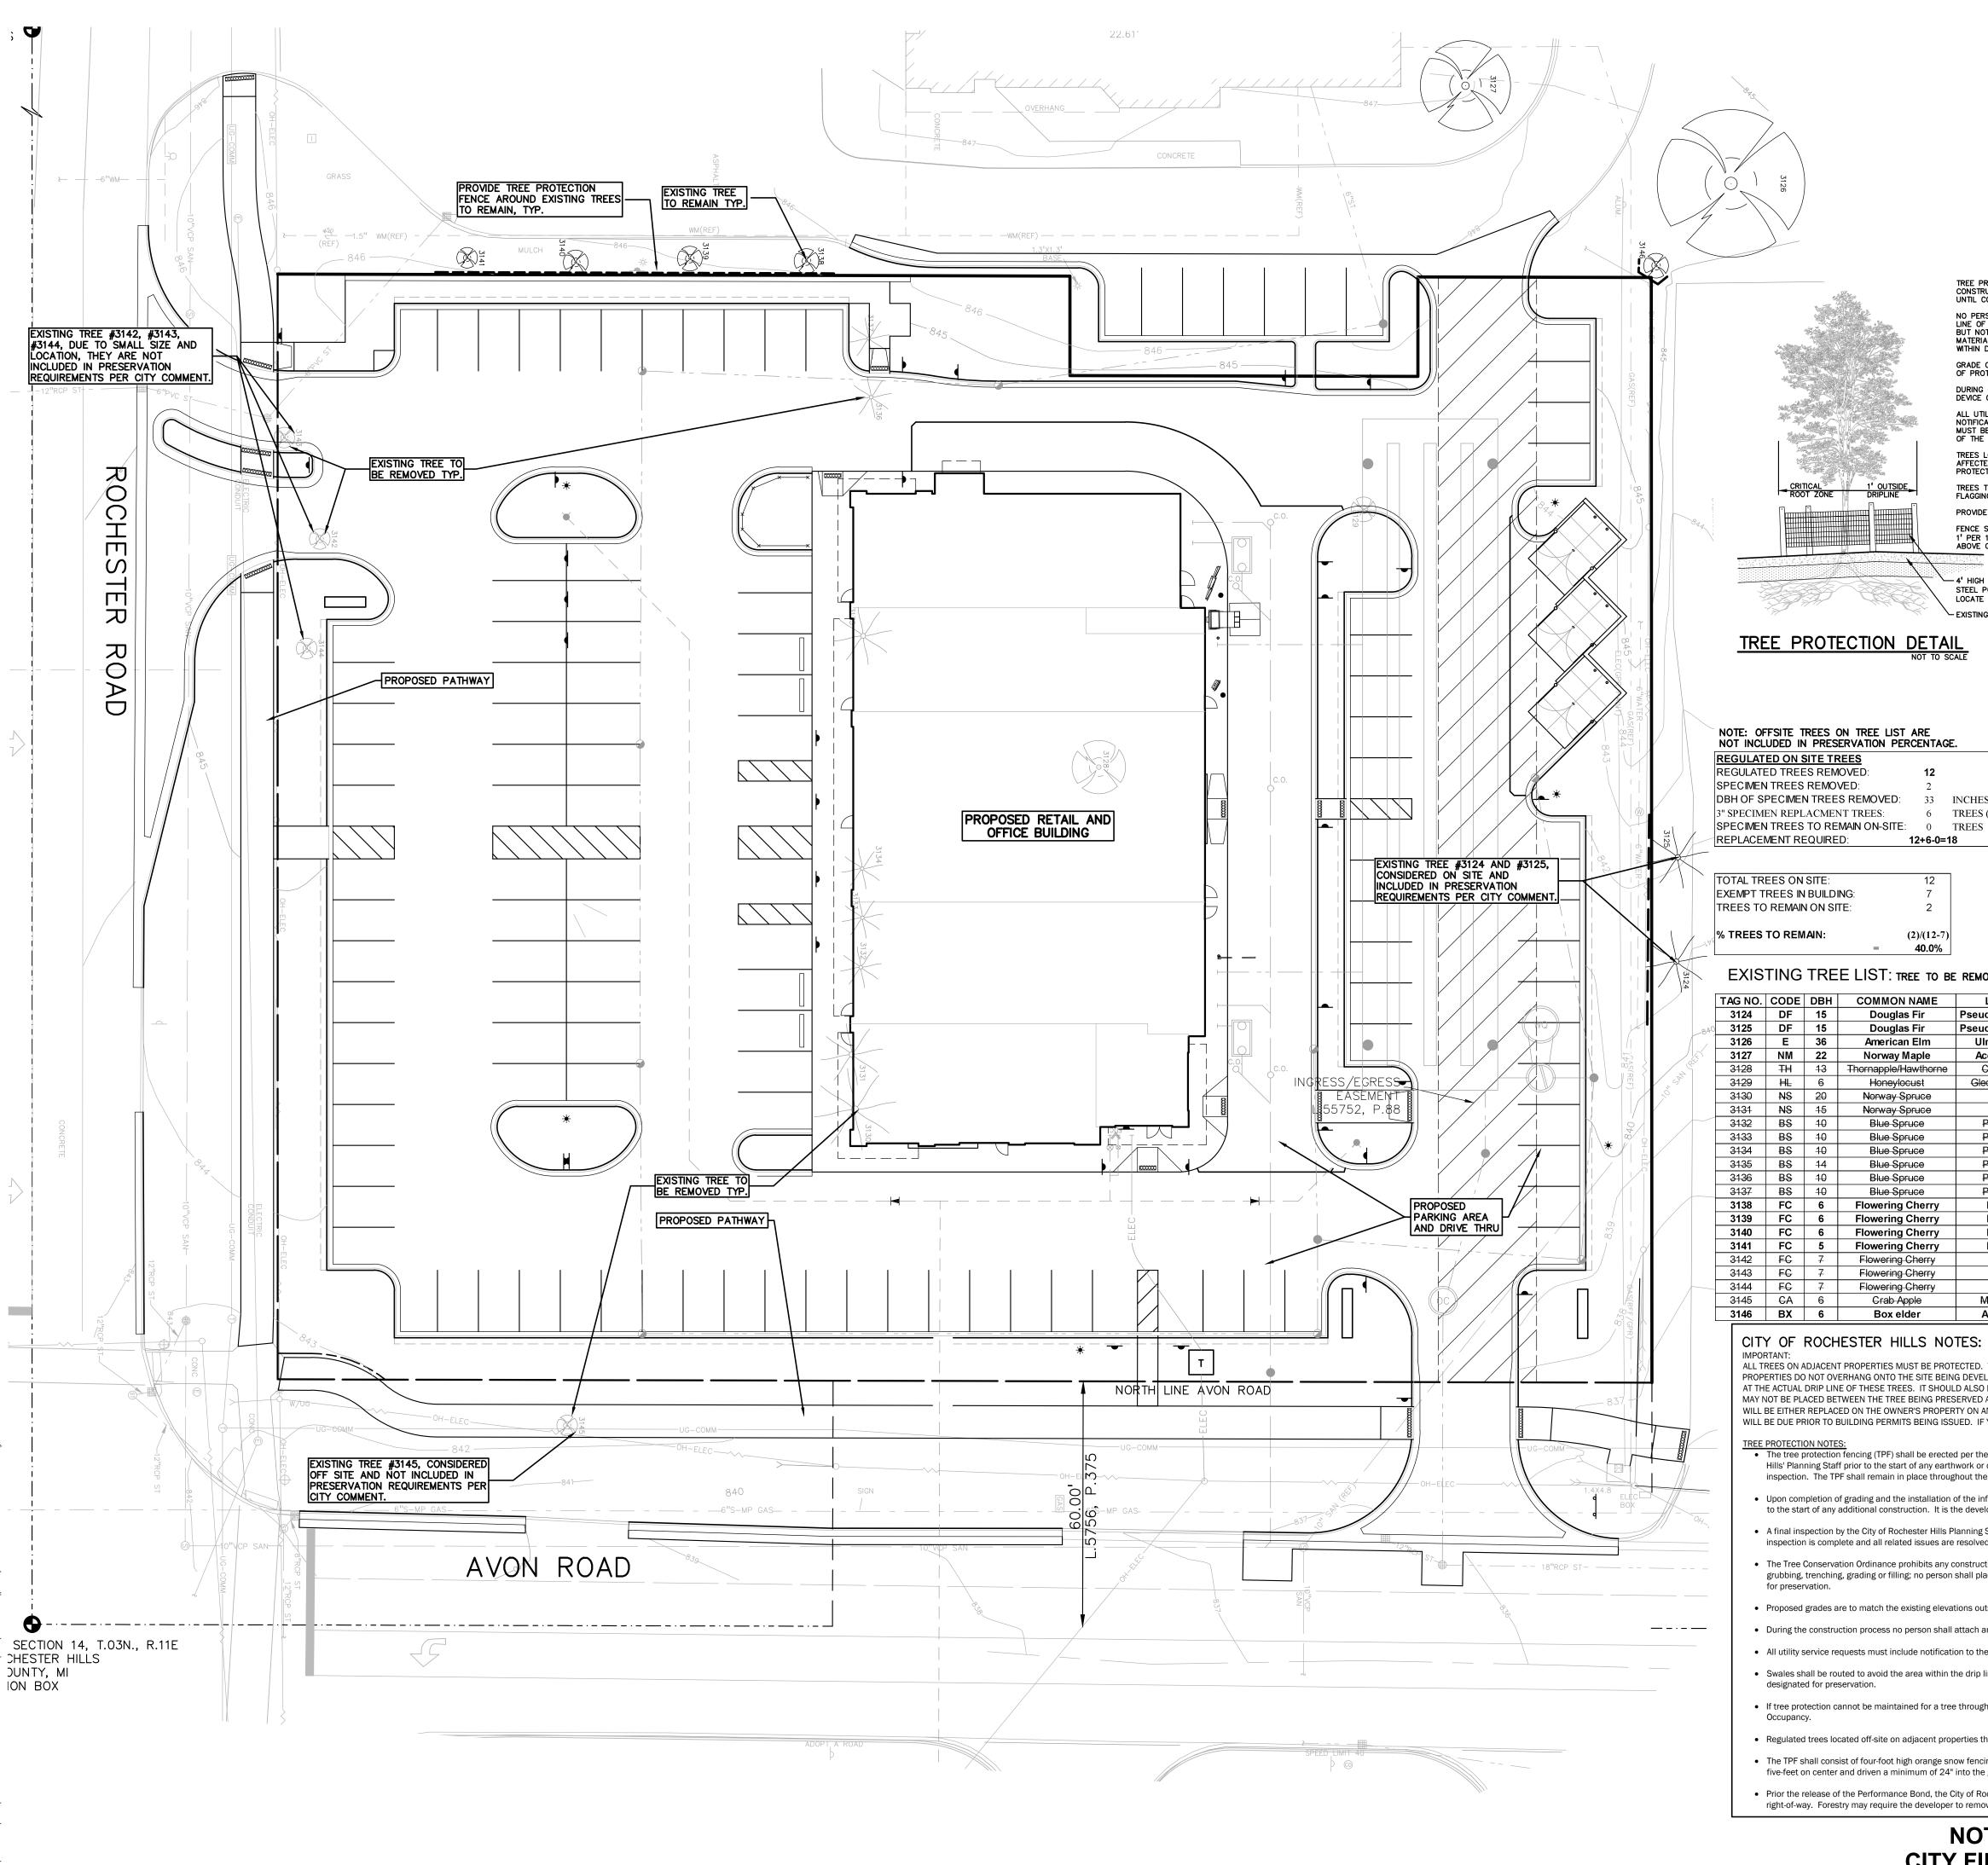

LOCATION MAP - NOT TO SCALE

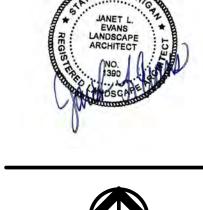

t: 844.813.2949 www.peagroup.com

KEY = EXISTING TREES TO REMAIN WITH TREE PROTECTION FENCING

= EXISTING TREES TO BE REMOVED

NATURAL FEATURES STATEMENT:

STEEP SLOPE: THE SITE DOES NOT CONTAIN REGULATED STEEP SLOPES. | WETLANDS: | THE SITE DOES NOT CONTAIN REGULATED WETLANDS OR

THE LOCATIONS AND ELEVATIONS OF EXISTING UNDER JTILITIES AS SHOWN ON THIS DRAWING ARE ONLY

APPROXIMATE. NO GUARANTEE IS EITHER EXPRESSED OR IMPLIED AS TO THE COMPLETENESS OR ACCURACY THEREOF THE CONTRACTOR SHALL BE EXCLUSIVELY RESPONSIBLE FOR DETERMINING THE EXACT UTILITY LOCATIONS AND ELEVATIONS PRIOR TO THE START OF CONSTRUCTION.

CAUTION!!

SCALE: 1" = 20'

NATURAL FEATURES SETBACK: THE SITE DOES NOT CONTAIN NATURAL FEATURE SETBACKS.

TREE PRESERVED.

TREE REPLACEMENT CALCULATIONS
PER CITY OF ROCHESTER HILLS ZONING ORDINANCE 33 INCHES = 17 REPLACEMENT INCHES 6 TREES (3" DECIDUOUS OR 8' EVERGREEN) REPLACEMENT TREES:
REQUIRED: 1, 2" DEC. TREE OR 8' EVG PER REGULATED TREE TREES (3" DECIDUOUS OR 8' EVERGREE REMOVED. 2" TREE REPLACEMENT CREDIT FOR EACH SPECIMEN

> REQUIRED: 18, 3" OR 8' EVG. REPLACEMENT TREES SEE SHEET L-1.0 FOR TREE REPLACEMENTS

EXISTING TREE LIST: TREE TO BE REMOVED DENOTED WITH STRIKE OUT THROUGH TREE NUMBER

TREE PROTECTION WILL BE ERECTED PRIOR TO START OF CONSTRUCTION ACTIVITIES AND SHALL REMAIN IN PLACE UNTIL CONSTRUCTION IS COMPLETE.

NO PERSON MAY CONDUCT ANY ACTIVITY WITHIN THE DRIP LINE OF ANY TREE DESIGNATED TO REMAIN; INCLUDING, BUT NOT LIMITED TO PLACING SOLVENTS, BUILDING MATERIAL, CONSTRUCTION EQUIPMENT OR SOIL DEPOSITS WITHIN DRIP LINES.

GRADE CHANGES MAY NOT OCCUR WITHIN THE DRIP LINE OF PROTECTED TREES.

DURING CONSTRUCTION, NO PERSON SHALL ATTACH ANY DEVICE OR WIRE TO ANY REMAINING TREE.

ALL UTILITY SERVICE REQUESTS MUST INCLUDE NOTIFICATION TO THE INSTALLER THAT PROTECTED TREES MUST BE AVOIDED. ALL TRENCHING SHALL OCCUR OUTSIDE OF THE PROTECTIVE FENCING.

TREES LOCATED ON ADJACENT PROPERTY THAT MAY BE AFFECTED BY CONSTRUCTION ACTIVITIES MUST BE

PROVIDE FENCE AROUND CRITICAL ROOT ZONE OF TREE. FENCE SHALL BE PLACED IN A CIRCLE WITH A RADIUS OF 1' PER 1" DIAMETER OF THE TREE MEASURED AT 4.5' ABOVE GROUND.

- 4' HIGH PROTECTIVE FENCING WITH

LOCATE FENCE 1' OUTSIDE DRIPLINE.

STEEL POSTS - 10' O.C.

EXISTING SOIL

12+6-0=18

	TAG NO.	CODE	DBH	COMMON NAME	LATIN NAME	CONDITION	NOTES	EXEMPT?	SPECIMEN	SAVE / REMOVE	OFFSITE/ NIC	IN BULDIN
	3124	DF	15	Douglas Fir	Pseudotsuga menziesii	FAIR			N	S	N	N
-840	3125	DF	15	Douglas Fir	Pseudotsuga menziesii	FAIR			N	S	N	N
/ ,	3126	Е	36	American Elm	Ulmus americana	GOOD			Υ	S	Υ	N
\preceq	3127	NM	22	Norway Maple	Acer platanoides	GOOD			Υ	S	Υ	N
,	3128	ŦH	13	Thornapple/Hawthorne	Crataegus spp.	FAIR			¥	R	N	¥
	3129	HL	6	Honeylocust	Gleditsia triacanthos	POOR			N	R	N	N
	3130	NS	20	Norway Spruce	Picea Abies	POOR			¥	R	N	¥
	3131	NS	15	Norway Spruce	Picea Abies	FAIR			N	R	N	¥
	3132	BS	10	Blue Spruce	Picea pungens	FAIR			И	R	И	¥
	3133	₿Ş	10	Blue Spruce	Picea pungens	FAIR			N	R	И	¥
	3134	₿Ş	10	Blue Spruce	Picea pungens	FAIR			N	R	N	¥
	3135	BS	14	Blue Spruce	Picea pungens	FAIR			И	R	И	¥
	3136	BS	10	Blue Spruce	Picea pungens	FAIR			N	R	N	N
	3137	₿Ş	10	Blue Spruce	Picea pungens	FAIR			N	R	И	N
	3138	FC	6	Flowering Cherry	Prunus spp.	GOOD			N	S	Y	N
	3139	FC	6	Flowering Cherry	Prunus spp.	GOOD			N	S	Υ	N
	3140	FC	6	Flowering Cherry	Prunus spp.	GOOD			N	S	Y	N
	3141	FC	5	Flowering Cherry	Prunus spp.	GOOD			N	S	Υ	N
	3142	FC	7	Flowering Cherry	Prunus spp.	FAIR			N	R	¥	H
	3143	FC	7	Flowering Cherry	Prunus spp.	GOOD			N	R	¥	И
	3144	FC	7	Flowering Cherry	Prunus spp.	POOR			И	R	¥	Н
	3145	CA	6	Crab Apple	Malus caronaria	FAIR			И	R	¥	И
	3146	вх	6	Box elder	Acer negundo	POOR	Х3		N	S	Υ	N

CITY OF ROCHESTER HILLS NOTES:

ALL TREES ON ADJACENT PROPERTIES MUST BE PROTECTED. THE TREE PROTECTIVE FENCING MAY BE PLACED ALONG THE ACTUAL PROPERTY LINE IF THE BRANCHES OF THE TREES ON THE ADJACENT PROPERTIES DO NOT OVERHANG ONTO THE SITE BEING DEVELOPED. IF THE BRANCHES OVERHANG ONTO THE AREA OF THE SITE BEING DEVELOPED, THE TREE PROTECTIVE FENCING MUST BE PLACED AT THE ACTUAL DRIP LINE OF THESE TREES. IT SHOULD ALSO BE NOTED THAT THE SILT FENCING MUST BE PLACED ON THE DEVELOPMENT SIDE OF THE TREE PROTECTIVE FENCING. THE SILT FENCING MAY NOT BE PLACED BETWEEN THE TREE BEING PRESERVED AND THE TREE PROTECTIVE FENCING. IF ANY REGULATED TREES ARE MANAGED ON THE ADJACENT PROPERTIES, THE DAMAGED TREES WILL BE EITHER REPLACED ON THE OWNER'S PROPERTY ON AN INCH FOR INCH BASIS OR A FINE IN THE SUM OF \$122.00 PER CALIPER INCH WILL BE ISSUED AGAINST THE DEVELOPMENT. THIS FINE WILL BE DUE PRIOR TO BUILDING PERMITS BEING ISSUED. IF YOU HAVE ANY QUESTIONS OR NEED ADDITIONAL INFORMATION, CALL THE CITY'S PLANNING DEPARTMENT AT 248-656-4660.

- The tree protection fencing (TPF) shall be erected per the plans approved by the City of Rochester Hills Planning Department. The TPF must be in place and be inspected by the City of Rochester Hills' Planning Staff prior to the start of any earthwork or construction operations. It is the developer's responsibility to contact the City Planning Department at 248-656-4660 to schedule a TPF inspection. The TPF shall remain in place throughout the entire construction process or until the City authorizes the removal or issues a final Certificate of Occupancy, whichever occurs first.
- Upon completion of grading and the installation of the infrastructure, a second inspection of the TPF and the trees designated for preservation is required by the City of Rochester Hills' Forester prior to the start of any additional construction. It is the developer's responsibility to contact the City Planning Department at 248-656-4660 to schedule this TPF inspection.
- A final inspection by the City of Rochester Hills Planning Staff is required at the end of the warranty and maintenance period. The Landscape Maintenance Bond will not be released until this inspection is complete and all related issues are resolved. It is the developer's responsibility to contact the City Planning Department at 248-656-4660 to schedule this inspection.
- The Tree Conservation Ordinance prohibits any construction or development activities within the drip line of any regulated trees not approved for removal, including, but not limited to, land clearing, grubbing, trenching, grading or filling; no person shall place any solvents, building material, construction equipment, soil deposits or harmful materials within the drip line limit of trees designated
- Proposed grades are to match the existing elevations outside the limits of the TPF. No grading either cut or fill is permitted within the drip line of any tree designated for preservation.
- During the construction process no person shall attach any device or wire/cable/card/rope to an existing tree designated to be preserved.
- All utility service requests must include notification to the installer that protected trees must be avoided. All trenching shall occur outside the TPF.
- Swales shall be routed to avoid the area within the drip line of the only tree designated for preservation. Swales shall be constructed so as to not direct any additional flow into the drip line of a tree
- If tree protection cannot be maintained for a tree throughout entire period required, the replacement of that tree will be required on an inch for inch basis prior to the issuance of any Certificate of
- Regulated trees located off-site on adjacent properties that may be affected by construction operations must be protected defined herein.
- The TPF shall consist of four-foot high orange snow fencing to be installed around the drip line of all trees designated to be saved. This fencing shall be supported by six-foot metal T-bar posts five-feet on center and driven a minimum of 24" into the ground. The PTF fencing shall remain upright and securely in place for the required time as specified above.
- Prior the release of the Performance Bond, the City of Rochester Hills Forestry Division needs to inspect all trees existing or planted, to identify any that pose a hazard to the safe use of the public right-of-way. Forestry may require the developer to remove and possibly replace any such trees.

NOT FOR CONSTRUCTION
CITY FILE #21-007 SECTION #14 XREF: S: \PROJECTS\2019\2019-007\DWG\TOPOBASE-19007.dwg
XREF: S: \PROJECTS\2019\2019-007\DWG\SITE PLANS\CBASE-19007.dwg
XREF: S: \PROJECTS\2019\2019-007\DWG\SITE PLANS\CBASE-19007.dwg
XREF: S: \PROJECTS\2019\2019-007\DWG\SITE PLANS\CBASE-19007.dwg

CLIENT

ROCHESTER AVON PARTNERS, LLC 251 EAST MERRILL STRÉET, SUITE #205 BIRMINGHAM, MICHIGAN, 48009

PROJECT TITLE

RETAIL REDEVELOPMEN' N.E.C. ROCHESTER ROAD & AVON ROAD


REVISIONS	
CITY COMMENTS	6/16/21
CITY COMMENTS	7/21/21

ORIGINAL ISSUE DATE: MAY 10, 2021


DRAWING TITLE

TREE PRESERVATION PLAN


PEA JOB NO.	2019-007
P.M.	RLS
DN.	JE
DES.	JE

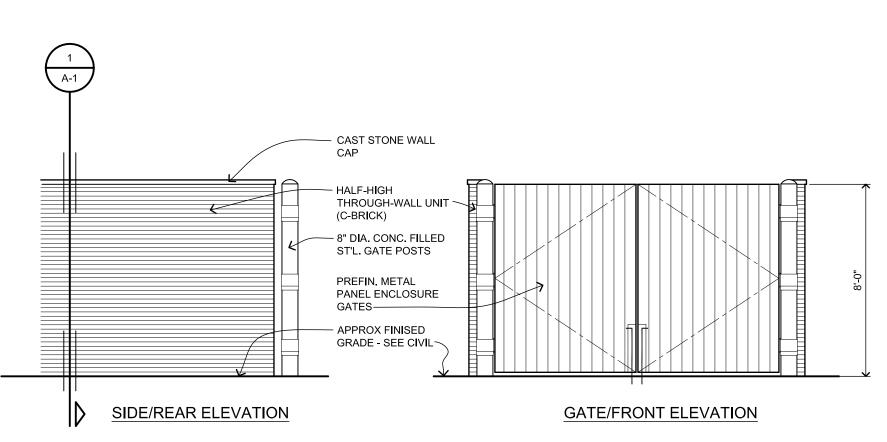

Dumpster Enclosure Elevations 1/4" = 1'-0"

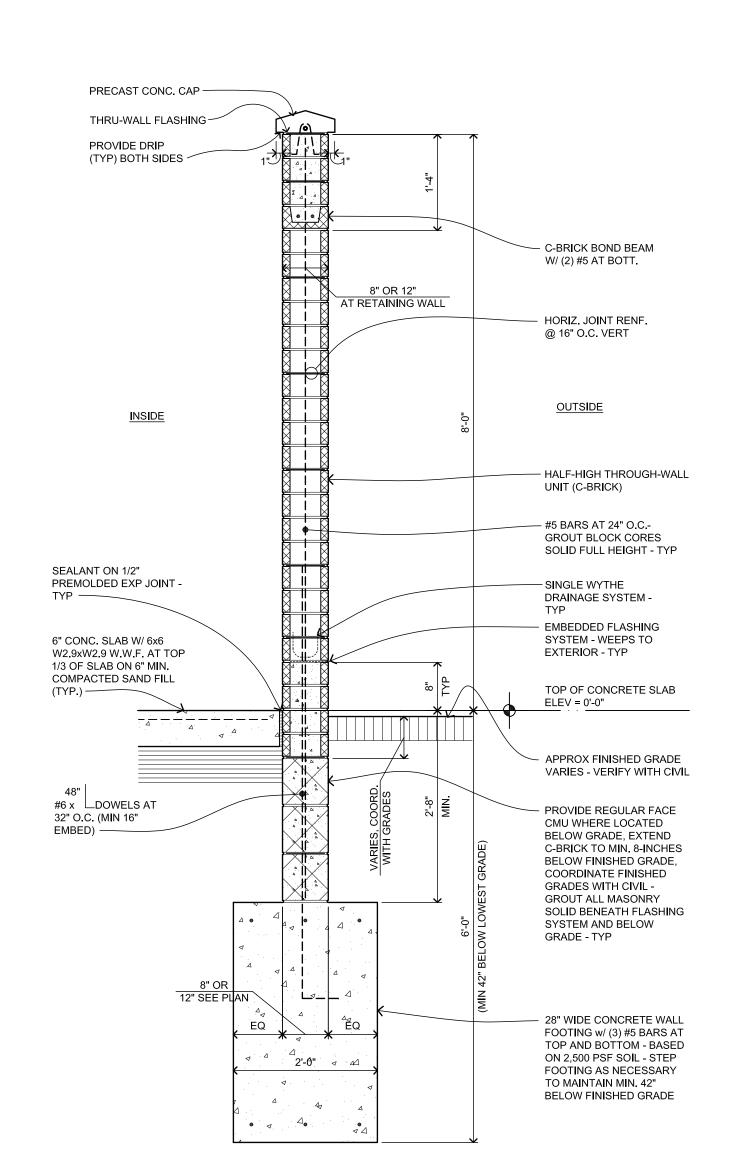


Dumpster Enclosure Wall Section 3/4" = 1'-0"

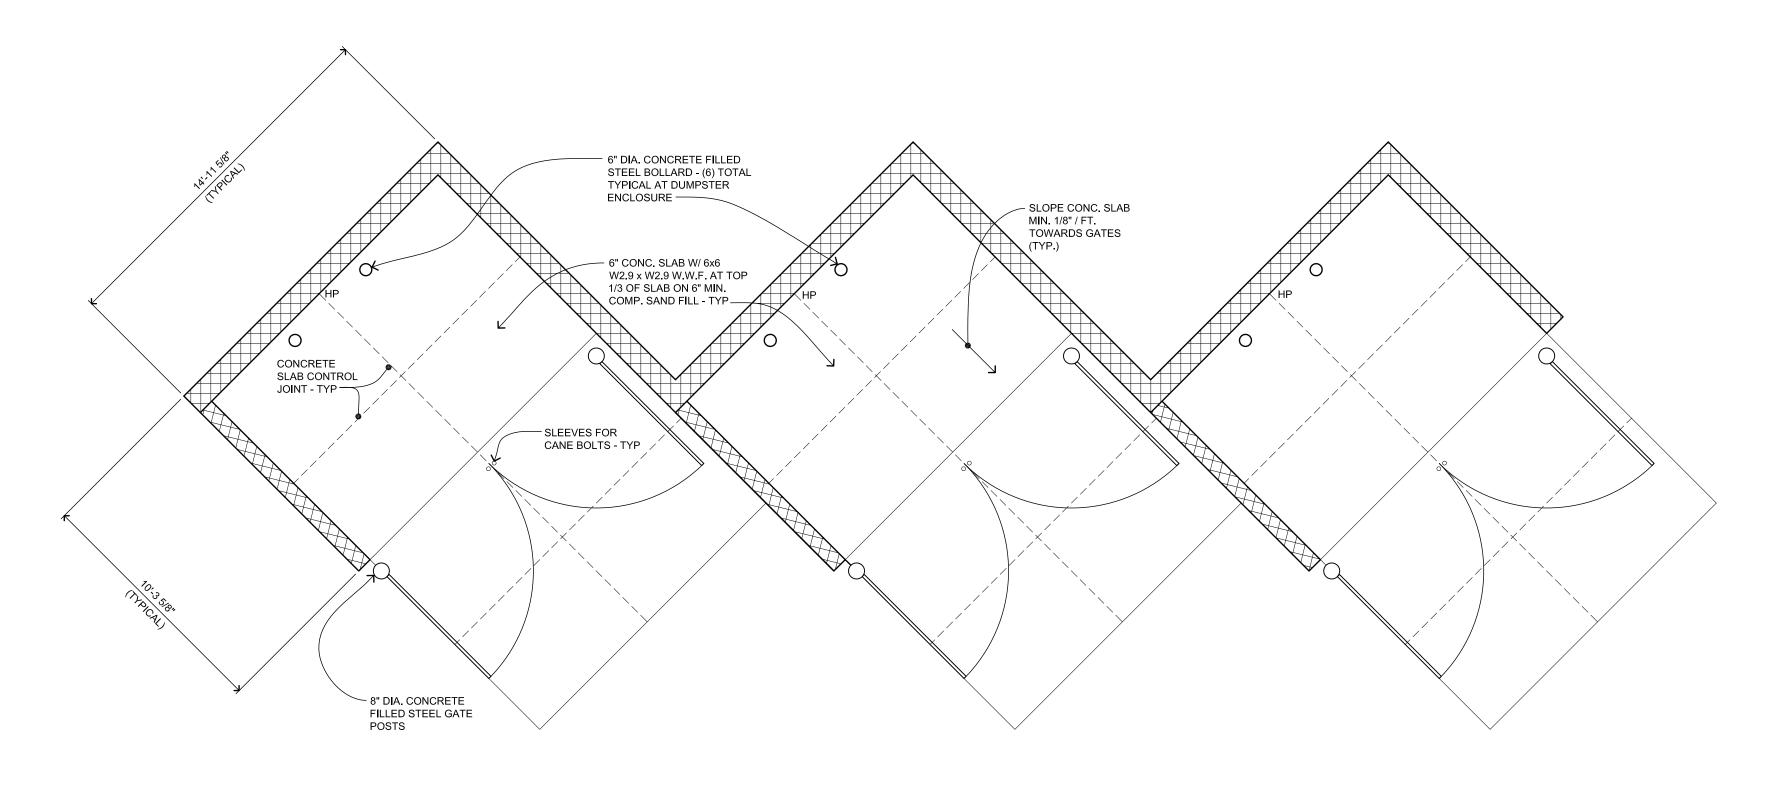

Dumpster Enclosure Plan View

SEE SITE PLAN FOR ORIENTATION AND LOCATION, TYP. Scale: 1/4"=1'-0"

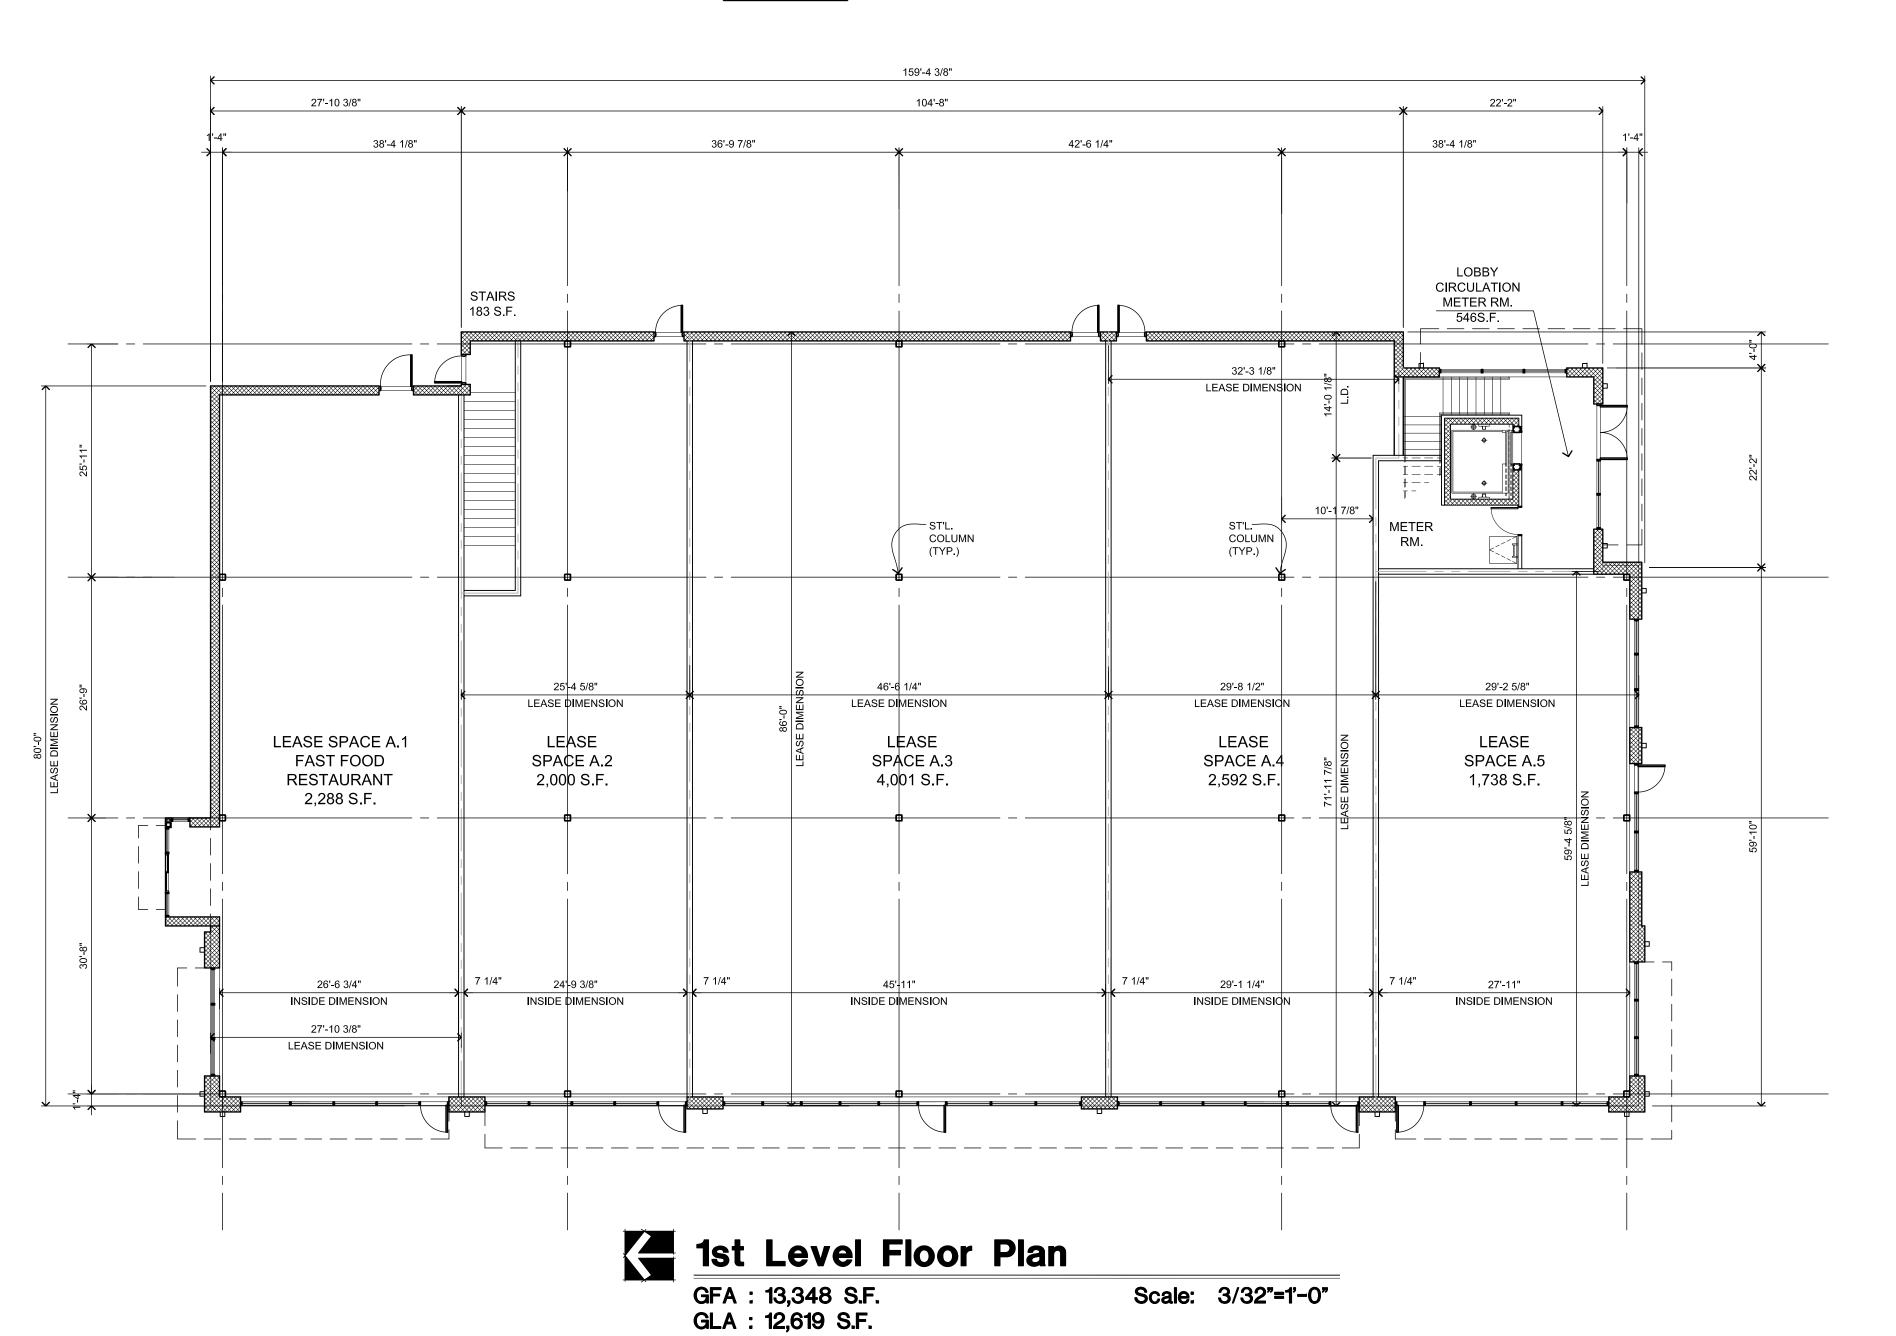

ISSUED FOR:

OWNER REVIEW: 11 SEPT. 2020

OWNER REVIEW: 01 FEB. 2021

OWNER REVIEW: 10 FEB. 2021

OWNER REVIEW: 11 FEB. 2021

OWNER REVIEW: 08 MAR. 2021

OWNER REVIEW: 19 APR. 2021

OWNER REVIEW: 20 APR. 2021

OWNER REVIEW: 22 APR. 2021

SITE PLAN REVIEW: 05 MAY 2021

project:

Commercial Development



32500 TELEGRAPH ROAD SUITE 250 BINGHAM FARMS, MICHIGAN 48025-2404

PH 248.540.7700 FX 248.540.2710 www.rogvoy.com



drawing:

First Level Floor Plan

DO NOT SCALE DRAWING


issue date:
drawn: KL
checked: MD
approved: MD

file number:

shoo

A-1

© COPYRIGHT 2015: ROGVOY ARCHITECTS, P.C.

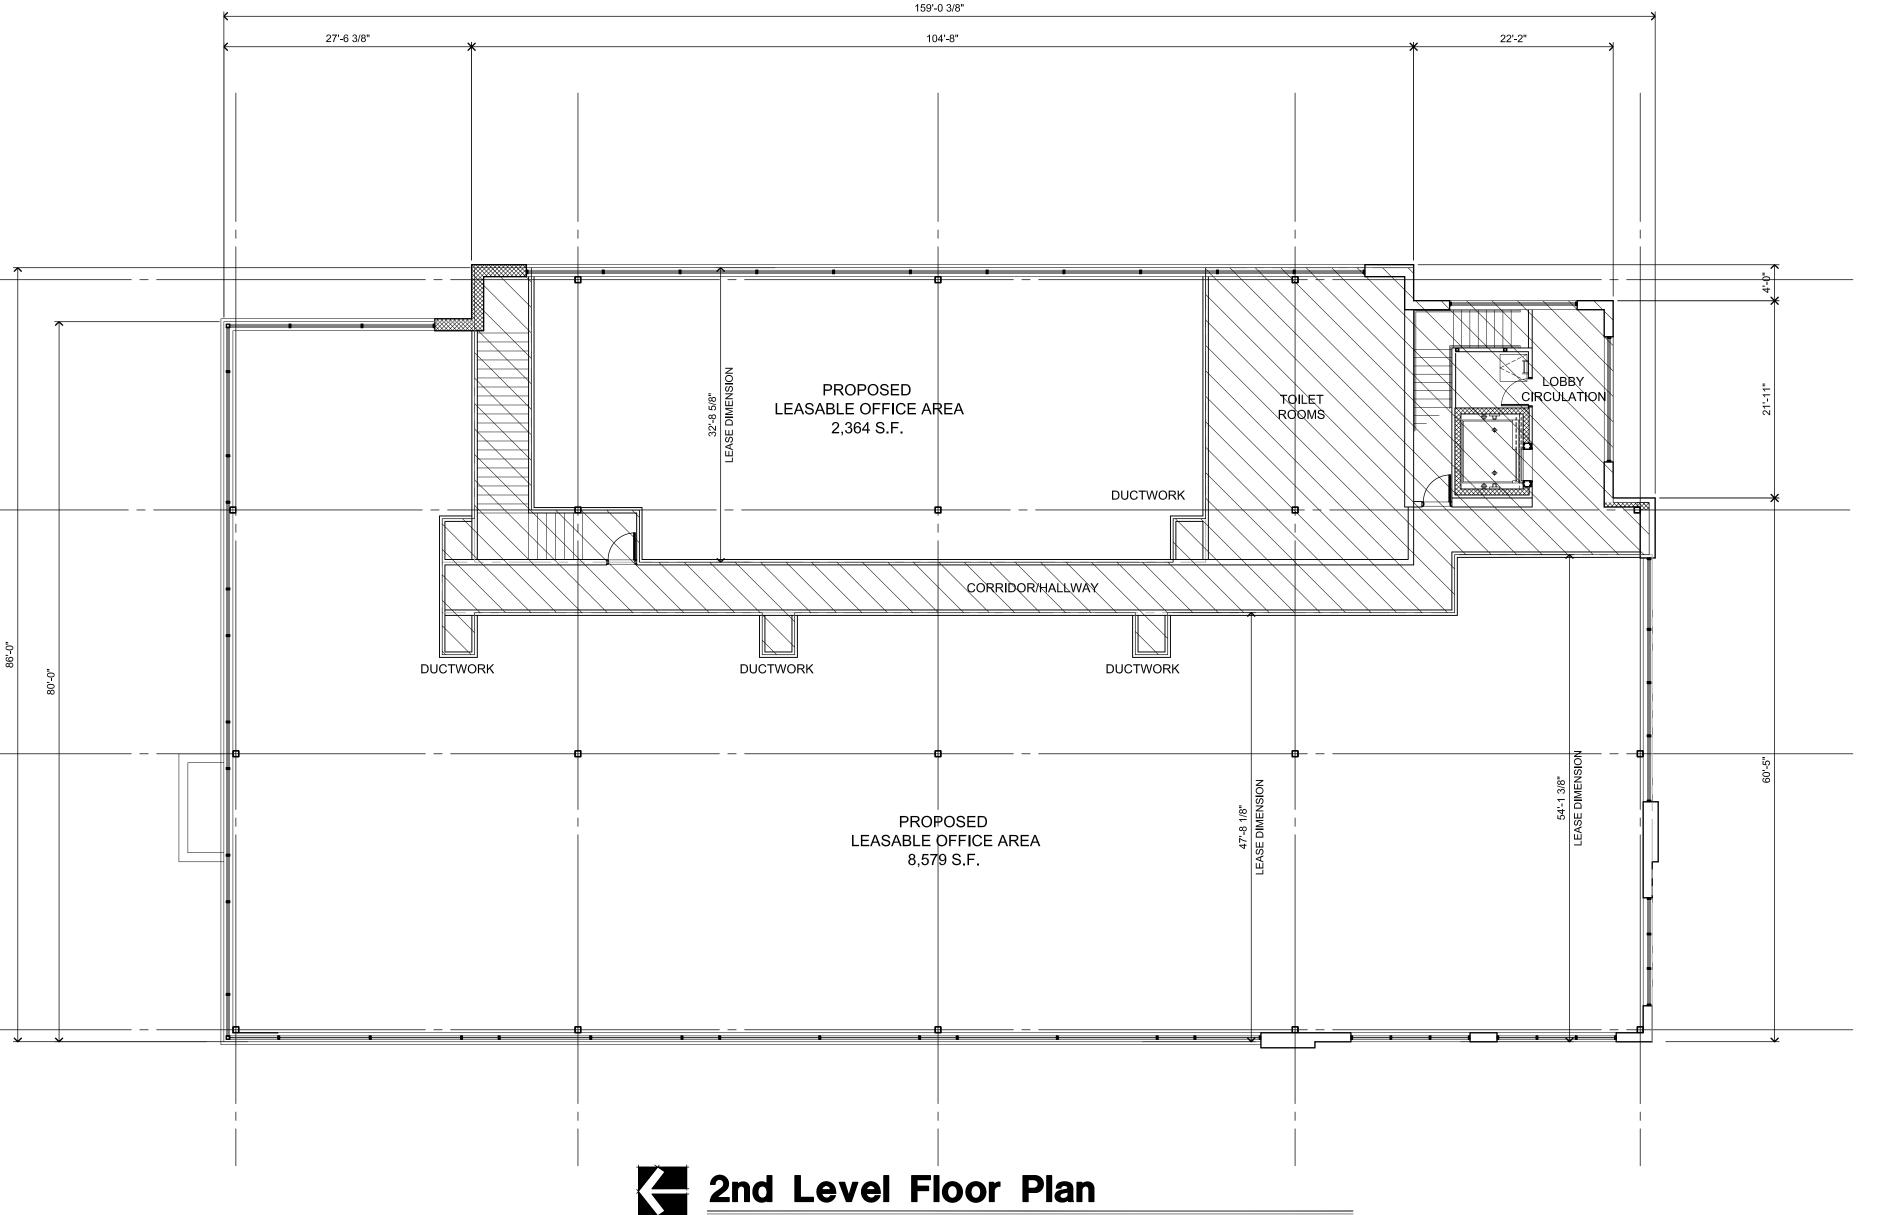

GFA: 13,288 S.F.

GLA: 10,943 S.F.

issued for:

OWNER REVIEW: 17 SEPT. 2020 OWNER REVIEW: Ø1 FEB. 2021 OWNER REVIEW: 11 FEB. 2021 SITE PLAN REVIEW: Ø5 MAY 2021 SITE PLAN REVIEW: 15 JUN. 2021 SITE PLAN REVIEW: 21 JUL. 2021

velopment ommerc

ARCHITECT S

32500 TELEGRAPH ROAD SUITE 250 BINGHAM FARMS, MICHIGAN 48025-2404

PH 248.540.7700 FX 248.540.2710 www.rogvoy.com




drawing:

Second Level Floor Plan

DO NOT SCALE DRAWING

issue date: drawn: KL checked: MD approved: MD

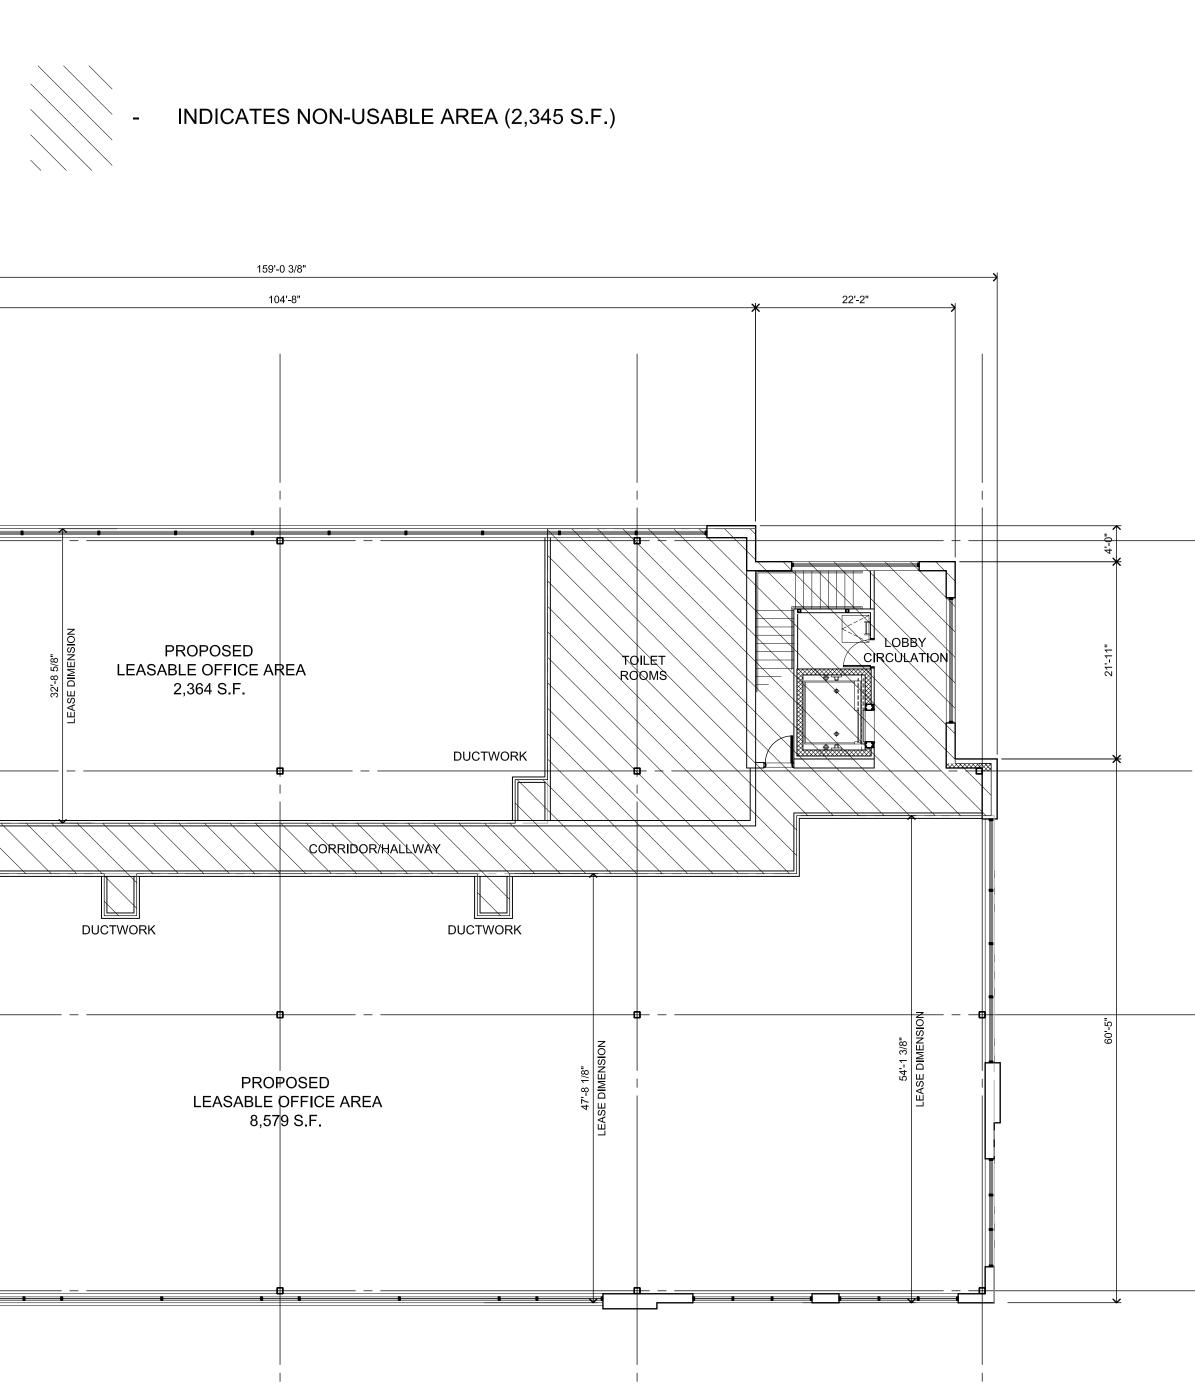

Scale: 3/32"=1'-0"


ALUMINUM WALL PANEL: ALUCABOND COLOR: 'CHAMPAGNE METALLIC'




BRICK: ALUCABOND COLOR: BRICK TECH ENDICOTT COLOR: 'MANGANESE IRON SPOT'

First floor non-residential transparency must equal 70% measured between 2-8 ft. above the sidewalk. The Planning Commission can modify this requirement per Section 138-8.604.


STONE: CULTURED STONE COUNTRY LEDGESTONE COLOR: 'ASHFALL'

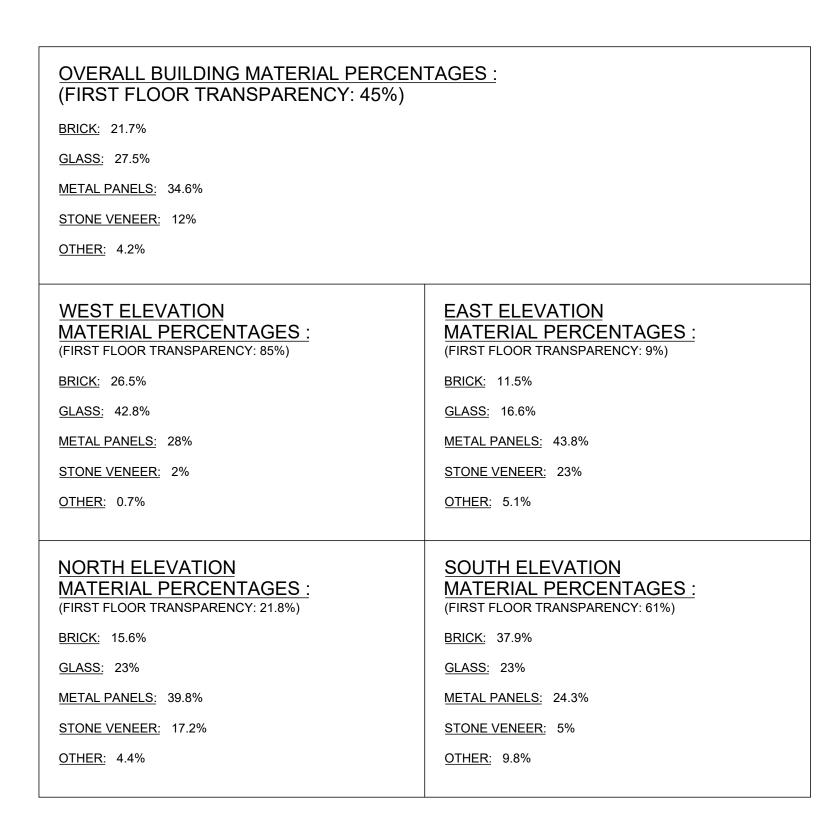

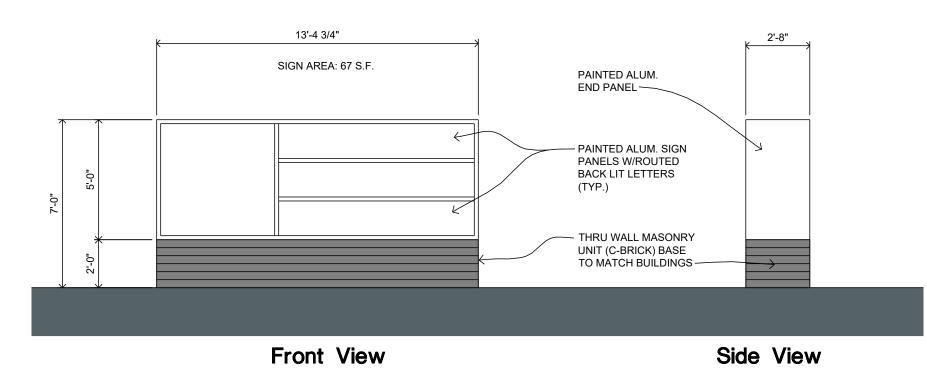


Monument Sign - Avon Rd.

Scale: 1/4"=1'-0"

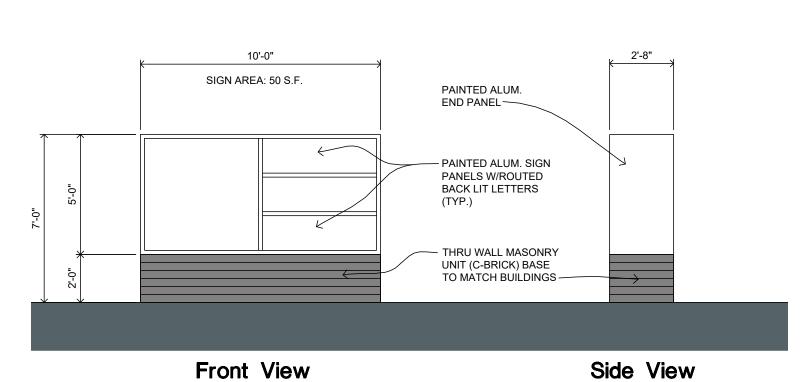

Monument Sign - Rochester Rd.

Scale: 1/4"=1'-0"

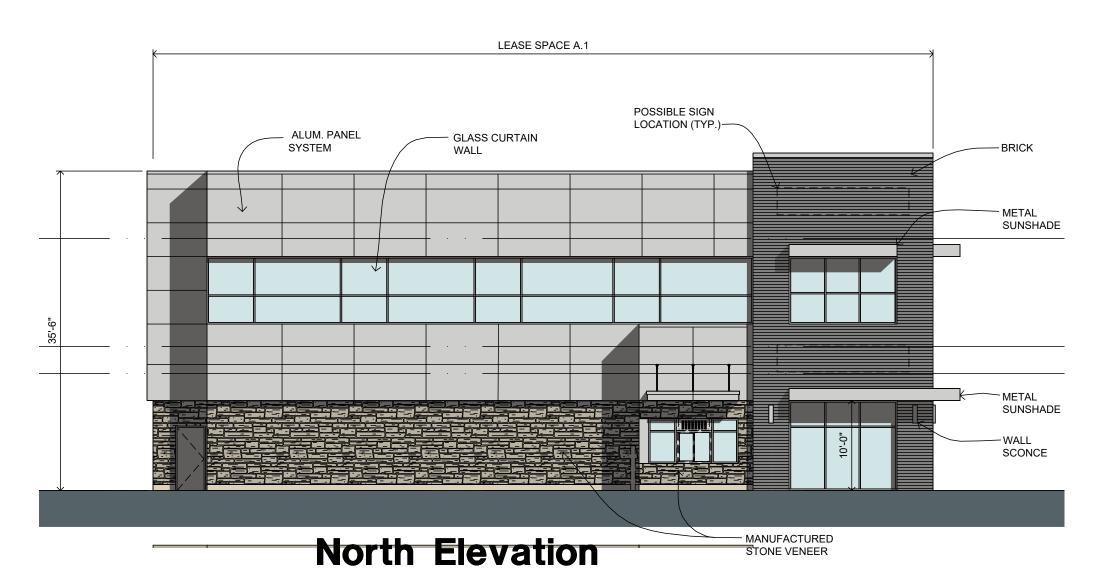



Scale: 3/32"=1'-0"



South Elevation

Scale: 3/32"=1'-0"

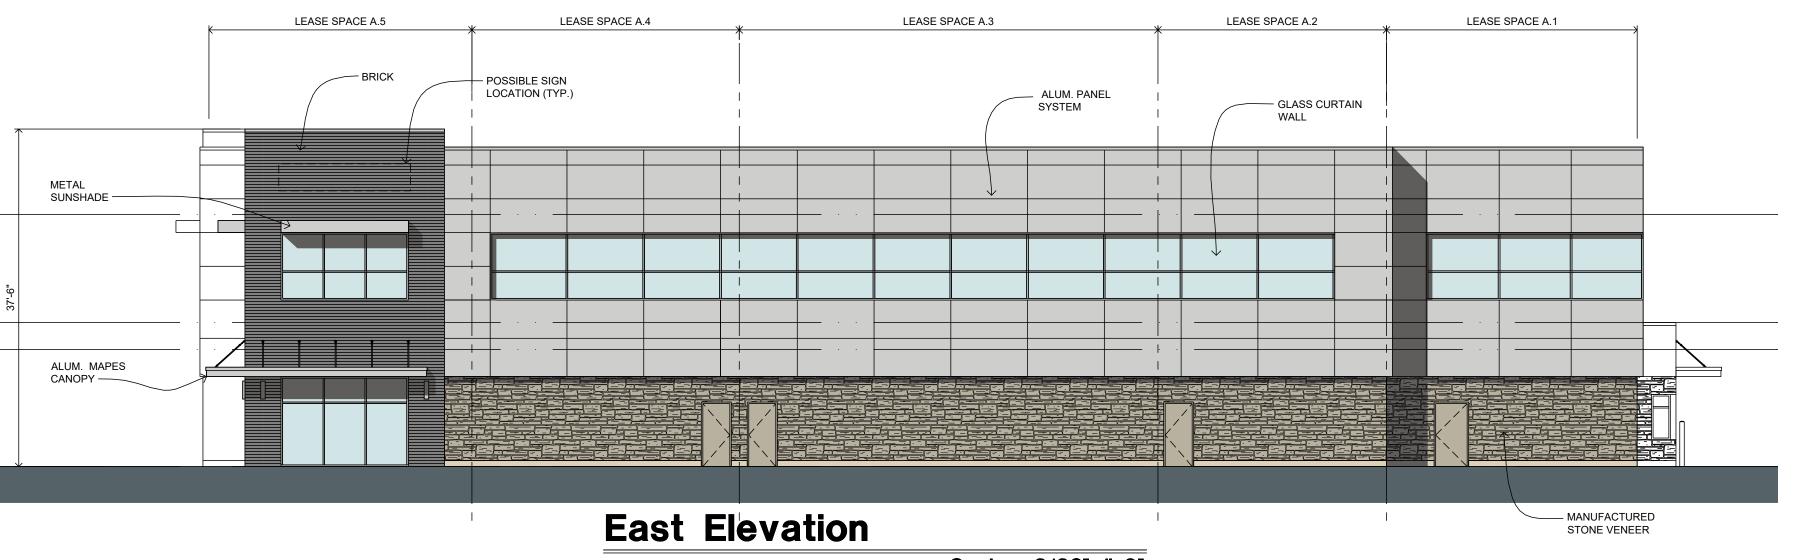

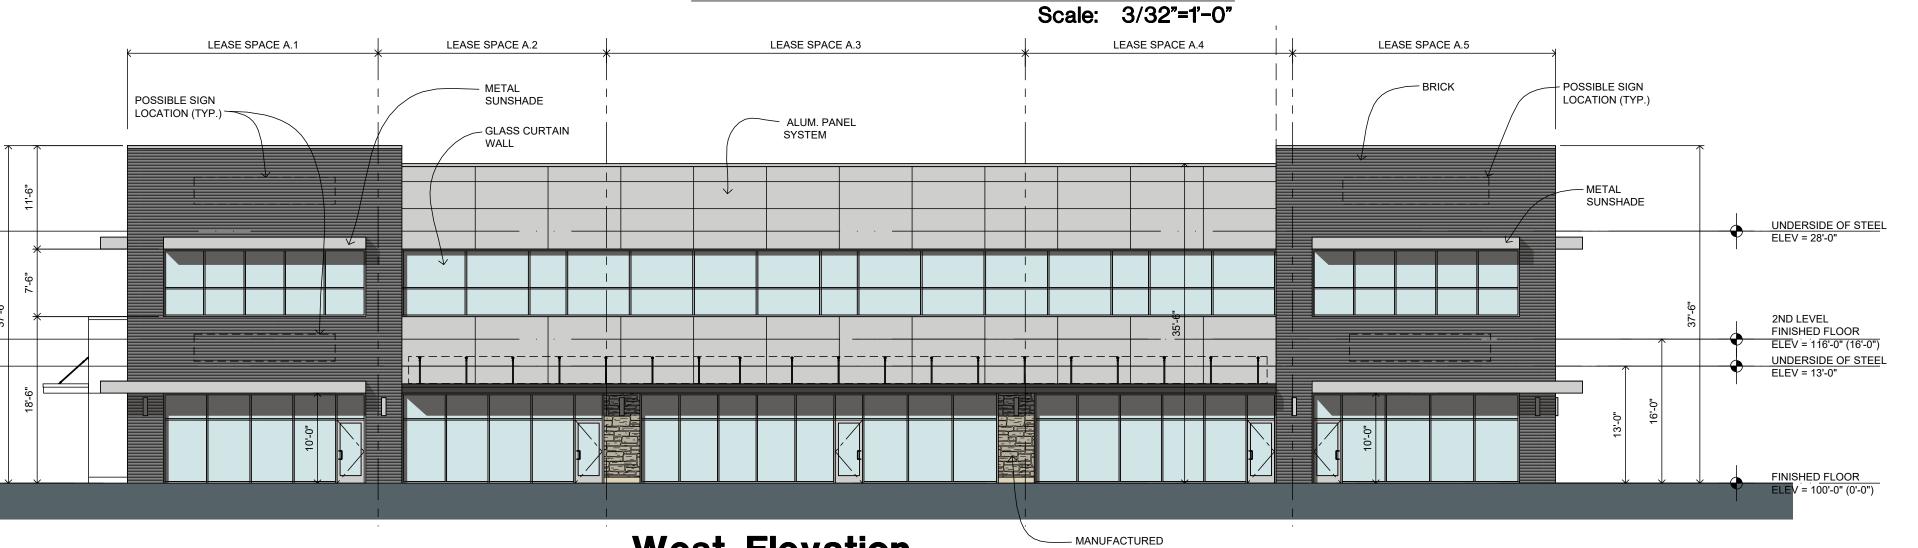

West Elevation

MANUFACTURED STONE VENEER

Scale: 3/32"=1'-0"

© COPYRIGHT 2015: ROGVOY ARCHITECTS, P.C.

ISSUED FOT:

OUNER REVIEW 17 SEPT. 2020

OWNER REVIEW 01 FEB. 2021

OWNER REVIEW 15 FEB. 2021

OWNER REVIEW 17 FEB. 2021

OWNER REVIEW 22 APR. 2021

SITE PLAN REVIEW 05 MAY 2021

REVISED 07 JUN. 2021

SITE PLAN REVIEW 15 JUN. 2021

project:

ommercial Development

ROGVOY

32500 TELEGRAPH ROAD SUITE 250 BINGHAM FARMS, MICHIGAN 48025-2404

PH 248.540.7700 FX 248.540.2710



drawing:

Conceptual Bldg. Elevations

DO NOT SCALE DRAWING

issue date: drawn: KL checked: MD approved: MD

file number:

et:

A-3

MLS	EA

Lumens Lumen Light Loss Wattage Efficiency Distribut Plot Notes

Lamps James Lamps L

ASL1-160L-100- 12012 1 0.92 87.6 100% -4K7-3.ies

1 ASL1-160L-115- 15234 1 0.92 109.7 100% -4K7-4W.ies

ASL1-160L-100--4K7-4W.ies 1 0.92 87.6 100%

ASL1-160L-100- 12012 1 0.92 87.6 100% -4K7-3.ies

0.5 18.8 100%

1 LNC4-36L-4K- 4632 1 0.92 40.3 100% 035-3-U.ies

48 19414_16.8W-Ultralights.ies

Statistics								
Description	Symbol	Avg	Max	Min	Max/Min	Avg/Min		
Calc Zone #1	+	1.8 fc	4.5 fc	0.3 fc	15.0:1	6.0:1		
Property Line	+	0.2 fc	0.7 fc	0.0 fc	N/A	N/A		

HUBBELL OUTDOOR

16 Ultralights Lighting, 320 S Plumer Ave, Tucson, AZ 85719

ASL1-160L-100-4K7-3-

ASL1-160L-115-4K7-4W

ASL1-160L-100-4K7-3-

LNC4-36L-4K-035-3-U Large LNC4 Litepak

Ultralights Lighting - Wall sconce luminaire. Product ID: 19413 Brown formed steel housing with flat white plastic lens top and bottom. 48 LEDs with single row of 24 mounted at top and at bottom. One Fulham driver. Model: T1T11200700-18CA Operating at 120v AC and 60 Hz.

3 HUBBELL ASL1-160L-100-4K7-4W-OUTDOOR -U

B-70-CRI

- TW34

ASL1-160L-100-4K7-3--U

ASL1-

160L-115-4K7-


4W-U

S4

S3

W4

WS

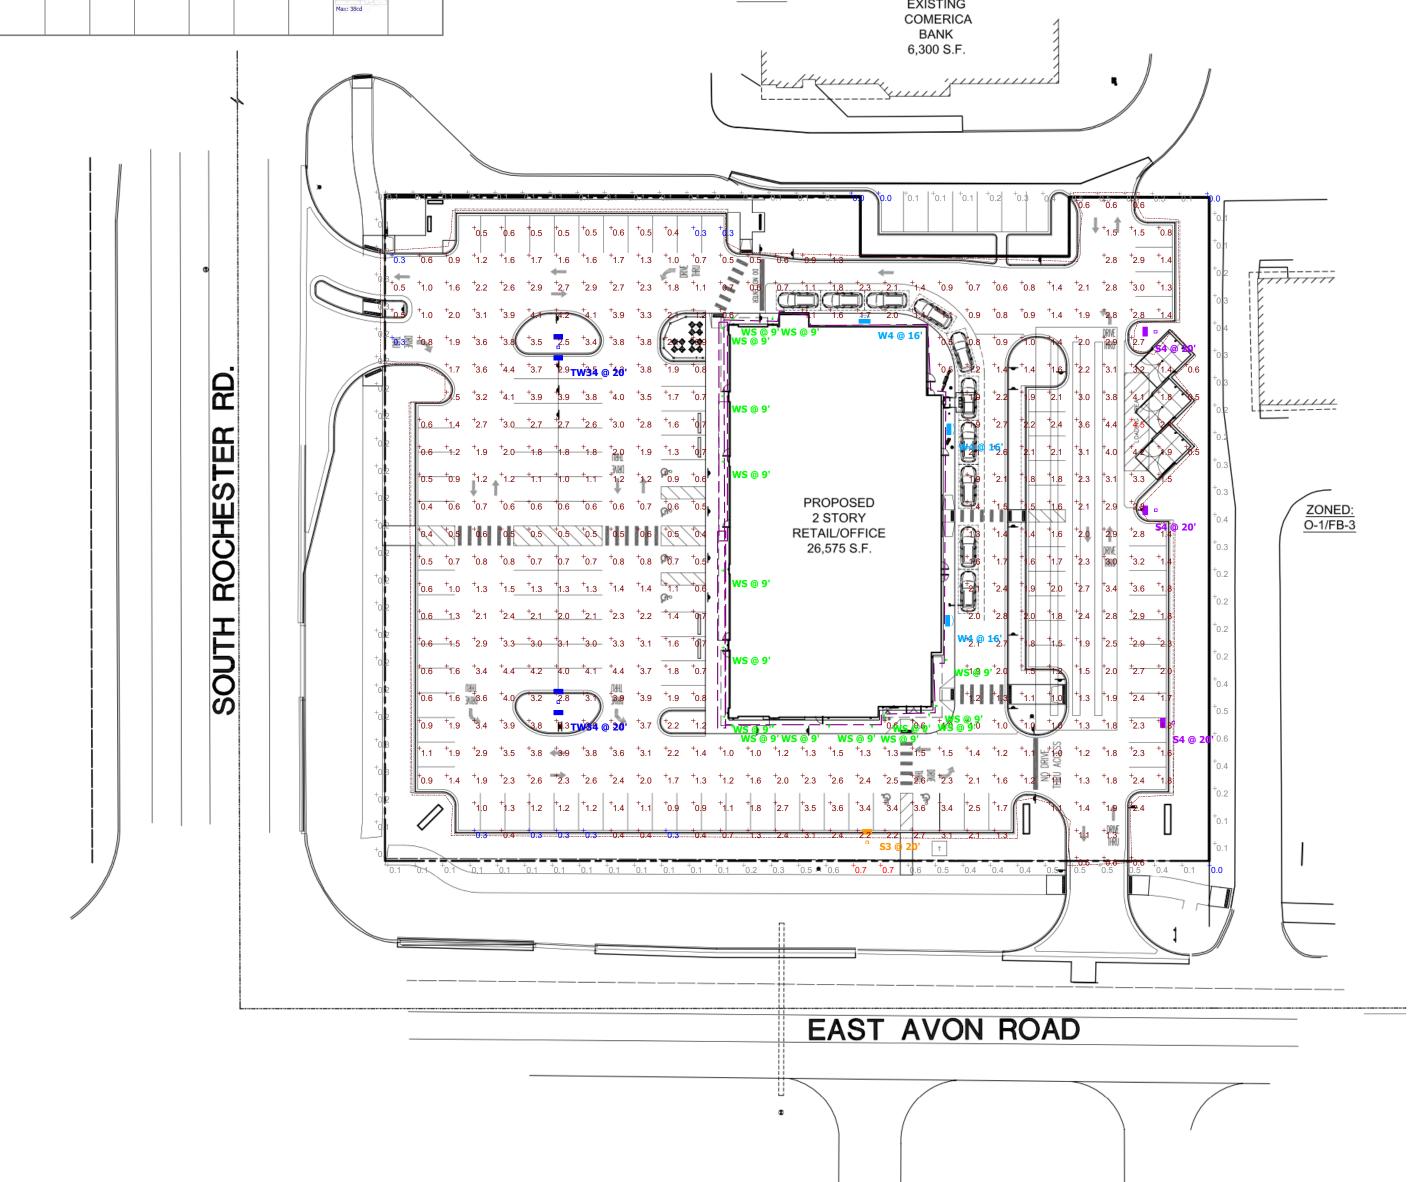

ZONED: B-3/FB-3

EXISTING

SITE PLAN

SCALE: 1"=30'-0"

Plan View Scale - 1" = 35ft

Designer
BG
Date
6/15/2021 REV2
Scale Not to Scale

Drawing No. Summary

installation or mast arm option for 2-3/8 ft OD roadway bracket Capable of replacing up to 1000w HID luminaires · Micro Strike optical distributions of Type 2, 3, 4W or 5QW Tool-less entry option for easy installation and maintenance.

• 1.5G rated for high vibration applications including bridges and



Site Sunc NX DISTRIBUTED

SPECIFICATIONS

CONSTRUCTION fins that are optimal for heat dissipation white keeping a clean smooth outer surface · Corrosion resistant, die cast aluminum housing with powder coat paint finish

for improved thermal management and optimum component operation . TGIC thermoset polyester powder paint finish applied at nominal 2.5 mil thickness

Separate optical and electrical compartment

· Entire optical aperture illuminates to create a larger luminous surface area resulting in a low glare appearance without sacrificing

· Premium engineered individual acrylic lenses deliver ES Type 2, 3, 4W and 5QW distributions · Lens distributions are field rotatable (in 90" increments) or exchangeable for job site

. 3000K, 4000K, or 5000K (70 CRI) CCT B0, 160, or 320 midpower LEDs . 3000K 4000K by 5000K (70 CRU CCT

 Zero uplight at 0 degrees of tilt Fleid rotatable optics INSTALLATION

· Tool-less entry to wiring/driver compartment optional Universal mounting block works with #2 drill

· Fixture ships with slotted mounting block to accommodate wide range of drill patterns for

Page 1/11 Rev. 02/16/21 AIROLED-SPEC

HUBBELL Outdoor Lighting

INSTALLATION (CONTINUED) 2-3/8" OD brackets with vertical tilt of +3", 0" or -3" ELECTRICAL

 Universal 120-277 VAC or 347-480 VAC input Voltage, 50/60 Hz Ambient operating temperature -40° C to 40° C · Drivers have greater than 90% power factor

PROJECT.

CATÁLOG #

over-current protection and short discult protection with auto recovery Field replaceable surge protection device provides 20KA and 10KV protection meeting ANSVIEEE C62.41.2 Category C High and Surge Location Category C3, Automatically takes fixture off-line for protection when

· LED drivers have output power over-voltage.

CONTROLS wireless available for complete on/off and 7-pin ANSI C136.41-2013 photocontrol receptacle uption available for twist lock

(control accessories sold separately). · Dimming Drivers are standard and dimming. leads are extended out of the luminaire unless control options require connection to the dimming leads. Must specify if winds leads are to be greater than the 6 · SiteSync" wireless control system is available

Lumen Range 5,000–35,000 at: www.hubbelllighting.com/sites/ NX Distributed Intelligence" available in fixture wireless control module dimming and occupancy sensor

CATÁLOG #

CONTROLS (CONTINUED)

RELATED PRODUCTS

8 RARI Ratio 8 RAR2 Ratio 8 Cimarron LED

control module, features dimming and ccupancy sensor via 7-pin · Please consult brand or sales representative when combining control and electrical operate as anticipated depending on your

 Listed to UL1598 and CSA C22.2#250.0-24 for wet locations and 40°C ambient temperatures. 1,56 rated for ANSI C136.31 high vibration IP65 optical assembly Meets IDA recommendations using 3K CCT

configuration at 0 degrees of tilt · This product qualifies as a "designated country construction material" per FAR. 52.225-11 Buy American-Construction terials under Trade Agreements effective 04/23/2020, See Buy American Solutions

 5 Year warranty . See HLI Standard Warranty for

KEY DATA

on and details	Wattage Range	25-225		
llable with	Efficacy Range (LPW)	118-148		
e features	Weight lbs. (kg)	14,5-17.5 (6.6-8)		
	and the second	- VIIDOS		

TYPE: PROJECT.

LARGE LED LITEPAK

FEATURES distributions and CCT for maximum light level and mounting height flexibility

 Capable of replacing up to 400w HID solutions at over 70% energy savings · Easy to install and retrolit existing HID luminaires with same footprint Zero uplight Compact LED Architectural Wallpack

hospitals, warehouses and retail applications

 Inverted 'up' mounting capable Control capabilities offer additional energy savings options

. Ideal applications include: perimeter illumination, schools, factories,



CONTROL TECHNOLOGY

Site Sunc NX DISTRIBUTED WISCAPE

SPECIFICATIONS

CONSTRUCTION арреаталсе.

· Casting thermally conducts LED heat to optimize performance and long life Powder paint finish provides durability in outdoor environments Four V2° conduit entries (top, bottom, and sides) provided for surface conduit.

 Zero uplight distributions using individual acrylic LED optics provide IES type II. III and IV distributions CS - Frosted acrylic diffuser option for reduced glare "up" mounting applications (lens required

OPTICS

• 3000K, 4000K and 5000K CCT nominal with 70 CRI 36 and 44 LED configurations available

INSTALLATION

- Quick-mount adapter with gasket seal provides easy installation to wall or to recessed junction box (4° square junction box) Fixture attaches by two Allen-head hidden fasteners for tamper resistance

feed on all four sides in single SKU

· Designed for direct j-box mount or conduit

 L96 at 25,000 hrs (Projected per IESNA TM-21-11), see table on page 2 for all values Electronic driver. 10 kA surge protection. · Ambient operating temperature -40°C to

CONTROLS
- Button photocontrol for dusk to dawn energy savings Occupancy sensor options available for complete on/off and dimming control

 SiteSync pre-commisioned wireless controls (with or without sensor) In addition, the LNC4 can be specified. reduction in energy and maintenance cost while optimizing light quality 24/7 See ordering information or visit:
 www.hubbedlighting.gom/sitesync for

8 LNC 8 INCZ 8 LNC3 ELECTRICAL

• 120-277, 347 and 480 voltage, 50/60Hz.
0-10V dimming drivers. CERTIFICATIONS


DesignLights Consortium® (DLC) qualified.
Please refer to the DLC website for specific product qualifications at www.designlights.org Listed to UL1598 and CSAC22.2#250.0-24 for IP65 Assembly IDA Approved (3000K configurations)


> WARRANTY 5 year limited warranty

See <u>HLI Standard Warranty</u> for additional information

RELATED PRODUCTS

KEY DATA	
Lumen Range	4,269-14,793
Wattage Range	40.3-170
Efficacy Range (LPW)	75.2-117
Fixture Projected Life (Hours)	L96>25K
Weights lbs. (kg)	27.0 (12.2)

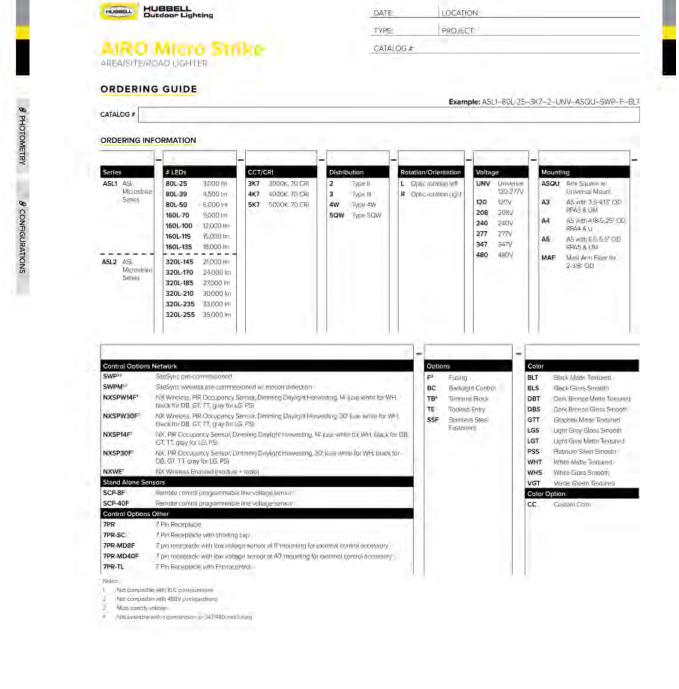

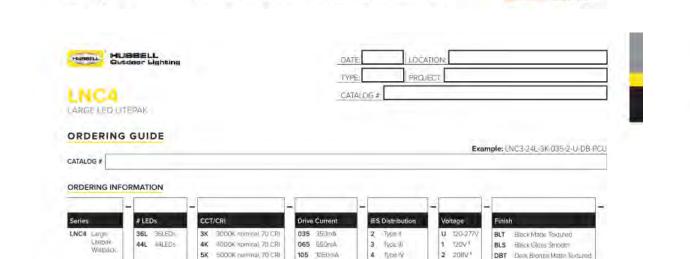

5 480V LGS Light Grey Gloss Smooth WHT Write Matte Textured WHS White Glass Smooth ny vistali any, hlat avaliable with SCP or SWPM sensal/corresi options ist pre-informan of one remove control to program directing settings, 0-40V kilay etyminia reving wan automatic dayagid cultivation and different time delay settings, 120-277V only CS Frosted acrylic diffuser 4 PCU action not admicable, included in control (8F = units 8f) 20F = Units 20ff Accepts spending 3, 5, and 7 Fin ANSI controls (by orders). Not wealthin with ECU, SWP or SWPM control ciptions: 36L-65DrivA version only. Not available with SWP or SWPM control collons. Sensor Asset E Integral battery backup rated for 0°C 1.4 EH Integral battery backup with heater rated 8 Specify time caum, cumming laws and insidency haight for 123-227V pay in 650ma for 347V or 460V

Catalog Number	Lumens	LPW	Wattage	No. of LEDs	CCT/CRI	Voltage	Distribution	Weight lbs. (kg)	No. of Drivers	Current
LNC4-36L-4K	10,754	86.3	124/5	35	4000K	120-277	N.	270 (12.2)	2	1050inA
LNC4-44L-4K-7PR	13,477	88,3	1526	44	4000K	120-277V	N	270 (12:2)	3	1050ma
LNC4-44L-4K-SCP	13,477	883	52.6	:44	4000K	120-277V	N-	270 (12.2)	2	1050mÅ


Hubbell Control Solution	= Accessories (Sold Separately),
NX Distributed Intelligen	to"
NXOFM-1R1D-UNV	On-fature Module (7 pm), On / Off / Dm, Dwyight Sensor with HaddNET Rivato viru Bluetooth® Radio (20→BOVA)
wiSCAPE® Lighting Cont	rat
WIR-RME-L	On floure Module (7-on or 5-pm), On / Off / Dim. Davioht Sansor with WSCAPE Radio, 10-480VAC

SiteSync 7-Pin Module: · Available as an accessory for new construction or retrofit applications (With existing 7-Pin receptor . Does not interface with occupancy sensors

	1
Over 1000	HUBBELL


Site Synt


3 240V1 DBS Dark Brone Gloss Smooth
4 277V1 GTT Grephile Matte Textureo.

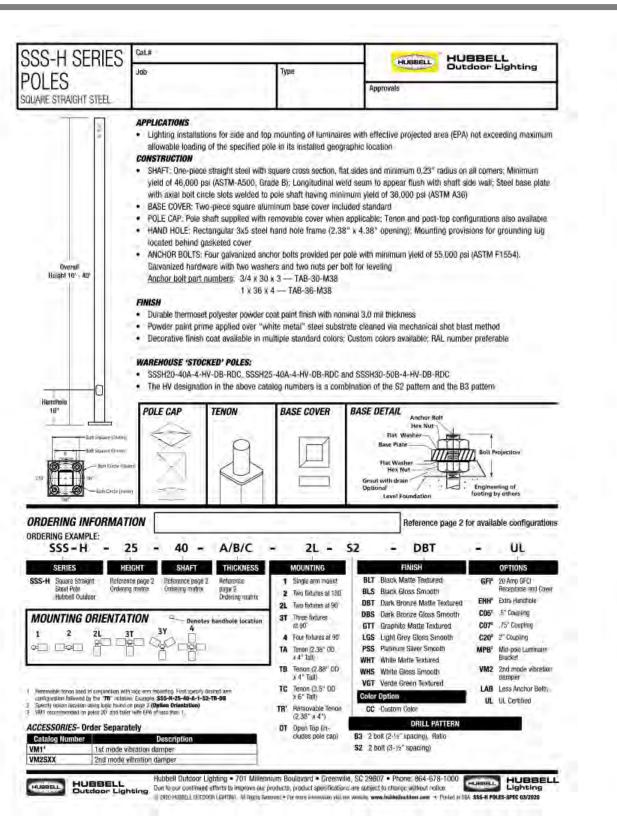



320 S Plumer Avenue • Tucson, AZ 85719 • p +1 520 623 9829 • info@ultralightslighting.com

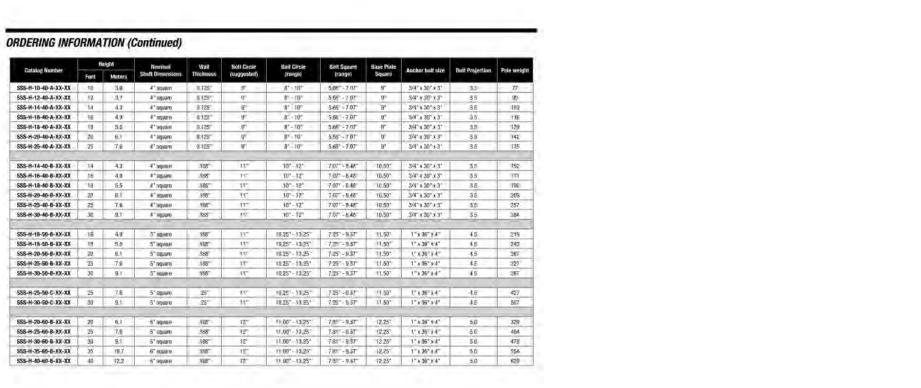

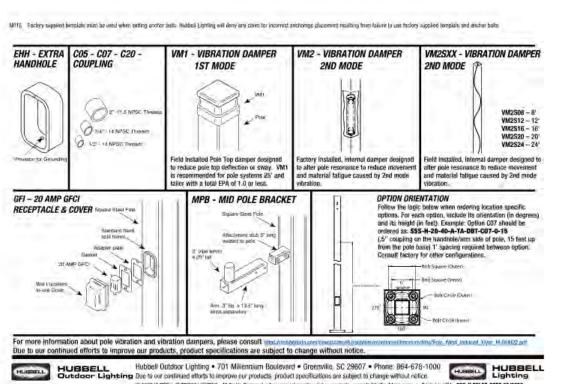

Designer Date 6/15/2021 REV2

Summary

Scale Not to Scale Drawing No.

2 of 2

Test ED