

#### Landscape Summary

Right-of-Way Trees: Brewster Road

Length of Frontage: 615.71 LF 1 Deciduous Tree / 35 LF Required:

1 Ornamental Tree / 60 LF Required: 18 Deciduous & 11 Ornamental Trees Required:

11 Deciduous Trees (7 Proposed & 4 Existing)\* 0 Ornamental Trees\*

West Buffer along RM-1 Length of Boundary: 257.86 LF Required:

Buffer Type B - 10' Width Greenbelt - 2 Deciduous Trees per 100 LF - 1.5 Ornamental Trees per 100 LF - 2 Evergreen Trees per 100 LF - 4 Shrubs / 100 LF

10' Width Greenbelt Required: 6 Deciduous Trees 4 Ornamental Trees 6 Evergreen Trees 11 Shrubs

10' Width Greenbelt 6 Deciduous Trees (3 Proposed + 3 Existing) 4 Ornamental Trees

6 Evergreen Trees 12 Shrubs

\*Note: All required trees cannot fit in the required locations due to infrastructure and corner clearance conflicts. In lieu of planting, a payment of \$3,901.50 (\$216.75 per tree) shall be made to the City of Rochester Hills tree fund. A final amount shall be determined during final site plan approval.

#### Tree Replacement Summary

Total Trees Surveyed: - Total Trees Offsite: 52 Total Onsite Trees: - Total Landmark Trees: 0

- Total Historic Trees: 0

Total Trees Saved: Per Sec. 126-327.2, a minimum of 37% of the - Required: total number of regulated trees on site shall be

preserved and undamaged 99 Trees - Required: - Provided: 11.70% Saved

Total Trees Removed: - Exempt Trees: 9 (These trees include poor quality Elm and

Replacement Requirements:

Required: Equivalency of 225 Trees (1 Tree / 1 Tree Removed) per the following replacement rates: Deciduous Trees - 2" replacement caliper = 1 Tree

- 2.5" replacement caliper = 1.5 Trees - 3" or greater replacement caliper = 2 Trees Evergreen Trees - 8' replacement height = 1 Tree

- 9' replacement height = 1.5 Trees - 10' or greater replacement height = 2 Trees

Provided: 225.50 Total Tree Equivalency at the following calculations: Deciduous Trees - 79 Trees at 2" caliper - 29 Trees at 2.5" caliper Evergreen Trees - 103 Trees at 8' ht.

#### Plant Schedule (This Sheet)

sym.	qty.	botanical name	common name	size	spacing	root	notes
Brewster R	oad R.O	.W. Trees					
AR-S	4	Acer rubrum 'Armstrong'	Armstrong Red Maple	3" cal.	per plans	B&B	
LT-S	3	Liriodendron tulipifera	Tulip Tree	3" cal.	per plans	B&B	
Buffer Scre	en Trees						
AG-B	4	Amelanchier x grandiflora 'Autumn Brilliance'	Autumn Brilliance Serviceberry	2" cal.	per plans	B&B	Multister
PG-B	6	Picea glauca	White Spruce	10' ht.	per plans	B&B	
QB-B	3	Quercus bicolor	Swamp White Oak	3" cal.	per plans	B&B	
Woodland	Replace	ment Trees					
AC-R	44	Abies concolor	White Fir	8' ht.	per plans	B&B	
AG-R	3	Amelanchier x grandiflora 'Autumn Brilliance'	Autumn Brilliance Serviceberry	2" cal.	per plans	B&B	Multisten
AR-R	14	Acer rubrum 'Armstrong'	Armstrong Red Maple	2.5" cal.	per plans	B&B	
GT-R	24	Gleditsia triacanthos f. inermis 'Skyline'	Skyline Thornless Honeylocust	2" cal.	per plans	B&B	Thornless
LT-R	12	Liriodendron tulipifera	Tulip Tree	2" cal.	per plans	B&B	
PA-R*	15	Platanus x acerifolia 'Exclamation'	Exclamation London Planetree	2.5" cal.	per plans	B&B	
PG-R	29	Picea glauca	White Spruce	8' ht.	per plans	B&B	
PS-R	30	Pinus strobus	Eastern White Pine	8' ht.	per plans	B&B	
QB-R	11	Quercus bicolor	Swamp White Oak	2" cal.	per plans	B&B	
ZS-R	29	Zelkova serrata	Japanese Zelkova	2" cal.	per plans	B&B	

common name


Diabolo Ninebark

## Development Sign Note:

PO-B 12 Physocarpus opulifolius 'Diabolo'

All signs must meet the requirements of Section 138-12.306 and Chapter 134 of the City Code of Ordinances and be approved under separate permits issued by the Building Department.

botanical name

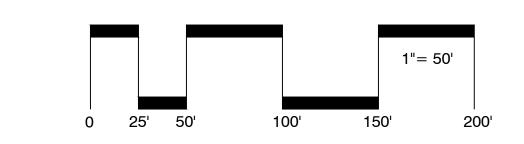

size

#5

spacing

5' o.c.

root notes

cont.





landscape architecture / land planning

18161 W. Thirteen Mile Rd, Suite B-4 Southfield, MI 48076 T:: 248.594.3220

#### **LEGEND**

F:: 248.594.3260

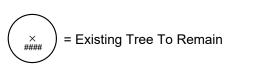


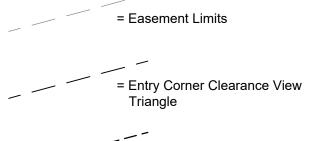



Standards

= Pathway Site Line per CITY

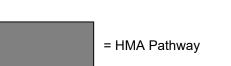



#### Overall Landscape Plan

project title:

## Brewster Village

City of Rochester Hills, MI

■ prepared for:

Robertson Brothers Homes 6905 Telegraph Rd. - Suite 200 Bloomfield Hills, MI 48301


Phone: 248.644.3460


■ job number:	■ date:
17031	08.02.2018
■ drawn by:	■ checked by:
EMJ	WTK



■ revisions:	
10.12.2018	Per Site Redesign
11.13.2018	Per Municipal Review
01.23.2019	Per Municipal Review
02.25.2019	Per Municipal Review



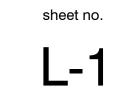

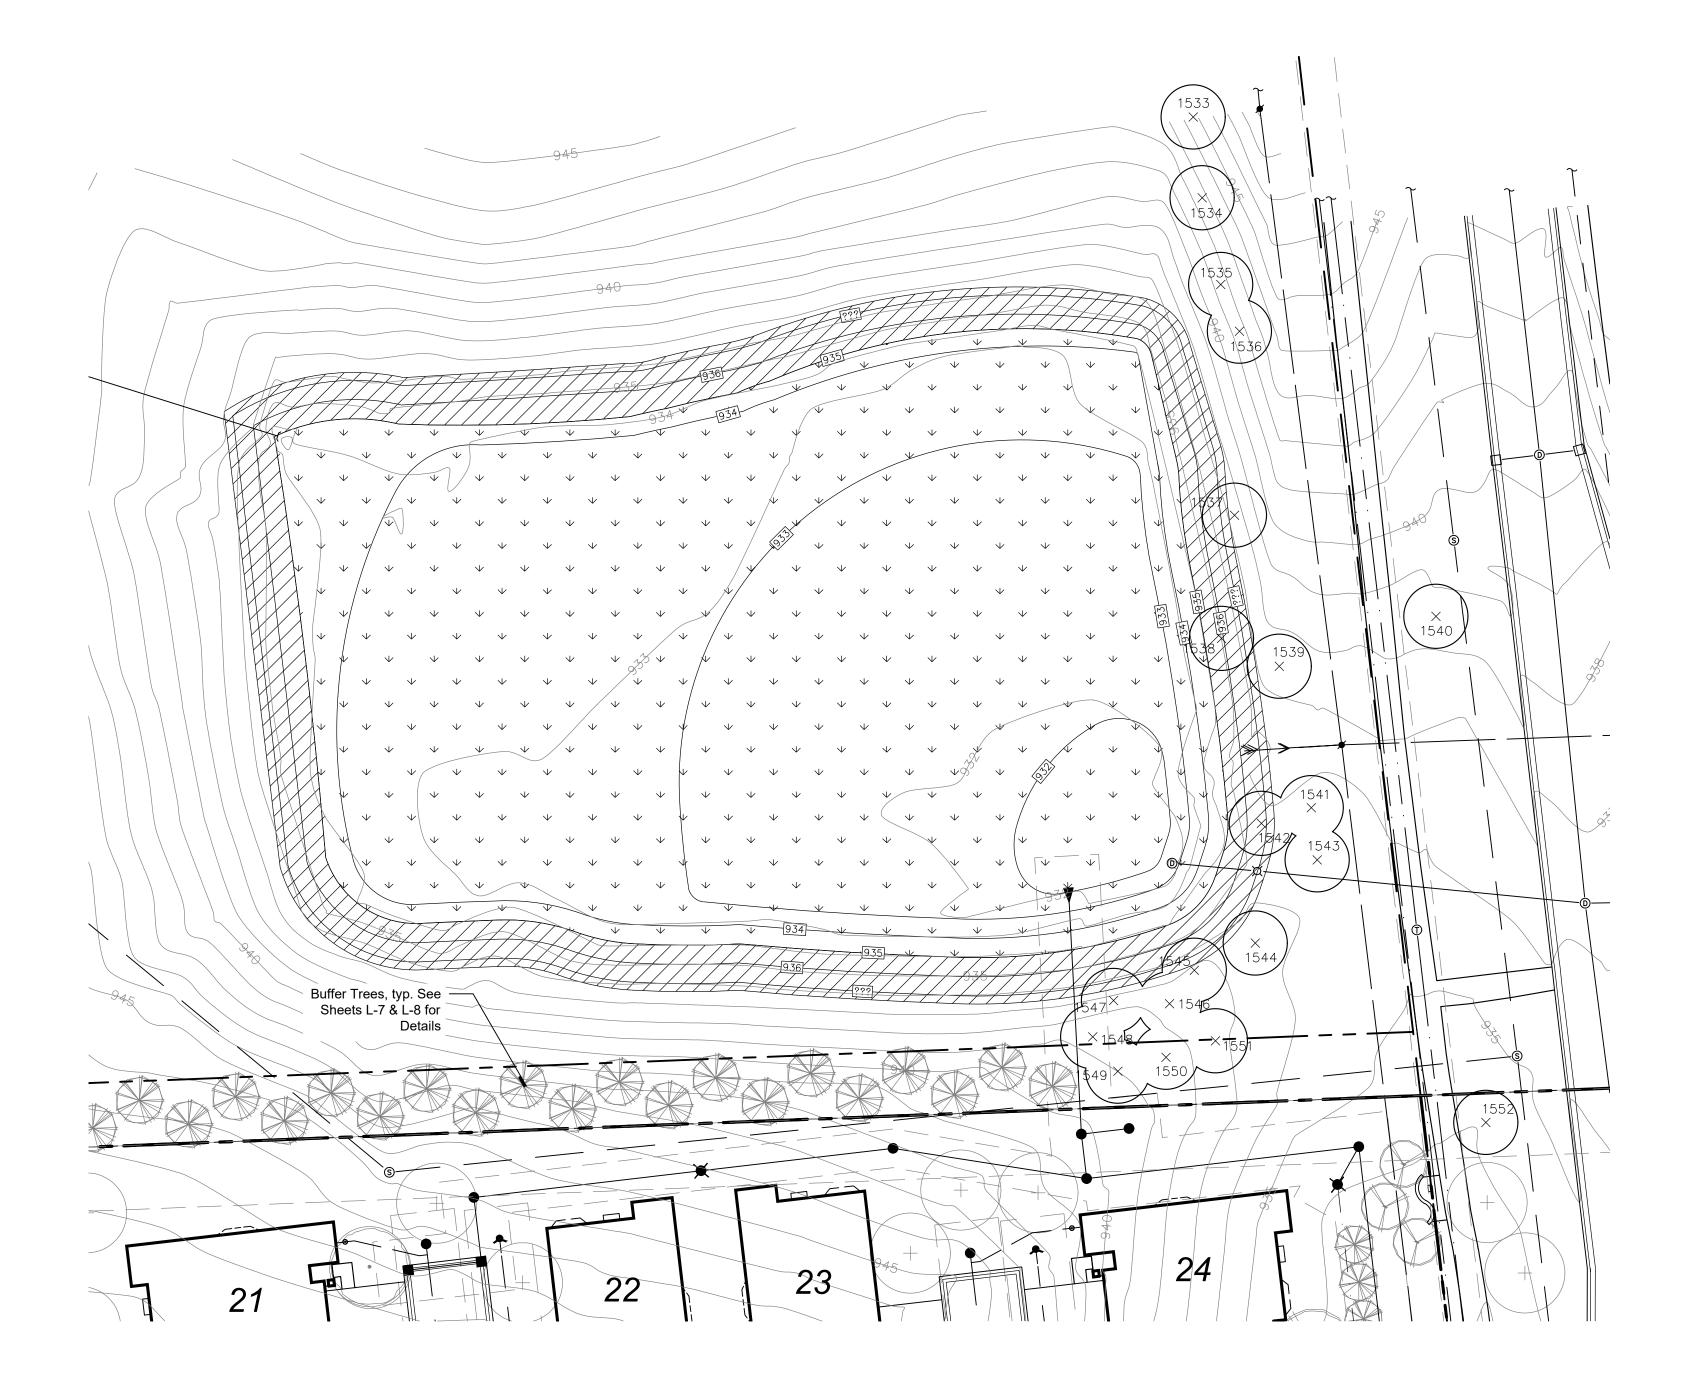

#### General Notes:

Should the Storm System Improvement result in the removal of any tree(s), replacement trees shall be installed.

#### **Detention Pond Seeding Summary**

Basin Zone - Elev. 932'-935'

Basin Zone - E

Seeding Area: 48,505 s.f.
Application Rate: 32.81 lbs./Ac.
Required Quantity: 36.54 lbs. of Stormwater Seed Mix

otes:
- Install 3"-6" of Topsoil or Wetland Mulch prior to seeding
- Use Seed Mat

Upland Zone - Elev. 935'-937'

Upland Zone - E

Seeding Area: 13,476 s.f.
Application Rate: 38.67 lbs./Ac.
Required Quantity: 11.96 lbs. of Low-profile Prairie Seed Mix
Notes:

Notes:

- Install 3"-6" of Topsoil or Wetland Mulch prior to seeding
- Use Seed Mat

Seed Mixes available from Cardno JFNew
- www.carnonativeplantnursery.com
- (574) 586-2412
All Seed shall be protected with mulch blanket


#### Native Seeding Maintenance

During the first growing season, native areas should be mowed two to four times to a height of about 4"-6" when the growth reaches 10"-12". Selective herbicide applications or hand pulling may be needed to control unwanted weed populations. If a mower cannot be set high enough, a string trimmer can be used.

During the second growing season, native areas should be mowed a few times to a height of about 8" when the growth reaches 10"-18". Selective herbicide applications or hand pulling may be needed to control unwanted weed populations.

By the second growing season it should be apparent if some areas need reseeding. Reseed or overseed as needed.

Long term management may include prescribed burning, mowing, hand pulling, and selective herbicide applications. If burning is not allowed or feasible, the planting may be mowed to a short height and the clippings removed in the early spring before ground-nesting birds begin nesting.

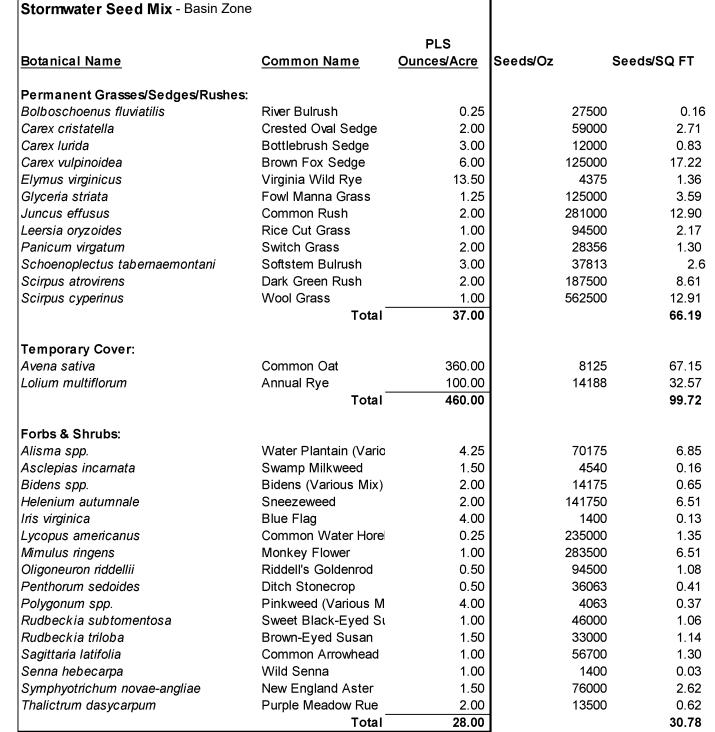

Mix Statistics												
Native Component	PLS lbs./Acre	PLS Seeds/Acre	PLS Seeds/Sq. Ft.	% of Native Mi								
Forbs	1.75	1,340,887	30.78	31.74								
Grasses	2.31	2,883,281	66.19	68.26								
Total Natives	4.06	4,224,168	96.97	100.00								
Cover	28.75	4,343,800	99.72									
Totals	32.81	8,567,968	196.69									

Botanical Namo	Common Name	PLS Ounces/Acre	  Seeds/Oz	Seeds/SQ FT
Botanical Name	Common Name	Ouncestacte	SeedsOZ	Seeds/SQ FT
Permanent Grasses:				
Bouteloua curtipendula	Side Oats Grama	16.00	9375	3.4
Carex spp.	Prairie Carex Mix	4.00	33422	3.0
Elymus canadensis	Canada Wild Rye	32.00	4258	3.1
Koeleria pyramidata	June Grass	1.00	150000	3.4
Panicum virgatum	Switch Grass	1.00	28356	0.6
Schizachyrium scoparium	Little Bluestem	36.00	8800	7.2
	Total	90.00		21.0
Temporary Cover:				
Avena sativa	Common Oat	360.00	8125	67.1
Lolium multiflorum	Annual Rye	100.00	14188	32.5
-onam mannoram	Total		14100	99.7
F <b>orbs</b> : A <i>morpha canescens</i>	Lead Plant	0.50	17000	0.2
•	ThimbleWeed	0.50	20938	0.2
Anemone cylindrica	Common Milkweed	2.00	4000	0.2
Asclepias syriaca		2.00	3500	0.1
Asclepias tuberosa	Butterfly MilkWeed	2.00	1600	0.1
Baptisia alba Chamasariata fassiaulata	White Wild Indigo	12.00		1.0
Chamaecrista fasciculata	Partridge Pea	5.00	3800 12500	1.4
Coreopsis lanceolata	Sand Coreopsis	1.00		0.2
Coreopsis palmata	Prairie Coreopsis		11500	0.2
Dalea candida	White Prairie Clover	1.50	26250 20000	0.8
Dalea purpurea Desmanthus illinoensis	Purple Prairie Clover Illinois Sensitive Plant	1.50 3.00	4888	0.6
		7.00	6600	1.0
Echinacea purpurea	Broad-Leaved Purple Coneflower Rattlesnake Master	3.00	8000	0.5
Eryngium yuccifolium Lespedeza capitata	Round-Head Bush Clover	2.00	10000	0.4
· ·		0.50	13000	0.2
Liatris aspera	Rough Blazing Star	4.00	1000	0.0
Lupinus perennis Manarda fiatulasa	Wild Lupine Wild Bergamot	0.75	78000	1.3
Monarda fistulosa	Stiff Goldenrod	1.00	46000	1.0
Oligoneuron rigidum	Wild Quinine	1.00	6800	0.1
Parthenium integrifolium		0.50	115000	1.3
Penstemon digitalis Penstemon hirsutus	Foxglove Beard Tongue Hairy Beard Tongue	0.50	125000	1.4
Pycnanthemum virginianum	Common Mountain Mint	1.00	331250	7.6
_	Yellow Coneflower	4.00	25250	2.3
Ratibida pinnata Rudbeckia hirta	Black-Eyed Susan	5.00	110000	12.6
Rudbeckia subtomentosa	Sweet Black-Eyed Susan	1.00	46000	12.0
Silphium terebinthinaceum	Prairie Dock	0.50	1100	0.0
Silpinum terebinumaceum Solidago speciosa	Showy Goldenrod	0.50	105000	1.2
	Heath Aster	0.25	140000	0.8
Symphyotrichum ericoides	Smooth Blue Aster	1.00	48000	0.c 1.1
Symphyotrichum laeve		0.50		0.8
Symphyotrichum novae-angliae	New England Aster		76000	
Tradescantia ohiensis	Common Spiderwort	0.75	8000	0.1
Verbena stricta	Hoary Vervain	1.00	32000	0.7
Vernonia spp.	Ironweed (Various Mix)	1.75	24000	0.9
Veronicastrum virginicum	Culvers Root Total	0.25 <b>68.75</b>	750000	4.3 <b>46.</b> 8

Mix Statistics											
Native Component	PLS lbs./Acre		PLS Seeds/Acre	PLS Seeds/Sq. Ft.	% of Native Mix						
Forbs		4.30	2,042,608	46.89	69.06%						
Grasses		5.63	915,100	21.01	30.94%						
Total Natives		9.92	2,957,708	67.90	100.00%						
Cover		28.75	4,343,800	99.72							
Totals		38 67	7 301 508	167 62							



18161 W. Thirteen Mile Rd, Suite B-4 Southfield, MI 48076

Southfield, MI 480 T:: 248.594.3220 F:: 248.594.3260

#### **LEGEND**





■ sheet

## Detention Pond Seeding Plan

■ project title:

## Brewster Village

City of Rochester Hills, MI

■ prepared for:

Robertson Brothers Homes 6905 Telegraph Rd. - Suite 200 Bloomfield Hills, MI 48301

Phone: 248.644.3460

■ job number:	■ date:
17031	10.12.2018
■ drawn by:	■ checked by:
EMJ	WTK




■ revisions:


11.13.2018 Per Municipal Review


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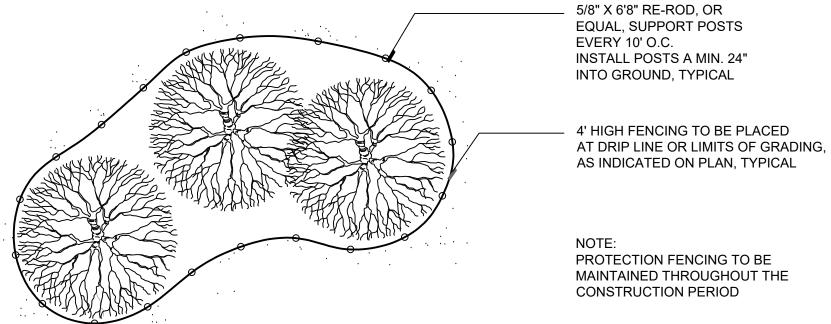
02.25.2019 Per Municipal Review



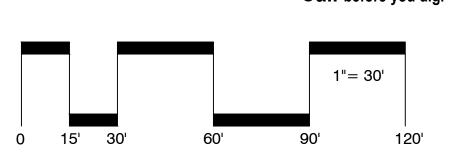




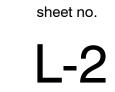

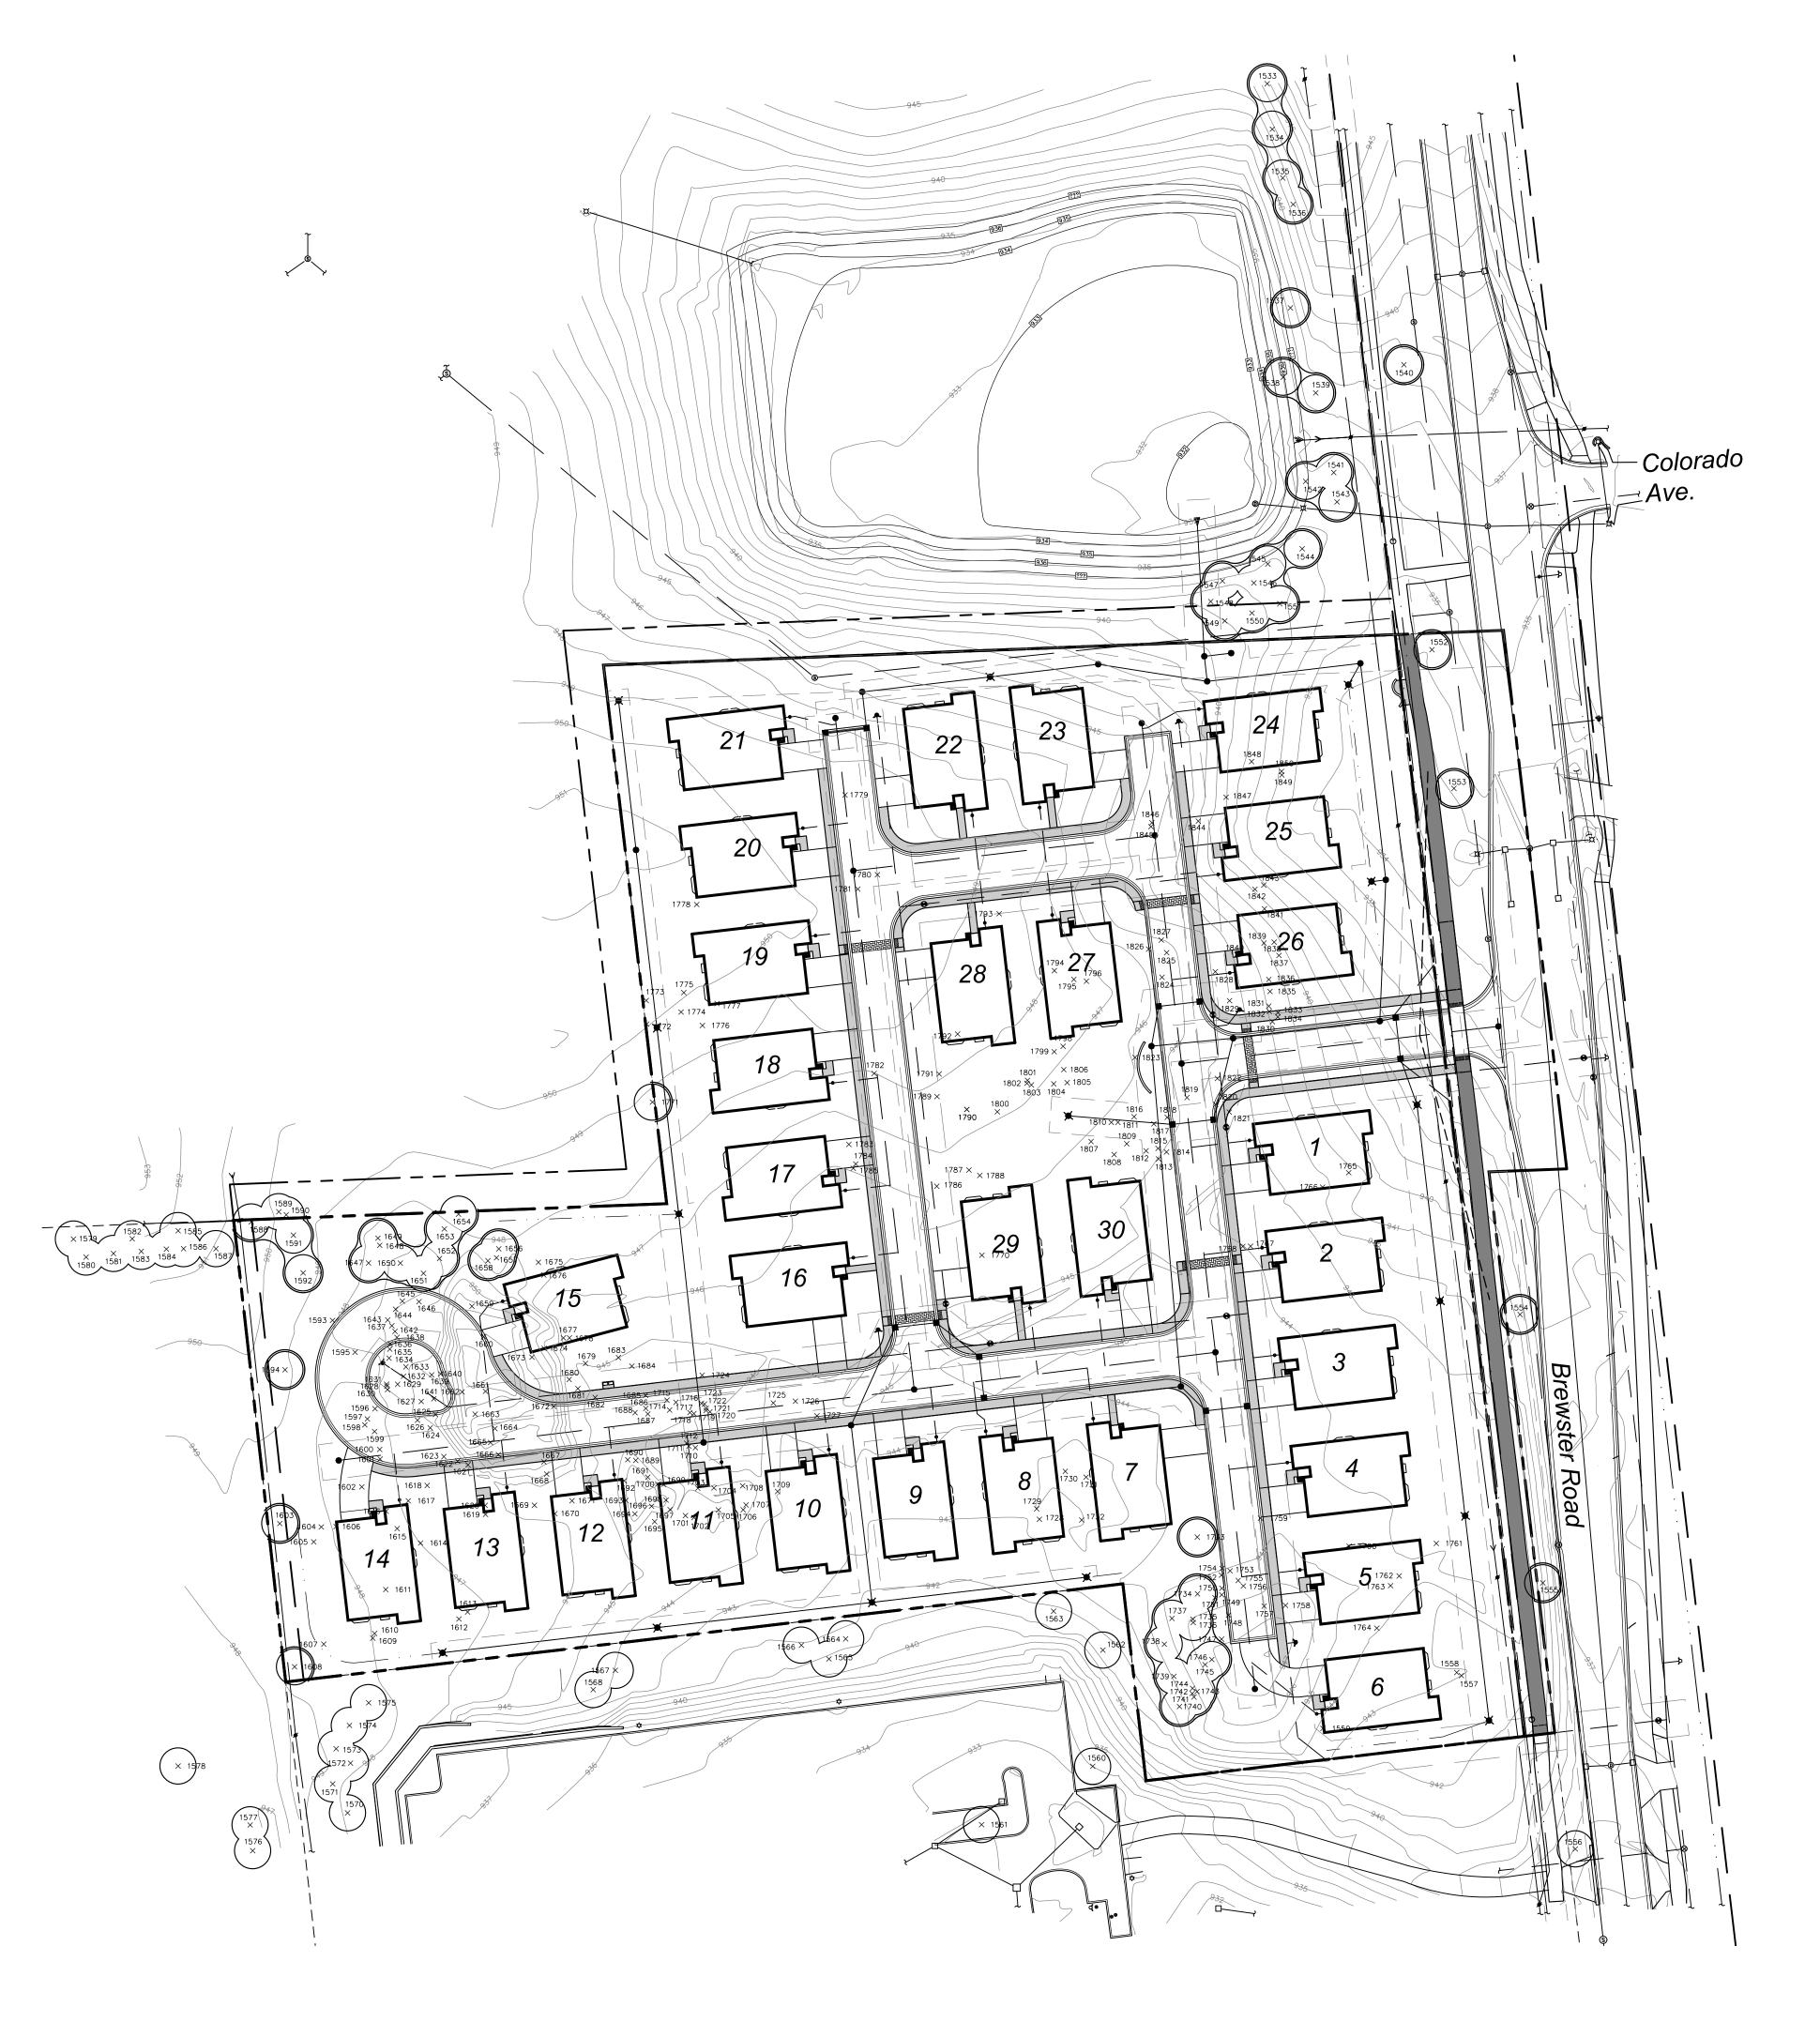

#### Tree Protection Detail - Plan

Scale: NTS

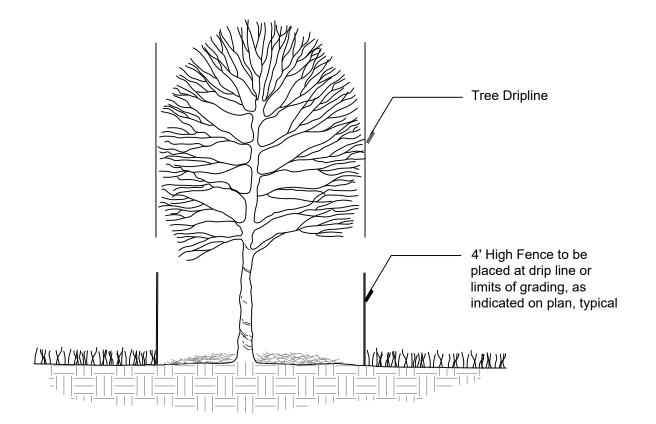

#### Tree Protection Detail - Section

Scale: NTS

#### Tree Protection Notes

- 1. Approved tree protection shall be erected prior to the start of construction activities, and shall remain in place until construction is complete.
- 2. No person may conduct any activity within the drip line, or protected area, of any designated tree to remain, including, but not limited to, placing solvents, building materials, construction equipment, etc.
- 3. Grade changes may not occur within the drip line of protected trees. 4. During construction, no person shall attach any device or wire to any remaining tree. 5. All utility service requests must include notification to the installer that protected trees
- must be avoided. All trenching shall occur outside of the protective fencing.

  6. Swales shall be routed to avoid the area within the drip lines of protected trees. 7. Trees located on adjacent properties that may be affected by construction activities
- 8. Trees to be removed shall be flagged by the Owner Representative prior to site
- grading.9. Root zones of protected trees should be well marked with bright colors and surrounded
- with rigidly staked fencing.

  10. The parking of idle and running equipment shall be prohibited under the drip line of
- protected trees.

  11. The stripping of topsoil from around protected trees shall be prohibited.

  12. Trees to be removed shall be fell away from trees to be saved.
- 13. Grubbing of understory vegetation in construction areas should be cleared by cutting vegetation at ground level with a chain saw or minimally with a hydro-axe.
  14. The Landscape Architect shall be notified immediately if any protected tree is damaged

#### Tree Replacement Notes


- 1. See Sheet L-1 for Tree Replacement Calculations
- 2. See Sheets L-4 & L-5 for Tree Survey, Tree Designations, and Tree Replacement



#### LEGEND



= Existing Tree To Be Removed

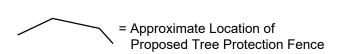

= Concrete Sidewalk

= HMA Pathway



#### Tree Preservation Plan

project title:

## Brewster Village

City of Rochester Hills, MI

prepared for:

Robertson Brothers Homes 6905 Telegraph Rd. - Suite 200 Bloomfield Hills, MI 48301


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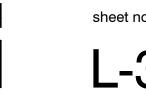
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			To be Saved/	/ Landmark/										To be Saved/	Landmark/						
<i>Tr</i> ee # 1533	<u>Botanical Name</u> Acer rubrum	Common Name RED MAPLE	Removed Offsite	Historic	Exempt -	<u>Dia.</u> <u>Ty</u>	pe Othe		dition AIR	<u>Comments</u> SEAMS, MECHANICAL DAMAGE, EXPOSED ROOTS	<u>Tree #</u> 1653	<u>Botanical Name</u> Fraxinus pennsylvanica	Common Name	Removed Save	Historic -	<u>Exempt</u> Yes	<u>Dia.</u> 6	Type O	ther Dia.	Condition POOR	<u>Comments</u> UTILTIY TRIM, INSECT
1534 1535	Gleditisia triacanthos Pinus nigra	HONEYLOCUST AUSTRIAN PINE	Offsite Offsite	-	-	13 8 MII	LTI 7,6		OOD OOR	THIN CROWN, DIEBACK, FUNGUS	1654 1655	Malus spp.	APPLE BOXELDER	Save Remove	-	•	7	MULTI	6	POOR POOR	UTILITY TRIM, DIEBACK, VINES UTILITY TRIM
1536	Gleditisia triacanthos	HONEYLOCUST	Offsite	-	-	15	,		OOD	,	1656	Acer negundo Acer negundo	BOXELDER	Save	-	-	6			POOR	ROT, DIEBACK, LEAN, UTILITY TRIM
1537 1538	Gleditisia triacanthos Acer rubrum	HONEYLOCUST RED MAPLE	Offsite Offsite	-	-	15 TW 11	/IN	F F	AIR AIR	EXPOSED ROOTS, MECHANICAL DAMAGE EXPOSED ROOTS, MECHANICAL DAMAGE	1657 1658	Morus alba Acer negundo	WHITE MULBERRY BOXELDER	Save Save	-	-	9 14	MULTI	12, 9	FAIR POOR	FUNGUS ROT, DIEBACK, TREE STAND
1539 1540	Acer rubrum Tilia cordata	RED MAPLE LITTLE LEAF LINDEN	Offsite Offsite	-	-	11 6		F G	AIR OOD	EXPOSED ROOTS, MECHANICAL DAMAGE	1659 1660	Acer negundo Acer negundo	BOXELDER BOXELDER	Remove Remove	-	-	8 11	TWIN	11	FAIR POOR	DIEBACK ROT, INSECT, DIEBACK
1541 1542	Pinus nigra Acer rubrum	AUSTRIAN PINE RED MAPLE	Offsite Offsite	-	-	15 11			OOR	GIRDLING ROOTS, FUNGUS,BIRD PEAK, THIN CROWN EXPOSED ROOTS, MECHANICAL DAMAGE	1661 1662	Acer negundo	BOXELDER BOXELDER	Remove Remove	-	-	6	TWIN		FAIR POOR	LEAN ROT, SUPRESSION, DIEBACK
1543	Pinus nigra	<b>AUSTRIAN PINE</b>	Offsite	-	-	14		P	OOR	LEAN, UTITLTY TRIM, EXPOSED ROOTS, MECHANICAL DAMAGE	1663	Acer negundo Acer negundo	BOXELDER	Remove	-	-	7	IVVIIN		FAIR	LEAN
1544 1545	Pinus nigra Gleditisia triacanthos	AUSTRIAN PINE HONEYLOCUST	Offsite Offsite	-	-	15 7		P G	OOR OOD	BIRD PEAK, DIEBACK, EXPOSED ROOTS, MECHANICAL DAMAGE	1664 1665	Acer negundo Acer negundo	BOXELDER BOXELDER	Remove Remove	-	-	7 7			FAIR FAIR	LEAN LEAN, DIEBACK
1546 1547	Gleditisia triacanthos Pinus nigra	HONEYLOCUST AUSTRIAN PINE	Offsite Offsite	-	-	6 9		F P	AIR OOR	EXPOSED ROOTS THIN CROWN, DIEBACK, INSECT	1666 1667	Acer negundo Acer negundo	BOXELDER BOXELDER	Remove Remove	-	-	7 6			GOOD POOR	VINES
1548 1549	Pinus nigra Pinus nigra	AUSTRIAN PINE AUSTRIAN PINE	Offsite Offsite	<u>-</u>	-	11 MU 10	LTI	9 F	AIR	COMPETETION, INSECT THIN CROWN, DIEBACK, INSECT	1668 1669	Acer negundo Acer negundo	BOXELDER BOXELDER	Remove Remove	<u>-</u>	-	8 10	TWIN		FAIR FAIR	LEAN, VINES LEAN, DIEBACK
1550	Pinus nigra	<b>AUSTRIAN PINE</b>	Offsite	-	-	10		P	OOR	THIN CROWN, DIEBACK, COMPETETION, INSECT	1670	Acer negundo	BOXELDER	Remove	- -	-	6	MULTI		FAIR	LEAN, DIEBACK
1551 1552	Acer rubrum Acer saccharum	RED MAPLE SUGAR MAPLE	Offsite Offsite	-	-	6 13		P	OOR	FUNGUS, ROT, EXPOSED ROOTS, MECHANICAL DAMAGE MECHANICAL DAMAGE, ROT, EXPOSED ROOTS	1671 1672	Acer negundo Fraxinus pennsylvanica		Remove Remove	-	- Yes	/ 10			FAIR POOR	LEAN, COMPETETION VINES, INSECT, DIEBACK
1553 1554	Thuja occidentalis Thuja occidentalis	NORWAY MALE NORWAY MALE	Offsite Offsite	-	-	15 21		-	AIR OOD	EXPOSED ROOTS, MECHANICAL DAMAGE	1673 1674	Acer negundo Acer negundo	BOXELDER BOXELDER	Remove Remove	-	-	14 8			POOR POOR	LEAN, DIEBACK, BARK MISSING ROT, VINES, TREE STAND
1555 1556	Thuja occidentalis Thuja occidentalis	NORWAY MALE NORWAY MALE	Offsite Offsite	-	-	20 13		F	AIR	EROSION, SEAM, MECHANICAL DAMAGE, EXPOSED ROOTS EXPOSED ROOTS, MECHANICAL DAMAGE	1675 1676	Fraxinus pennsylvanica Acer negundo	GREEN ASH BOXELDER	Remove Remove	-	Yes -	8 9	TWIN	7	POOR POOR	INSECT LEAN, VINES
1557 1558	Populus deltoides	EASTERN COTTONWOOD SIBERIAN ELM	Remove Remove	-	- Yes	21 18 TW	/INI 4		OOD AIR	FUNGUS, DIEBACK	1677 1678	Acer negundo	BOXELDER SIBERIAN ELM	Remove	-	-	7	TVA/INI	7	POOR	VINES, SUPRESSION VINES
1559	Ulmus pumila Populus deltoides	EASTERN COTTONWOOD	Remove	-	-	26		P	OOR	FUNGUS, ROT, DIEBACK	1679	Ulmus pumila Acer negundo	BOXELDER	Remove Remove	-	-	6	TWIN	1	FAIR POOR	LEAN, VINES
1560 1561	Malus spp. Tilia americana	APPLE BASSWOOD	Offsite Offsite	-	-	6 MU 11	LTI	P G	OOR OOD	ROT, DIEBACK, EPICORMIC BRANCHING	1680 1681	Acer negundo Populus deltoides	BOXELDER EASTERN COTTONWOOD	Remove Remove	-	-	7 10			POOR POOR	LEAN, DIEBACK, SUPRESSION ROT, DIEBACK
1562 1563	Picea abies Picea abies	NORWAY SPRUCE NORWAY SPRUCE	Offsite Offsite	-	-	10 14			OOD OOD		1682 1683	Populus deltoides Acer negundo	EASTERN COTTONWOOD BOXELDER	Remove Remove	-	-	16 6			GOOD FAIR	VINES
1564 1565	Abies balsamea Picea abies	BALSAM FIR NORWAY SPRUCE	Offsite Offsite	-	-	6 13		F	AIR OOD	LEAN, UTITLTY TRIM, EXPOSED ROOTS, MECHANICAL DAMAGE	1684	Acer negundo	BOXELDER	Remove	-	- Voc	6			FAIR POOR	SUPRESSION INSECT
1566	Picea abies	NORWAY SPRUCE	Offsite	-	-	12		G	OOD		1686	Fraxinus pennsylvanica Populus deltoides	EASTERN COTTONWOOD	Remove Remove	-	Yes -	17			GOOD	INSECT
1567 1568	Picea abies Picea abies	NORWAY SPRUCE NORWAY SPRUCE	Offsite Offsite	-	-	15 13			OOD OOD		1687 1688	Populus deltoides Populus deltoides	EASTERN COTTONWOOD EASTERN COTTONWOOD	Remove Remove	-	-	13 11	TWIN	11	GOOD FAIR	BROKEN TOP, COMPETETION
1569 1570	Picea abies Picea abies	NORWAY SPRUCE NORWAY SPRUCE	Remove Offsite	-	-	11 13			OOD OOD		1689 1690	Acer negundo Populus deltoides	BOXELDER EASTERN COTTONWOOD	Remove Remove	-	-	6 18			POOR FAIR	LEAN, ROT, DIEBACK DIEBACK
1571 1572	Picea abies Picea abies	NORWAY SPRUCE NORWAY SPRUCE	Offsite Offsite	-	-	12		G	OOD AIR	COMPETETION	1691	Populus deltoides	EASTERN COTTONWOOD	Remove	-	-	6			POOR	LEAN, SUPRESSION
1573	Picea abies	NORWAY SPRUCE	Offsite	-	-	13		G	OOD	COMPETETION	1692 1693	Populus deltoides Populus deltoides	EASTERN COTTONWOOD EASTERN COTTONWOOD	Remove Remove	-	-	19			GOOD FAIR	COMPETETION
1574 1575	Picea abies Picea abies	NORWAY SPRUCE NORWAY SPRUCE	Offsite Offsite	-	-	12 TV 14	/IN 1		OOD OOD		1694 1695	Populus deltoides Populus deltoides	EASTERN COTTONWOOD EASTERN COTTONWOOD	Remove Remove	-	-	12 17			FAIR GOOD	LEAN, COMPETETION
1576 1577	Pinus nigra Pinus nigra	AUSTRIAN PINE AUSTRIAN PINE	Offsite Offsite	-	-	17 15			AIR	BIRDPECK, DIEBACK BIRDPECK, DIEBACK	1696 1697	Ulmus pumila Populus deltoides	SIBERIAN ELM EASTERN COTTONWOOD	Remove Remove	-	-	8 6			FAIR FAIR	SUPRESSION COMPETETION
1578	Pinus nigra	AUSTRIAN PINE EASTERN WHITE PINE	Offsite Offsite	-	-	17			OOD	UTITLITY TRIM, THIN CROWN	1698	Úlmus pumila	SIBERIAN ELM	Remove	-	Yes	8			POOR	LEAN, SUPRESSION
1579 1580	Pinus strobus Pinus nigra	<b>AUSTRIAN PINE</b>	Offsite	-	-	13		P	OOR	UTITLITY TRIM, INSECT	1700	Populus deltoides Acer platanoides	EASTERN COTTONWOOD NORWAY MAPLE	Remove Remove	-	-	6			GOOD POOR	SUPRESSION
1581 1582	Pinus nigra Pinus strobus	AUSTRIAN PINE EASTERN WHITE PINE	Offsite Offsite	-	-	15 6			OOR OOR	UTILITY TRIM, INSECT UTILITY TRIM, DIEBACK, THIN CROWN	1701 1702	Populus deltoides Populus deltoides	EASTERN COTTONWOOD EASTERN COTTONWOOD	Remove Remove	-	-	8 10			FAIR GOOD	COMPETETION
1583 1584	Pinus nigra Pinus nigra	AUSTRIAN PINE AUSTRIAN PINE	Offsite Offsite	-	-	16 18			OOR OOR	UTILITY TRIM, THIN CROWN UTILITY TRIM, INSECT, BIRD PECK	1703 1704	Populus deltoides Populus deltoides	EASTERN COTTONWOOD EASTERN COTTONWOOD	Remove Remove	-	-	6 10			GOOD GOOD	
1585 1586	Pinus strobus Pinus nigra	EASTERN WHITE PINE AUSTRIAN PINE	Offsite Offsite	-	-	7		Р	OOR OOR	UTILITY TRIM, ONE BRANCH LEFT LEAN, BIRD PECK, UTILITY TRIM	1705	Populus deltoides	EASTERN COTTONWOOD EASTERN COTTONWOOD	Remove	-	-	11			GOOD GOOD	
1587	Pinus nigra	<b>AUSTRIAN PINE</b>	Offsite	-	-	18		Р	OOR	UTILITY TRIM, INSECT, BIRD PECK	1706 1707	Populus deltoides Populus deltoides	EASTERN COTTONWOOD	Remove Remove	-	-	10			GOOD	
1588 1589	Malus spp. Malus spp.	APPLE APPLE	Save Remove	-	-	9 TV 8 MU			AIR AIR	UTILTY TRIM UTILTY TRIM, VINES	1708 1709	Populus deltoides Populus deltoides	EASTERN COTTONWOOD EASTERN COTTONWOOD	Remove Remove	-	-	11 12			GOOD GOOD	
1590 1591	Acer negundo Rhamnus cathartica	BOXELDER COMMON BUCKTHORN	Remove Save	-	-	9 6			AIR	LEAN, UTITLTY TRIM VINES, COMPETETION	1710 1711	Ulmus pumila Populus deltoides	SIBERIAN ELM EASTERN COTTONWOOD	Remove Remove	-	Yes -	10 6			POOR FAIR	DIEBACK, ROT VINES
1592 1593	Rhamnus cathartica Acer negundo	COMMON BUCKTHORN BOXELDER	Save Remove	-	-	6 MU	LTI	Р	OOR AIR	VINES, DIEBACK LEAN, DIEBACK	1712	Populus deltoides	EASTERN COTTONWOOD	Remove	-	-	10			FAIR	VINES SUPRESSION
1594	Populus deltoides	EASTERN COTTONWOOD	Save	-	-	33 TW		2 P	OOR	ROT, DIEBACK, VINES	1714 1715	Populus deltoides Populus deltoides	EASTERN COTTONWOOD EASTERN COTTONWOOD	Remove Remove	-	-	7			POOR POOR	BROKEN TOP, ROT
1595 1596	Catalpa spp. Catalpa spp.	NORTHERN CATALPA NORTHERN CATALPA	Remove Remove	-	-	12 MU 6	LTI 11	•	OOR AIR	ROT, VINES, TREE STAND SUPRESSION	1716 1717	Populus deltoides Populus deltoides	EASTERN COTTONWOOD EASTERN COTTONWOOD	Remove Remove	-	-	6 8			FAIR GOOD	SUPRESSION
1597 1598	Populus deltoides Acer negundo	EASTERN COTTONWOOD BOXELDER	Remove Remove	-	-	10 8			AIR OOR	COMPETETION LEAN, SUPRESSION	1718 1719	Populus deltoides Populus deltoides	EASTERN COTTONWOOD EASTERN COTTONWOOD	Remove Remove	-	-	8 7			FAIR FAIR	VINES SUPRESSION
1599 1600	Populus deltoides Populus deltoides	EASTERN COTTONWOOD EASTERN COTTONWOOD	Remove Remove	-	-	20 TV	/IN 1	6 P		FUNGUS, ROT, DIEBACK BROKEN TOP, ROT, DIEBACK	1720 1721	Populus deltoides Populus deltoides	EASTERN COTTONWOOD EASTERN COTTONWOOD	Remove Remove	-	-	16 10			FAIR FAIR	DIEBACK COMPETETION
1601	Populus deltoides	EASTERN COTTONWOOD	Remove	-	-	11			OOR	LEAN, SUPRESSION, DIEBACK	1722	Populus deltoides	EASTERN COTTONWOOD	Remove	-	-	10			FAIR	COMPETETION
1602 1603	Rhamnus cathartica Malus spp.	COMMON BUCKTHORN APPLE	Remove Save	-	-		LTI 7,	6,6 P	OOR	ROT, DIEBACK, SUPRESSION UTILTIY TRIM, ROT	1723 1724	Populus deltoides Salix spp.	EASTERN COTTONWOOD WILLOW	Remove Remove	-	-	6 8			FAIR FAIR	COMPETETION DIEBACK
1604 1605	Prunus serotina Crataegus spp.	BLACK CHERRY HAWTHORN	Remove Remove	-	-	10 6 MU	LTI	_	AIR AIR	COMPETETION DIEBACK, ROT	1725 1726	Populus deltoides Populus deltoides	EASTERN COTTONWOOD EASTERN COTTONWOOD	Remove Remove	-	-	18 6	TWIN		FAIR FAIR	FUNGUS COMPETETION
1606 1607	Rhamnus cathartica Prunus serotina	COMMON BUCKTHORN BLACK CHERRY	Remove Remove	-	-	8 <b>M</b> U	LTI		OOR AIR	BROKEN TOP, ROT, DIEBACK VINES	1727 1728	Populus deltoides Populus deltoides	EASTERN COTTONWOOD EASTERN COTTONWOOD	Remove Remove	-	-		TWIN TWIN	11	FAIR GOOD	DIEBACK
1608	Malus spp.	APPLE BLACK CHERRY	Save	-	-	6 MU	LTI		AIR	VINES, UTILITY TRIM SEAMS, METAL FENCE, VINES, DIEBACK	1729	Populus deltoides	EASTERN COTTONWOOD	Remove	-	-	10 -			GOOD	
1609 1610	Prunus serotina Prunus serotina	BLACK CHERRY	Remove Remove	-	-	15 TW	VIIN .		OOR	VINES, LIGHTING, METAL FENCE, ROT	1730 1731	Populus deltoides Populus deltoides	EASTERN COTTONWOOD EASTERN COTTONWOOD	Remove Remove	-	-	8			GOOD GOOD	
1611 1612	Acer negundo Salix spp.	BOXELDER WILLOW	Remove Remove	-	-	16 TW 22 MU			OOR OOR	VINES, ROT, DIEBACK DIEBACK, ROT, VINES	1732 1733	Populus deltoides Acer negundo	EASTERN COTTONWOOD BOXELDER	Remove Save	-	-	6 9			GOOD FAIR	VINES
1613 1614	Salix spp. Salix spp.	WILLOW WILLOW	Remove Remove	-	-	17 TW 24 MU	/IN 1 LTI 16		OOR OOR	VINES, ROT, DIEBACK ROT, DIEBACK	1734 1735	Prunus serotina Prunus serotina	BLACK CHERRY BLACK CHERRY	Save Save	-	-	13 I	MULTI	11	POOR FAIR	ROT, DIEBACK, VINES VINES, COMPETETION
1615 1616	Salix spp. Salix spp.	WILLOW WILLOW	Remove Remove	-	-	20 19		Р	OOR OOR	ROT, DIEBACK, SUPRESSION VINES, ROT, DIEBACK	1736 1737	Prunus serotina Prunus serotina	BLACK CHERRY BLACK CHERRY	Save	-	-	7	TWIN		FAIR POOR	COMPETETION LEAN, VINES
1617	Acer negundo	BOXELDER BOXELDER	Remove	-	-	19 11 MU	LTI	Р	OOR	DIEBACK, LEAN, ROT, MECHANICAL DAMAGE MECHANICAL DAMAGE	1738	Prunus se rotina	BLACK CHERRY	Save Save	-	-	6			POOR	LEAN, ROT
1618 1619	Acer negundo Carya cordiformis	BITTERNUT HICKORY	Remove Remove	-	-	9		G	AIR OOD	WESTARISAL DAWASE	1739 1740	Prunus serotina Prunus serotina	BLACK CHERRY BLACK CHERRY	Save Save	-	-	8 10			POOR POOR	LEAN, ROT, VINES LEAN, SEAM, COMPETETION
1620 1621	Populus deltoides Acer negundo	EASTERN COTTONWOOD BOXELDER	Remove Remove	-	-	28 7		F	OOD AIR	SUPRESSION	1741 1742	Prunus serotina Prunus serotina	BLACK CHERRY BLACK CHERRY	Save Save	-	-		TWIN TWIN	6	POOR POOR	SEAM, ROT, VINES, DIEBACK DIEBACK, VINES, COMPETETION
1622 1623	Acer negundo Acer negundo	BOXELDER BOXELDER	Remove Remove	-	-	6 6			AIR OOD	LEAN, SUPRESSION	1743 1744	Prunus serotina Prunus serotina	BLACK CHERRY BLACK CHERRY	Save Save	-	-	6 8			POOR POOR	INSECT, BIRD PECK, LEAN LEAN, VINES, DIEBACK
1624 1625	Populus deltoides Populus deltoides	EASTERN COTTONWOOD EASTERN COTTONWOOD	Remove Remove	<u>.</u>	•	11 18 T\^	/IN 4	F	AIR OOD	COMPETETION	1745 1746	Prunus serotina	BLACK CHERRY BLACK CHERRY	Save	-	-	12			FAIR POOR	LEAN, SEAM LEAN, SEAM, ROT, INSECT
1626	Populus deltoides	EASTERN COTTONWOOD	Remove	-	-	12	VIIN I	F	AIR	COMPETETION	1747	Prunus serotina Prunus serotina	BLACK CHERRY	Save Remove	-	-	8			POOR	VINES, INSECT, LEAN
1627 1628	Populus deltoides Populus deltoides	EASTERN COTTONWOOD EASTERN COTTONWOOD	Remove Remove	-	-	12 11			AIR OOR	COMPETETION DEAD TOP	1748 1749	Prunus serotina Prunus serotina	BLACK CHERRY BLACK CHERRY	Remove Remove	-	-	13 10			FAIR POOR	DIEBACK INSECT, ROT, DIEBACK
1629 1630	Populus deltoides Populus deltoides	EASTERN COTTONWOOD EASTERN COTTONWOOD	Remove Remove	-	-	7 11			OOR AIR	LEAN, SUPRESSION COMPETETION	1750 1751	Prunus serotina Prunus serotina	BLACK CHERRY BLACK CHERRY	Remove Remove	-	-	11 6			POOR POOR	ROT, DIEBACK, LEAN, INSECT COMPETETION, JUNK PILE
1631 1632	Populus deltoides Populus deltoides	EASTERN COTTONWOOD EASTERN COTTONWOOD	Remove Remove	-	-	11 6			AIR OOR	DIEBACK, COMPETETION SUPRESSION	1752	Prunus serotina	BLACK CHERRY	Remove	-	-	7			POOR	LEAN, VINES
1633	Populus deltoides	EASTERN COTTONWOOD	Remove	<u>-</u>	•	9		G	OOD	55. A <b>.55.5.</b>	1753 1754	Prunus serotina Prunus serotina	BLACK CHERRY BLACK CHERRY	Remove Remove	-	-	, 8 -			POOR POOR	LEAN, VINES LEAN, VINES
1634 1635	Populus deltoides Populus deltoides	EASTERN COTTONWOOD EASTERN COTTONWOOD	Remove Remove	-	-	14 12		G	OOD OOD		1755 1756	Prunus serotina Prunus serotina	BLACK CHERRY BLACK CHERRY	Remove Remove	-	-	7 8			FAIR POOR	LEAN LEAN, ROT, JUNK PILE
1636 1637	Populus deltoides Populus deltoides	EASTERN COTTONWOOD EASTERN COTTONWOOD	Remove Remove	-	-	10 8			AIR OOR	COMPETETION HOLLOW, ROT, SUPRESSION	1757 1758	Malus spp. Prunus serotina	APPLE BLACK CHERRY	Remove Remove	-	-	6 7	TWIN	6	POOR GOOD	ROT, DIEBACK, EPICORMIC BRANCHING
1638 1639	Populus deltoides Populus deltoides	EASTERN COTTONWOOD EASTERN COTTONWOOD	Remove Remove	-	-	9 8		G	OOD AIR		1759	Acer saccharum	SUGAR MAPLE BLACK CHERRY	Remove	-	-	9	TWIN		GOOD	DIERACK
1640	Populus deltoides	EASTERN COTTONWOOD	Remove	-	-	8		Р	OOR	LEAN SUPRESSION	1760 1761	Prunus serotina Populus deltoides	EASTERN COTTONWOOD	Remove Remove	-	-	7	ı vv IIV		FAIR POOR	DIEBACK VINES
1641 1642	Populus deltoides Populus deltoides	EASTERN COTTONWOOD EASTERN COTTONWOOD	Remove Remove	-	-	12		G	OOR OOD	LEAN SUPRESSION	1762 1763	Prunus serotina Ulmus pumila	BLACK CHERRY SIBERIAN ELM	Remove Remove	-	- Yes	12 6	TWIN		POOR POOR	VINES, DIEBACK, SEAM VINES
1643 1644	Acer negundo Populus deltoides	BOXELDER EASTERN COTTONWOOD	Remove Remove	-	-	6 13		G	OOR OOD	LEAN VINES	1764 1765	Acer negundo Rhamnus cathartica	BOXELDER COMMON BUCKTHORN	Remove Remove	-	-	7 6			FAIR POOR	LEAN ROT, FUNGUS
1645 1646	Acer negundo Populus deltoides	BOXELDER EASTERN COTTONWOOD	Remove Remove	-	-	8 21		Р	OOR OOD	LEAN, VINES	1766 1767	Rhamnus cathartica Acer platanoides	COMMON BUCKTHORN NORWAY MAPLE	Remove Remove	-	<u>-</u>		TWIN TWIN	14	POOR FAIR	ROT, DIEBAK, UTITLITY TRIM DIEBACK
1647 1648	Fraxinus pennsylvanica Carya cordiformis		Save Save	-	Yes	12		Р	OOR OOD	VINES, INSECT, DIEBACK	1768	Prunus serotina	BLACK CHERRY	Remove	-	-	14	. ** IIV	1-7	FAIR	DIEBACK, VINES
1649	Fraxinus pennsylvanica	GREEN ASH	Save	-	Yes	6		Р	OOR	ULITILY TRIM, INSECT	1769 1770	Acer negundo Salix spp.	BOXELDER WILLOW	Remove Remove	-	-	о 39			POOR FAIR	LEAN, UTITLITY TRIM DIEBACK, VINES
1650 1651	Fraxinus pennsylvanica Populus deltoides	EASTERN COTTONWOOD	Save Save	-	Yes -	, 11		G	OOR OOD	INSECT	1771 1772	Acer saccharum Acer negundo	SUGAR MAPLE BOXELDER	Offsite Remove	-	-	7 8			POOR POOR	VINES LEAN, VINES
1652	Populus deltoides	EASTERN COTTONWOOD	Save	-	-	14		G	OOD		1773	Acer negundo	BOXELDER	Remove	-	-	6			FAIR	LEAN



landscape architecture / land planning

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LEGEND

Note: This Tree Survey was prepared by Nowak & Fraus Engineers

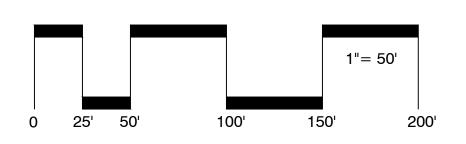

sheet title:

## Tree Survey

■ project title:

## Brewster Village

City of Rochester Hills, MI

■ prepared for:

Robertson Brothers Homes 6905 Telegraph Rd. - Suite 200 Bloomfield Hills, MI 48301

Phone: 248.644.3460

■ job number:	■ date:
17031	08.02.2018
■ drawn by:	■ checked by:
EMJ	WTK

■ revisions: 10.12.2018 Per Site Redesign
11.13.2018 Per Municipal Review
01.23.2019 Per Municipal Review
02.25.2019 Per Municipal Review

Know what's below.

Call before you dig.

sheet no.

L-4

Tree # 1774 1775 1776 1777 1778 1779 1780 1781 1782 1783	Botanical Name Acer negundo Acer negundo Fraxinus pennsylvanica Acer negundo Acer negundo Malus spp.	Common Name  BOXELDER  BOXELDER  GREEN ASH	To be Saved/ Removed Remove Remove	<u>Landmark/</u> <u>Historic</u> -	Exempt -	<u>Dia.</u>	<u>Type</u>	Other Dia.	Condition	<u>Comments</u>
1775 1776 1777 1778 1779 1780 1781 1782 1783	Acer negundo Fraxinus pennsylvanica Acer negundo Acer negundo Malus spp.	BOXELDER GREEN ASH		-	_	c			D00D	
1776 1777 1778 1779 1780 1781 1782 1783	Fraxinus pennsylvanica Acer negundo Acer negundo Malus spp.	GREEN ASH	Remove			6			POOR	VINES
1777 1778 1779 1780 1781 1782 1783	Acer negundo Acer negundo Malus spp.			-	-	6			FAIR	VINES
1778 1779 1780 1781 1782 1783	Acer negundo Malus spp.	DOVEL DED	Remove	-	Yes	9			POOR	VINES
1779 1780 1781 1782 1783	Malus spp.	BOXELDER	Remove	-	-	9	TWIN	6	POOR	LEAN, VINES, DIEBACK
1780 1781 1782 1783	• •	BOXELDER	Remove	-	-	13	TWIN	8	POOR	ROT, DIEBACK, INSECT
1781 1782 1783		APPLE	Remove	-	-	6	TWIN	6	GOOD	
1782 1783	Prunus serotina	BLACK CHERRY	Remove	-	-	19	TWIN	12	POOR	ROT, DIEBACK, VINES
1783	Prunus serotina	BLACK CHERRY	Remove	-	-	16			POOR	ROT, DIEBACK, INSECT
	Ulmus americana	AMERICAN ELM	Remove	-	-	13			FAIR	VINES
	Crataegus spp.	HAWTHORN	Remove	-	-	7			FAIR	VINES
1784	Prunus serotina	BLACK CHERRY	Remove	-	-	9			GOOD	
1785	Pyrus spp.	PEAR	Remove	-	-	10			FAIR	UTITLITY TRIM
1786	Malus spp.	APPLE	Remove	-	-	6			POOR	LEAN, VINES, DIEBACK, UTILTIY TRIM
1787	Malus spp.	APPLE	Remove	-	-	7			FAIR	VINES
1788	Prunus serotina	BLACK CHERRY	Remove	-	-	7			POOR	UTILTIY TRIM, SEAM, ROT
1789	Malus spp.	APPLE	Remove	-	-	7			FAIR	VINES
1790	Acer negundo	BOXELDER	Remove	-	-	7			POOR	VINES, ROT, DIEBACK
1791	Acer negundo	BOXELDER	Remove	-	-	6			POOR	VINES
1792	Prunus serotina	BLACK CHERRY	Remove	-	-	6			POOR	VINES
1793	Prunus serotina	BLACK CHERRY	Remove	-	-	8			GOOD	
1794	Prunus serotina	BLACK CHERRY	Remove	-	-	8			POOR	VINES, DIEBACK, ROT
1795	Ulmus americana	AMERICAN ELM	Remove	-	-	11			FAIR	INSECT
1796	Pyrus spp.	PEAR	Remove	-	-	10			FAIR	DIEBACK, SUPRESSION
1797	Malus spp.	APPLE	Remove	-	-	7			GOOD	
1798	Prunus serotina	BLACK CHERRY	Remove	-	-	13	MULTI	11,11	POOR	ROT, FUNGUS, DIEBACK, VINES
1799	Ulmus americana	AMERICAN ELM	Remove	-	-	12			FAIR	VINES, COMPETETION
1800	Malus spp.	APPLE	Remove	-	-	8			FAIR	VINES
1801	Prunus serotina	BLACK CHERRY	Remove	-	-	6			POOR	FUNGUS
1802	Prunus serotina	BLACK CHERRY	Remove	-	-	7			POOR	FUNGUS, ROT
1803	Prunus serotina	BLACK CHERRY	Remove	-	-	7			POOR	FUNGUS, VINES
1804	Prunus serotina	BLACK CHERRY	Remove	-	-	6	TWIN		POOR	MECHANICAL DAMAGE, ROT
1805	Prunus serotina	BLACK CHERRY	Remove	-	-	6	TWIN		POOR	VINES, DIEBACK
1806	Acer negundo	BOXELDER	Remove	-	-	8			POOR	MECHANICAL DAMAGE, ROT
1807	Pyrus spp.	PEAR	Remove	-	-	8			FAIR	VINES
1808	Pyrus spp.	PEAR	Remove	-	-	8			FAIR	COMPETETION
1809	Pyrus spp.	PEAR	Remove	-	-	14	TWIN	8	FAIR	DIEBACK, UTITLITY TRIM
1810	Pyrus spp.	PEAR	Remove	-	-	8			FAIR	VINES, COMPETETION
1811	Pyrus spp.	PEAR	Remove	-	-	7			FAIR	COMPETETION
1812	Pyrus spp.	PEAR	Remove	-	-	6			FAIR	COMPETETION
1813	Pyrus spp.	PEAR	Remove	-	-	6	TWIN		POOR	UTILITY TRIM, COMPETETION
1814	Pyrus spp.	PEAR	Remove	-	-	9			GOOD	
1815	Pyrus spp.	PEAR	Remove	-	-	6			FAIR	COMPETETION
1816	Pyrus spp.	PEAR	Remove	-	-	6			GOOD	
1817	Pyrus spp.	PEAR	Remove	-	-	8			GOOD	
1818	Prunus serotina	BLACK CHERRY	Remove	-	-	15	MULTI	11, 10	POOR	ROT, DIEBACK, FUNGUS
1819	Quercus rubra	RED OAK	Remove	-	-	10			GOOD	
1820	Prunus serotina	BLACK CHERRY	Remove	-	-	11	MULTI	6	POOR	DIEBACK, ROT
1821	Prunus serotina	BLACK CHERRY	Remove	-	-	15	MULTI	7,6,6,6	FAIR	DIEBACK
1822	Ulmus pumila	SIBERIAN ELM	Remove	-	Yes	13			FAIR	FUNGUS, VINES
1823	Rhamnus cathartica	COMMON BUCKTHORN	Remove	-	-	8			FAIR	VINES
1824	Malus spp.	APPLE	Remove	-	-	6	MULTI		FAIR	VINES
1825	Prunus serotina	BLACK CHERRY	Remove	-	-	7			FAIR	WEAK UNION
1826	Malus spp.	APPLE	Remove	-	-	6			POOR	LEAN, VINES, SUPRESSION
1827	Prunus serotina	BLACK CHERRY	Remove	-	-	7			FAIR	VINES
1828	Acer platanoides	NORWAY MAPLE	Remove	-	-	19		4.0	FAIR	DIEBACK
1829	Prunus serotina	BLACK CHERRY	Remove	-	-	13	TWIN	10	FAIR	ROT, DIEBACK
1830	Prunus serotina	BLACK CHERRY	Remove	-	-	6	TWIN	6	FAIR	COMPETETION
1831	Prunus serotina	BLACK CHERRY	Remove	-	-	6	MULTI		FAIR	COMPETETION
1832	Prunus serotina	BLACK CHERRY	Remove	-	-	6			FAIR	COMPETETION
1833	Prunus serotina	BLACK CHERRY	Remove	-	-	6			FAIR	COMPETETION
1834	Prunus serotina	BLACK CHERRY	Remove	-	-	8	MULTI	6	FAIR	LEAN, COMPETETION
1835	Prunus serotina	BLACK CHERRY	Remove	-	-	13	MULTI	11,8,6	FAIR	VINES, DIEBACK
1836	Prunus serotina	BLACK CHERRY	Remove	-	-	10	TWIN	8	GOOD	
1837	Prunus serotina	BLACK CHERRY	Remove	-	-	7			FAIR	LEAN, VINES, SEAM
1838	Prunus serotina	BLACK CHERRY	Remove	-	-	6			FAIR	LEAN, SUPRESSION
1839	Prunus serotina	BLACK CHERRY	Remove	-	-	10	TWIN	6	FAIR	DIEBACK, VINES
1840	Prunus serotina	BLACK CHERRY	Remove	-	-	10	TWIN	6	FAIR	DIEBACK, COMPETETION
1841	Prunus serotina	BLACK CHERRY	Remove	-	-	10		_	FAIR	VINES, COMPETETION
1842	Prunus serotina	BLACK CHERRY	Remove	-	-	16	TWIN	10	FAIR	DIEBACK
1843	Pyrus spp.	PEAR	Remove	-	-	10	MULTI		FAIR	COMPETETION
1844	Prunus serotina	BLACK CHERRY	Remove	-	-	8	MULTI		POOR	VINES, ROT, DIEBACK
1845	Prunus serotina	BLACK CHERRY	Remove	-	-	21			FAIR	VINES, DIEBACK
1846	Prunus serotina	BLACK CHERRY	Remove	-	-	8			FAIR	ROT, SUPRESSION
1847	Prunus serotina	BLACK CHERRY	Remove	-	-	10	TWIN	8	FAIR	DIEBACK, FUNGUS
1848	Prunus serotina	BLACK CHERRY	Remove	-	-	8	TWIN	6	FAIR	FUNGUS
1849	Acer negundo	BOXELDER	Remove	-	-	13	_		FAIR	FUNGUS, COMPETETION
1850	Prunus serotina	BLACK CHERRY	Remove	-	-	16	TWIN	13	POOR	ROT, DIEBACK, INSECT

Note: This Tree Survey was prepared by Nowak & Fraus Engineers



#### Decorative Mailbox - 16 Gang CBU


Manufacturer: Salsbury Industries 1010 E. 62nd St. Los Angeles, CA 90001 www.mailboxes.com Model: Regency Decorative CBU Quantity: 2




#### Bike Repair Station Detail

Manufacturer: Duo-Gard Industries, Inc. 40442 Koppernick Rd. Canton, MI 48187 734.207.9700 Model Number: BBRS01B Various Powdercoat Options Available


Quantity:

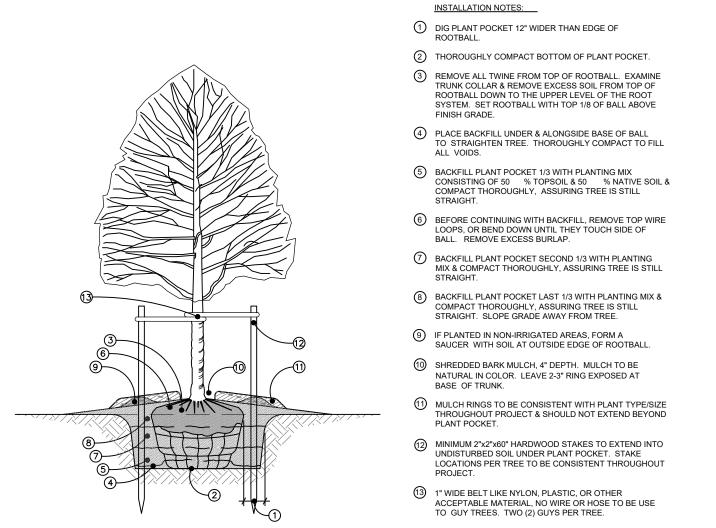

# Deciduous Tree Planting Detail - 4" Cal. and Under

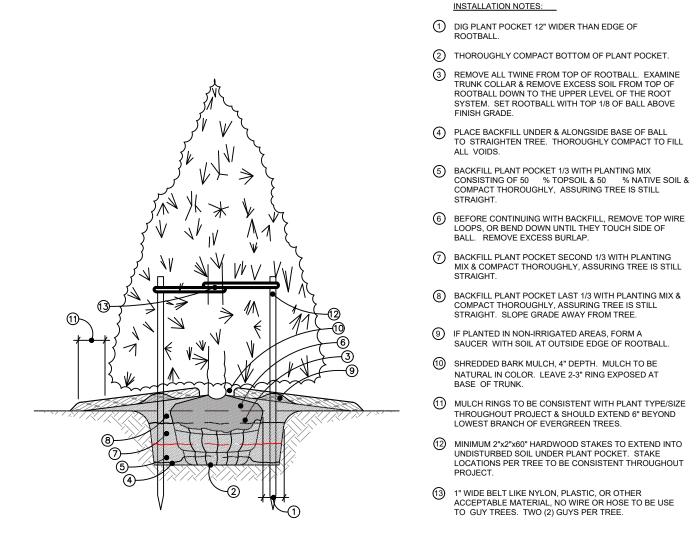


Evergreen Tree Planting Detail - 10' Ht. and Under

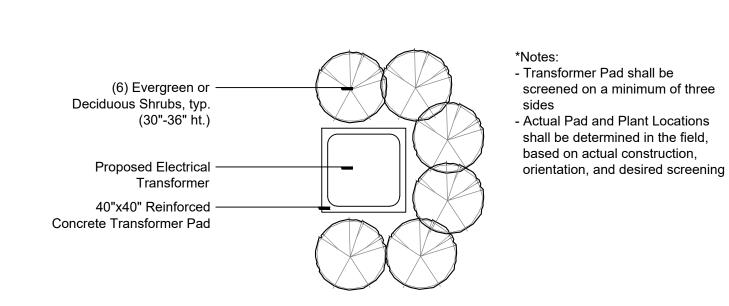

Optional Transformer Screening Detail

Scale: 1/4" = 1'

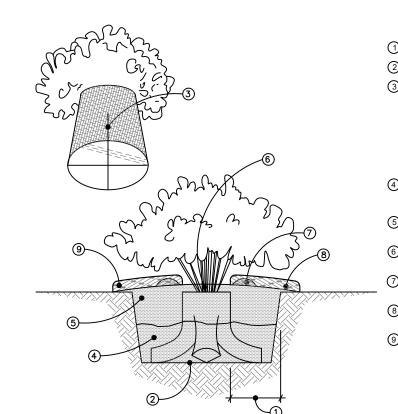


#### INSTALLATION NOTES:

- 1) DIG PLANT POCKET 6" WIDER THAN EDGE OF ROOTBALL. 2 THOROUGHLY COMPACT BOTTOM OF PLANT POCKET.
- 3 REMOVE PLANT FROM CONTAINER AND EXAMINE ROOTMASS. IF ROOTMASS IS LOOSE, INTEGRATE PLANT ROOTS & POTTING MEDIA WITH PLANTING MIX. IF A ROOTBOUND CONDITIONS
  EXISTS, DISRUPT THE ROOTMASS BY CUTTING THROUGH BOTTOM HALF OF ROOTMASS. ROTATE ROOTMASS 90° AND CUT AGAIN, FORMING FOUR (4) LOBES. SPREAD THE FOUR LOBES DISTRUPTING ROOTMASS AND INTEGRATE PLANT ROOTS & POTTING MEADIA WITH PLANTING MIX. PLACE PLANT IN POCKET SLIGHTLY ABOVE GRADE.
- (4) BACKFILL PLANT POCKET 1/2 WITH PLANTING MIX CONSISTING OF 50 % TOPSOIL & 50 % NAITIVE SOIL, ASSURING SHRUB IS
- (5) BACK FILL REMAINING 1/2 OF PLANT POCKET WITH PLANTING MIX & COMPACT THOROUGHLY, ASSURING SHRUB IS STILL STRAIGHT. 6) SPREAD 1" OF PLANTING MIX OVER TOP OF CONTAINER
- (7) IF PLANTED IN NON-IRRIGATED AREAS, FORM A SAUCER WITH 8 SHREDDED BARK MULCH, 4" DEPTH. MULCH TO BE NATURAL IN
- COLOR. LEAVE 1-2" RING EXPOSED AT BASE OF PLANT. 9 IF NOT PLANTED WITHIN A LANDSCAPE BED, MULCH RINGS TO BE CONSISTENT IN SIZE WITH PLANT TYPE/SIZE THROUGHOUT PROJECT.


ROOTBALL. SLOPE GRADE AWAY FROM SHRUB.

## Shrub Planting Detail - Container

Scale: NTS

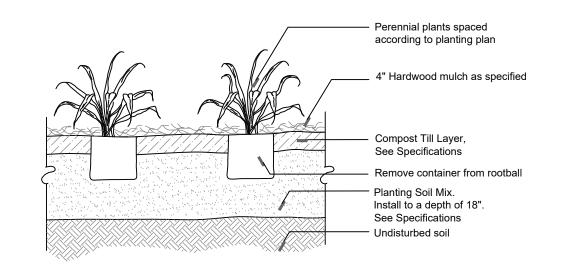

### Perennial Planting Detail

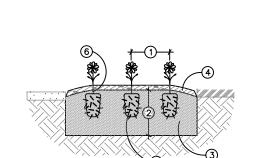


- 1 SEE DRAWING FOR PLANT SPACING.
- (2) EXCAVATE BED TO A MINIMUM 6" DEPTH. BACKFILL WITH PREPARED PLANTING MIX. 3 PLANTING MIX TO CONSIST OF 50% TOPSOIL & 50% LEAF COMPOST.
- DEPTH. MULCH TO BE NATURAL IN COLOR. REMOVE ALL CONTAINERS. IF ROOTBOUND, DISRUPT ROOT PLUG

SHREDDED BARK MULCH, 1"

 PLANT THE ANNUAL OR GROUND COVER PLANT THROUGH THE MULCH INTO THE PLANTING MIX ...JEGH INTO THE PLANTING MIX ASSURING THAT PLANTING MIX COVERS ENTIRE ROOT MASS OF PLANT.

## Annual & Ground Cover Planting Detail

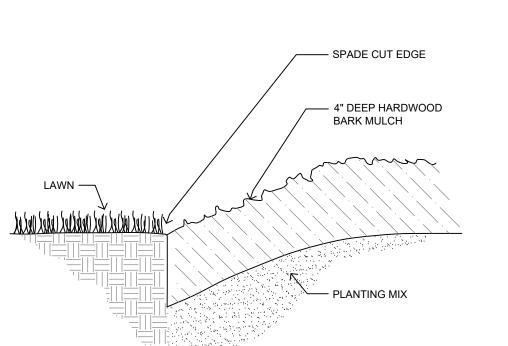

Spade Cut Edging Detail

prepared for: Robertson Brothers Homes 6905 Telegraph Rd. - Suite 200 Bloomfield Hills, MI 48301 Phone: 248.644.3460

City of Rochester Hills, MI

project title:

17031	08.02.2018
■ drawn by:	■ checked by:
EMJ	WTK

Brewster Village

Tree Survey & Details

landscape architecture / land planning

18161 W. Thirteen Mile Rd, Suite B-4


Southfield, MI 48076

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T:: 248.594.3220

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sheet no.

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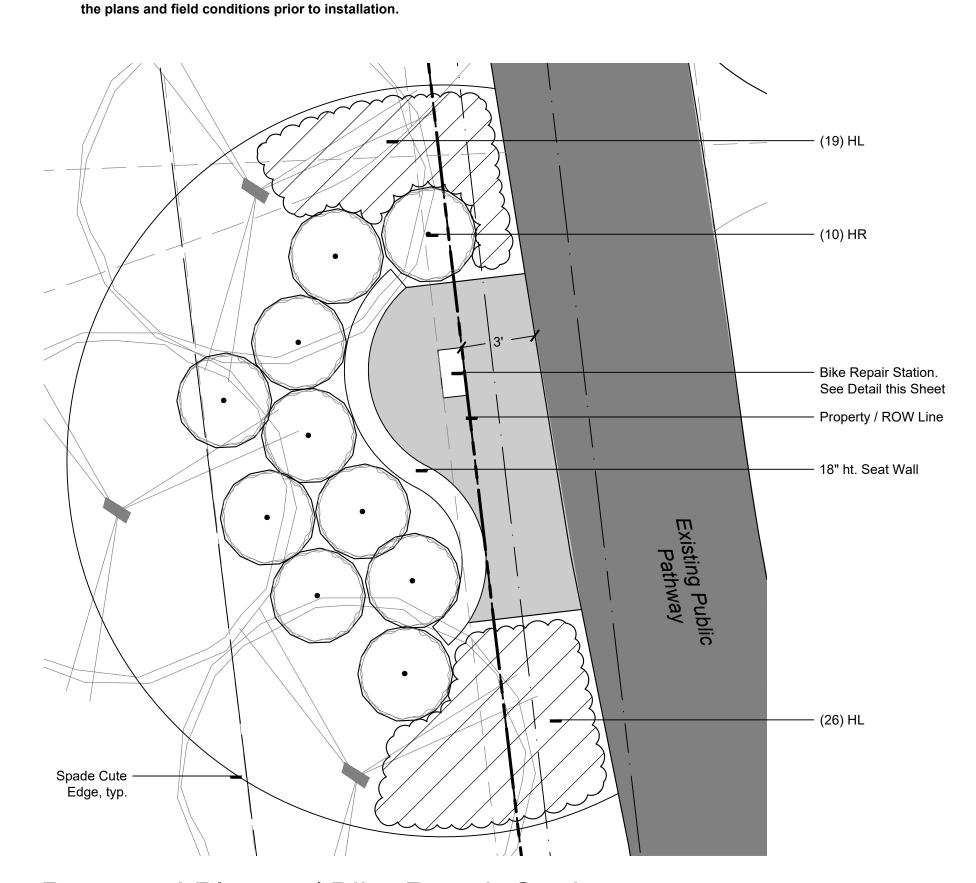
■ revisions:

L-5
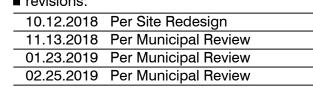
#### Landscape Notes

- 1. All plant material shall be true to name and free from physical damage
- 2. Plants shall be full, well-branched, and in a healthy, vigorous growing
- Plants shall be watered before and after planting is complete. 4. All trees must be staked, fertilized, and mulched and shall be
- guaranteed to exhibit a normal growth cycle for at least one (1) full year following planting.
- 5. All material shall conform to the guidelines established in the most recent edition of the American Standard for Nursery Stock.
- Provide clean backfill soil, using material stockpiled on site. Soil shall be screened and free of any debris, foreign material, or stone.
- "Agriform" tabs or similar slow-release fertilizer shall be added to the planting pits before being backfilled.
- Amended planting mix shall consist of 1/3 screened topsoil, 1/3 sand,
- All plantings shall be mulched with shredded hardwood bark, spread to a minimum depth of 4". Mulch is to be free from debris and foreign
- material and shall contain no pieces of inconsistant size. 10. Any planting area within a wetland, watercourse, or floodplain shall not
- receive mulch, as it is considered fill. 11. The Landscape Contractor shall be responsible for all work shown on
- the landscape drawings and specifications. 12. No substitutions or changes of location, or plant types shall be made
- without the approval of the Landscape Archtiect or Owner's 13. The Landscape Architect shall be notified of any discrepancies between

- 13. The Landscape Contractor shall be responsible for maintaining all
- plant material in a vertical condition throughout the guaranteed period. 14. The Landscape Architect shall have the right at any stage of the installation to reject any work or material that does not meet the requirements of the plane and specifications, if requested by the
- The Contractor shall be responsible for checking plant quantities to ensure quantities on drawings and plant list are the same. In the event of a discrepancy, the quantities on the plans shall prevail.
- 16. The Landscape Contractor shall seed and mulch or sod (as indicated on plans)all areas disturbed during construction, throughout the
- 17. A pre-emergent weed control agent, "Preen" or equal, shall be applied uniformly to all planting beds prior to mulching.
- All lawn areas to be irrigated. The Developer and Landscape Architect reserve the right to change location of plant material and alter plant species/variety at the time of
- installation based upon availability and quantity of material as well as site conditions. Materials will be of similar size, appearance and growth habit.
- All Lawn areas shall be Seeded or Sodded
- 21. All Landscape Areas shall be irrigated by an automatic irrigation system with separate zones for Lawn and Plants. Irrigation systems
- shall only be permitted to run between the hours of 12am & 5am. Prior to the release of the performance bond, the City of Rochester
- Hills must inspect all landscape plantings. 24. Irrigation shall not broadcast onto CITY pathway.



#### Proposed Plaza w/ Bike Repair Station


Scale: 1/4" = 1'

#### Plant Schedule - Total This Sheet

sym.	qty.	botanical name	common name	size	spacing	root	note
HQ	5	Hydrangea quercifolia	Oakleaf Hydrangea	#5	6' o.c.	cont.	
HR	10	Hydrangea quercifolia 'Ruby Slippers'	Ruby Slippers Oakleaf Hydrangea	#5	48" o.c.	cont.	
		ses and Perennials	sommon namo		specing	root	
	ital Gras qty.	ses and Perennials  botanical name	common name	size	spacing	root	note
			common name Karl Foerster Feather Reed Grass	size #2	spacing 24" o.c.	root	note
sym.	qty.	botanical name			<u> </u>		note
sym. CA	qty. 38	botanical name Calamagrostis x acutiflora 'Karl Foerster'	Karl Foerster Feather Reed Grass	#2	24" o.c.	cont.	note


#### **Site Maintenance Notes**

- 1. The owner of the property shall be responsible for all maintenance of site landscaping according to the rules and standards herein.
- 2. Landscaping shall be kept neat, orderly and healthy growing condition, free from debris and refuse.
- 3. Pruning shall be minimal at the time of installation, only to remove dead or diseased branches. Subsequent pruning shall assure proper maturation of plants to achieve their approved purpose.
- 4. All dead, damaged, or diseased plant material shall be removed immediately and replaced within six months after it dies or in the next planting season, whichever occurs first. For purposes of this Section, the planting season for deciduous plants shall be March 1 and June 1 and from October 1 until the prepared soil becomes frozen. The planting season for evergreen plants shall be between March 1 and June 1. Plant material installed to replace dead or diseased material shall be as close to practical to the size of the material it is intended to replace. The City may notify property owners of the need to replace dead, damaged, or diseased material.
- 5. The approved landscape plan shall be considered a permanent record and integral part of the Site Plan Approval. Unless otherwise approved in accordance with the aforementioned procedures, any revisions to or removal of plant materials, or non-conmpliance with the maintenance requirements of this Section 138-12.109 will place the parcel in non-conformity withe the approved landscape plan and be in violation of
- 6. If protected trees are damaged, a fine shall be issued on an inch-by-inch basis at a monetary rate as defined by the Forestry Department.

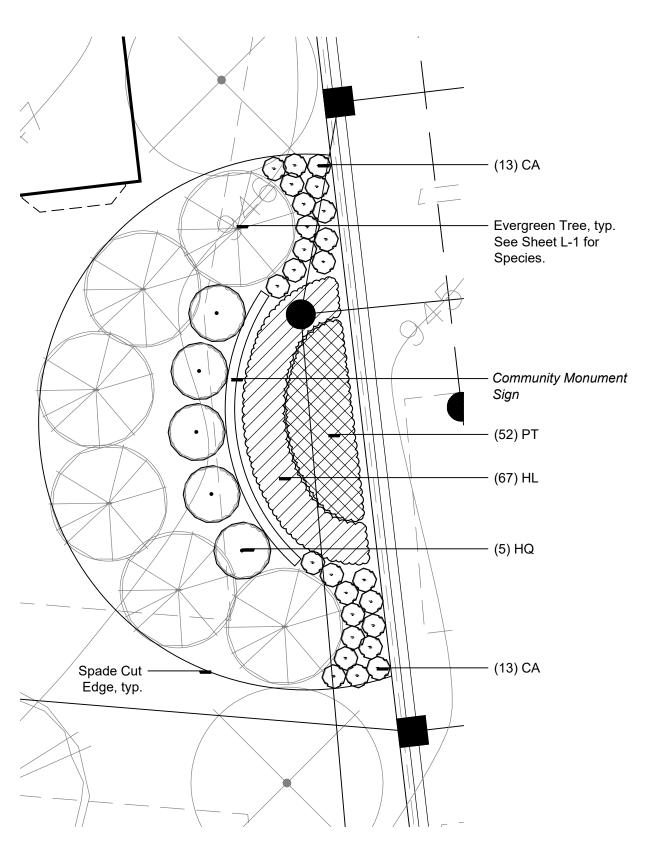

#### Development Sign Landscape Enlargement

Sign must meet the requirements of Section 138-12.306 and Chapter 134 of the City Code of Ordinances and be approved under separate permits issued by the Building Department

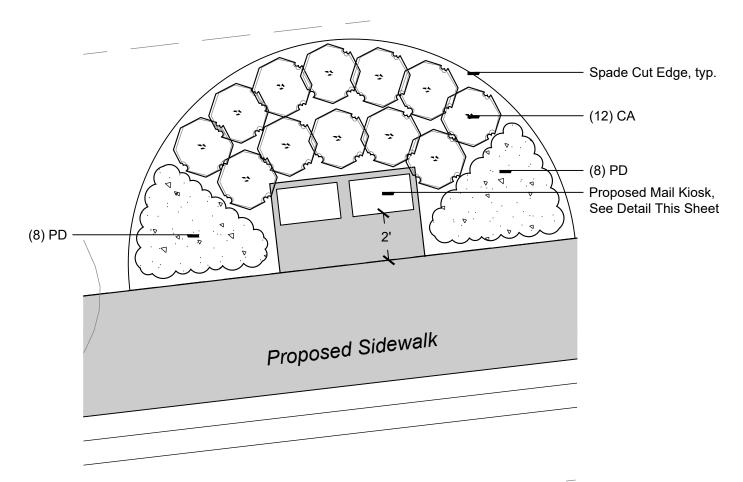

Proposed Mail Kiosk Landscape Enlargement

#### R.O.W. Landscape Notes:

- 1. Prior approval is required to plant any tree or shrub on the public right-of-way.
- 2. All trees and shrubs must be planted at least 10' from the edge of the public road. (Trees must be planted at least 15' away from curb or road edge where the speed limit is more than 35 mph.)
- 3. Shade trees and shrubs must be planted at least 5' from the edge of the public walkway. Evergreen and ornamental trees must be planted at least 10' from the edge of the public walkway.
- 4. No trees or shrubs may be planted within the triangular area formed at the intersection of any street right-of-way lines at a distance along each line of 25' from their point of intersection.
- No trees or shrubs may be planted in the triangular area formed at the intersection of any driveway with a public walkway at a distance along each line of 15' from their point of intersection.
- 6. All trees and shrubs must be planted at least 10' from any fire hydrant.
- 7. Shade and evergreen trees must be at least 15' away from the nearest overhead wire.
- 8. Trees must be planted a minimum of 5' from an underground utility, unless the city's Landscape Architect requires a greater distance.
- 9. Prior to the release of the performance bond, the City of Rochester Hills Forestry Division needs to inspect all trees, existing or planted, to identify any that pose a hazard to the safe use of the public right-of-way. Forestry may require the developer to remove, and possibly replace, any such trees.
- 10. The above requirements are incorporated into the plan.

#### **Brewster Village** Rochester Hills, Michigan Landscape Cost Estimate - 02/25/2019

ltem	Quantity	_	Ur	it Price	 Amount
<u>Trees</u>					
Armstrong Red Maple (3" cal.)	4 EA		\$	489.00	\$ 1,956.00
Armstrong Red Maple (2.5" cal.)	14 EA		\$	405.00	\$ 5,670.00
Autumn Brilliance Serviceberry (2" cal.)	7 EA		\$	340.00	\$ 2,380.00
Eastern White Pine (8' ht.)	30 EA		\$	385.00	\$ 11,550.00
Exclamation London Planetree (2.5" cal.)	15 EA		\$	436.00	\$ 6,540.00
Japanese Zelkova (2" cal.)	29 EA		\$	373.00	\$ 10,817.00
Skyline Thornless Honeylocust (2" cal.)	24 EA		\$	340.00	\$ 8,160.00
Swamp White Oak (3" cal.)	3 EA		\$	450.00	\$ 1,350.00
Swamp White Oak (2" cal.)	11 EA		\$	325.00	\$ 3,575.00
Tulip Tree (3" cal.)	3 EA		\$	425.00	\$ 1,275.00
Tulip Tree (2" cal.)	12 EA		\$	338.00	\$ 4,056.00
White Fir (8' ht.)	44 EA		\$	369.00	\$ 16,236.00
White Spruce (10' ht.)	6 EA		\$	450.00	\$ 2,700.00
White Spruce (8' ht.)	29 EA		\$	300.00	\$ 8,700.00
<u>Shrubs</u>					
Diabolo Ninebark (#5 cont.)	12 EA		\$	46.00	\$ 552.00
Oakleaf Hydrangea (#5 cont.)	5 EA		\$	52.00	\$ 260.00
Ruby Slippers Oakleaf Hydrangea (#5 cont.)	10 EA		\$	60.00	\$ 600.00
<u>Perennials</u>					
Dark Towers Penstemon (#1 cont.)	16 EA		\$	15.00	\$ 240.00
Japanese Pachysandra (#1 cont.)	52 EA		\$	12.00	\$ 624.00
Karl Foerster Feather Reed Grass (#2 cont.)	38 EA		\$	19.00	\$ 722.00
Little Business Daylily (#1 cont.)	112 EA		\$	12.00	\$ 1,344.00
<u>Landscape Materials</u>					
Mulch (4" depth)	41 CY		\$	55.00	\$ 2,255.00
<u>Irrigation</u>					
Irrigation System	1 LS	JM	\$2	0,000.00	\$ 20,000.00
		Estir	na	ted Total	\$ 111,562.00





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■ sheet title:

#### Details & Notes

project title:

## Brewster Village

City of Rochester Hills, MI

prepared for:

**Robertson Brothers Homes** 6905 Telegraph Rd. - Suite 200 Bloomfield Hills, MI 48301

Phone: 248.644.3460


17031	08.02.2018
■ drawn by:	■ checked by:
EMJ	WTK


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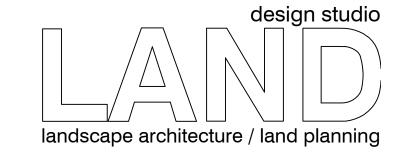
10.12.2018 Per Site Redesign 11.13.2018 Per Municipal Review 02.25.2019 Per Municipal Review







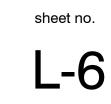

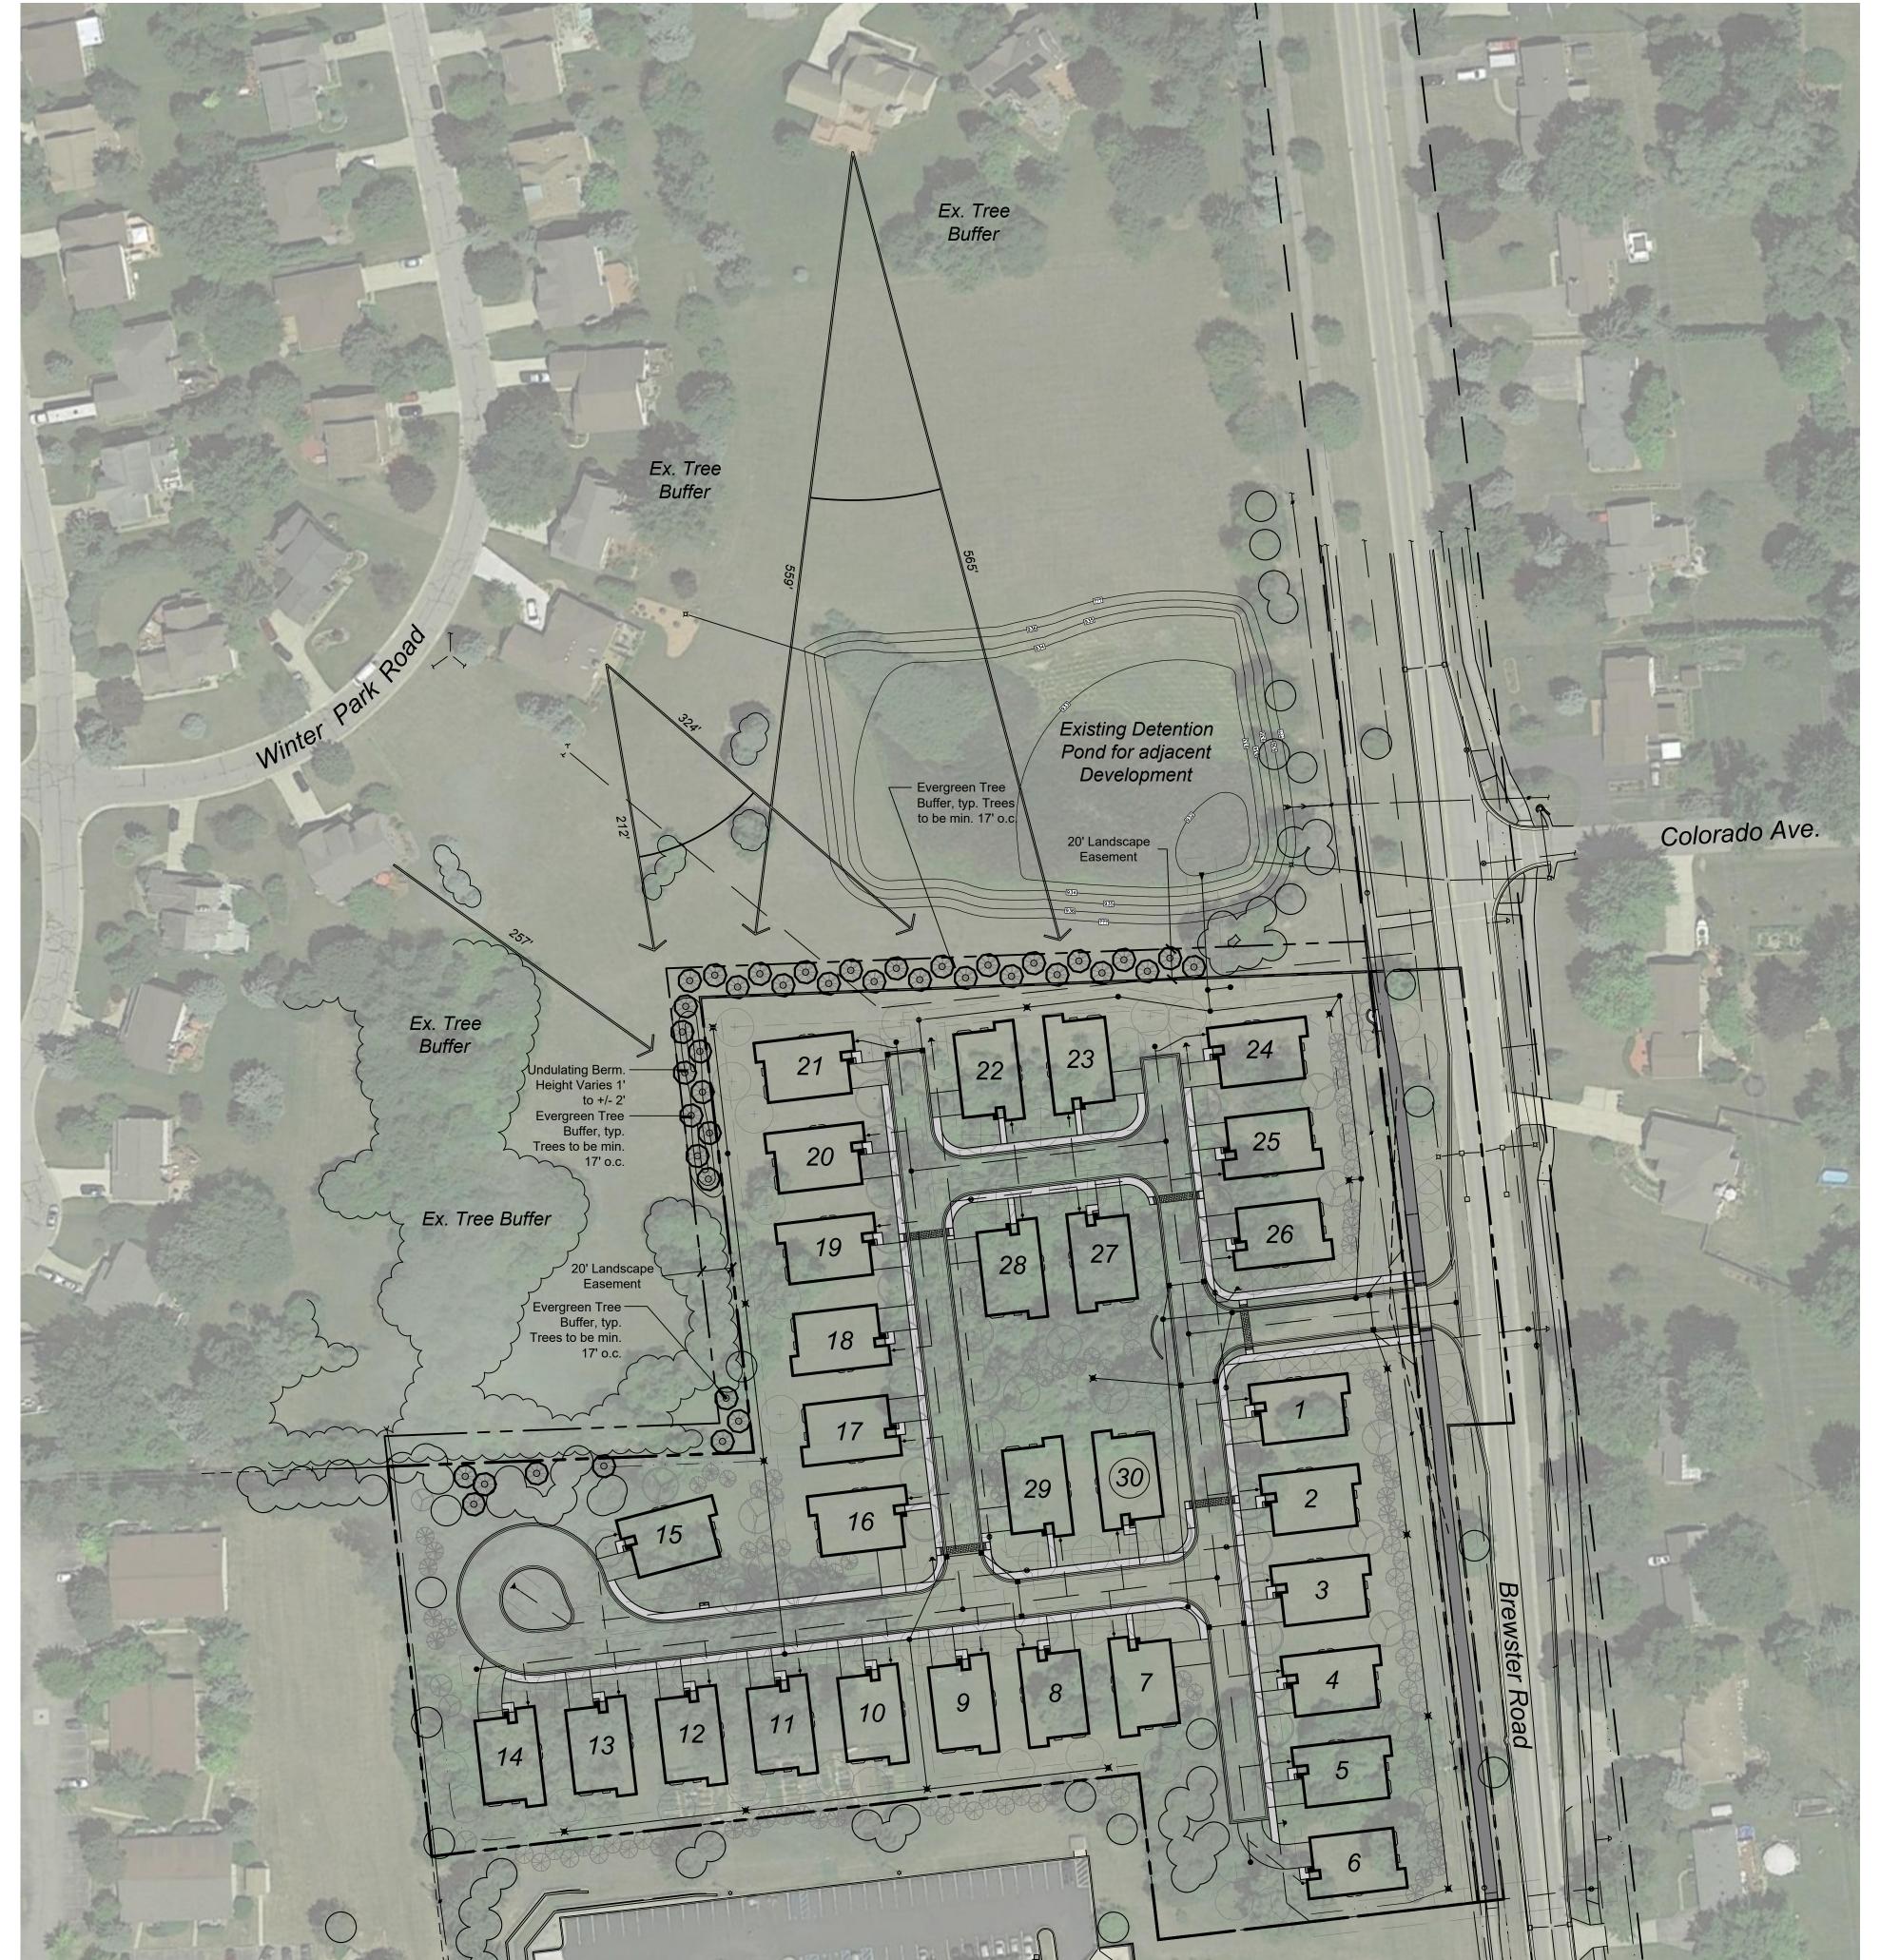

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## Landscape Buffer Plan

■ project title:

## Brewster Village

City of Rochester Hills, MI

■ prepared for:

■ job number:

Robertson Brothers Homes 6905 Telegraph Rd. - Suite 200 Bloomfield Hills, MI 48301

Phone: 248.644.3460


17031 02.25.2019 ■ checked by: ■ drawn by:

WTK EMJ

■ date:



■ revisions:

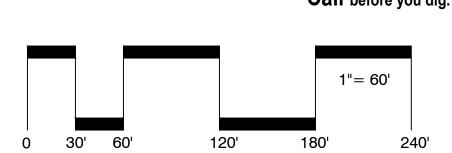





#### Buffer Plant Schedule

Trees						
sym.	qty.	botanical name	common name	size	spacing	root
Α	16	Picea pungens	Blue Spruce	10' ht.	17' o.c.	B&B
В	11	Abies concolor	White Fir	10' ht.	17' o.c.	B&B
С	12	Pica abies	Norway Spruce	10' ht.	17' o.c.	B&B

### Typical Buffer Easement Elevation

\*Note: Tree height and spread in this rendering is indicative of a more mature form, rather than a depiction of size when newly planted.

### Proposed Buffer Tree Information




Blue Spruce
- Height: 50' to 75'
- Spread: 10' to 20'
- Rarely damaged by deer




White Fir
- Height: 30' to 50'
- Spread: 20'
- Occassionally damaged by deer



Norway Spruce
- Height: 40' to 60'
- Spread: 25' to 30'
- Rarely damaged by deer

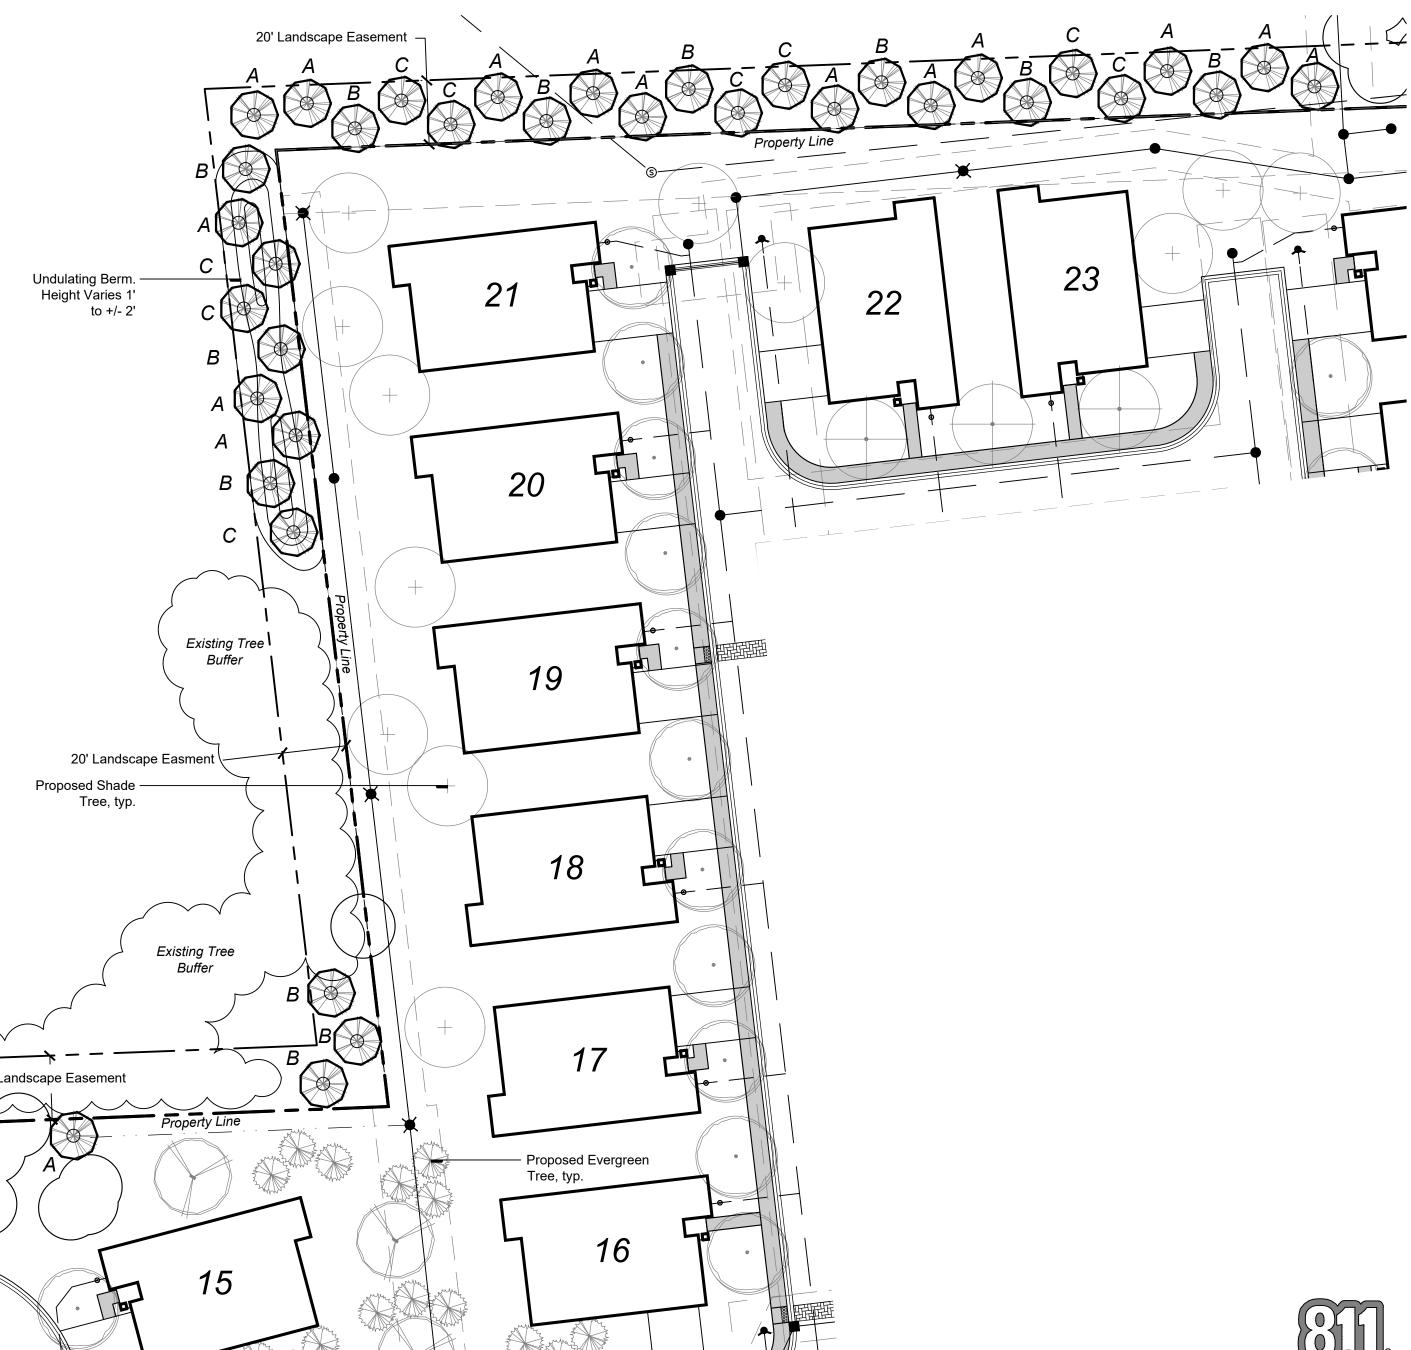

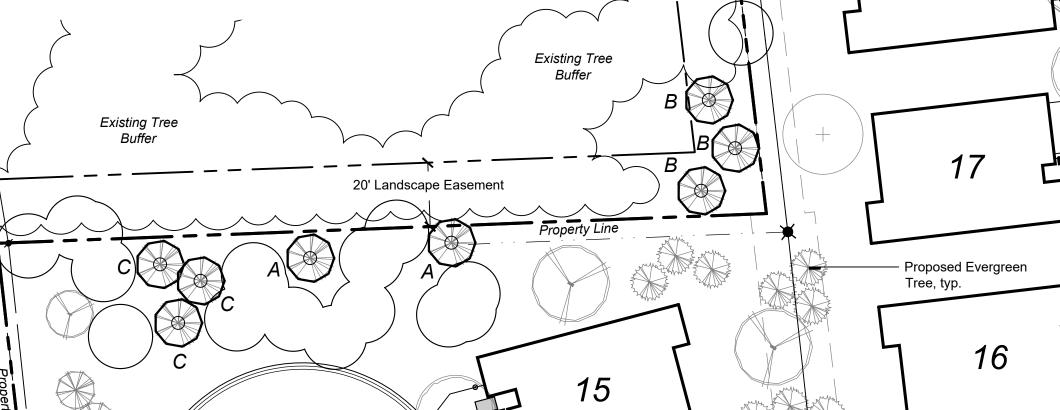

Evergreen Buffer Landscape Plan





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Scale: 1" = 30'

landscape architecture / land planning

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Landscape Buffer Details

■ project title:

Brewster Village

City of Rochester Hills, MI

prepared for:

Robertson Brothers Homes 6905 Telegraph Rd. - Suite 200 Bloomfield Hills, MI 48301

Phone: 248.644.3460

■ job number:

17031 02.25.2019 checked by: ■ drawn by EMJ WTK

■ date:

revisions: