

Frank

Salamone 🐠

architects 🝾

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03/03/20

11/06/19

Date Issued:

Bid Docs. S.P.A.

Project:

Grace

Client:

Grace


Proposed Group Home for:


Properties, L.L.C.


Properties, L.L.C.

1841 Crooks Road Rochester Hills, MI

planners **Ž**

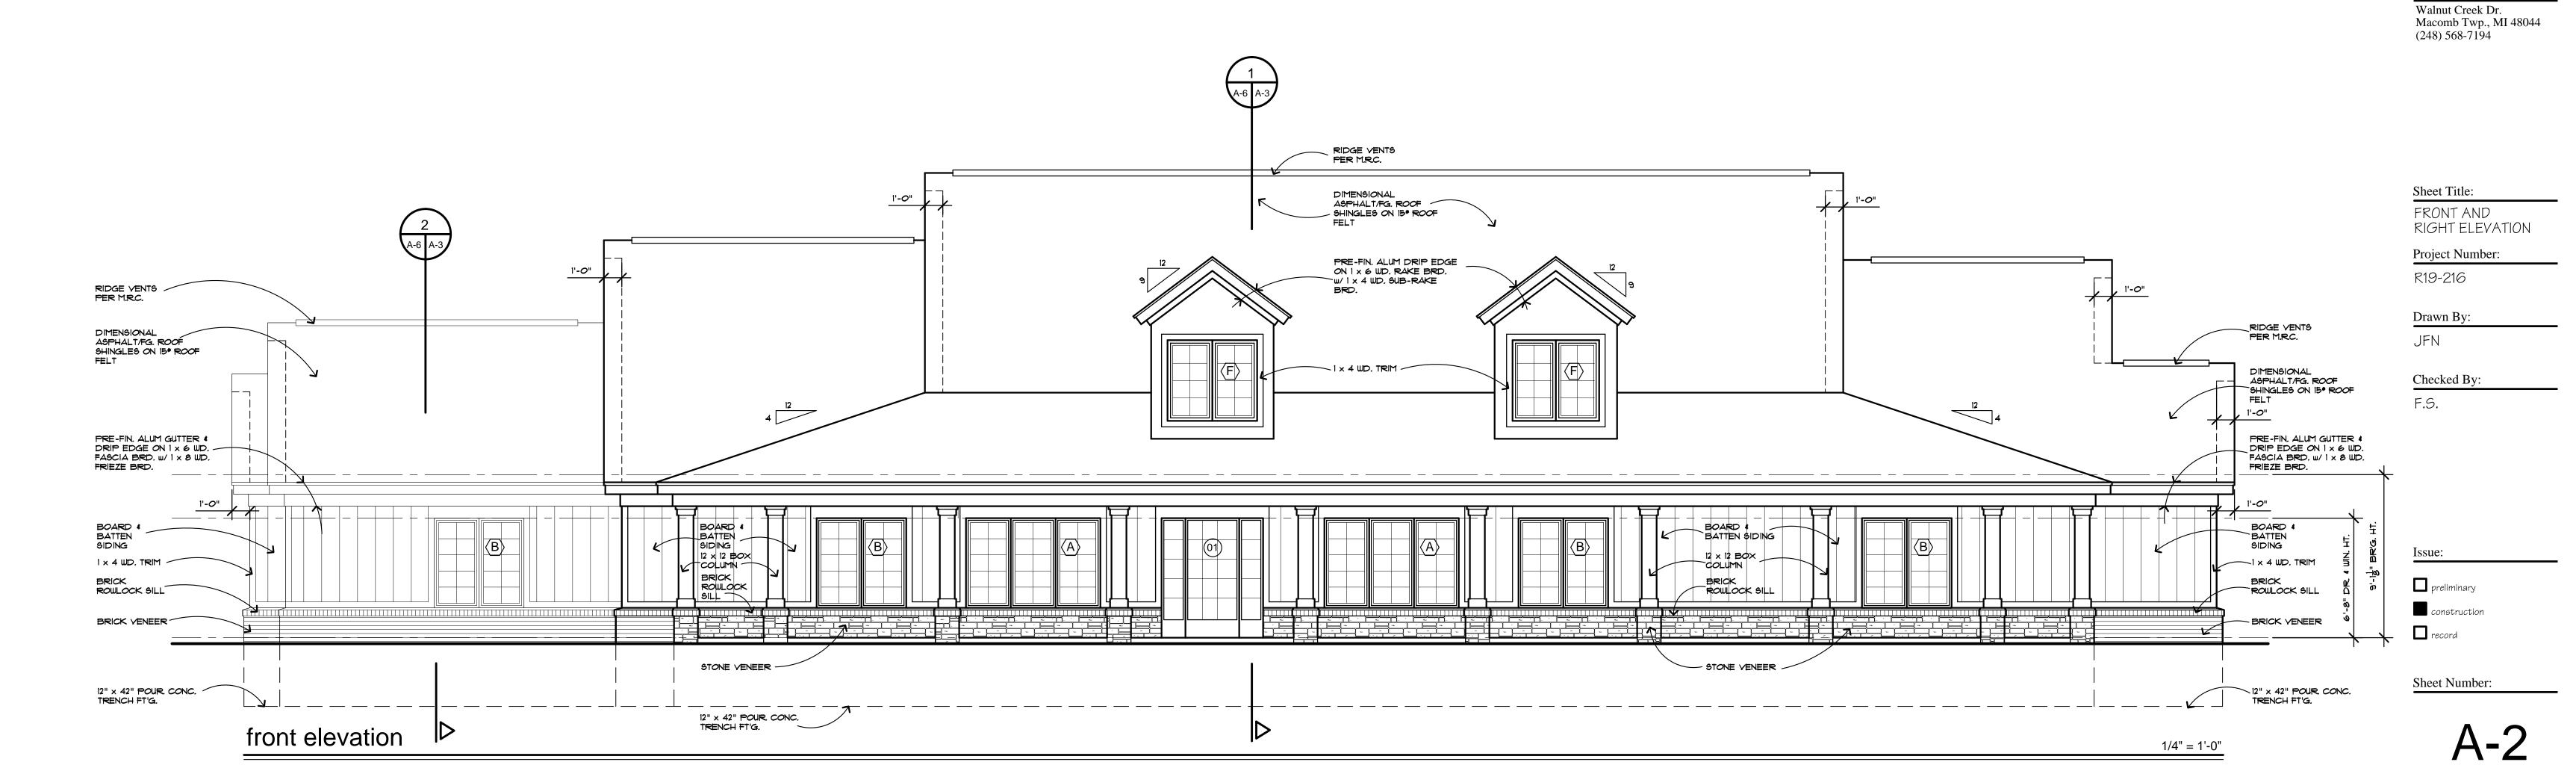

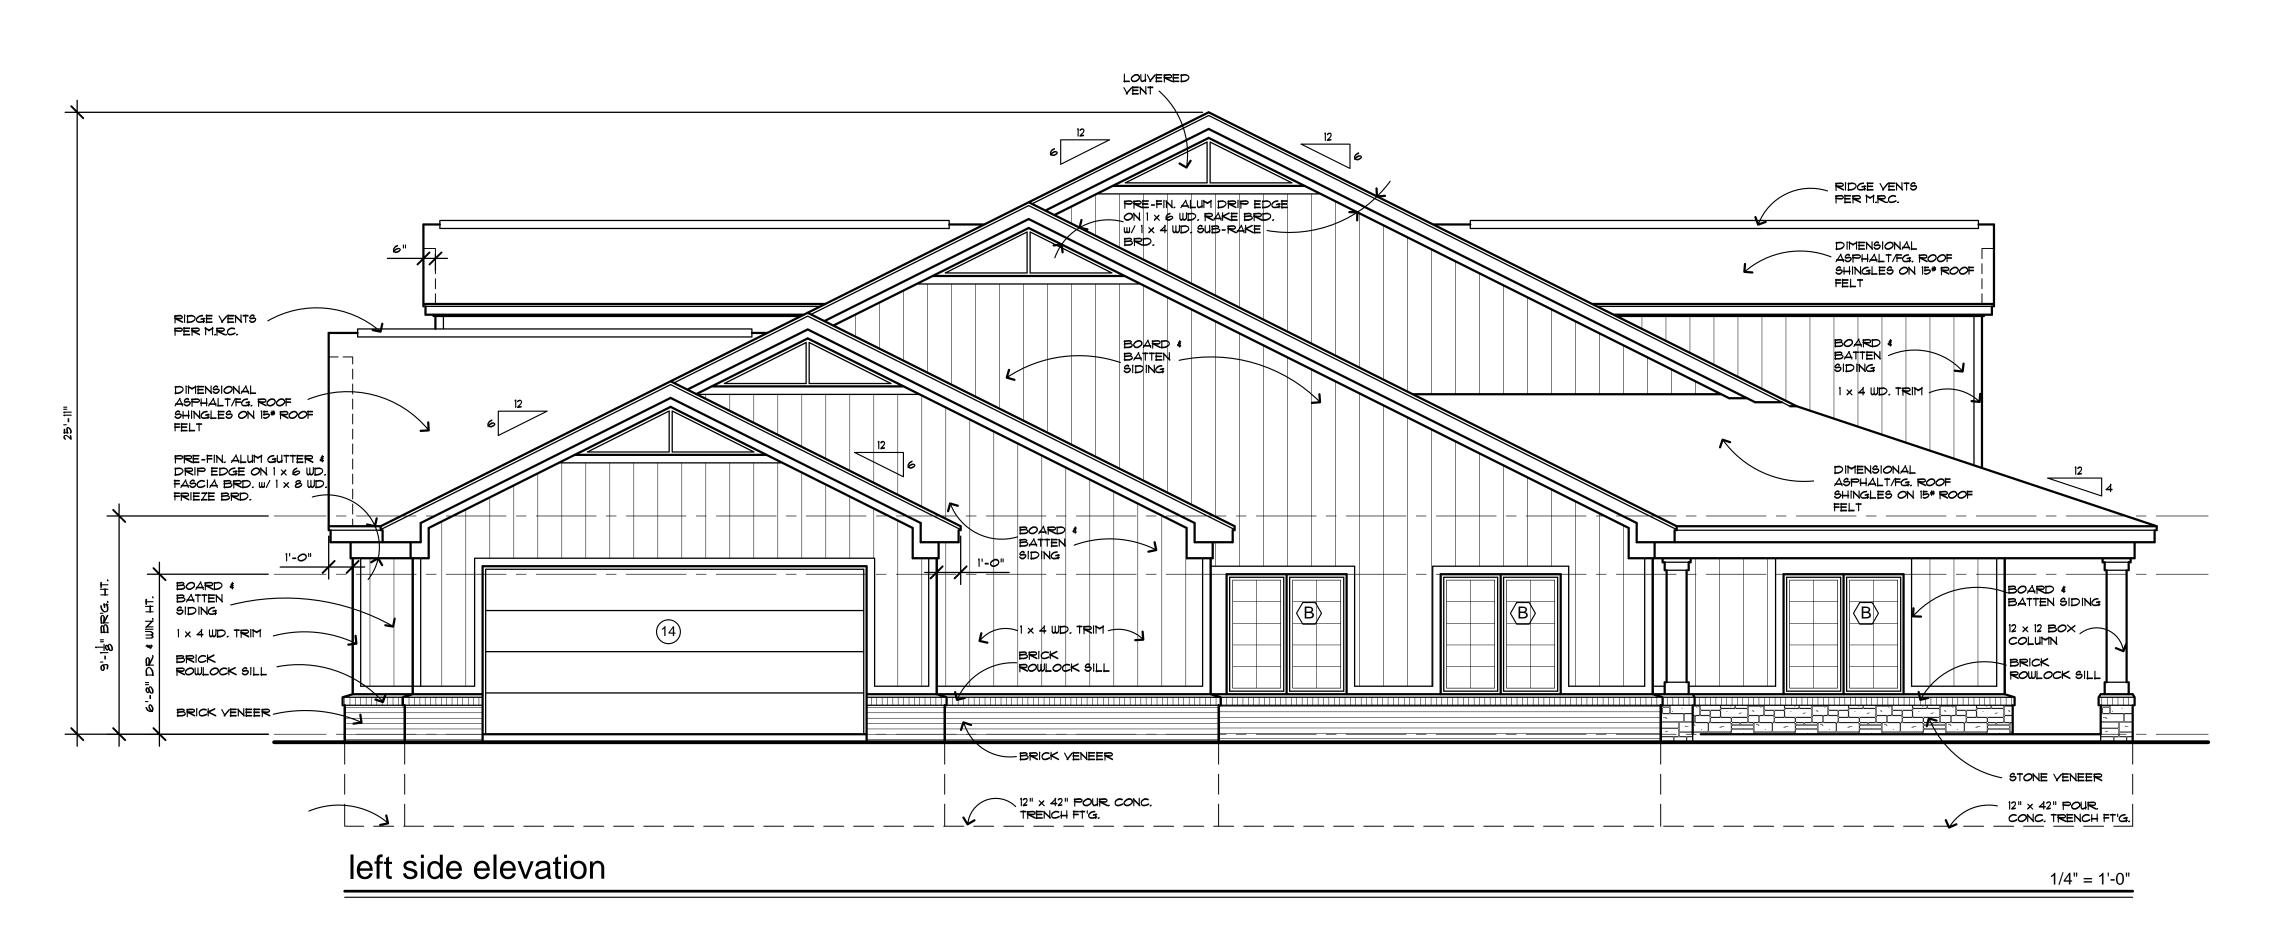

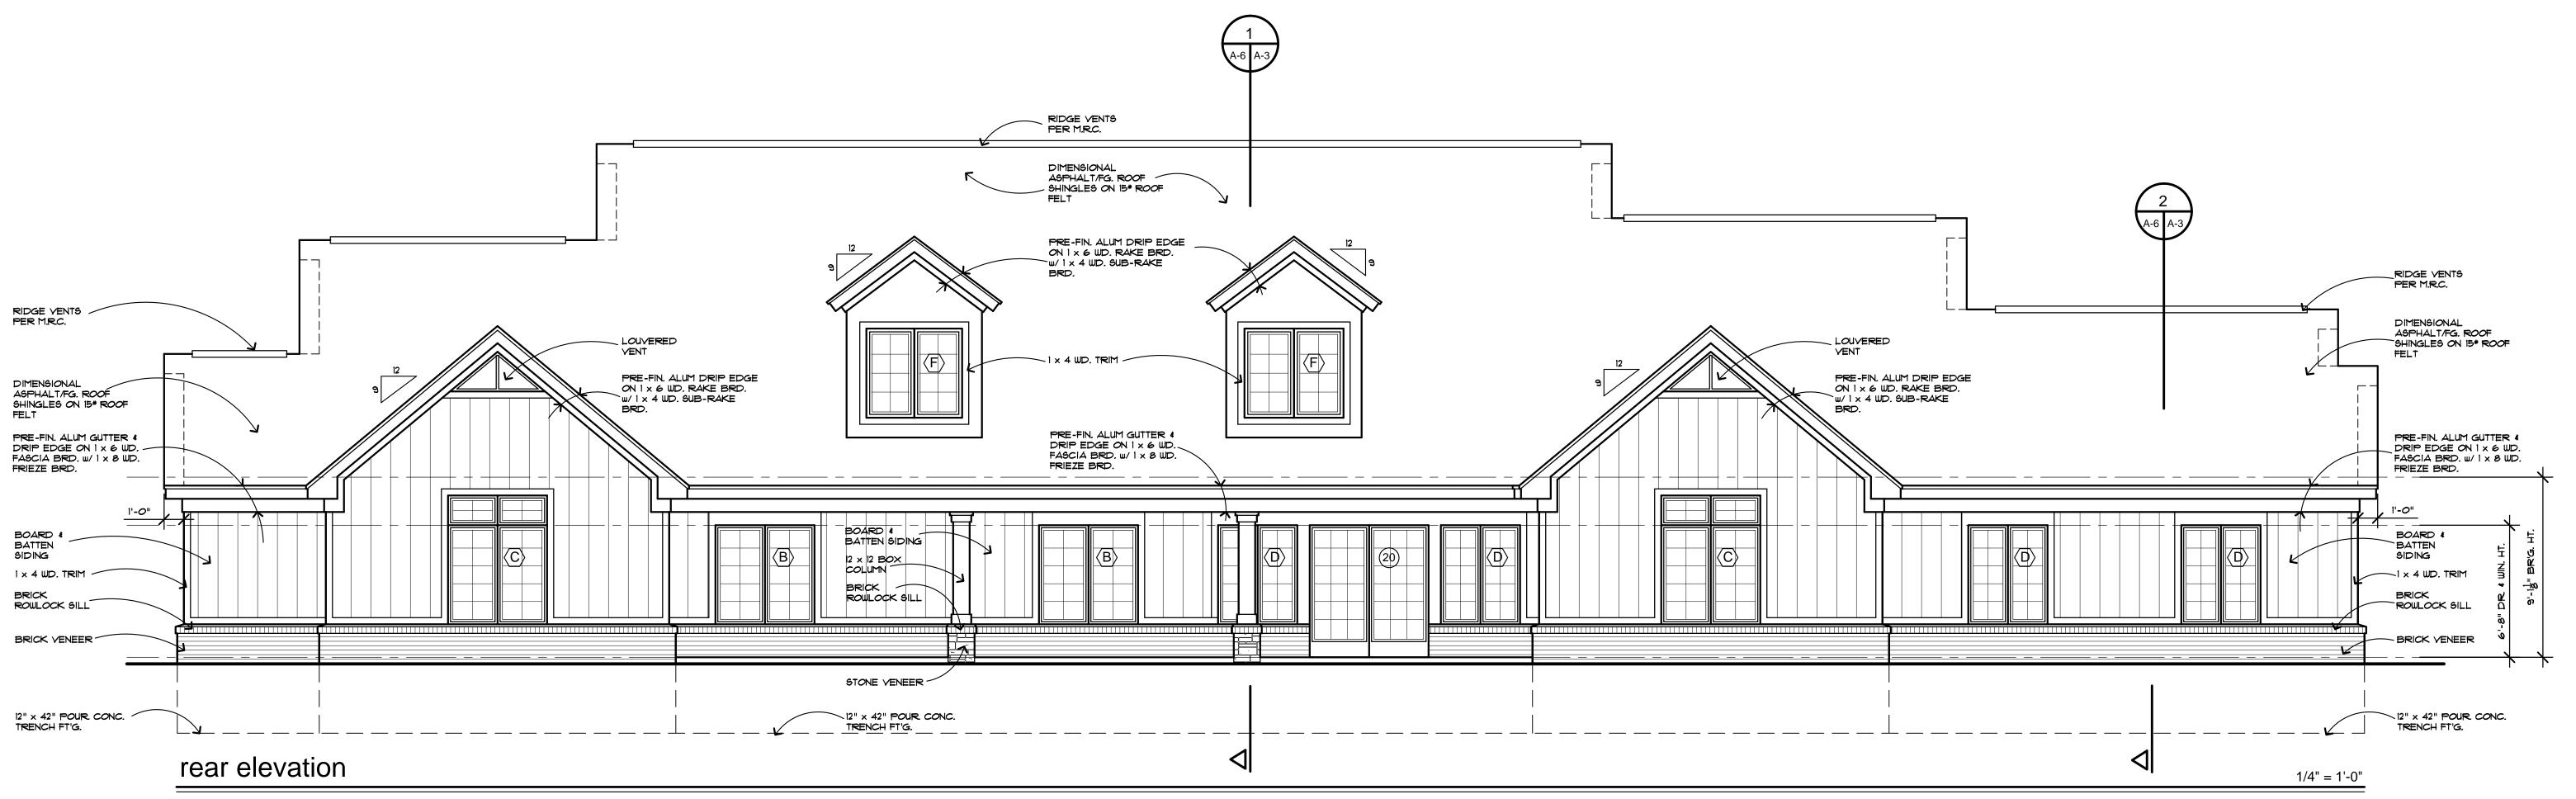

Frank Salamone

> architects engineers planners

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Date Issued:

Bid Docs. 03/03/20 S.P.A. 11/06/19

Project:
Proposed
Group Home for:

Grace Properties, L.L.C. 1841 Crooks Road Rochester Hills, MI

Client:

Grace
Properties, L.L.C.

Walnut Creek Dr.
Macomb Twp., MI 48044
(248) 568-7194

Sheet Title:

REAR AND

LEFT ELEVATION

Project Number: R19-216

Drawn By:

JFN


Checked By: F.S.


Issue:

preliminary

construction

Sheet Number:

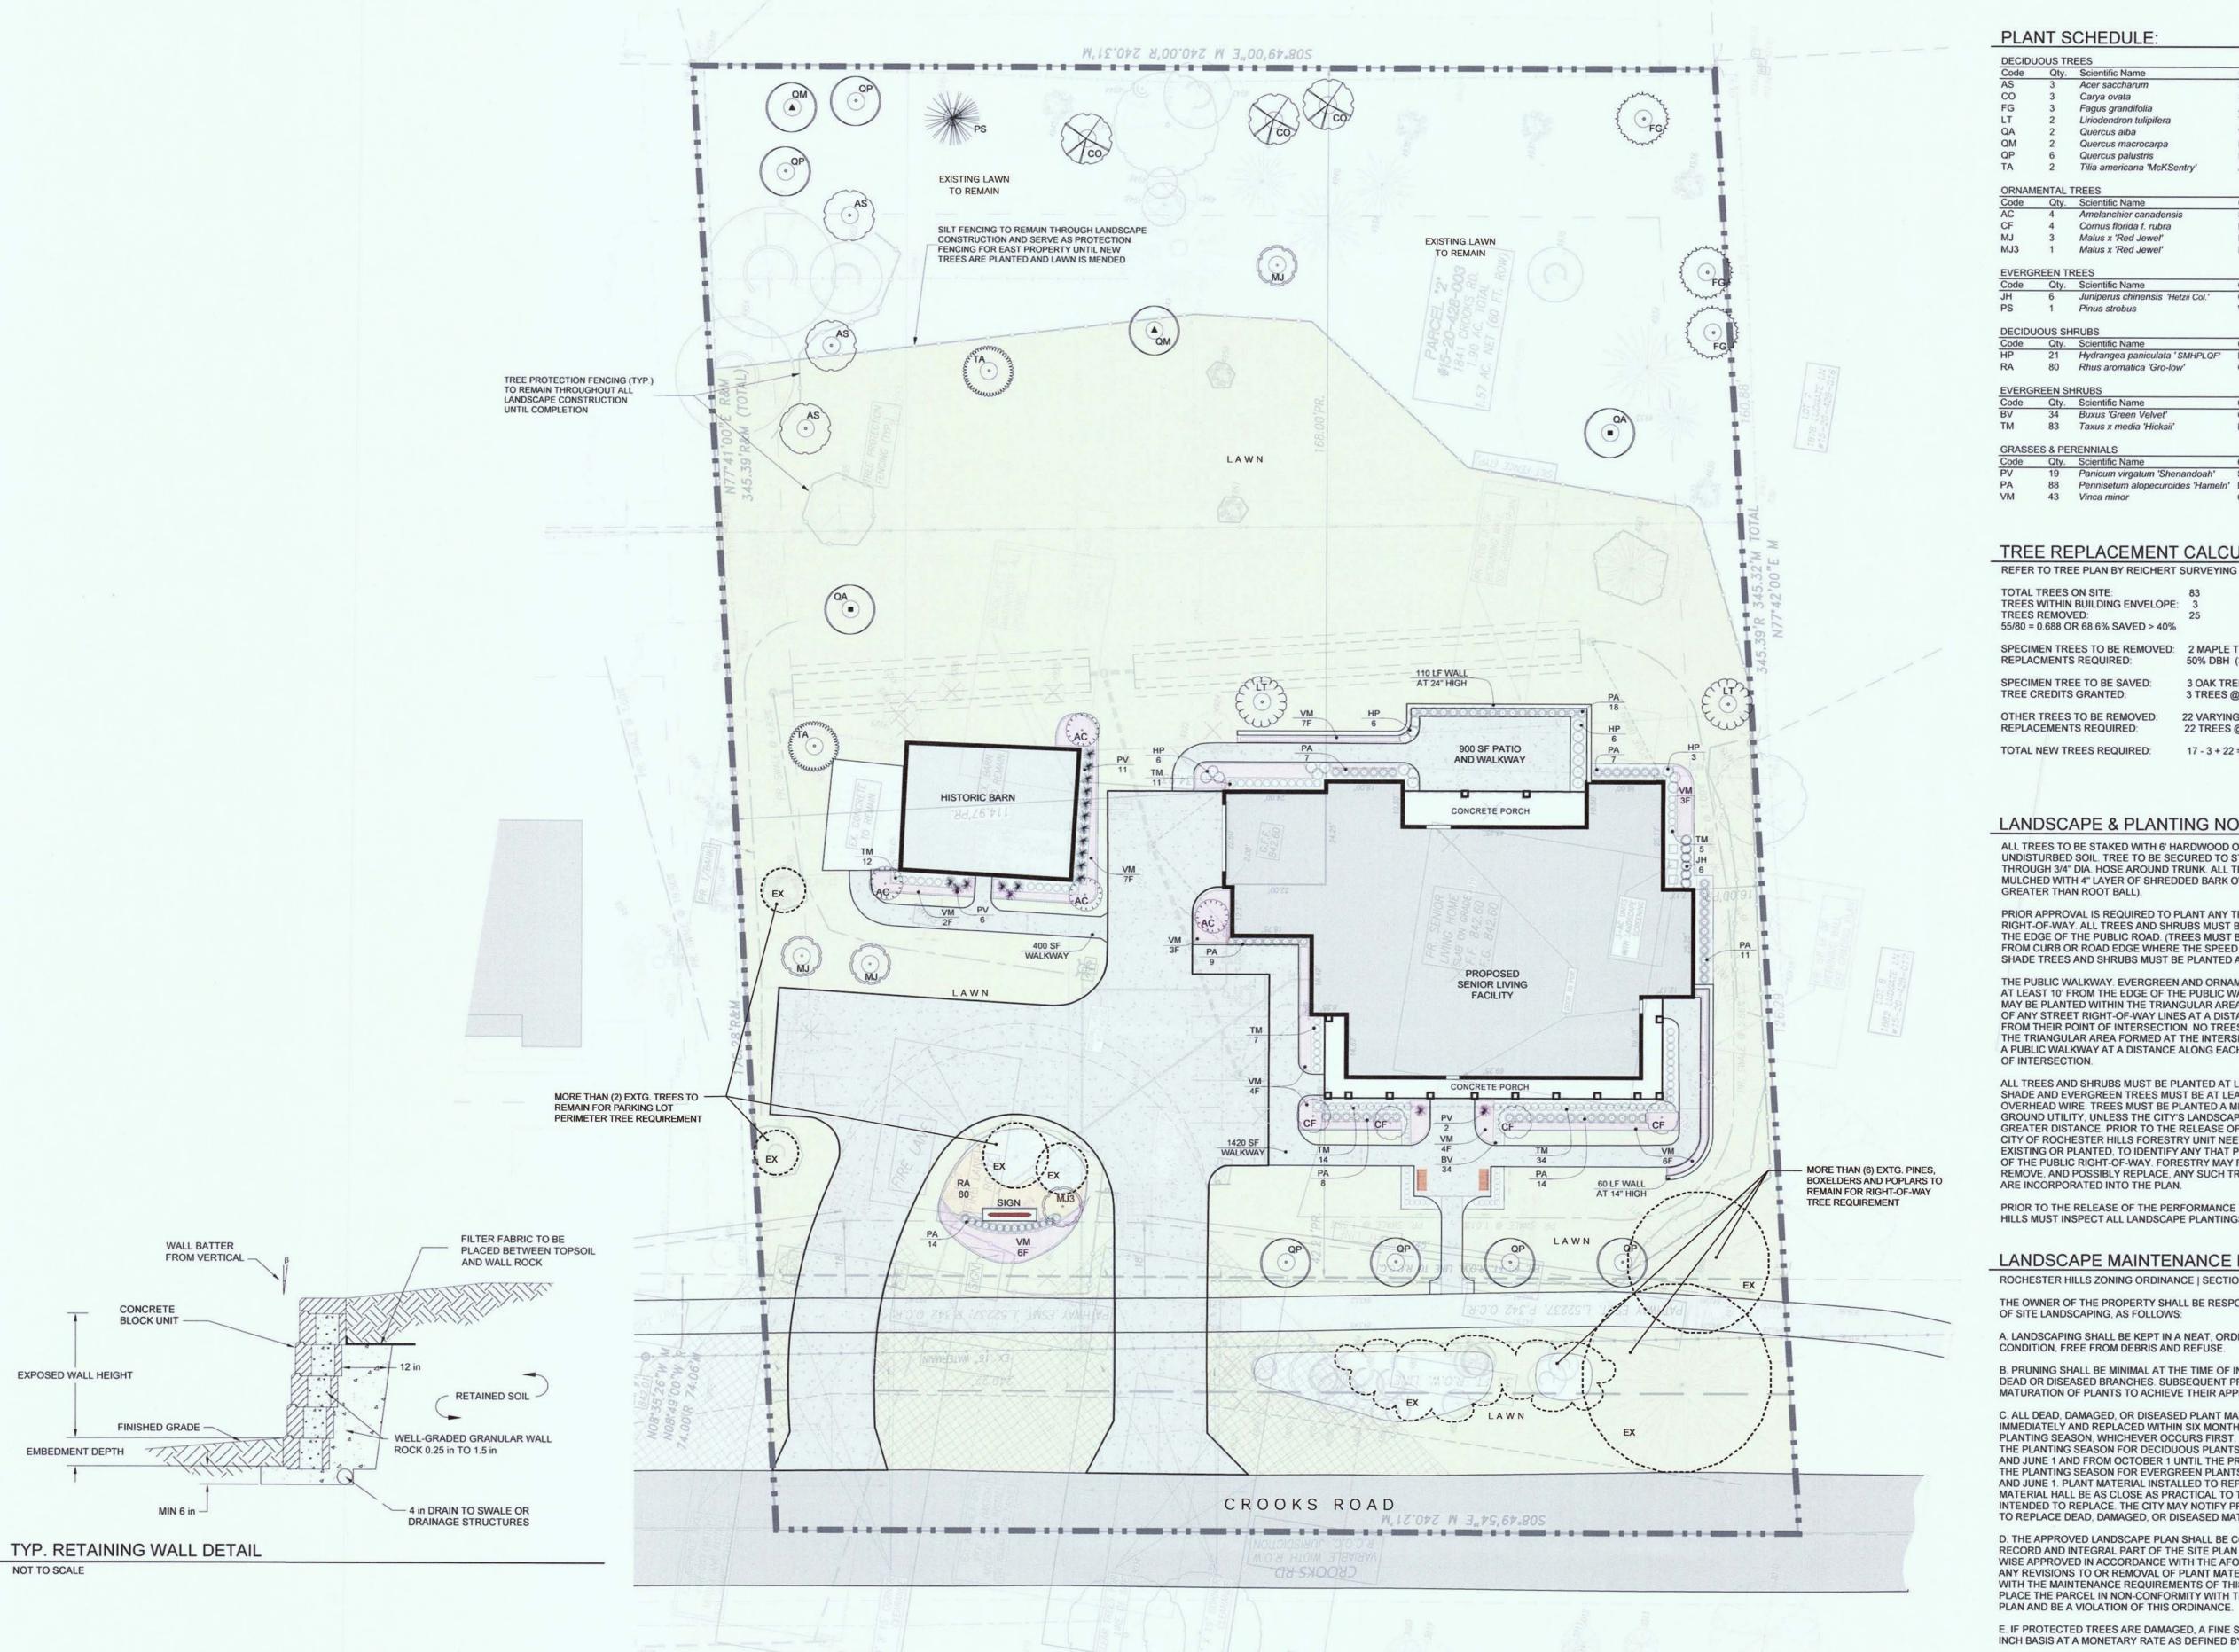

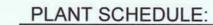

DECIDUOUS TREES			Includes 23 required tree replacemen		
Code	Qty.	Scientific Name	Common Name	Size	
AS	3	Acer saccharum	Sugar Maple	2" cal.	
CO	3	Carya ovata	Shagbark Hickory	2" cal.	
FG	3	Fagus grandifolia	American Beech	2" cal. 2" cal.	
LT	2	Liriodendron tulipifera	Tulip Tree		
QA	2	Quercus alba	White Oak	2" cal.	
QM	2	Quercus macrocarpa	Bur Oak	2" cal.	
QP	6	Quercus palustris	Pin Oak	2" cal.	
TA	2	Tilia americana 'McKSentry'	American Sentry Linden	2" cal.	
ORNAM	ENTAL	TREES	Includes 12 required tree	replaceme	
Code	Qty.	Scientific Name	Common Name	Size	
AC	4	Amelanchier canadensis	Serviceberry	6'	
CF	4	Cornus florida f. rubra	Pink Flowering Dogwood	2" cal.	
MJ	3	Malus x 'Red Jewel'	Red Jewel Crabapple	2" cal.	
MJ3	1	Malus x 'Red Jewel'	Red Jewel Crabapple	3" cal.	
EVERG	REEN TE	REES	Includes 1 required tree	e replacem	
Code	Qty.	Scientific Name	Common Name	Size	
JH	6	Juniperus chinensis 'Hetzii Col.'	Columnar Juniper	4'-5'	
PS	1	Pinus strobus	White Pine 10'		
DECIDU	OUS SH	IRUBS			
Code	Qty.	Scientific Name	Common Name	Size	
HP	21	Hydrangea paniculata 'SMHPLQF'	Little Quickfire Hydrangea	5 gal.	
RA	80	Rhus aromatica 'Gro-low'	Gro-Low Sumac	12"	
EVERG	REEN SI	HRUBS			
Code	Qty.	Scientific Name	Common Name	Size	
BV	34	Buxus 'Green Velvet'	Green Velvet Boxwood	18"	
TM	83	Taxus x media 'Hicksii'	Hicks Yew 24"		
GRASSI	ES & PE	RENNIALS			
Code	Qty.	Scientific Name	Common Name	Size	
PV	19	Panicum virgatum 'Shenandoah'	Shenandoah Switch Grass	2 gal.	
PA	88	Pennisetum alopecuroides 'Hameln'	Dwarf Fountain Grass	2 gal.	
VM	43	Vinca minor	Creeping Myrtle	Flat of 2	

TREE REPLACEMENT CALCULATIONS:

TOTAL TREES ON SITE: TREES WITHIN BUILDING ENVELOPE: TREES REMOVED: 55/80 = 0.688 OR 68.6% SAVED > 40%

SPECIMEN TREES TO BE REMOVED: 2 MAPLE TREES (68" DBH)
REPLACMENTS REQUIRED: 50% DBH (34" DBH) = 17 TR 50% DBH (34" DBH) = 17 TREES @ 2" Cal.

SPECIMEN TREE TO BE SAVED: TREE CREDITS GRANTED:

3 TREES @ 2" Cal. 22 VARYING TREES

22 TREES @ 2" Cal.

OTHER TREES TO BE REMOVED: REPLACEMENTS REQUIRED:

TOTAL NEW TREES REQUIRED: 17 - 3 + 22 = 36 TREES @ 2" Cal.

LANDSCAPE & PLANTING NOTES:

ALL TREES TO BE STAKED WITH 6' HARDWOOD OR METAL POSTS PLACED IN UNDISTURBED SOIL. TREE TO BE SECURED TO STAKES WITH GUY CABLE OR ROPE THROUGH 3/4" DIA. HOSE AROUND TRUNK, ALL TREES TO BE FERTILIZED AND MULCHED WITH 4" LAYER OF SHREDDED BARK OVER TREE PIT (DIAMETER 2 TIMES GREATER THAN ROOT BALL).

PRIOR APPROVAL IS REQUIRED TO PLANT ANY TREE OR SHRUB ON THE PUBLIC RIGHT-OF-WAY, ALL TREES AND SHRUBS MUST BE PLANTED AT LEAST 10' FROM THE EDGE OF THE PUBLIC ROAD. (TREES MUST BE PLANTED AT LEAST 15' AWAY FROM CURB OR ROAD EDGE WHERE THE SPEED LIMIT IS MORE THAN 35 MPH.) SHADE TREES AND SHRUBS MUST BE PLANTED AT LEAST 5' FROM THE EDGE OF

THE PUBLIC WALKWAY. EVERGREEN AND ORNAMENTAL TREES MUST BE PLANTED AT LEAST 10' FROM THE EDGE OF THE PUBLIC WALKWAY, NO TREES OR SHRUBS MAY BE PLANTED WITHIN THE TRIANGULAR AREA FORMED AT THE INTERSECTION OF ANY STREET RIGHT-OF-WAY LINES AT A DISTANCE ALONG EACH LINE OF 25' FROM THEIR POINT OF INTERSECTION. NO TREES OR SHRUBS MAY BE PLANTED IN THE TRIANGULAR AREA FORMED AT THE INTERSECTION OF ANY DRIVEWAY WITH A PUBLIC WALKWAY AT A DISTANCE ALONG EACH LINE OF 15' FROM THEIR POINT OF INTERSECTION.

ALL TREES AND SHRUBS MUST BE PLANTED AT LEAST 10' FROM ANY FIRE HYDRANT. SHADE AND EVERGREEN TREES MUST BE AT LEAST 15' AWAY FROM THE NEAREST OVERHEAD WIRE. TREES MUST BE PLANTED A MINIMUM OF 5' FROM AN UNDER-GROUND UTILITY, UNLESS THE CITY'S LANDSCAPE ARCHITECT REQUIRES A GREATER DISTANCE. PRIOR TO THE RELEASE OF THE PERFORMANCE BOND, THE CITY OF ROCHESTER HILLS FORESTRY UNIT NEEDS TO INSPECT ALL TREES. EXISTING OR PLANTED, TO IDENTIFY ANY THAT POSE A HAZARD TO THE SAFE USE OF THE PUBLIC RIGHT-OF-WAY. FORESTRY MAY REQUIRE THE DEVELOPER TO REMOVE, AND POSSIBLY REPLACE, ANY SUCH TREES. THE ABOVE REQUIREMENTS ARE INCORPORATED INTO THE PLAN.

PRIOR TO THE RELEASE OF THE PERFORMANCE BOND, THE CITY OF ROCHESTER HILLS MUST INSPECT ALL LANDSCAPE PLANTINGS.

LANDSCAPE MAINTENANCE REQUIREMENTS:

ROCHESTER HILLS ZONING ORDINANCE | SECTION 138-12.109

THE OWNER OF THE PROPERTY SHALL BE RESPONSIBLE FOR ALL MAINTENANCE OF SITE LANDSCAPING, AS FOLLOWS:


A. LANDSCAPING SHALL BE KEPT IN A NEAT, ORDERLY AND HEALTHY GROWING CONDITION, FREE FROM DEBRIS AND REFUSE.

B. PRUNING SHALL BE MINIMAL AT THE TIME OF INSTALLATION, ONLY TO REMOVE DEAD OR DISEASED BRANCHES. SUBSEQUENT PRUNING SHALL ASSURE PROPER MATURATION OF PLANTS TO ACHIEVE THEIR APPROVED PURPOSE.

C. ALL DEAD, DAMAGED, OR DISEASED PLANT MATERIAL SHALL BE REMOVED IMMEDIATELY AND REPLACED WITHIN SIX MONTHS AFTER IT DIES OR IN THE NEXT PLANTING SEASON, WHICHEVER OCCURS FIRST. FOR PURPOSES OF THIS SECTION, THE PLANTING SEASON FOR DECIDUOUS PLANTS SHALL BE BETWEEN MARCH 1 AND JUNE 1 AND FROM OCTOBER 1 UNTIL THE PREPARED SOIL BECOMES FROZEN. THE PLANTING SEASON FOR EVERGREEN PLANTS SHALL BE BETWEEN MARCH 1 AND JUNE 1. PLANT MATERIAL INSTALLED TO REPLACE DEAD OR DISEASED MATERIAL HALL BE AS CLOSE AS PRACTICAL TO THE SIZE OF THE MATERIAL IT IS INTENDED TO REPLACE. THE CITY MAY NOTIFY PROPERTY OWNERS OF THE NEED TO REPLACE DEAD, DAMAGED, OR DISEASED MATERIAL.

D. THE APPROVED LANDSCAPE PLAN SHALL BE CONSIDERED A PERMANENT RECORD AND INTEGRAL PART OF THE SITE PLAN APPROVAL. UNLESS OTHER-WISE APPROVED IN ACCORDANCE WITH THE AFOREMENTIONED PROCEDURES ANY REVISIONS TO OR REMOVAL OF PLANT MATERIALS, OR NON-COMPLIANCE WITH THE MAINTENANCE REQUIREMENTS OF THIS SECTION 138-12.109 WILL PLACE THE PARCEL IN NON-CONFORMITY WITH THE APPROVED LANDSCAPE PLAN AND BE A VIOLATION OF THIS ORDINANCE.

E. IF PROTECTED TREES ARE DAMAGED, A FINE SHALL BE ISSUED ON AN INCH-BY-INCH BASIS AT A MONETARY RATE AS DEFINED BY THE FORESTRY DEPARTMENT.

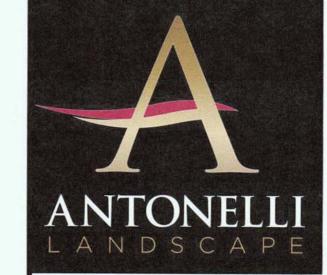

16171 31 MILE ROAD RAY TOWNSHIP, MI 48096

(586) 336-7800

LANDSCAPE **PLAN**

THE BARNS SENIOR LIVING


1841 Crooks Road Rochester Hills, MI 48309

SCALE: 1" = 20'-0"



DRAWN BY MSS: 12.28.2020 REV: 02.02.2021 03.26.2021

mark.antonellilandscape@gmail.com

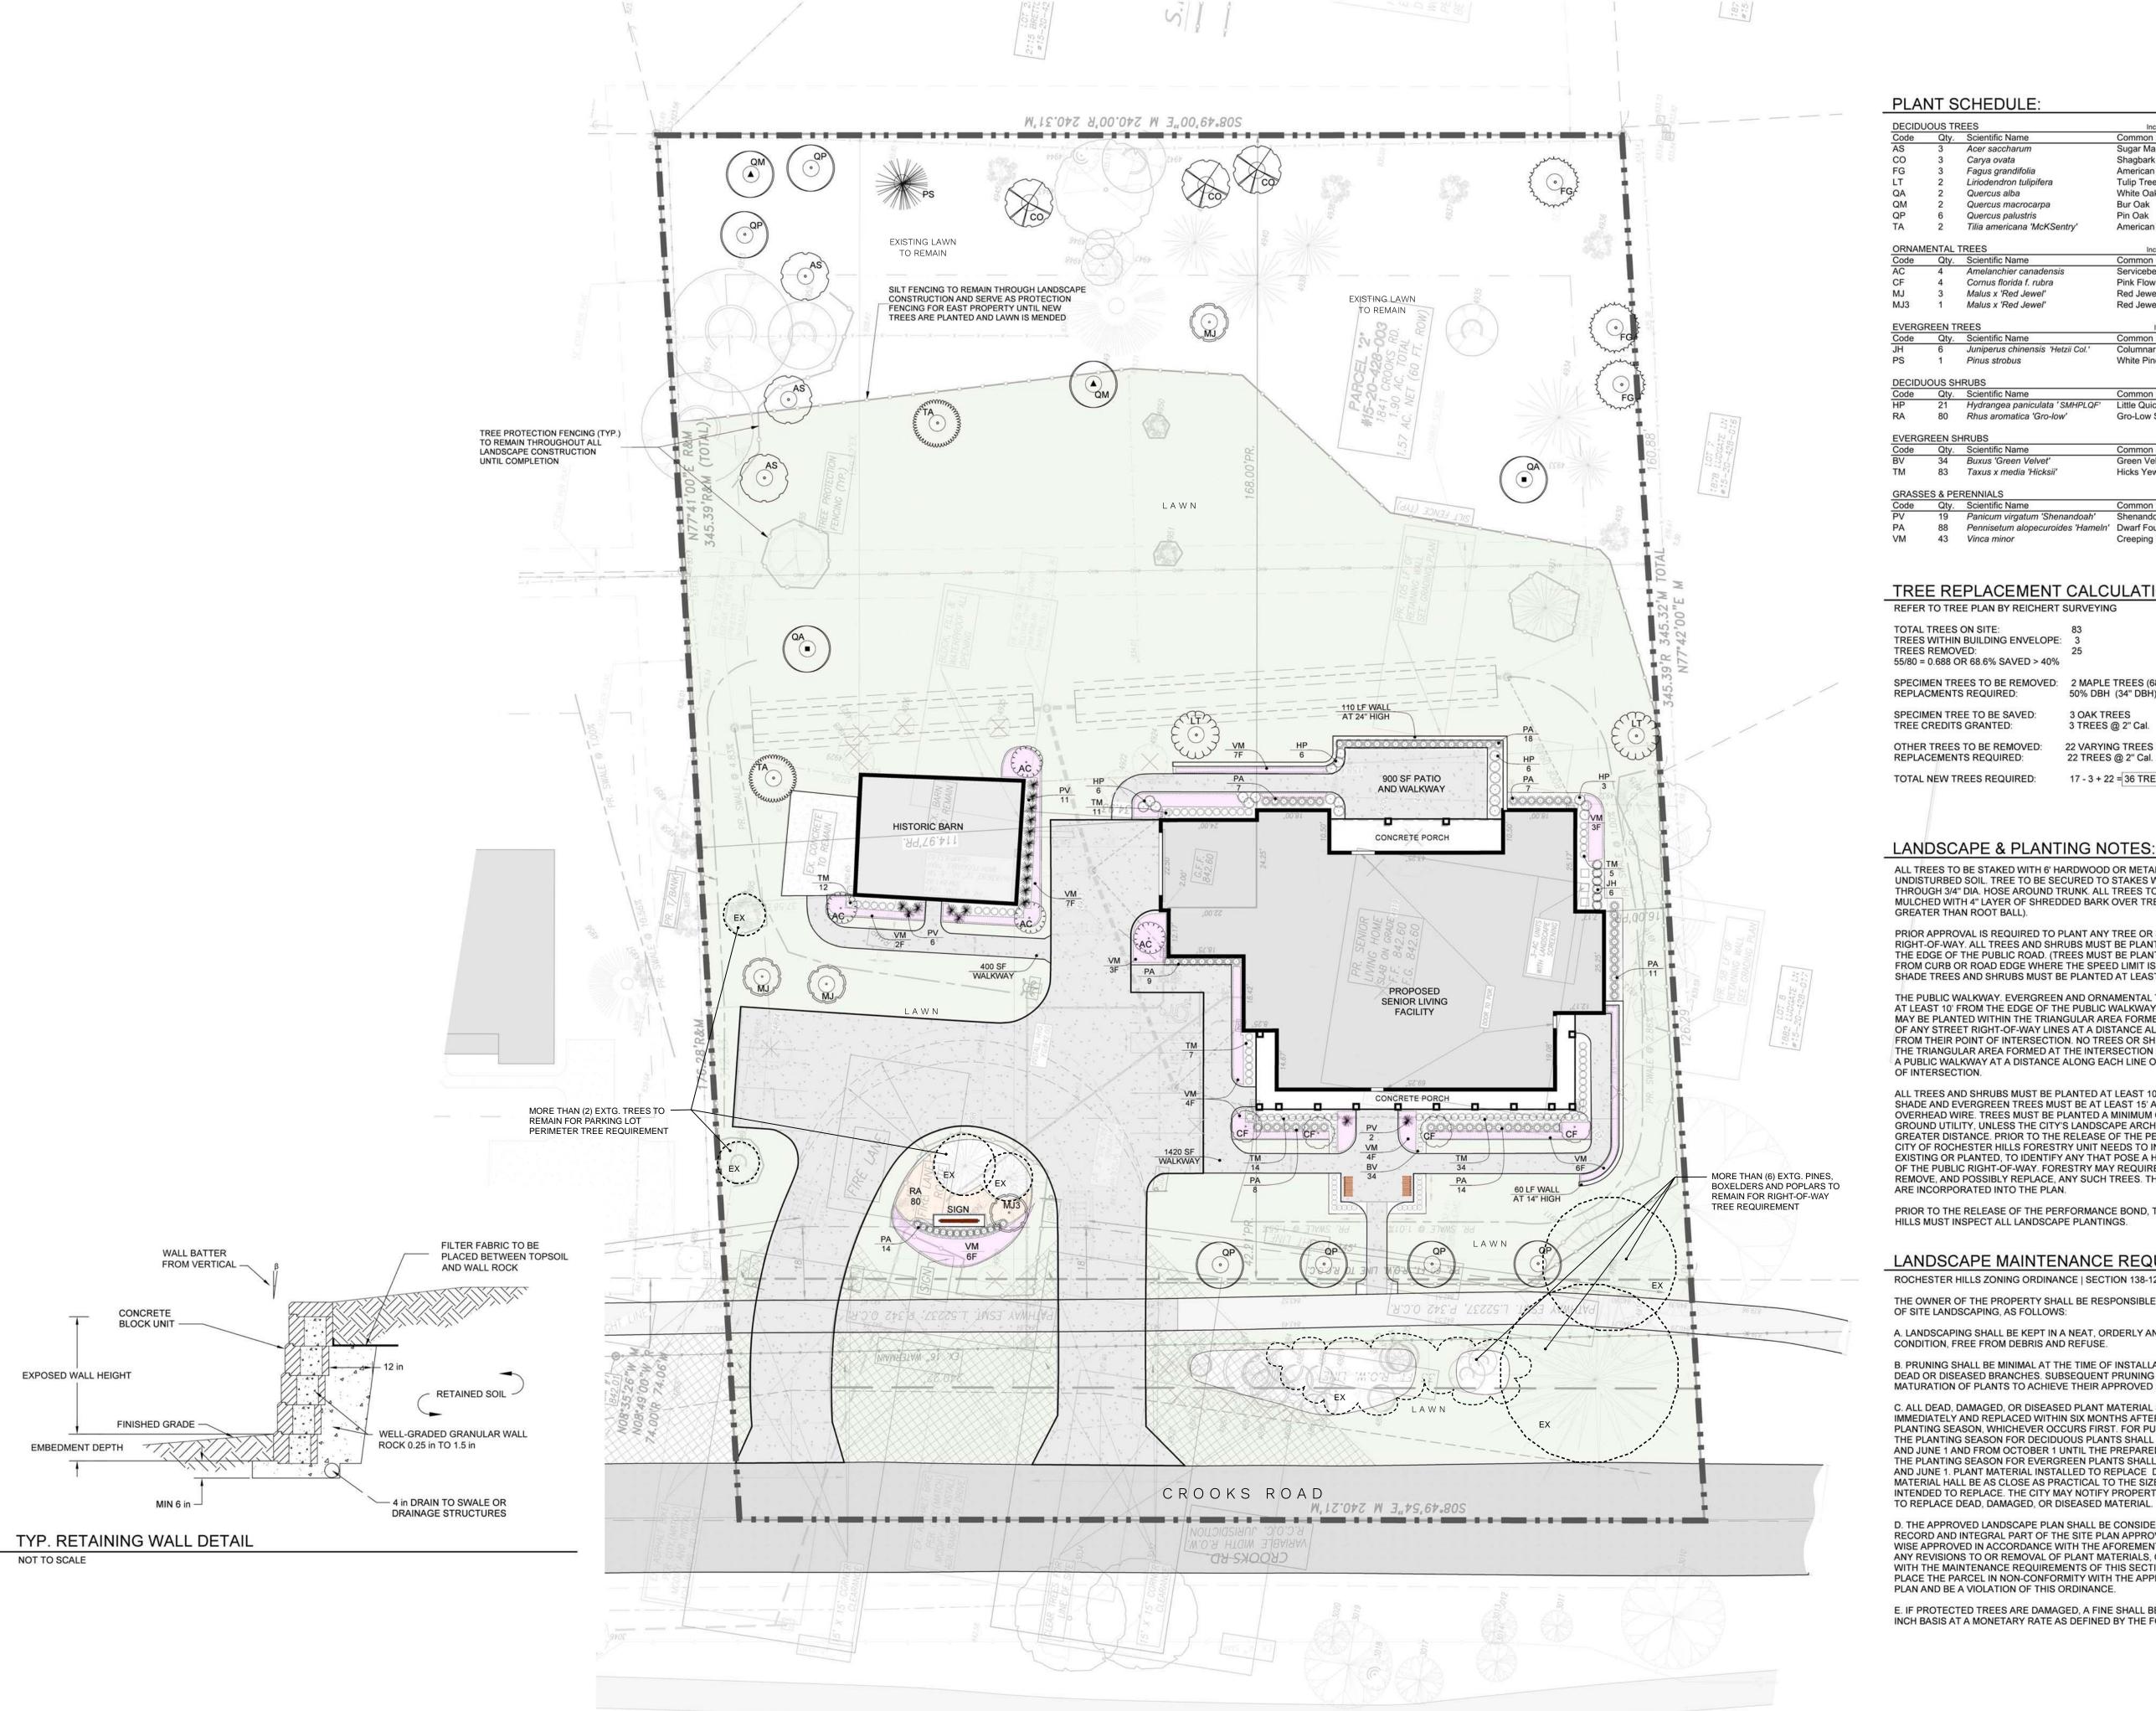



DECIDUOUS TREES		EES	Includes 23 required tree replacement		
Code	Qty.	Scientific Name	Common Name	Size	
AS	3	Acer saccharum	Sugar Maple	2" cal.	
CO	3	Carya ovata	Shagbark Hickory	2" cal.	
FG	3	Fagus grandifolia	American Beech	2" cal.	
LT	2	Liriodendron tulipifera	Tulip Tree	2" cal.	
QA	2	Quercus alba	White Oak	2" cal.	
QM	2	Quercus macrocarpa	Bur Oak	2" cal.	
QP	6	Quercus palustris	Pin Oak	2" cal.	
TA	2	Tilia americana 'McKSentry'	American Sentry Linden	2" cal.	
ORNAM	ENTAL	TREES	Includes 12 required tree	replaceme	
Code	Qty.	Scientific Name	Common Name	Size	
AC	4	Amelanchier canadensis	Serviceberry	6'	
CF	4	Cornus florida f. rubra	Pink Flowering Dogwood	2" cal.	
MJ	3	Malus x 'Red Jewel'	Red Jewel Crabapple	2" cal.	
MJ3	1	Malus x 'Red Jewel'	Red Jewel Crabapple	3" cal.	
EVERG	REEN TH	REES	Includes 1 required tree	e replaceme	
	Qty.	REES Scientific Name	Includes 1 required tree Common Name	Size	
Code					
EVERGI Code JH PS	Qty.	Scientific Name	Common Name	Size	
Code JH PS	Qty. 6 1	Scientific Name Juniperus chinensis 'Hetzii Col.' Pinus strobus	Common Name Columnar Juniper	Size 4'-5'	
Code JH PS DECIDU	Qty. 6 1	Scientific Name Juniperus chinensis 'Hetzii Col.' Pinus strobus	Common Name Columnar Juniper	Size 4'-5'	
Code JH PS DECIDU Code	Qty. 6 1	Scientific Name Juniperus chinensis 'Hetzii Col.' Pinus strobus IRUBS	Common Name Columnar Juniper White Pine	Size 4'-5' 10'	
Code JH	Qty. 6 1 OUS SH	Scientific Name Juniperus chinensis 'Hetzii Col.' Pinus strobus IRUBS Scientific Name	Common Name Columnar Juniper White Pine Common Name	Size 4'-5' 10'	
Code JH PS DECIDU Code HP RA	Qty. 6 1 OUS SH Qty. 21 80	Scientific Name Juniperus chinensis 'Hetzii Col.' Pinus strobus IRUBS Scientific Name Hydrangea paniculata 'SMHPLQF' Rhus aromatica 'Gro-low'	Common Name Columnar Juniper White Pine Common Name Little Quickfire Hydrangea	Size 4'-5' 10' Size 5 gal.	
Code JH PS DECIDU Code HP RA	Qty. 6 1 OUS SH Qty. 21 80	Scientific Name Juniperus chinensis 'Hetzii Col.' Pinus strobus IRUBS Scientific Name Hydrangea paniculata 'SMHPLQF' Rhus aromatica 'Gro-low'	Common Name Columnar Juniper White Pine Common Name Little Quickfire Hydrangea	Size 4'-5' 10' Size 5 gal.	
Code JH PS DECIDU Code HP RA EVERGI	Qty. 6 1 OUS SH Qty. 21 80 REEN SI	Scientific Name Juniperus chinensis 'Hetzii Col.' Pinus strobus IRUBS Scientific Name Hydrangea paniculata 'SMHPLQF' Rhus aromatica 'Gro-low'	Common Name Columnar Juniper White Pine Common Name Little Quickfire Hydrangea Gro-Low Sumac	Size 4'-5' 10' Size 5 gal. 12"	
Code JH PS DECIDU Code HP	Qty. 6 1 OUS SH Qty. 21 80 REEN SI	Scientific Name Juniperus chinensis 'Hetzii Col.' Pinus strobus IRUBS Scientific Name Hydrangea paniculata 'SMHPLQF' Rhus aromatica 'Gro-low' HRUBS Scientific Name	Common Name Columnar Juniper White Pine Common Name Little Quickfire Hydrangea Gro-Low Sumac Common Name	Size 4'-5' 10' Size 5 gal. 12"	
Code JH PS DECIDU Code HP RA EVERGI Code BV TM	Qty. 6 1 1 OUS SH Qty. 21 80 REEN SI Qty. 34 83	Scientific Name Juniperus chinensis 'Hetzii Col.' Pinus strobus IRUBS Scientific Name Hydrangea paniculata 'SMHPLQF' Rhus aromatica 'Gro-low' HRUBS Scientific Name Buxus 'Green Velvet'	Common Name Columnar Juniper White Pine Common Name Little Quickfire Hydrangea Gro-Low Sumac Common Name Green Velvet Boxwood	Size 4'-5' 10' Size 5 gal. 12" Size 18"	
Code JH PS DECIDU Code HP RA EVERGI Code BV TM GRASSI	Qty. 6 1 1 OUS SH Qty. 21 80 REEN SI Qty. 34 83	Scientific Name Juniperus chinensis 'Hetzii Col.' Pinus strobus IRUBS Scientific Name Hydrangea paniculata 'SMHPLQF' Rhus aromatica 'Gro-low' HRUBS Scientific Name Buxus 'Green Velvet' Taxus x media 'Hicksii'	Common Name Columnar Juniper White Pine Common Name Little Quickfire Hydrangea Gro-Low Sumac Common Name Green Velvet Boxwood	Size 4'-5' 10' Size 5 gal. 12" Size 18"	
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Code JH PS DECIDU Code HP RA EVERGI Code BV TM	Qty. 6 1 1 1 1 1 1 1 1 1 1 1 1 1 1 1 1 1 1	Scientific Name Juniperus chinensis 'Hetzii Col.' Pinus strobus IRUBS Scientific Name Hydrangea paniculata 'SMHPLQF' Rhus aromatica 'Gro-low' HRUBS Scientific Name Buxus 'Green Velvet' Taxus x media 'Hicksii'	Common Name Columnar Juniper White Pine Common Name Little Quickfire Hydrangea Gro-Low Sumac Common Name Green Velvet Boxwood Hicks Yew Common Name	Size 4'-5' 10' Size 5 gal. 12" Size 18" 24"	

TREE REPLACEMENT CALCULATIONS: REFER TO TREE PLAN BY REICHERT SURVEYING

TOTAL TREES ON SITE: TREES WITHIN BUILDING ENVELOPE: TREES REMOVED:

SPECIMEN TREES TO BE REMOVED: 2 MAPLE TREES (68" DBH) 50% DBH (34" DBH) = 17 TREES @ 2" Cal.

> 3 OAK TREES 3 TREES @ 2" Cal.

22 VARYING TREES

SPECIMEN TREE TO BE SAVED: TREE CREDITS GRANTED:

REPLACEMENTS REQUIRED:

22 TREES @ 2" Cal. TOTAL NEW TREES REQUIRED: 17 - 3 + 22 = 36 TREES @ 2" Cal.

LANDSCAPE & PLANTING NOTES:

ALL TREES TO BE STAKED WITH 6' HARDWOOD OR METAL POSTS PLACED IN UNDISTURBED SOIL. TREE TO BE SECURED TO STAKES WITH GUY CABLE OR ROPE THROUGH 3/4" DIA. HOSE AROUND TRUNK. ALL TREES TO BE FERTILIZED AND MULCHED WITH 4" LAYER OF SHREDDED BARK OVER TREE PIT (DIAMETER 2 TIMES GREATER THAN ROOT BALL).

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THE PUBLIC WALKWAY. EVERGREEN AND ORNAMENTAL TREES MUST BE PLANTED AT LEAST 10' FROM THE EDGE OF THE PUBLIC WALKWAY. NO TREES OR SHRUBS MAY BE PLANTED WITHIN THE TRIANGULAR AREA FORMED AT THE INTERSECTION OF ANY STREET RIGHT-OF-WAY LINES AT A DISTANCE ALONG EACH LINE OF 25' FROM THEIR POINT OF INTERSECTION. NO TREES OR SHRUBS MAY BE PLANTED IN THE TRIANGULAR AREA FORMED AT THE INTERSECTION OF ANY DRIVEWAY WITH A PUBLIC WALKWAY AT A DISTANCE ALONG EACH LINE OF 15' FROM THEIR POINT

ALL TREES AND SHRUBS MUST BE PLANTED AT LEAST 10' FROM ANY FIRE HYDRANT. SHADE AND EVERGREEN TREES MUST BE AT LEAST 15' AWAY FROM THE NEAREST OVERHEAD WIRE. TREES MUST BE PLANTED A MINIMUM OF 5' FROM AN UNDER-GROUND UTILITY, UNLESS THE CITY'S LANDSCAPE ARCHITECT REQUIRES A GREATER DISTANCE. PRIOR TO THE RELEASE OF THE PERFORMANCE BOND, THE CITY OF ROCHESTER HILLS FORESTRY UNIT NEEDS TO INSPECT ALL TREES. EXISTING OR PLANTED. TO IDENTIFY ANY THAT POSE A HAZARD TO THE SAFE USE OF THE PUBLIC RIGHT-OF-WAY. FORESTRY MAY REQUIRE THE DEVELOPER TO REMOVE, AND POSSIBLY REPLACE, ANY SUCH TREES. THE ABOVE REQUIREMENTS ARE INCORPORATED INTO THE PLAN.

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LANDSCAPE MAINTENANCE REQUIREMENTS:

ROCHESTER HILLS ZONING ORDINANCE | SECTION 138-12.109

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B. PRUNING SHALL BE MINIMAL AT THE TIME OF INSTALLATION, ONLY TO REMOVE DEAD OR DISEASED BRANCHES. SUBSEQUENT PRUNING SHALL ASSURE PROPER MATURATION OF PLANTS TO ACHIEVE THEIR APPROVED PURPOSE.

C. ALL DEAD, DAMAGED, OR DISEASED PLANT MATERIAL SHALL BE REMOVED IMMEDIATELY AND REPLACED WITHIN SIX MONTHS AFTER IT DIES OR IN THE NEXT PLANTING SEASON, WHICHEVER OCCURS FIRST. FOR PURPOSES OF THIS SECTION, THE PLANTING SEASON FOR DECIDUOUS PLANTS SHALL BE BETWEEN MARCH 1 AND JUNE 1 AND FROM OCTOBER 1 UNTIL THE PREPARED SOIL BECOMES FROZEN. THE PLANTING SEASON FOR EVERGREEN PLANTS SHALL BE BETWEEN MARCH 1 AND JUNE 1. PLANT MATERIAL INSTALLED TO REPLACE DEAD OR DISEASED MATERIAL HALL BE AS CLOSE AS PRACTICAL TO THE SIZE OF THE MATERIAL IT IS INTENDED TO REPLACE. THE CITY MAY NOTIFY PROPERTY OWNERS OF THE NEED

D. THE APPROVED LANDSCAPE PLAN SHALL BE CONSIDERED A PERMANENT RECORD AND INTEGRAL PART OF THE SITE PLAN APPROVAL. UNLESS OTHER-WISE APPROVED IN ACCORDANCE WITH THE AFOREMENTIONED PROCEDURES ANY REVISIONS TO OR REMOVAL OF PLANT MATERIALS, OR NON-COMPLIANCE WITH THE MAINTENANCE REQUIREMENTS OF THIS SECTION 138-12.109 WILL PLACE THE PARCEL IN NON-CONFORMITY WITH THE APPROVED LANDSCAPE PLAN AND BE A VIOLATION OF THIS ORDINANCE.

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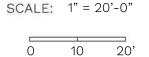
16171 31 MILE ROAD RAY TOWNSHIP, MI 48096

(586) 336-7800

LANDSCAPE PLAN

THE BARNS SENIOR LIVING

1841 Crooks Road Rochester Hills, MI 48309





DRAWN BY MSS: 12.28.2020 REV: 02.02.2021 03.26.2021

mark.antonellilandscape@gmail.com



Symbol	Description	Pressure	Flow	Radius					
Sprinklers									
	Rain Bird 10H - 1804	30 psi	0.79 gpm	10 ft					
	Rain Bird 10H - 1812	30 psi	0.79 gpm	10 ft					
lacktriangle	Rain Bird 10Q	30 psi	0.39 gpm	10 ft					
left	Rain Bird 10-VAN 180 - 1804	30 psi	1.45 gpm	10 ft					
left	Rain Bird 15H - 1804	30 psi	1.85 gpm	15 ft					
lacktriangle	Rain Bird 15Q - 1804	30 psi	0.92 gpm	15 ft					
	Rain Bird 15SST - 1804	30 psi	1.21 gpm	$30 \times 4 \text{ ft}$					
lacktriangle	Rain Bird 5000-MPR-30-H - 5004-PL-PC	45 psi	2.96 gpm	30 ft					
٠	Rain Bird 5000-MPR-30-Q - 5004-PL-PC	45 psi	1.4 gpm	30 ft					
•	Rain Bird 5000-MPR-35-F - 5004-PL-FC	45 psi	7.58 gpm	35 ft					
lacktriangle	Rain Bird 5000-MPR-35-H - 5004-PL-PC	45 psi	3.81 gpm	35 ft					
•	Rain Bird 5000-MPR-35-Q - 5004-PL-PC	45 psi	1.92 gpm	35 ft					
Madaus /Dunana									

Notes per Rochester Hills ordinances:

Watering to occur between 12am and 5am.

Irrigation spray is not prohibited over or on public pathways.



SHEET DESCRIPTION: Irrigation Design

PROJECT: Barns Senior Li

REVISIONS:

2/2/2021

DATE: 12/22/2020

JOB NUMBER:

122220


DRAWN BY:


P.B. CHECKED BY:

1" = 20'

SHEET: 1 of 1



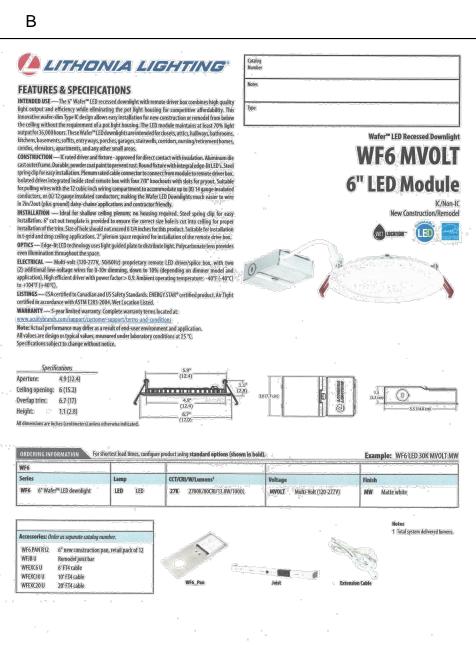

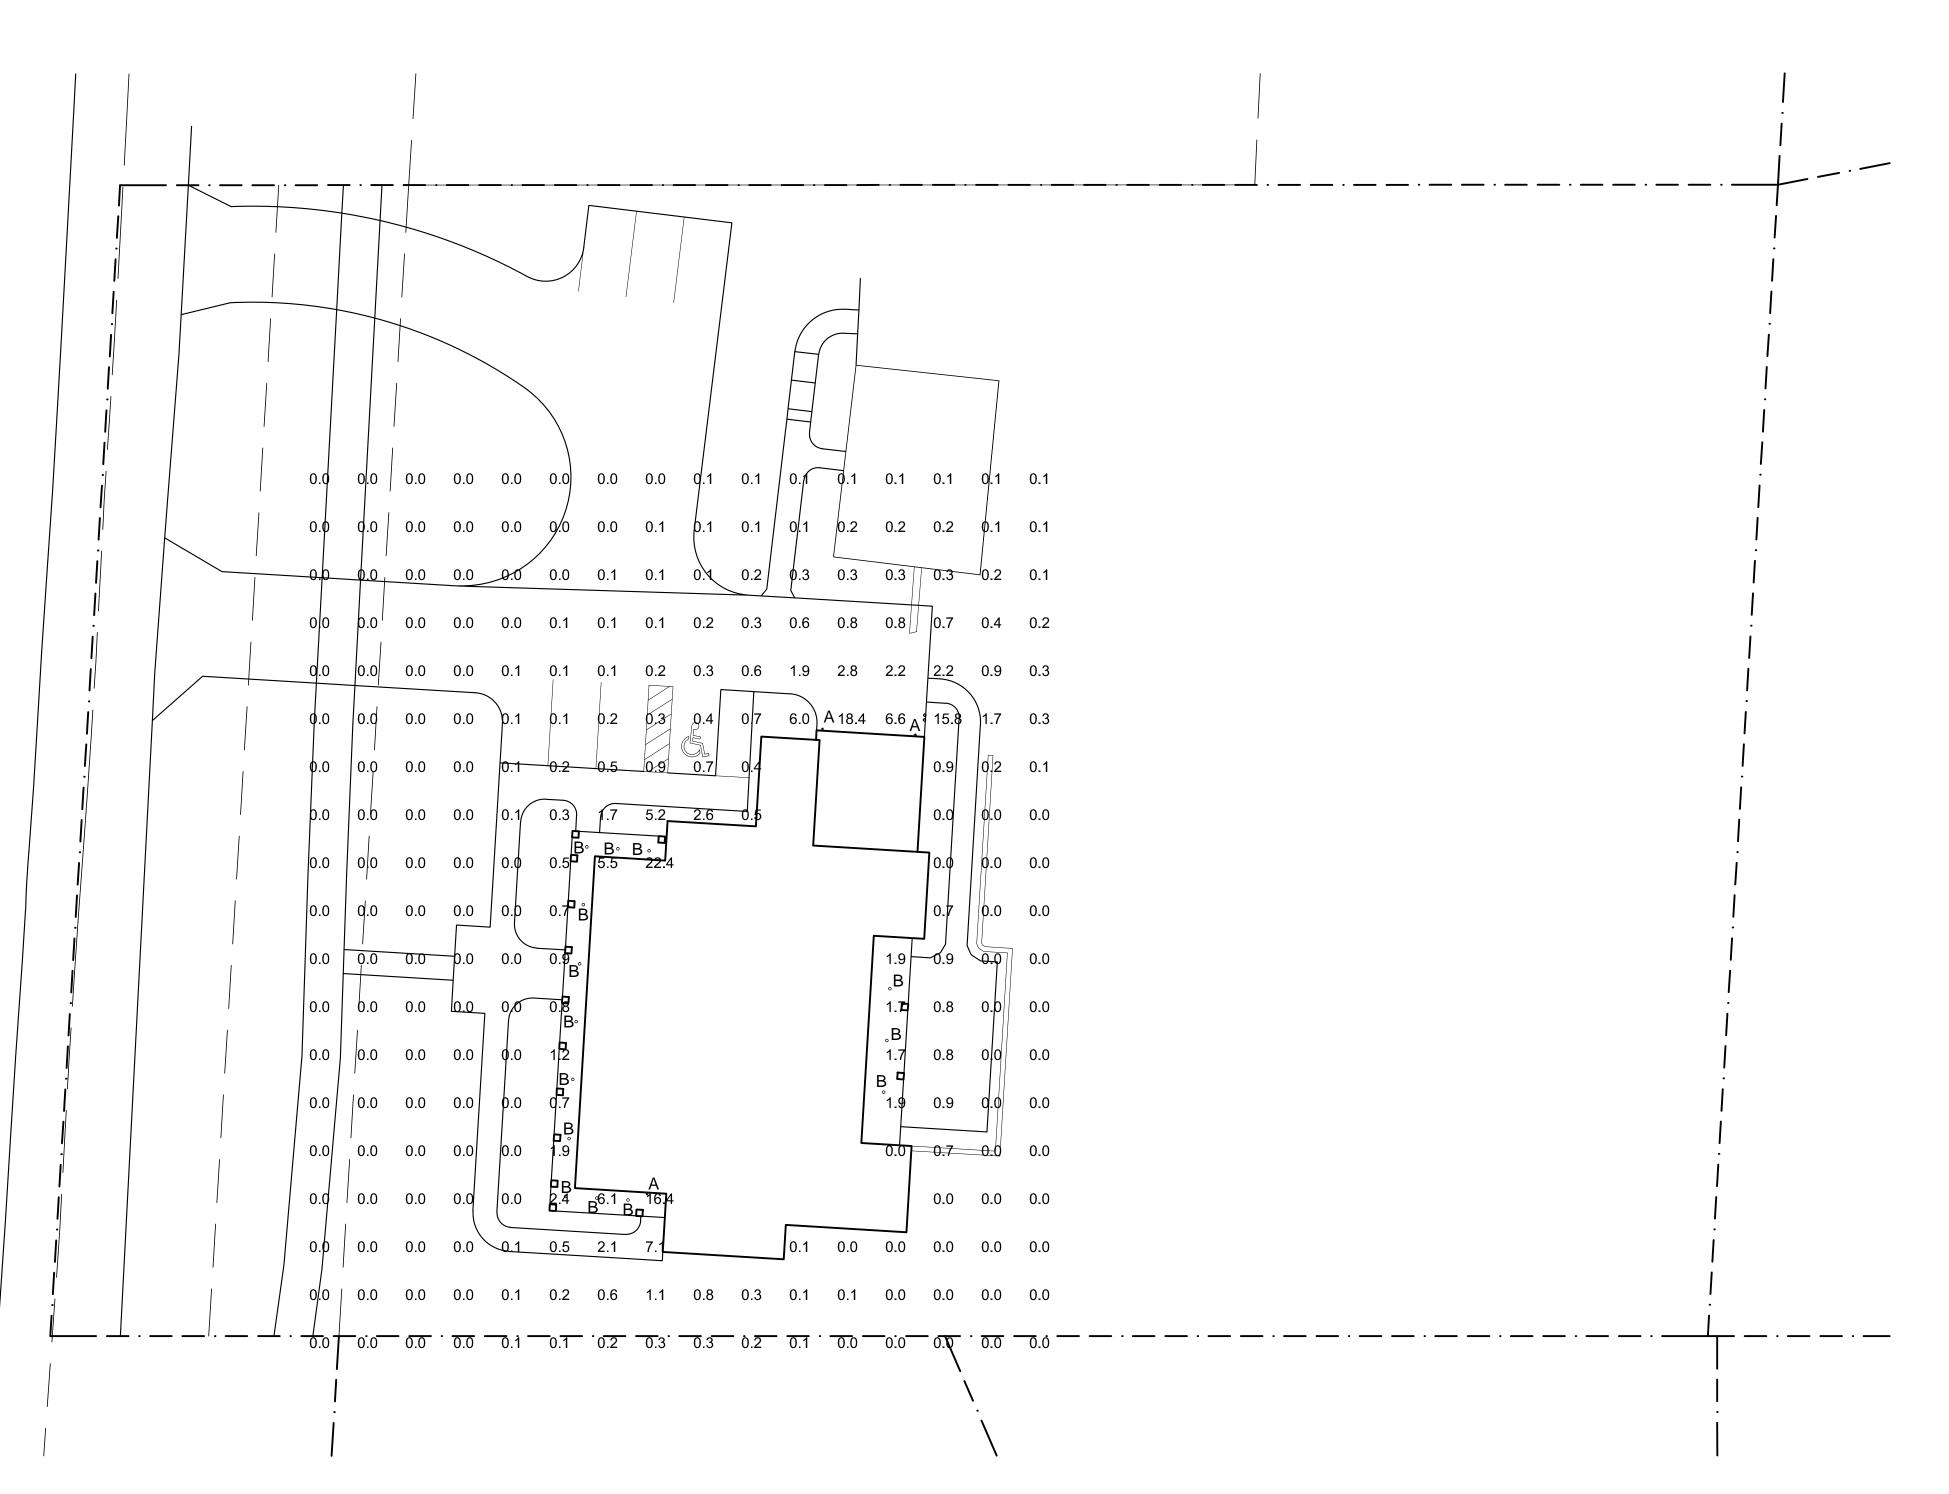



Frank
Salamone

architects
engineers

engineers planners

48701 hayes rd shelby, mi 48315 586.532.0091 fsalamone@fsarchitect.com

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Date Issued:

Revised: 09/29/20
Bid Docs. 03/03/20

11/06/19

Project:

S.P.A.

Proposed
Group Home for:

Grace
Properties, L.L.C.

1841 Crooks Road
Rochester Hills, MI

Client:

Grace Properties, L.L.C.

Walnut Creek Dr. Macomb Twp., MI 48044 (248) 568-7194

Sheet Title:

PHOTOMETRIC PLAN

Project Number: R19-216

Drawn By:

Checked By:

F.S.

Issue:

prelim

constr

Sheet Number:

1" = 20.0"