
DEVELOPER: IAC BARCLAY, LLC C/O THE IVANHOE COMPANIES 6689 ORCHARD LAKE ROAD WEST BLOOMFIELD, MI 48322 GARY SHAPIRO

CIVIL ENGINEER/LAND SURVEYOR: ZEIMET-WOZNIAK & ASSOCIATES, INC 55800 GRAND RIVER SUITE 100 NEW HUDSON, MI 48165 ANDY WOZNIAK

PLANNING CONSULTANT: LSL PLANNING 306 S. WASHINGTON STREET LANDSCAPE ARCHITECT: FELINO A, PASCUAL & ASSOCIATES 4333 ORCHARD LAKE ROAD SUITE 400 ROYAL OAK, MI 48067 SUITE G FARMINGTON HILLS, MI 48336 (248) 586-0505 BRAD STRADER FELINO PASCUAL

ARCHITECT: TR DESIGN GROUP, LLC 6001 NORTH ADAMS ROAD SUITE 202 BLOOMFIELD HILLS, MI 48304 (248) 792-3256

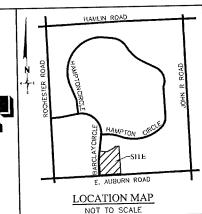

### GENERAL SITE PLAN NOTES:

- ALL EXTERIOR LIGHTING SHALL BE SHIELDED AND DIRECTED AWAY FROM ADJACENT

- ALL EXTERIOR LIGHTING SHALL BE SHIELDED AND DIRECTED AWAY FROM ADJACENT PROPERTIES.

  TRAINSFORMERS SHALL BE LOCATED BEHIND THE BUILDING AS INDICATED ON THE SITE PLAN AND SHALL BE SCREENED USING LANDSCAPING. THE SCREENING SHALL MEET ALL ORDINANCE REQUIREMENTS.

  ASPHALT SURFACING SHALL BE USED FOR ALL PARKING AREAS AND DRIVEWAYS, AND SHALL MEET ALL ORDINANCE REQUIREMENTS.

  ALL BUILDING AND SITE SIGNAGE SHALL BE SUBMITTED FOR REVIEW AT A LATER DATE AND WILL BE IN CONFORMANCE WITH THE CITY OF ROCHESTER HILLS REQUIREMENTS AND A SEPARATE SIGN PERMIT WILL BE OBTAINED FROM THE BUILDING DEPARTMENT.

  BUILDING DEPARTMENT.

  BARRIER FREE RAMPS WILL BE PROVIDED AT ALL SIDEWALK APPROACHES AND SHALL HAVE A MAXIMUM 1:12 SLOPE AND MUST BE CONSTRUCTED PER ADA AND MICHIGAN BARRIER FREE STANDARDS.

  TYPICAL PARKING SPACE SIZE IS 10'X18', WITH A MINIMUM 24' WIDE AISLE PRABLELLE PARKING SPACE SIZE IS 10'X18', WITH A MINIMUM 24' WIDE AISLE PRABLELLE PLAN SHALL BE SUBJECT TO WRITTEN APPROVAL BY THE CITY'S FIRE MARSHALL.

- THE SITE PLAN SHALL BE SUBJECT TO WRITTEN APPROVAL BY THE CITY'S
- THE STIE PLAN SHALL BE SUBJECT TO WATER APPROVED THE STIE AND SHALL BE CONGINEER.
  FIRE LAMES SHALL BE DESIGNATED BY THE FIRE CODE OFFICIAL, AND SHALL BE CONSPICUOUSLY POSTED ON BOTH SIDES OF THE FIRE LANE WITH FIRE LANE SIGNS, SPACED NOT MORE THAN 100' APART ('NO STOPPING, STANDING, PARKING, SPRE-LANE') AND IN CONFORMANCE WITH THE "MICHIGAN MANUAL OF UNIFORM TRAFFIC CONTROL DEWICES". (FIRE PREVENTION ORDINANCE CHAPTER 58, SECTION
- 506)
  ALL PORTIONS OF A BUILDING SHALL BE WITHIN 150' OF AN APPROVED FIRE DEPARTMENT ACCESS ROAD.

  11. FIRE DEPARTMENT ACCESS ROADS SHALL BE A MINIMUM 20' WIDE AND PAVED.

- DEPARTMENT ACCESS ROAD.

  11. FIRE DEPARTMENT ACCESS ROADS SHALL BE A MINIMUM 20' WIDE AND PAVED.

  12. FDC'S SHALL NOT BE OBSCURED OR OBSTRUCTED BY LANDSCAPING, PARKING, OR BY ANY OTHER PERMAININT OR TEMPORARY MATERIALS OR DEVICE. THEY SHALL BE LOCATED ON THE STREET FRONT OF THE BUILDING AND WITHIN 100' OF A FIRE HYDRANT AND WITHIN 50' OF AN APPROVED FIRE ACCESS ROAD. (FIRE PREVENTION ORDINANCE CHAPTER 58, SECTION 912.7 AND SECTION 58-90).

  13. EXIT DOORS SHALL REMAIN FIRE OF OBSTRUCTIONS AT ALL TIMES. PROVIDE GUARD POSTS OR OTHER ACCEPTABLE MEANS OF PROTECTING EXIT DOORS ONTO DRIVES AND PARKING AREAS. (IFC 2006 SECTION 1028.2).

  14. OPEN BURNING IS NOT PERMITTED INCLUDING THE BURNING OF TRASH, DEBRIS, OR LAND CLEARING MATERIALS. OPEN BURNING FOR WARMING OF SAND AND/OR WATER FOR PREPARATION OF MORTAR SHALL BE WITHIN THE CITY OF ROCHESTER HILLS BURN PERMIT GUIDELINES. (FIRE PREVENTION ORDINANCE CHAPTER 58, SECTIONS 307.6.2 AND 307.6.2.3.)


  15. CONSTRUCTION SITE SHALL BE SAFEGUAROED IN ACCORDANCE WITH IFC 2006 CHAPTER 14. THIS INCLUDES MAINTAINING FIRE DEPARTMENT ACCESS ROADS AND FIRE HYDRANTS WILL BE OPERATIONAL PRIOR TO BUILDING CONSTRUCTION. ALL FIRE HYDRANTS WILL BE OPERATIONAL PRIOR TO BUILDING CONSTRUCTION BASED ON THE IFC 2006.
- THE IFC 2006.

  16. FIRE HYDRANT REQUIREMENTS WILL BE BASED ON CONSTRUCTION TYPE AND

- FIRE HYDRANT REQUIREMENTS WILL BE BASED ON CONSTRUCTION TYPE AND SQUARE FOOTAGE OF THE BUILDING.
   DIMENSIONS FOR PARKING SPACES AND MANEUVERING LANES ARE MEASURED FROM THE BACK OF CURB.
   HERE WILL BE NO INDUSTRIAL WASTE OR PROPANE TANKS LOCATED ON-SITE.
   ACCESS TO PROPOSED CONSTRUCTION SITE SHALL BE PROVIDED AND MAINTAINED FROM AUBURN ROAD.
   THE PROPOSED FRIVATE ROADS ARE NOT BEING CONSTRUCTED TO THE CITY'S PUBLIC ROAD STANDARDS, AND THEREFORE, CANNOT BE TRANSFERRED AS PUBLIC ROADS IN THE FUTURE.



SCALE: 1" = 100

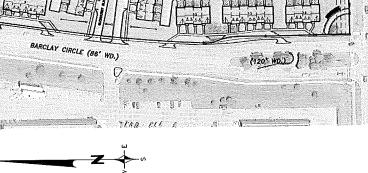

## SHEET INDEX:

### CIVIL PLANS:

COVER SHEET EXISTING CONDITIONS TREE SURVEY

SITE PLAN

OVERALL PAVING PLAN
OVERALL GRADING AND DRAINAGE PLAN
40 SCALE GRADING AND DRAINAGE PLAN CE-6

40 SCALE GRADING AND DRAINAGE PLAN SIDEWALK RAMP DETAILS AUBURN ROAD ENTRANCE DETAILS

CE-11

BARCLAY CIRCLE ENTRANCE DETAILS ROAD PROFILES SOIL EROSION CONTROL PLAN

STORMWATER MANAGEMENT PLAN OVERALL UTILITY PLAN

40 SCALE STORM SEWER PLAN 40 SCALE STORM SEWER PLAN

40 SCALE SANITARY SEWER PLAN 40 SCALE SANITARY SEWER PLAN

40 SCALE WATERMAIN PLAN

40 SCALE WATERMAIN PLAN

# STANDARD DETAILS:

CITY STORM SYSTEM STANDARD DETAILS 1/1
OEWRC STORM DRAIN NOTES AND DETAILS 1/1
CITY SANITARY SEWER STANDARD DETAILS 1/2
CITY SANITARY SEWER STANDARD DETAILS 2/2 WATERMAIN STANDARD DETAILS WATERMAIN STANDARD DETAILS OCWRC SOIL EROSION AND SEDIMENTATION CONTROL DETAILS

### LANDSCAPE PLANS:

OVERALL. PLANTING DETAILS

PLANTING DETAILS LS-3 LS-4

PLANTING DETAILS
BUILDING FOUNDATION PLANTINGS
PLANT MATERIAL LIST AND DETAILS LS-5

SITE AMENITIES

ENTRY DETAILS LS-8

# ARCHITECTURAL PLANS:

4 PLEX SCHEMATIC FRONT ELEVATION 5 PLEX SCHEMATIC FRONT ELEVATION 6 PLEX SCHEMATIC FRONT ELEVATION

SCHEMATIC REAR ELEVATION

SCHEMATIC SIDE ELEVATION

SCHEMATIC FLOOR PLANS

CITY FILE 14-012, SECTION 2 NOT FOR CONSTRUCTION


Civil Engineers & Land Surveyors 35800 GRAND RIVER AVE. SEATE DO NEW HUDSON, MICHIGAN 48165 219-127 SERVE P (2819415-522) AVEA, AMERICA OF A

MISS DIG SYSTEM, INCOME YOU THE

CLIENT: IAC BARCLAY, L.L.C. C/O THE IVANHOE COMPANIES 6689 ORCHARD LAKE ROAD, STE. 314 WEST BLOOMFIELD, MI 48322 (248) 626-6114

COVER SHEET BARRINGTON PARK ROCHESTER HILLS, MICHIGAN

DATE | SCALE | HOR: 1" = 100" 12/15/14 | SCALE | VER: 1" = N/A DESIGNED BY JOB NO. 13178 SRB SHEET CE-1

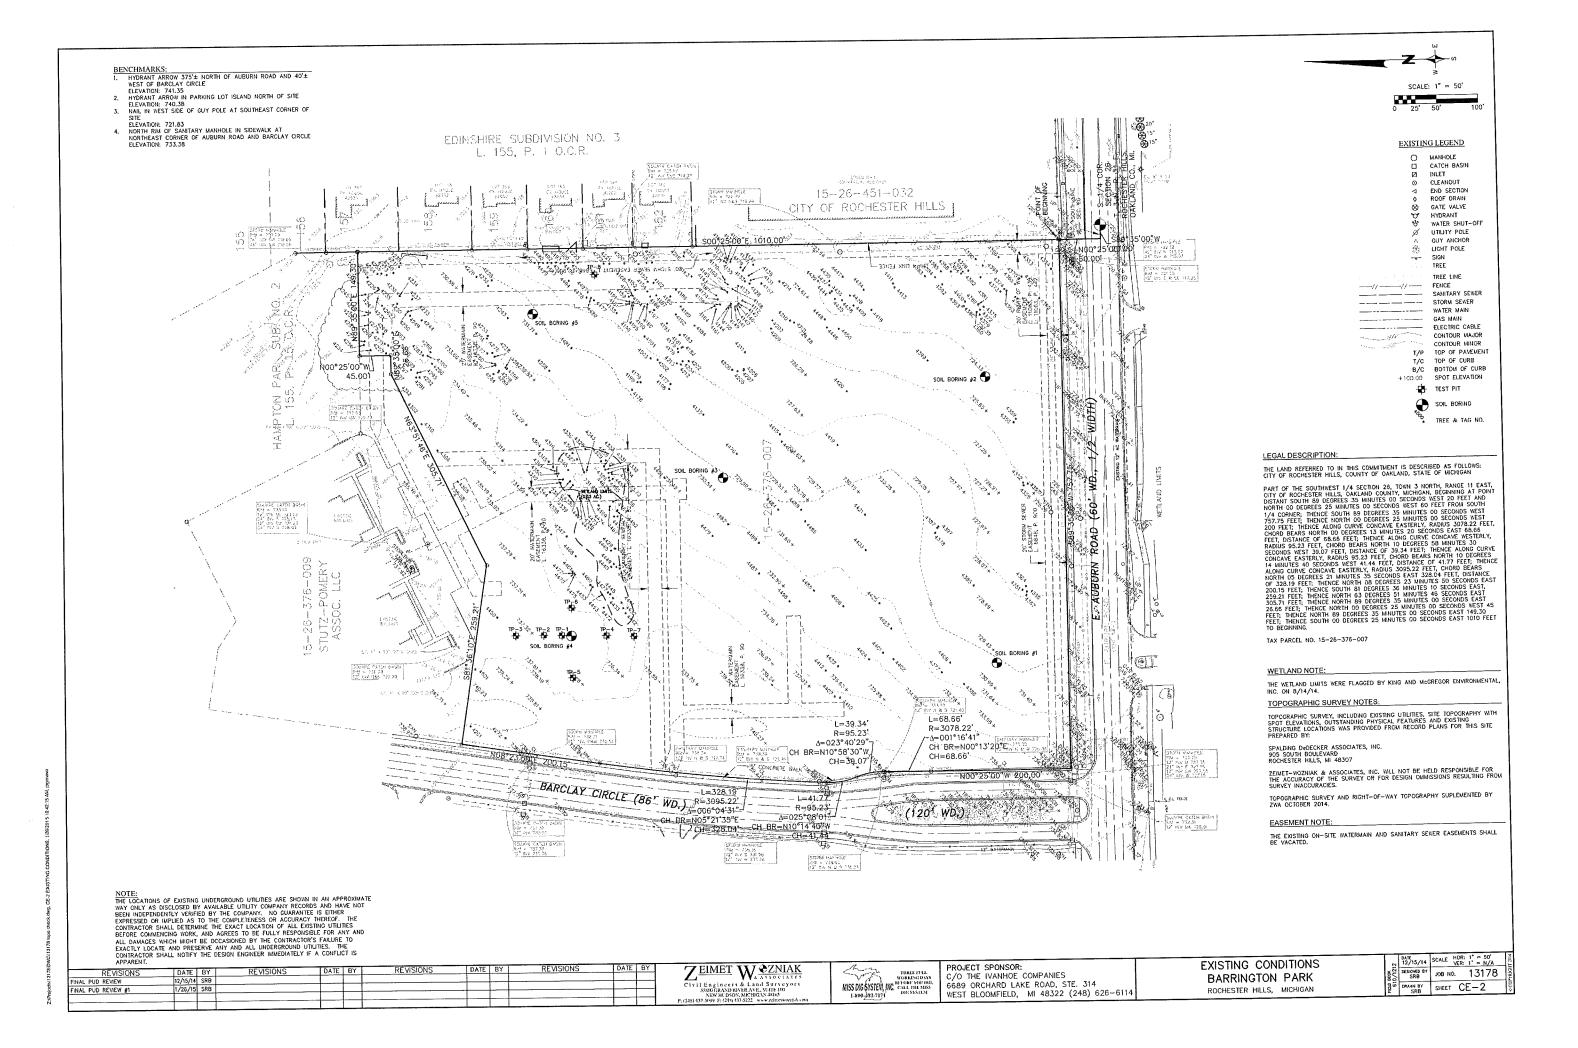




PRANT BY SHEET CE-3

ROCHESTER HILLS, MICHIGAN

WEST BLOOMFIELD, MI 48322 (248) 626-6114

1-800-182-7171

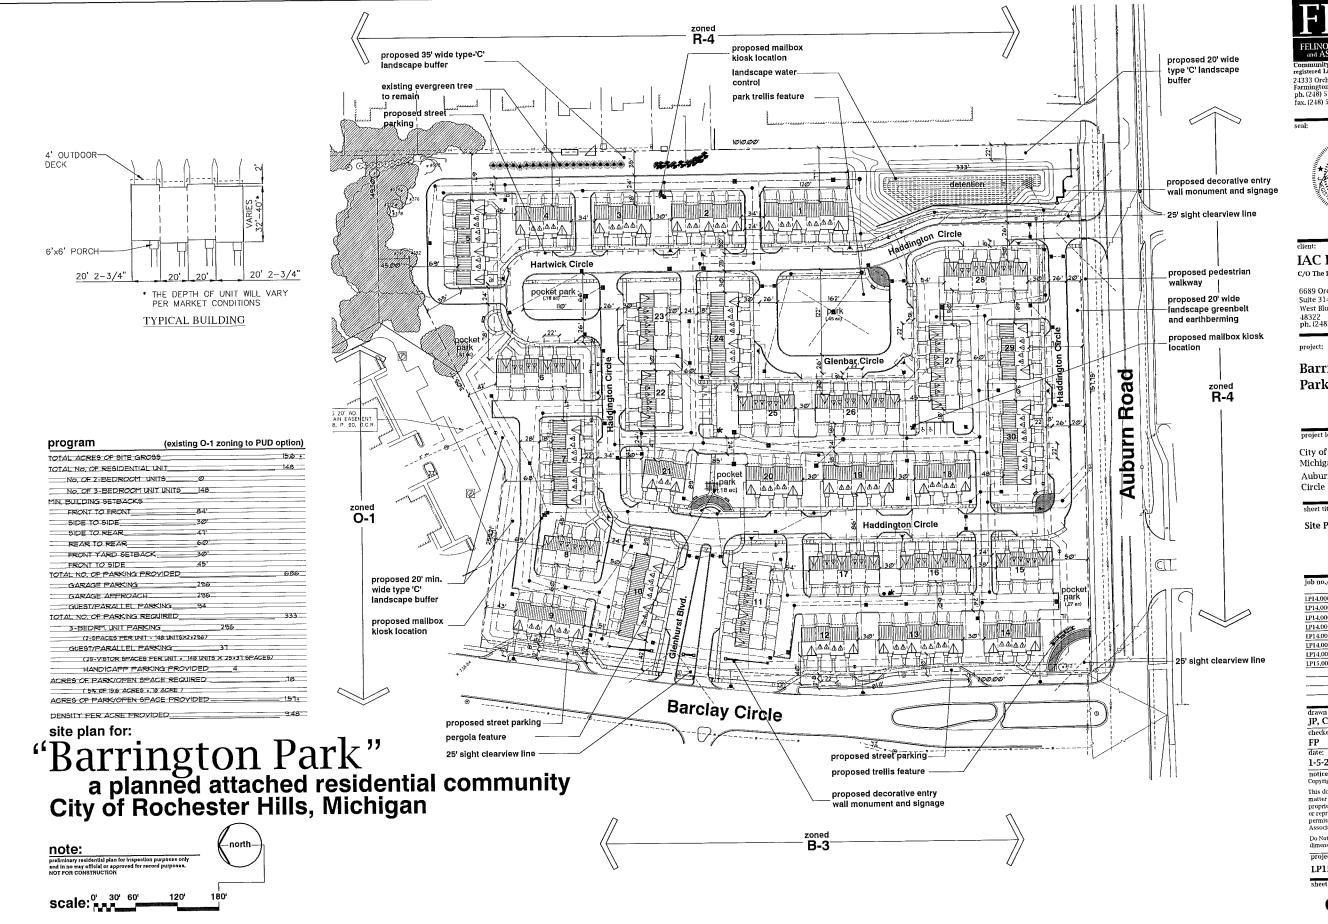



24333 Orchard Lake Rd, Suite G Farmington Hills, MI 48336 ph. (248) 557-5588 fax. (248) 557-5416



IAC Barclay, LLC C/O The Ivanhoe Companies

6689 Orchard Lake Road, Suite 314
West Bloomfield, Michigan 48322 ph. (248) 626-6114

project:

# Barrington Park

City of Rochester Hills, Michigan Auburn Road & Barclay

sheet title:

Site Plan

LP14.006.01	01-14-201
LP14,006,02	2-24-2014
LP14,006,09	9-15-2014
LP14.006.09	9-22-201-
LP14.006.10	10-10-201
LP14,006,10	10-27-201
LP14.006.12 REVI	12-15-201
LP15,003.01 FEVE	1-26-2015

JP, CZ, DH FP


1-5-2015

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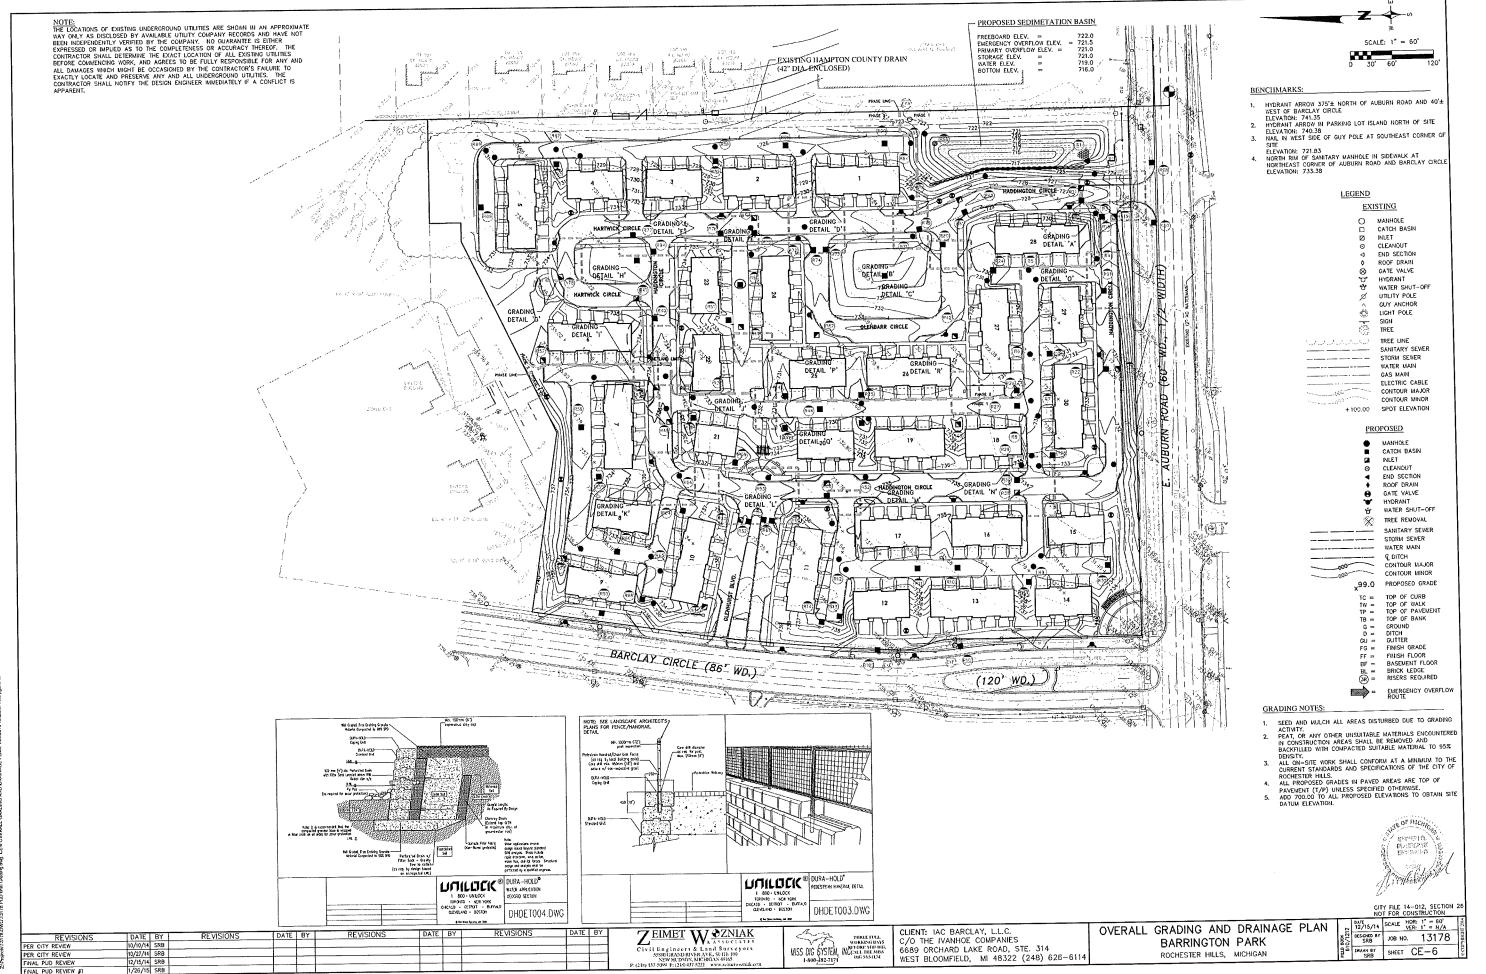
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**CE-4** 




PER CITY REVIEW FINAL PUD REVIEW

BARRINGTON PARK DRAWN BY SHEET CE-5 ROCHESTER HILLS, MICHIGAN

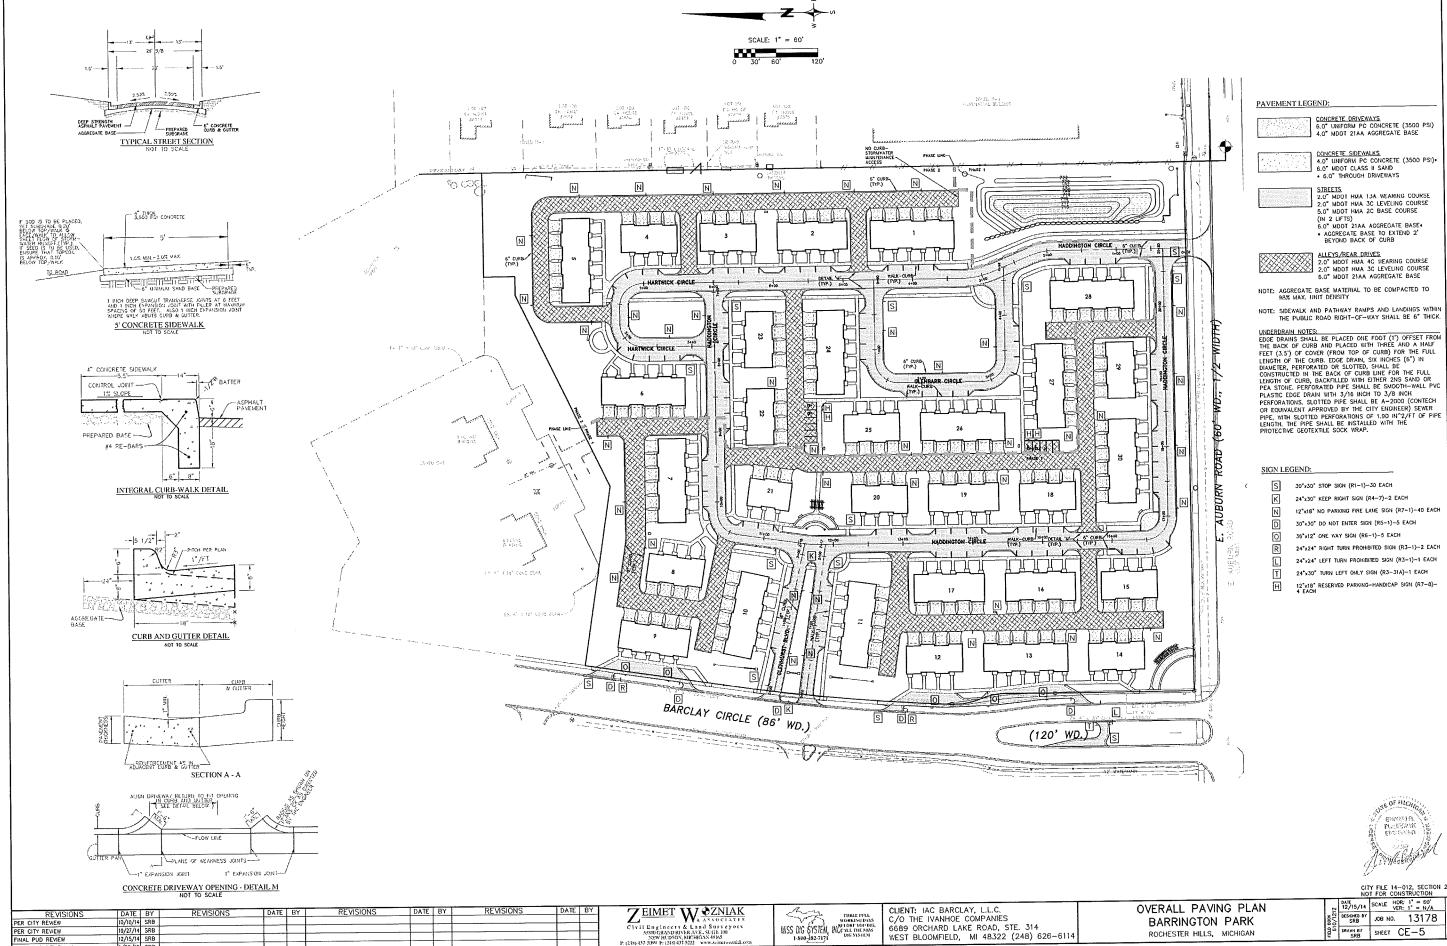

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### BENCHMARKS:

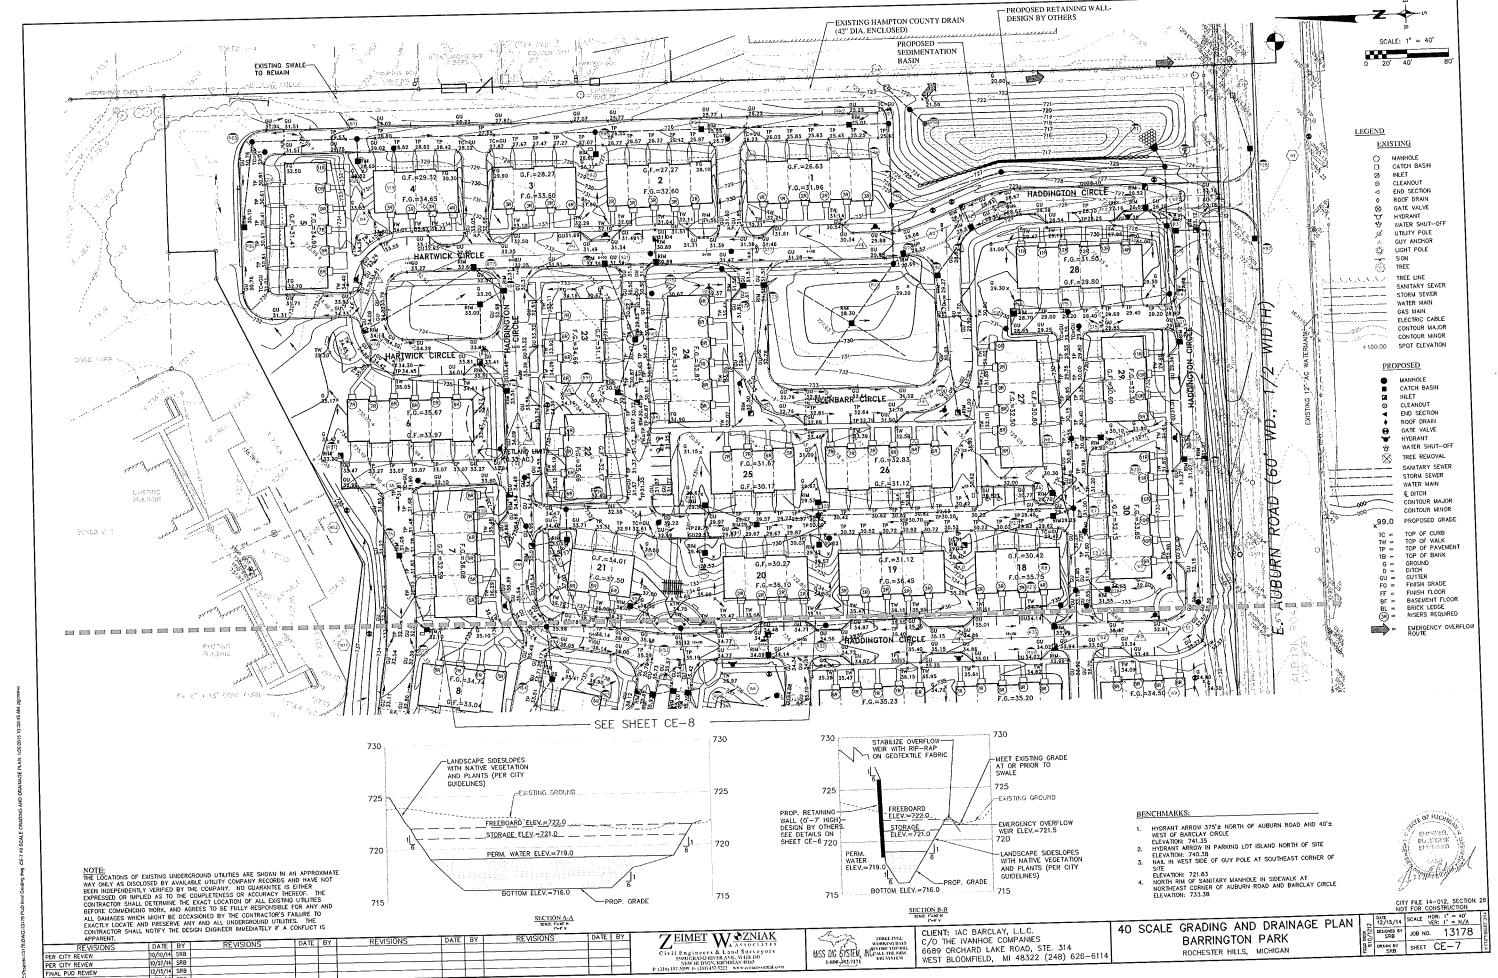- 1. HYDRANT ARROW 375' A NORTH OF AUBURN ROAD AND 40' EWEST OF BARCLAY CIRCLE ELEVATION: 741.5
  2. HYDRANT ARROW IN PARKING LOT ISLAND NORTH OF SITE ELEVATION: 740.78
  3. NAIL IN WEST SIDE OF GUY POLE AT SOUTHEAST CORNER OF SITE ELEVATION: 721.83
  4. NORTH RIM OF SANITARY MANHOLE IN SIDEWALK AT NORTHEAST CORNER OF AUBURN ROAD AND BARCLAY CIRCLE ELEVATION: 733.38

LEGEND

EXISTING MANHOLE CATCH BASIN INLET END SECTION ROOF DRAIN GATE VALVE HYDRANT WATER SHUT-OFF UTILITY POLE GUY ANCHOR LIGHT POLE

SIGN (3)

GAS MAIN ELECTRIC CABLE CONTOUR MAJOR CONTOUR MINOR + 100.00 SPOT ELEVATION PROPOSED

MANHOLE

CATCH BASIN INLET CLEANOUT END SECTION ROOF DRAIN GATE VALVE HYDRANT WATER SHUT-OFF

TREE REMOVAL SANITARY SEWER

STORM SEWER

WATER MAIN G DITCH CONTOUR MAJOR CONTOUR MINOR x99.0 PROPOSED GRADE

X93.0 PROPOSED STAND

IC = TOP OF CURB

IW = TOP OF WALK

IP = TOP OF BANK

G = GROUND

O = DITCH

GU = GUTTER

FG = FINSH GRADE

FF = FINSH FLOOR

BF = BASEMENT FLOOR


BL = BICK LEDGE

(38) = RISER'S REQUIRED

= EMERGENCY OVERFLOW ROUTE

TREE LINE
SANITARY SEWER
STORM SEWER

WATER MAIN

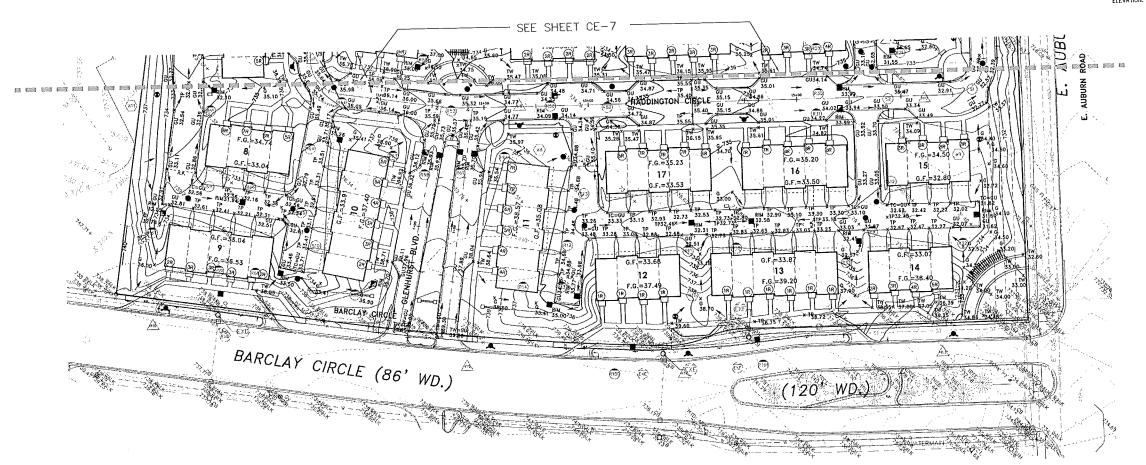




DATE 12/15/14 SCALE HOR: 1" = 40" VER: 1" = H/A

DESCRIED BY JOB NO. 13178


PRAWN BY SHEET CE-8

NOTE: THE LOCATIONS OF EXISTING UNDERGROUND UTILITIES ARE SHOWN IN AN APPROXIMATE WAY ONLY AS DISCLOSED BY AVAILABLE UTILITY COMPANY RECORDS AND HAVE NOT BEEN INDEPENDENTLY VERIFIED BY THE COMPANY. NO GUARANTEE IS EITHER EXPRESSED OR IMPLED AS TO THE CONTENTIONS OF ACCURACY THEREOF. THE CONTRACTOR SHALL DETERMINE THE EXACT LOCATION OF ALL EXISTING UTILITIES BEFORE COMMENCING WORK, AND AGREES TO BE FULLY RESPONSIBLE FOR ANY AND ALL DAMAGES WHICH MIGHT BE OCCASIONED BY THE CONTRACTOR'S FALLINE TO EXACTLY LOCATE AND PRESERVE ANY AND ALL UNDERGROUND UTULITIES. THE CONTRACTOR SHALL NOTIFY THE DESIGN DIGINEER IMMEDIATELY IF A CONFLICT IS				40 SCALE GRADING AND DRAINAGE PLAN
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PER CITY REVIEW 10/10/14 SRB		Civil Engineers & Land Surveyors SSEG GRAND RIVER AVE. 53-318 100 NEW MCDSON, MCHIGAN 84665 13	00 0 0 0 0 0 0 0 0 0 0 0 0 0 0 0 0 0 0	ROCHESTER HILLS, MICHIGAN
PER CITY REVIEW 10/27/14 SRB		NEW HUDSON, MICHIGAN 48165 P. (218) 437-5099 F: (248) 437-5222   www.k/microsonial.com	1-800-182-7171 WEST BLOOMFIELD, WIT 4-0322 (2-10)	
FINAL PUD REVIEW 12/15/14 SRB		F. (\$10) 137-23-7 (1-)-2-11		
FINAL PUD REVIEW #1 1/26/15 SRB				

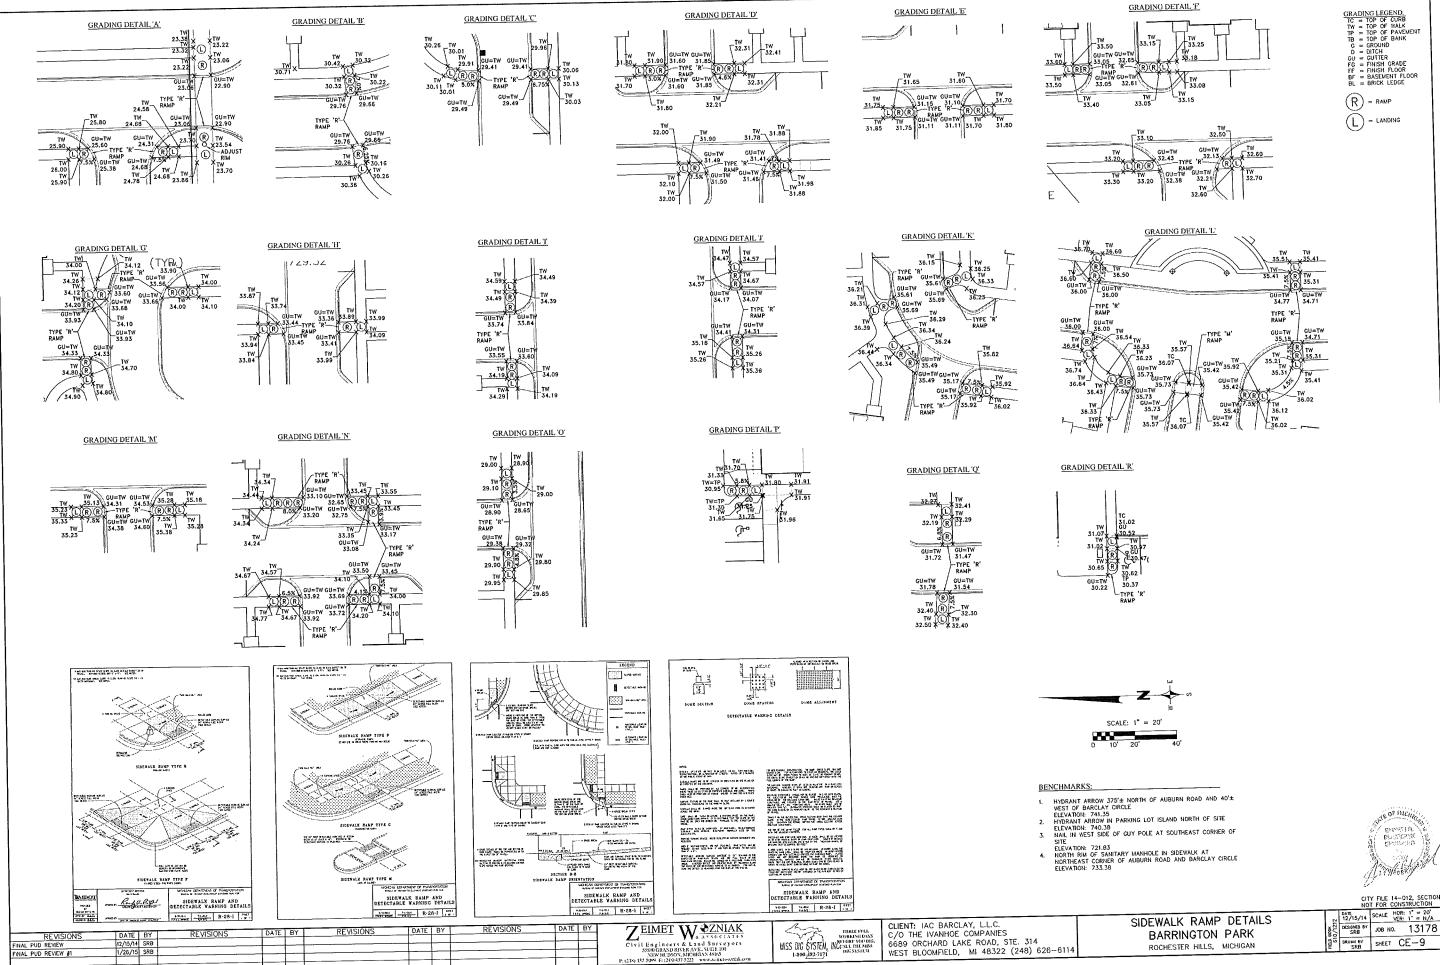


NAL PUD REVIEW #1

DESIGNED BY JOB NO. 13178 BARRINGTON PARK PANN BY SHEET CE-9 ROCHESTER HILLS, MICHIGAN

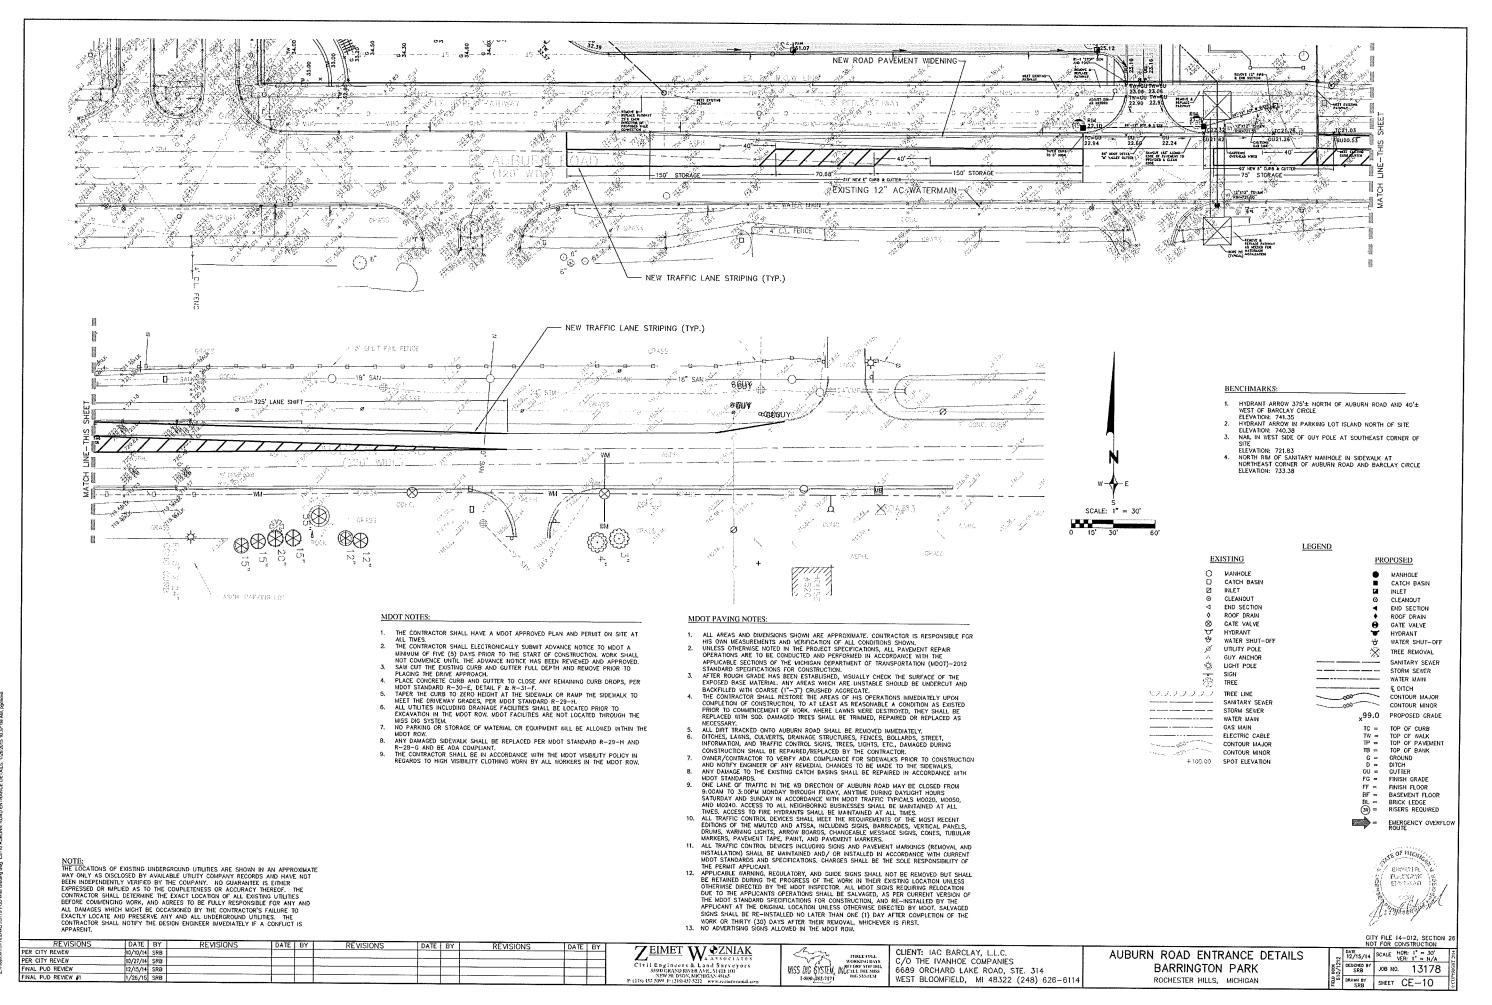

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NOTE:
THE LOCATIONS OF EXISTING UNDERGROUND UTILITIES ARE SHOWN IN AN APPROXIMATE WAY ONLY AS DISCLOSED BY AVAILABLE UTILITY COMPANY RECORDS AND HAVE NOT BEEN INDEPENDENTLY VERIFIED BY THE COMPANY. HO GUARANTEE IS EITHER EXPRESSED OR IMPLIED AS TO THE COMPLETENESS OR ACCURACY THEREOF. THE CONTRACTOR SHALL DETERMINE THE EXACT LOCATION OF ALL EXISTING UTILITIES BEFORE COMMENICING WORK, AND AGREES TO BE FULLY RESPONSIBLE FOR ANY AND ALL DAMAGES WHICH MIGHT BE OCCASIONED BY THE CONTRACTOR'S FAILURE TO EXACTLY LOCATE AND PRESERVE ANY AND ALL UNDERGROUND UTILITIES. THE CONTRACTOR SHALL NOTIFY THE DESIGN ENGINEER IMMEDIATELY IF A CONFLICT IS APPARENT.

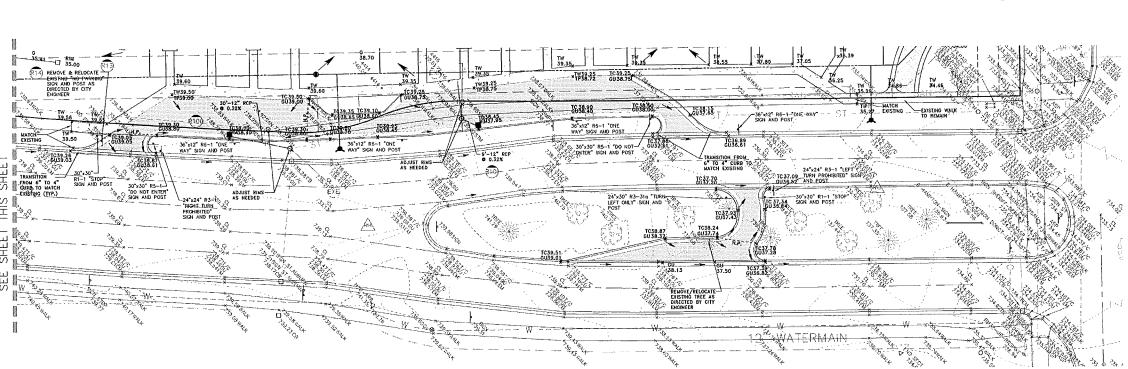

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CLIENT: IAC BARCLAY, L.L.C. C/O THE IVANHOE COMPANIES 6689 ORCHARD LAKE ROAD, STE. 314 WEST BLOOMFIELD, MI 48322 (248) 626-611BARRINGTON PARK

BARCLAY CIRCLE ENTRANCE DETAIL ROCHESTER HILLS, MICHIGAN

		CIT NO	Y FILE 14-012, SECTION T FOR CONSTRUCTION	26
LS	2	DATE 12/15/14	SCALE HOR: 1" = 20" VER: 1" = N/A	2000
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REVISIONS
PER CITY REVIEW
PER CITY REVIEW

XYOUNG TO TO THE TOP OF CURB
TW = TOP OF VALK
TP = TOP OF PAVEMENT
TB = TOP OF BANK
G = GROUND
D = DITCH
GU = GUTTER
FG = FINISH GRADE
FF = FINISH FLOOR
BF = BASEMENT FLOOR
BL = BRICK LEDGE
(39) = RISERS REQUIRED EMERGENCY OVERFLOW

1. HYDRANT ARROW 375'± NORTH OF AUBURN ROAD AND 40'±
WEST OF BARCLAY CIRCLE
ELEVATION: 741.35
HYDRANT ARROW IN PARKING LOT ISLAND NORTH OF SITE
ELEVATION: 740.38
NAIL IN WEST SIDE OF GUY POLE AT SOUTHEAST CORNER OF
SITE
ELEVATION: 721.83
NORTH RIM OF SANITARY MANHOLE IN SIDEWALK AT
NORTHEAST CORNER OF AUBURN ROAD AND BARCLAY CIRCLE
ELEVATION: 733.38

LEGEND

8 SIGN TREE TREE LINE SANITARY SEWER STORM SEWER WATER MAIN GAS MAIN ELECTRIC CABLE CONTOUR MAJOR CONTOUR MINOR +100.00 SPOT ELEVATION PROPOSED

EXISTING MANHOLE CATCH BASIN

INLET CLEANOUT END SECTION ROOF DRAIN GATE VALVE HYDRANT WATER SHUT-OFF UTILITY POLE GUY ANCHOR LIGHT POLE

CATCH BASIN INLET CLEANOUT

END SECTION ROOF DRAIN GATE VALVE


HYDRANT WATER SHUT-OFF


TREE REMOVAL

SANITARY SEWER STORM SEWER

CONTOUR MINOR x99.0 PROPOSED GRADE

WATER MAIN € DITCH CONTOUR MAJOR

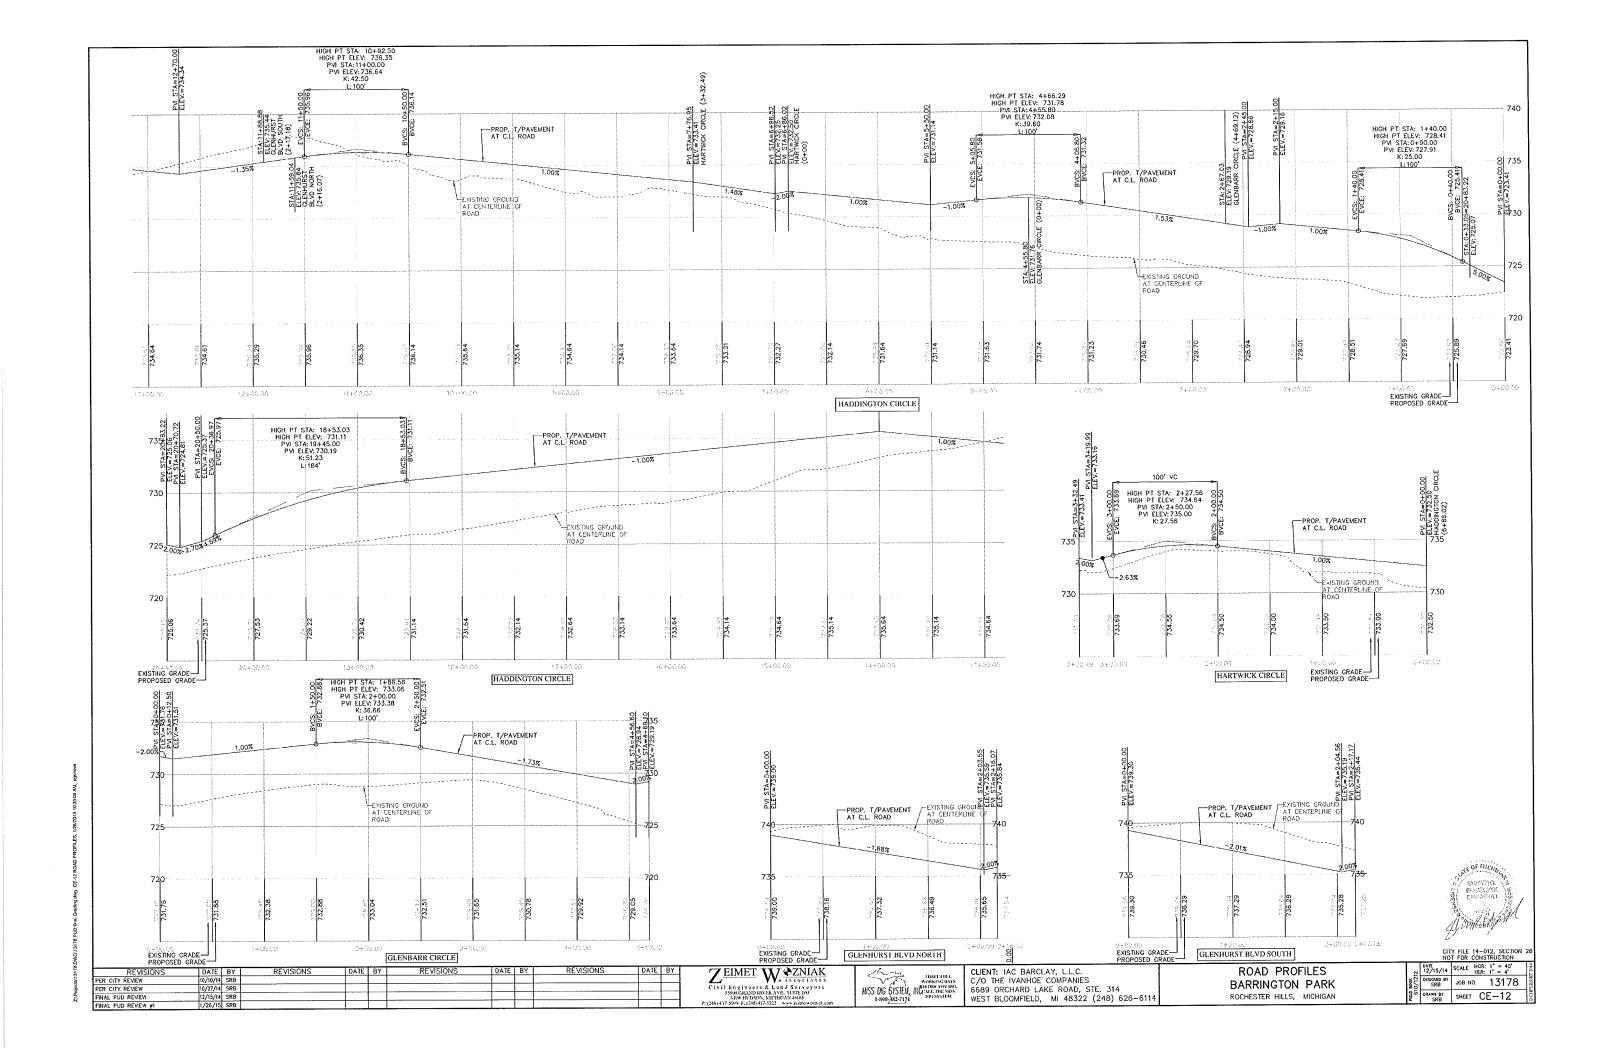

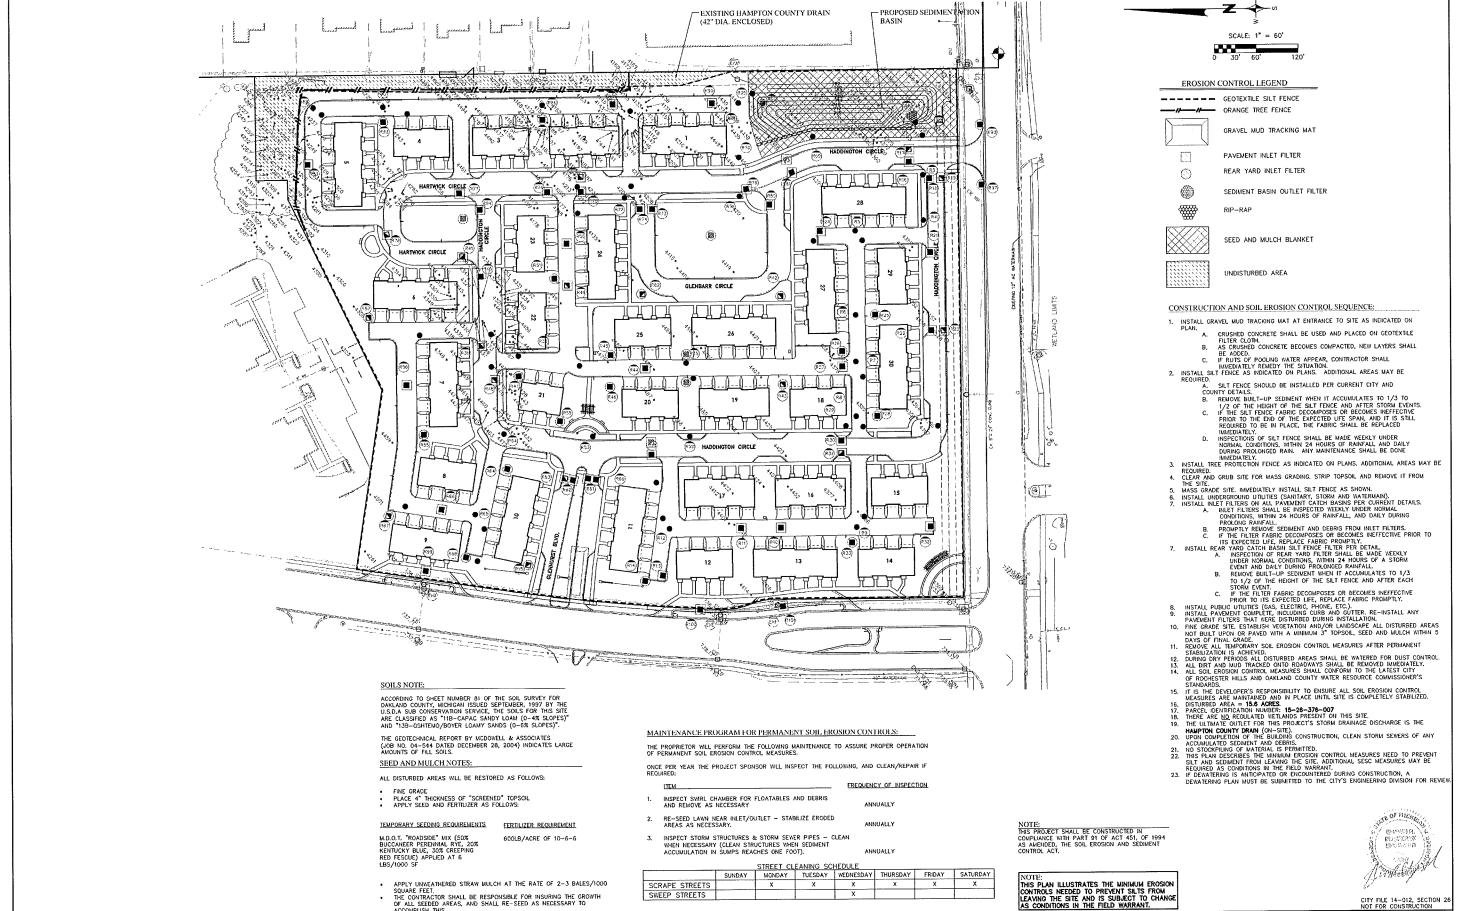

PER CITY REVIEW

NAL PUD REVIEW

ZEIMET WAZNIAK Civil Engineers & Land Surveyors
SSROGRAND RIVER AVE. SUITE HO
NEW HUDSON, MICHIGAN 48465
†(218) 475 909 FC (230) 437-5222

SCRAPE STREETS

APPLY UNWEATHERED STRAW MULCH AT THE RATE OF 2-3 BALES/1000 SQUARE FEET.

THE CONTRACTOR SHALL BE RESPONSIBLE FOR INSURING THE GROWTH OF ALL SEEDED, AREAS, AND SHALL RE-SEED AS NECESSARY TO

ACCOMPLISH THIS

MISS DIG SYSTEM, INCENT AND INCENT

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CLIENT: IAC BARCLAY, L.L.C. C/O THE IVANHOE COMPANIES 6689 ORCHARD LAKE ROAD, STE. 314 WEST BLOOMFIELD, MI 48322 (248) 626-6114 BARRINGTON PARK

SOIL EROSION CONTROL PLAN ROCHESTER HILLS, MICHIGAN

	NO	T FOR CONSTRUCTION
2	DATE 12/15/14	SCALE HOR: 1" = 60" VER: 1" = N/A
0/12	DESIGNED BY SRB	лов но.    13178
50	DRAWN BY SRB	SHEET CE-13

### STORMWATER MANAGEMENT:

THE HAMPTON COUNTY DRAIN EXTENDS ALONG THE SOUTH AND EAST PROPERTY LINES OF THE SITE AS AN ENCLOSED 42° DIA. PIPE WITHIN A 20' WIDE EASEMENT. THE DRAIN IS UNDER THE JURISDICTION OF THE OAKLAND COUNTY WATER RESOURCE COMMISSIONER AND HAS BEEN SIZED TO ACCOMMONATE RUNDEF FROM THIS SITE AT C=0.70, THE PROPOSED RUNDEF FROM THIS SITE IS CALCULATED AS:

BUILDING 2.72 ACRES @ 0.95 = 2.58
PAYEMENT 6.47 ACRES @ 0.95 = 6.15 (INCLUDES WALKS AND PATIOS)
0.20 ACRES @ 1.00 = 0.20
LAWN 6.21 ACRES @ 0.25 = 1.55
1.56
1.048

### C = 10.48/15.6 = 0.67 < 0.70 ALLOWABLE

SINCE THE PROPOSED RUNOFF IS LESS THAN THE DESIGN 'C' FOR THE DRAIN, NO ADDITIONAL DETERTION IS REQUIRED, PRE-TREATMENT OF THE FIRST FLUSH RUNOFF IS PROVIDED IN THE PROPOSED SEDIMENTATION BASIN.

### SEDIMENTATION BASIN:

A NEW SEDIMENTATION BASIN SHALL BE PROVIDED TO STORE AND TREAT THE FIRST  $1/2^{\circ}$  OF RUNOFF.

 $V = 1.815 \times A \times C = 1.815 \times 15.6 \times 0.67 = 18,970 CF$ 

### VOLUME AVAILABLE: AREA (SF) AVG. AREA (SF) DEPTH (FT) VOLUME (CF)

119	8,486	9,644	1	9,644
720	10,802	3,044	•	5,5 ( )
		12,043	1	12.043
721	13,285			21,687

THE ADDITIONAL VOLUME IS PROVIDED TO ALLOW FOR CONSTRUCTION TOLERANCES.

THE SEDMENT BASIN QUILET SHALL CONSIST OF A TEMPORARY QUILET CONTROL STRUCTURI (SO-2 FILTER) THAT SHALL BE REMOVED UPON STABILIZION OF THE SITE AND APPROVAL FROM OAKLAND COUNTY WATER RESOURCE COMMISSIONER'S OFFICE. A RESTRICTED PIPE SIZED TO SLOWLY RELEASE THE RUNDER WITHIN 48 HOURS SHALL CONNECT TO AN OVERFLOW STRUCTURE. THE OVERFLOW STRUCTURE SHALL HAVE A DISCHARGE PIPE SIZED FOR THE 10-YEAR FLOW FROM THE SITE AND CONNECT TO THE EXISTING HAMPTON COUNTY DRAIN (42").

SIZE RESTRICTOR:

SIZE RESIMICION:  $A = 0.3988 \times V/172,800 = 0.3988 \times 18,970/172,800 = 0.0438$  SF THIS EQUATES TO A 2.83" DIAMETER ORIFICE. THE MINIMUM ALLOWABLE ORIFICE IS 4". THEREFORE, USE A 4" DIAMETER ORIFICE.

A(4") = 0.0873 SF A(1") = 0.0055 SF NUMBER OF 1" HOLES IN STANDPIPE = 0.0873/0.0055 = 15.9

USE 16 (1") DIAMETER HOLES IN 2 ROWS. SET LOWEST ROW AT ELEVATION 719.0.

THE ADDITIONAL VOLUME IS PROVIDED TO ALLOW FOR CONSTRUCTION TOLERANCES.

OUTLET CONTROL STRUCTURE AND PIPE SIZING.

THE SEDIMENT BASIN QUITLET SHALL CONSIST OF A TEMPORARY QUITLET CONTROL STRUCTURE

SIZE QUITLET PIPE:
FROM THE STORM SEWER DESIGN CALCULATIONS THE 10-YEAR FLOW ENTERING THE BASIN OWN HE STORM IS 34.67 CFS.
FROM MANNING'S TABLE, A 42° DIAMETER PIPE AT 0.12% HAS A CAPACITY OF 35.0 CFS.

NOTE:
THIS IS A DRAINAGE DISTRIBUTION PLAN.
IT IS FOR REVIEW PURPOSES ONLY, IT
SHALL NOT BE USED FOR CONSTRUCTION
OR FIELD WORK.

REVISIONS PER CITY REVIEW

ZEIMET WAANSOCIATES
CIVIL Engineers & Land Surveyors
SSUGGAND RATHAVE, SUCID IN
NEW HUDSON, MICHIGAN ASIAS
(218) 137 909 F (218) 437 222 \*\*were/ameriovanial.co

MISS DIG SYSTEM, NUCLEUS THE MASS DIG SYSTEM NUCLEUS THE MASS DIG SYSTEM DIG SYSTEM

CLIENT: IAC BARCLAY, L.L.C. C/O THE IVANHOE COMPANIES
6689 ORCHARD LAKE ROAD, STE. 314 WEST BLOOMFIELD, MI 48322 (248) 626-6114

STORMWATER MANAGEMENT PLAN BARRINGTON PARK ROCHESTER HILLS. MICHIGAN

IUN		NOT FOR CONSTRUCTION					
	2	DATE 12/15/14	SCALE HOR: 1" = 60" VER: 1" = N/A				
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18

(120' WD.)

HADDINGTON CIRCLE

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- 4

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20

BENCHMARKS:

1. HYDRAHT ARROW 375'± NORTH OF AUBURN ROAD AND 40'±
NEST OF BARCLAY CIRCLE
ELEVATION: 741.35

2. HYDRAHT ARROW IN PARKING LOT ISLAND NORTH OF SITE
ELEVATION: 740.38

NAIL IN WEST SIDE OF GUY POLE AT SOUTHEAST CORNER OF SITE STIL ELEVATION: 721.83 NORTH RIM OF SANITARY MANHOLE IN SIDEWALK AT NORTHEAST CORNER OF AUBURN ROAD AND BARCLAY CIRCLE ELEVATION: 733.38

N: 5059.8530 E: 4979.5642

(MA)

5054.3425

E: 4221.8342

SCALE: 1" = 60" 

SANITARY SEWER BASIS OF DESIGN:
(USING THE OCURG SCHEDULE OF UNIT ASSIGNMENT FACTORS)

NO. OF UNITS
NO. OF REU'S = 0.60 REU/JUNIT x 148 UNITS
NO. OF PEOPLE = 3.5 PEOPLE/REU x 88 8 REU
AVG. DAILY FLOW RATE = 100 GPCPD x 310.8 PEOPLE
(7.5 x 24 x 3500) = 148 UNITS 88.8 REU = 310.8 PEOPLE = 0.048 CFS

PEAKING FACTOR
PEAK DAILY FLOW RATE = 4.0 x 100 GPCPD x 310.8 PEOPLE = 0.19 CFS
(7.5 x 24 x 3500)

A NEW DN-SITE  $B^{\bullet}$  DIA. SEWER AT 0.40% (MIN.) SLOPE HAS A CAPACITY OF 0.76 CFS.

THE EXISTING 15" DIA. SEWER AT 1.80% IN AUBURN ROAD HAS A CAPACITY OF 9 CFS.

N: 6069 8383

E: 4972.2163

EXISTING 20' WD. WATERMAIN EASEMENT L. 16338, P. 90, O.C.R

### FIRE DEPARTMENT NOTES:

- FIRE LANES SHALL BE CONSPICUOUSLY POSTED ON BOTH SIDES OF THE FIRE LANE, WITH FIRE LANE SIGN'S SPACED NOT MORE THAN 100 FEET APART, FIRE LANE SIGNS SHALL READ "NO STOPPING, STAINING, PARKING, FIRE LANE", AND IN COMPORMANCE WITH THE MICHIGAN MANUAL OF UNIFORM TRAFFIC CONTROL DEMONS.
- DEVICES.
  A 3-FOOT CLEAR SPACE SHALL BE MAINTAINED AROUND FIRE HYDRANTS.
  CONSTRUCTION SHALL BE SAFEGUARDED IN ACCORDANCE WITH IFC CHAPTER
- 14. OPEN BURNING IS NOT PERMITTED, INCLUDING THE BURNING OF TRASH, DEBRIS, OR LAND CLEARING MATERIALS. OPEN BURNING FOR WARMING OF SAND OR LAND CLEARING MATERIALS, OPEN BURNING FOR WARMING OF SAND AND/OR WATER FOR PREPARATION OF MORTAR SHALL BE WITHIN CITY OF ROCHESTER HILLS BURN PERMIT CUIDELINES. CONTACT ROCHESTER HILLS FIRE DEPARTMENT FOR PERMIT INFORMATION. THE PROPOSED BUILDING WILL NOT HAVE AUTOMATIC SPRINKLER SYSTEMS. PROPOSED BUILDING CONSTRUCTION SHALL BE V-B WITH THE FOLLOWING FIRE FLOWS RECUIRED:
- - 4-PLEX: 9600 SF (3 FLOORS), 2750 GPM WITH 3 HYDRANTS, AVERAGE SPACING 400', MAX. DISTANCE TO HYDRANT 225'.
  - 5-PLEX: 12,000 SF (3 FLOORS), 3000 GM WITH 3 HYDRANTS, AVERAGE SPACING 400', MAX. DISTANCE TO HYDRANT 225'.
  - 6-PLEX: 14,400 SF (3 FLOORS), 3250 GPM WITH 3 HYDRANTS, AVERAGE SPACING 350', MAX. DISTANCE TO HYDRANT 210'.

### WATERMAIN NOTES:

- 1. ALL CONSTRUCTION SHALL CONFORM TO THE CURRENT STANDARDS AND SPECIFICATIONS OF THE AGENCY HAVING JURISDICTION OVER THAT WORK.

  2. ALL HYDRANTS, INCLUDING NOZZLES AND PROJECTIONS SHALL BE 3' MINIMUM FROM EDGE OF SIDEWALK, OR 6' MINIMUM FROM EDGE OF STANDARD SHALL BE 3' MINIMUM FROM EDGE OF COVER.

  3. THE WATERMAIN WILL HAVE A MINIMUM OF 6 FEET OF COVER.

  4. THE WATERMAIN WILL HAVE A MINIMUM OF 6 FEET OF COVER.

  5. ALL WATERMAIN SHALL BE 8' (MIN), CEMENT-LINED (DOUBLE THICKNESS), DUCTUE IGNON PIPE, CLASS 54 POLYWRAPPED PER CURRENT CITY STANDARD DETAILS CENTERED IN A 20' WIDE EASEMENT.

  6. A VERTICAL SEPARATION OF 18 INCHES MUST BE MAINTAINED BETWEEN THE WATERMAIN AND SANITARY SEWERS, STORM SEWERS, OR DTHER PROPOSED UNTILES.

- UTILITES.

  7. ALL GATE VALVES SHALL BE RESIDENT WEDGE OR SEATED TYPE GATE VALVE (E.J.W. OR U.S. PIPE).

  8. RESTRAINED ROODED JOINTS SHALL BE USED AT ALL VERTICAL BENDS. THE NUMBER OF RESTRAINED ROODED JOINTS REQUIRED SHALL BE DETERMINED BY THE MANUPACTURER, SUBJECT TO APPROVAL BY THE CITY ENGINEER.

  9. USE HYDRANT CONNECTION DETAILS PER CURRENT CITY STANDARD DETAIL SHEET.
- 10. WATER SERVICES SHALL BE 2" SDR-9 POLY PIPE OR TYPE 'K' COPPER.

# SANITARY SEWER NOTES:

- ALL CONSTRUCTION SHALL CONFORM TO THE CURRENT STANDARDS AND
  SPECIFICATIONS OF THE AGENCY HAVING JURISDICTION OVER THAT WORK,
  2. ALL SANITARY SEWER BULDING LEADS WILL BE SOLD WALL PVC SOR 23.5 PIPE.
  3. ALL SANITARY SEWER MAINS SHALL BE PUBLIC AND 8" PVC TRUSS PIPE CENTERED

- ALL SANTARY SEWER MAINS SHALL BE PUBLIC AND 8 PVC INCOS PIPE CENTERED IN A 20' MIDE EASEMENT.

  SANTARY SEVER DROP CONNECTIONS MUST BE EXTERNAL TYPE.

  THE MINIMUM SLOPE FOR 6" SANITARY BUILDING LEADS IS 1.00%.

  ALL PROPOSED SEWERS SHALL HAVE CHEMICALLY WELDED JOHTS.

  THE CONTRACTOR SHALL HAVE A TELEVISION INSPECTION OF THE EXISTING SANITARY LEAD PERFORMED PRIOR TO CONSTRUCTION TO VERIFY THE CONDITION OF THE EXISTING PIPE. THE CITY INSPECTOR SHALL WITHNESS THE SCOPE AND A WIDEO COPY SHALL BE PROVIDED TO THE CITY.

# STORM SEWER NOTES:

- 1. PROPOSED STRUCTURE COVERS/GRATES SHALL BE PROVIDED AS REQUIRED ON THE CITY OF ROCHESTER HILLS STANDARD DETAIL SHEETS.

  2. DOSE PRAIN TO BE TO! IN EACH DIRECTION AT 90' ANGLES FROM INLET STRUCTURES LOCALIZATIONS AND INFECTION AT 90' ANGLES FROM INLET STRUCTURES CALCULATIONS AND SHOP DRAWINGS, SIGNED AND SEALED BY A PROFESSIONAL ENGHEER (REGISTERED IN THE STATE OF MICHIGAN) SHALL BE SUBBILITED TO THE CITY FOR REVEW PRIOR TO CONSTRUCTION OF ALL STORM SEWER STRUCTURES GREATER THAT 6 FEET IN DIAMETER.

  PROPOSED ROOF DRAINS SHALL BE SCHEDULE 40 PVC PIPE WITH CHEMICALLY WELDED JOINTS.

  PROPOSED STORM SEWER PIPE SHALL BE MIN. 12' REINFORCED CONCRETE CLASS IV WITH RUBBER GASKETS AND CLASS B BEDDING.

  6. A STORMWATER MAINTENANCE AGREEMENT AND EXHIBIT IS REQUIRED TO BE RECORDED PRIOR TO FINAL APPROVAL OF CONSTRUCTION DOCUMENTS.

N; 5926.7415 E: 4265.7085

(S19) 4

HARTWICK CIRCLE

HARTWICK CIRCLE

1 (RES)

BARCLAY CIRCLE (86' WD.)

UTILITY LEGEND EXISTING


- CATCH BASIN
- INIET CLEANOUT
- END SECTION
- ROOF DRAIN GATE VALVE
- HYDRANT
- WATER SHUT-OFF

UTILITY POLE

- GUY ANCHOR LIGHT POLE
- TREE
- TREE LINE
  - SANITARY SEWER STORM SEWER WATER MAIN
  - ELECTRIC CABLE
  - PROPOSED
  - CATCH BASIN INLET
  - CLEANOUT END SECTION
  - GATE VALVE HYDRANT
  - WATER SHUT-OFF TREE REMOVAL X SANITARY SEWER
- STORM SEWER WATER MAIN **€** DITCH





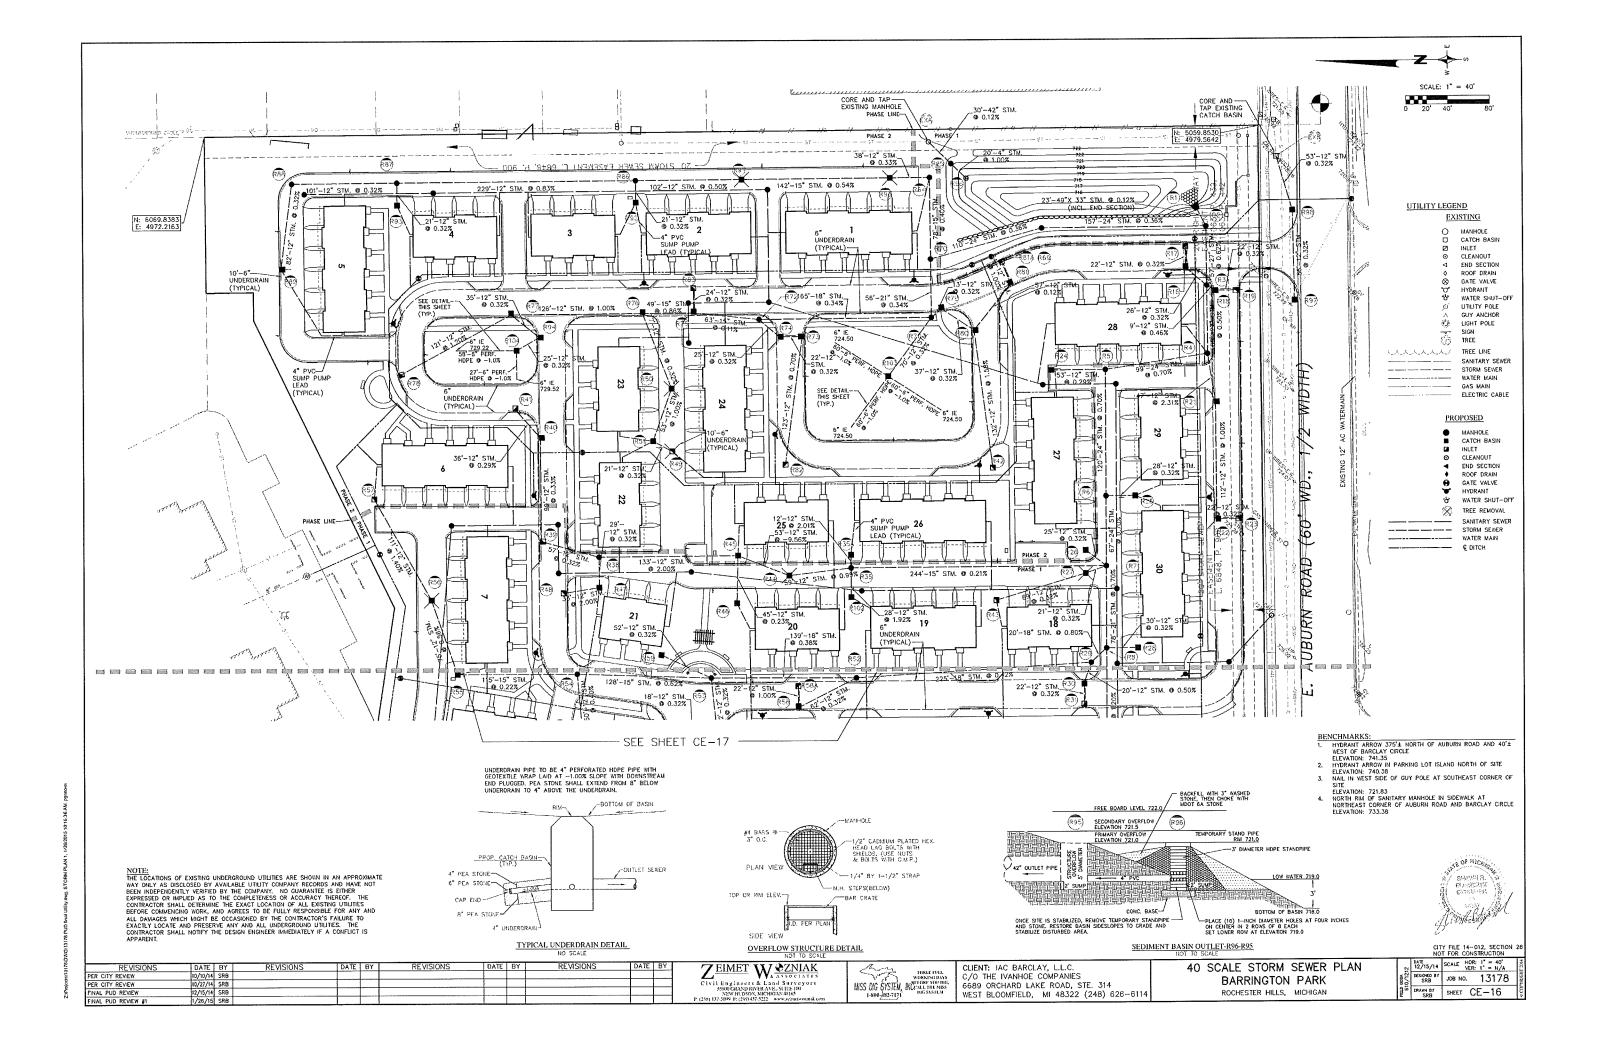



REVISIONS /26/15 SRB INAL PUD REVIEW #1

4' CATCH BASIN

5' MANHOLE

733.10 12\*

E

NW N S

728.87 5214.12

724.36 724.50 724.30

4301,13

4' CATCH BASIN

4323.16

4322.68

4322.43

728.62 728.72

728.90 729.00

5316.29

5373.61

S

S

4' CATCH BASIN

4' CATCH BASH

733.00 12

ZEIMET WAZNIAK
CIVIL Engineers & Land Surveyors
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SEW HI DSON, MICHIGAN SIGN
PORTUGE STATES OF CONTROLLED BY CONTROLL

730.50 5501.80 4425.81

4 CAICH RASN 731.66 12 W 727.35 5953.48 4529.04 PRET 733.20 12 SN 729.00 5907.83 4625.68

734.73 12" SE

MISS DIG SYSTEM, INCENT HE STATES
1-800-182-7171

5' CATCH BASIN

732.60 12°

728.42 728.30 728.40

5776.21

4801.30

SW S NW

CLIENT: IAC BARCLAY, L.L.C. C/O THE IVANHOE COMPANIES 6689 ORCHARD LAKE ROAD, STE. 314 WEST BLOOMFIELD, MI 48322 (248) 626-6114

4' CATCH BASSN

4' CATCH BASRI

721.70 12\* 12\*

4' CATCH 737.95 12" NE

4' CATCH 737.10 12"

¥

738.40 12° S 734.20 5432.93

717.62 717.52

w 732.90 5826.30

733,75 5313,45

5027.39

40 SCALE STORM SEWER PLAN BARRINGTON PARK

4898.77

4265,24

4204.15

4208.36

CITY FILE 14-012, SECTION 2 NOT FOR CONSTRUCTION

ROCHESTER HILLS, MICHIGAN

DATE 12/15/14 SCALE HOR: 1" = 40' VER: 1" = N/A DESCRETE BY JOB NO. 13178 DRAWN BY SHEET CE-17

NOTE:
THE LOCATIONS OF EXISTING UNDERGROUND UTILITIES ARE SHOWN IN AN APPROXIMATE WAY ONLY AS DISCLOSED BY AVAILABLE UTILITY COMPANY RECORDS AND HAVE NOT BEEN INDEPENDENTLY VERIFIED BY THE COMPANY. NO GUARANTEE IS EITHER EXPRESSED OR IMPLIED AS TO THE COMPLETENESS OR ACCURACY THEREOF. THE CONTRACTOR SHALL DETERMINE THE EXACT LOCATION OF ALL EXISTING UTILITIES BEFORE COMMENCING WORK, AND AGREES TO BE FULLY RESPONSIBLE FOR ANY AND ALL DAMAGES WHICH MIGHT BE OCCASIONED BY THE CONTRACTOR'S FAILURE TO EXACTLY LOCATE AND PRESERVE ANY AND ALL UMBERGROUND UTILITIES. THE CONTRACTOR SHALL NOTIFY THE DESIGN ENGINEER IMMEDIATELY IF A CONFLICT IS APPARENT.

BENCHMARKS:


ENCHMARKS:


HYDRAIT ARROW 375'± NORTH OF AUBURN ROAD AND 40'±
WEST OF BARCLAY CIRCLE
ELEVATION: 741.35

HYDRAIT ARROW IN PARKING LOT ISLAND NORTH OF SITE
ELEVATION: 740.38

NAIL IN WEST SIDE OF GUY POLE AT SOUTHEAST CORNER OF
SITE
ELEVATION: 721.83

NORTH RIM OF SANITARY MANHOLE IN SIDEWALK AT
NORTHEAST CORNER OF AUBURN ROAD AND BARCLAY CIRCLE
ELEVATION: 733.38

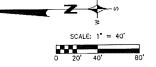

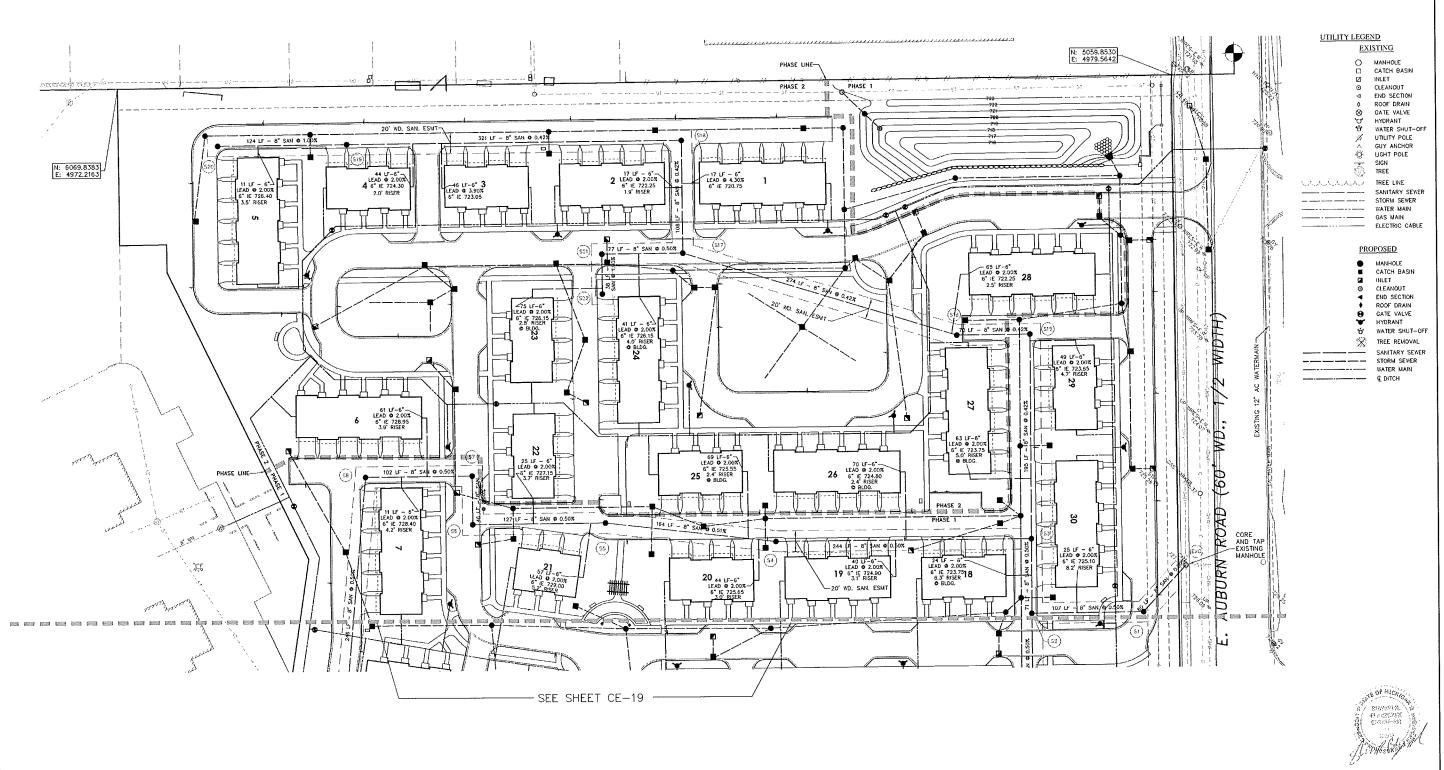

DATE 12/15/14 SCALE HOR: 1" = 40" 40 SCALE SANITARY SEWER PLAN MISS DIG SYSTEM, INCREMENTED HAS BEEN AND SYSTEM INCREMENTED H CLIENT: IAC BARCLAY, L.L.C. C/O THE IVANHOE COMPANIES DATE BY DESIGNED BY JOB NO. 13178 BARRINGTON PARK 6689 ORCHARD LAKE ROAD, STE. 314 WEST BLOOMFIELD, MI 48322 (248) 626-6114 PER CITY REVIEW FINAL PUD REVIEW SRB SHEET CE-18 ROCHESTER HILLS, MICHIGAN

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- BENCHMARKS:

  1. HYDRANT ARROW 375'± NORTH OF AUBURN ROAD AND 40'± WEST OF BARCLAY CIRCLE ELEVATION: 74.3.5


  2. HYDRANT ARROW IN PARKING LOT ISLAND NORTH OF SITE ELEVATION: 740.3B

  3. MAIL IN WEST SIDE OF GUY POLE AT SOUTHEAST CORNER OF SITE ELEVATION: 721.83

  4. NORTH RIM OF SANITARY MANHOLE IN SIDEWALK AT NORTHEAST CORNER OF AUBURN ROAD AND BARCLAY CIRCLE ELEVATION: 733.38





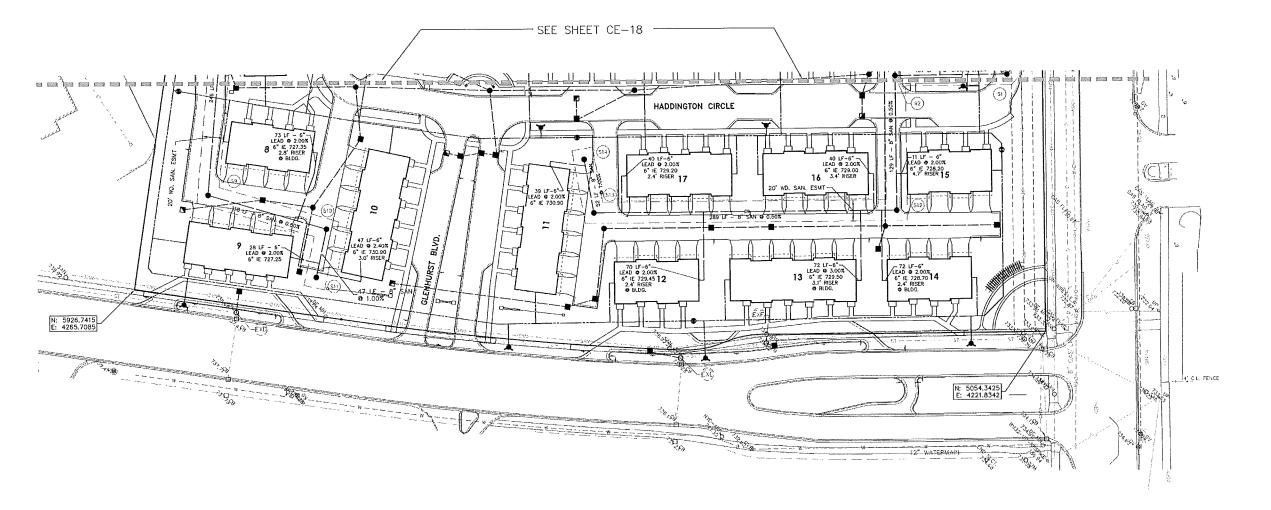

### UTILITY LEGEND

# EXISTING

MANHOLE CATCH BASIN INLET CLEANOUT END SECTION ROOF DRAIN GATE VALVE

HYDRANT WATER SHUT-OFF GUY ANCHOR LIGHT POLE

SIGN NUNUALALALA TREE LINE

WATER MAIN ELECTRIC CABLE

# PROPOSED

CATCH BASIN INLET CLEANOUT END SECTION ROOF DRAIN GATE VALVE HYDRANT WATER SHUT-OFF

TREE REMOVAL SANITARY SEWER 

--- WATER MAIN 

NO	DESCRIPTION	RIM	DIDE	DIRECTION	INVERT	NORTHING	FASTING
معمد	CLOCIME NON	DIM	Sulfi.b	VINE O HON	Trimiz.	110.11111110	- S211119.
EXC	W/ DROP COMMECTION	727.22	8" 15" 15"	NaY E ₩	715.67 715.18 715.18	5049.16	4511.81
51	4" MANIHOLE	732.67	8°	N SE	715.07 715.97	5090.13	4467.50
SZ	5' MANHOLE W/ DROP COMMECTION	732.72	6° 8° 8°	E S W	716,71 716.61 722.75	5197.21	4466.82
53	5' MANHOLE W/ DROP CONNECTION	731.06	8° 8°	₩ E ₩	720.30 717.17 717.07	5197.21	4538,21
54	4' MANHOLE	730.37	8" 8"	N S	721.61 721.51	5441.06	4537,14
\$5	4' MANHOLE	732.34	8" 8"	N 5	722.54 722.44	5604.23	4555.69
56	4' MANHOLE	734.98	8°	E S	723.28 723.18	5731.23	4554.74

E S

S11 4' MANCHOLE 735.36 8" E 726.71 5752.49 4276.72

723.61 723.51

724 22 724.12

W 726.24 5742.67

5731.60

5834.10

725.45 725.55 5855.90

4600.35

4355 50

S7 4' MANHOLE 734.52 8.

S9 4" MANHOLE 732.65 8".

4" MANHOLE 733.45 8" 8"

SANITARY SEWER TABLE:

		SAN	ITAR	Y SEWER	TABLE		
NO.	DESCRIPTION	RIM	PIPE	DIRECTION	INVERT	NORTHING	EASTING
512	4' MANHOLE	732.81	8* 8*	¥¥ E	724.69 723.39	5196.23	4338.22
S13	5' MANHOLE W/ DROP CONNECTION	734.43	8°	S E	726.13 729.63	5485.72	4336.94
\$14	4" MANHOLE	735.51	8*	₩	730,15	5494.83	4388.13
\$15	4' MANHOLE	729.54	8°	W	717.99 718.09	5197.21	4733.40
S15	4' WANHOLE	730.31	8°.	S N	718.38 718.48	5267.05	4732.88
S17	4' MANHOLE	731.71	8. 8.	E N S	719.73 721.10 719.63	552B.67	4512.73
518	4" MANHOLE	725.91	8"	H	720.28 720.18	5529.45	4920.27
\$19	4" MANHOLE	728.78	8°	N S	721.73 721.63	5850.44	4917.91
S20	4' DANHOLE	731.13	8*	S	722.97	5974.17	4917.01
S21	4' MANHOLE	731,16	8°	S	721.48 721.47	5606.16	4812.17
522	4' MANHOLE	730.62	6"	E	721,85	5605.87	4774.07



FINAL PUD REVIEW #1

ZEIMET WAZNIAK Civil Engineers & Land Surveyors
SSSEGRAND ENTRAVELSTRING
SSSEGRAND ENTRAVELSTRING
P. (218) 437-5227 www.comstournisk.

MISS DIG SYSTEM, INCREMENTAL THE BUILD IN STREET FULL WORKING DAYS BUILDING TO BUILDING SYSTEM BUILDING SYSTEM

CLIENT: IAC BARCLAY, L.L.C. C/O THE IVANHOE COMPANIES 6689 ORCHARD LAKE ROAD, STE. 314 WEST BLOOMFIELD, MI 48322 (248) 626-6114 40 SCALE SANITARY SEWER PLAN BARRINGTON PARK ROCHESTER HILLS, MICHIGAN

DATE 12/15/14 SCALE HOR: 1" = 40" VER: 1" = N/A DESIGNED BY JOB NO. 13178 DRAWN BY SRB SHEET CE-19

NOTE:
THE LOCATIONS OF EXISTING UNDERGROUND UTILITIES ARE SHOWN IN AN APPROXIMATE WAY ONLY AS DISCLOSED BY AVAILABLE UTILITY COMPANY RECORDS AND HAVE NOT BEEN INDEPENDENTLY VERIFIED BY THE COMPANY. NO GUARANTEE IS EITHER EXPRESSED OR IMPLIED AS TO THE COMPLETENESS OR ACCURACY THEREOF. THE CONTRACTOR SHALL DETERMINE THE EXACT LOCATION OF ALL EXISTING UTILITIES BEFORE COMMENCING WORK, AND ACREES TO BE FULLY RESPONSIBLE FOR ANY AND ALL DAMAGES WHICH MIGHT BE OCCASIONED BY THE CONTRACTOR'S FAILURE TO EXACTLY LOCATE AND PRESERVE ANY AND ALL UNDERGROUND UTILITIES. THE CONTRACTOR SHALL NOTIFY THE DESIGN ENGINEER IMMEDIATELY IF A CONFLICT IS APPARENT.

REVISIONS
PER CITY REVIEW
PER CITY REVIEW
FINAL PUD REVIEW

REVISIONS

BENCHMARKS:

BENCHMARKS:


1. HYDRANT ARROW 375'± NORTH OF AUBURN ROAD AND 40'± WEST OF BARCLAY CIRCLE LEVATION: 741.35

2. HYDRANT ARROW IN PARKING LOT ISLAND NORTH OF SITE LEVATION: 740.38

3. NAL IN WEST SIDE OF GUY POLE AT SOUTHEAST CORNER OF SITE LEVATION: 721.83

4. NORTH RIM OF SANITARY MANHOLE IN SIDEWALK AT NORTHEAST CORNER OF AUBURN ROAD AND BARCLAY CIRCLE ELEVATION: 733.38

SCALE: 1" = 40' 

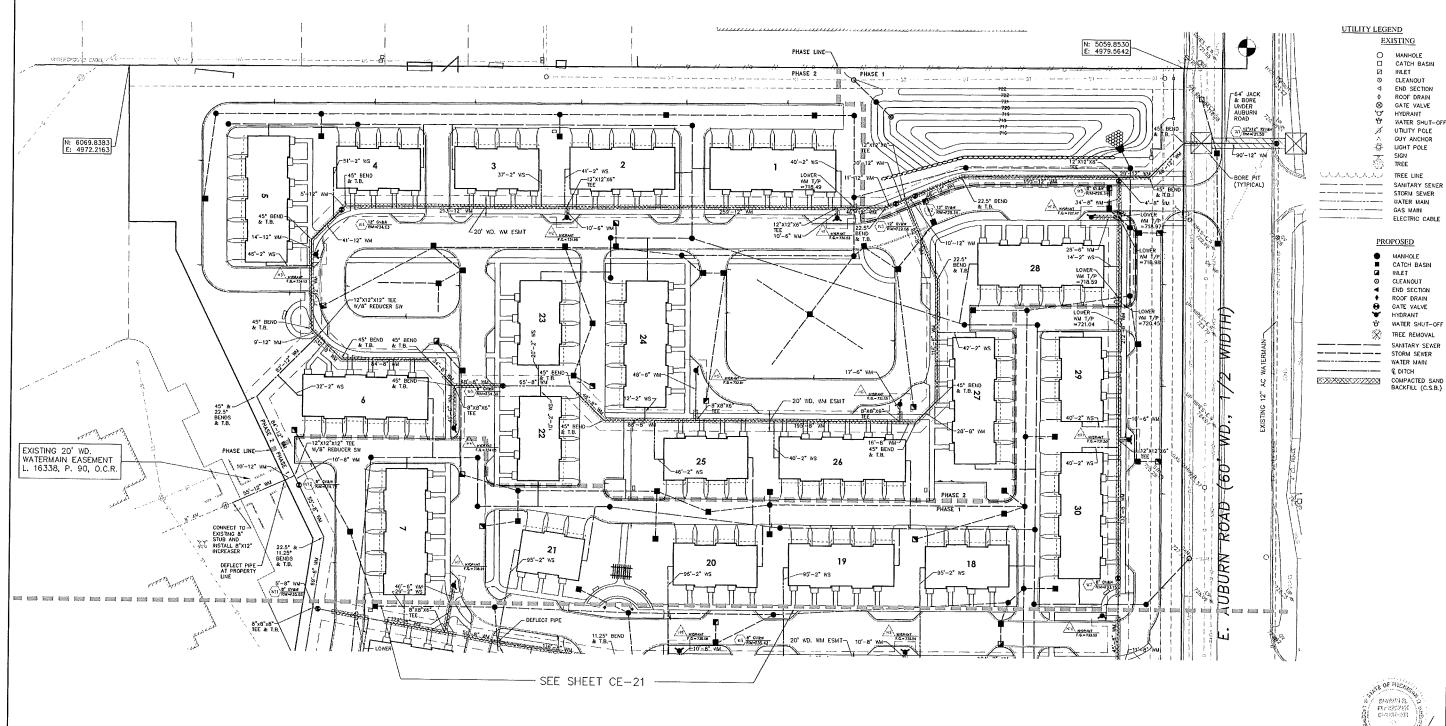

Civil Engineers & Land Surveyors
5500 GRAND RIVER AVE. 50:018 RD
NEW HLDSON, MICHIGAN 4865
(218) 437-599 Ft (28)437-5222 New Acting propriet

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CLIENT: IAC BARCLAY, L.L.C.

C/O THE IVANHOE COMPANIES 6689 ORCHARD LAKE ROAD, STE. 314

WEST BLOOMFIELD, MI 48322 (248) 626-6114

CITY FILE 14-012, SECTION 26 NOT FOR CONSTRUCTION DATE 12/15/14 SCALE HOR: 1" = 40' VER: 1" = N/A

DESCRIB BY JOB NO. 13178

BY SRB SHEET CE-20

40 SCALE WATERMAIN PLAN

BARRINGTON PARK

ROCHESTER HILLS, MICHIGAN

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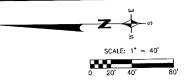
BENCHMARKS:


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NORTHEAST CORNER OF AUBURN ROAD AND BARCLAY CIRCLE
ELEVATION: 733.38





UTILITY LEGEND				
<u>E2</u>	<u> (ISTING</u>			
0	MANHOL			

MANHOLE CATCH BASIN INLET
CLEANOUT
END SECTION
ROOF DRAIN
GATE VALVE HYDRANT WATER SHUT-OFF UTILITY POLE GUY ANCHOR LIGHT POLE SIGN TREE

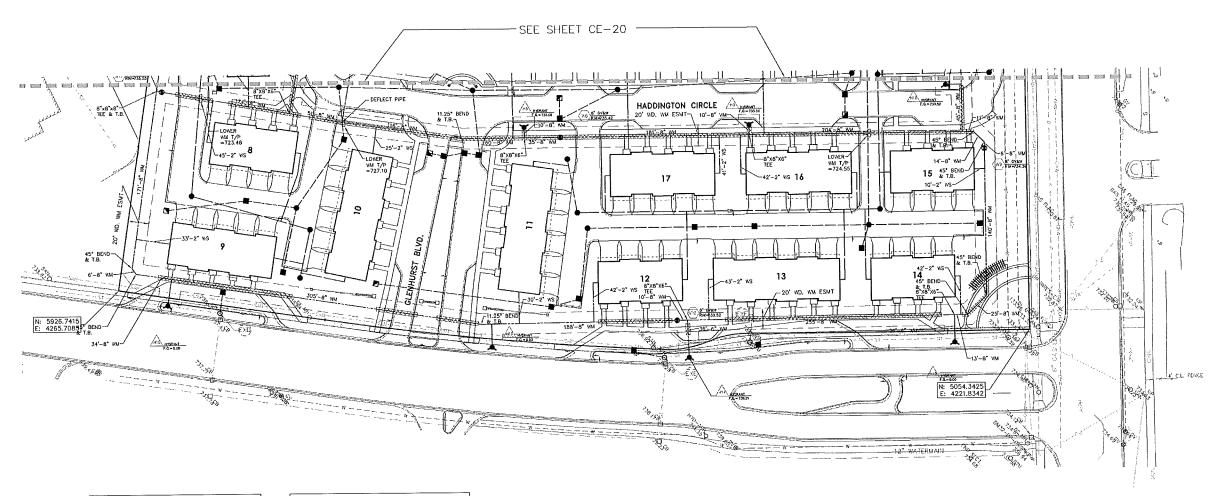Sala Water SANITARY SEWER
STORM SEWER WATER MAIN

TREE LINE

# ELECTRIC CABLE

MANHOLE CATCH BASIN INLET CLEANOUT

PROPOSED

END SECTION ROOF DRAIN GATE VALVE HYDRANT

WATER SHUT-OFF TREE REMOVAL SANITARY SEWER

STORM SEWER WATER MAIN © DITCH COMPACTED SAND BACKFILL (C.S.B.)

<u>NO</u>	DESCRIPTION	RIM/FG	NORTHING	EASTING
Hi	HYDRANT	730.53	5389.89	4833.41
H2	HYDRANT	731.98	5648,60	4831,37
Н3	HYDRANT	734.13	5889.26	4793.47
H4	HYDRANT	734.65	5754.83	4628.99
Н5	HYDRANT	732.81	5523.54	4686,69
H6	HYDRANT	731.55	5328.14	4656.54
		770.04	E757 41	4470 07

WATER MAIN TABLE:

736.21 5753.41 4479.07 H8 HYDRANT 735.06 5536.41 4418.71 HYDRANT 735.54 5320.57 4419.67 733.52 5132.04 4456.50 HYDRANT HYDRANT 731,50 5108.28 4624.80 H12 HYDRANT 727.47 5146.98 4836.78 H13 HYDRANT 0.00 5125.69 4210.76 HYDRANT 739.21 5379.90 4198.07

HYDRANT 0.00 5568.50 4209.35

HYDRANT 0.00 5879.43 4251,16

WATER MAIN TABLE:						
<u>NO</u>	DESCRIPTION	RIM/FG	NORTHING	EASTING		
W1	12"X12" TSV&W	721.50	4970.72	4908.78		
₩2	12" GV&W	729.34	5315.75	4855.34		
W3	12" GV&W	729.66	5334.22	4847.65		
W4	12" GV&W	734.03	5864.93	4836.39		
W5	8* GV&W	734.39	570B.15	4669.90		
W6	8" GV&W	735.42	5501.52	4408.94		
W7	8" GV&W	733.15	5117.28	4492,40		
W8	8" GV&W	726.34	5120.91	4871.48		
W9	8" GV&W	734.39	5095.49	4395.27		
W10	8* GV&W	739.52	5391.22	4233,52		
WII	8" GV&W	735,55	5883.62	4455.09		
W12	8" GV&W	734.72	5902.82	4573.23		

CITY FILE 14-012, SECTION 2

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a113	FINAL PUD REVIEW	12/15/14
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		SRB							
	12/15/14								
1	1/26/15	SRB							
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CLIENT: IAC BARCLAY, L.L.C. C/O THE IVANHOE COMPANIES
6689 ORCHARD LAKE ROAD, STE. 314 WEST BLOOMFIELD, MI 48322 (248) 626-6114 40 SCALE WATERMAIN F BARRINGTON PARK ROCHESTER HILLS, MICHIGAN

		NO	I FOR CONS	RUCHON
PLAN		DATE 12/15/14	SCALE HOR: VER:	1" = 40 1" = N/A
	×27	DESIGNED BY SRB	JOB NO.	13178
	32	DRAWN BY	SHEET C	E-21