PROPOSED FLACISTANK

ALD ALMES IMEALESTED BULLETE

ROCHISTER HILLS, MICHIGAN

AUBURN ROAD

LOCATION MAP NOT TO SCALE

Project Sponsor: FLAGSTAR BANK 5151 CORPORATE DRIVE TROY, MI CONTACT: PAUL BUC

CIVIL ENGINEER: Zeimet-wozniak and assoc., inc. 55800 GRAND RIVER SUITE 100 NEW HUDSON, MI Contact: Shawn Blaszczyk, Pe

ARCHUECU: MICHAEL BOGGIO ASSOCIATES 30100 TELEGRAPH ROAD SUITE 216 BINGHAM FARMS, MI Contact: Michael Boggio, Ala

LANDSCAPE ARCHITECT: AITHEN DESIGN 557 CARPENTER NORTHVILLE, MI CONTACT: JIM ALLEN

Sheet Index

COVER SHEET

DIMENSION PLAN

GRADING & EROSION CONTROL PLAN

UTILITY PLAN STORM AREA PLAN

EXISTING CONDITIONS

LANDSCAPE PLAN

IRRIGATION PLAN

FLOOR PLAN

ELEVATIONS

STANDARD DETAIL SHEETS

WATERMAIN DETAILS

WATERMAIN DETAILS

SANITARY SEWER DETAILS

STORM SEWER DETAILS

EROSION CONTROL DETAILS

FLAGSTAR BANK PARCEL DESCRIPTION

A PARCEL OF LAND LOCATED IN PART OF THE SOUTHWEST 1/4 OF SECTION 30, T. 3 N., R. 11 E., CITY OF ROCHESTER HILLS, OAKLAND COUNTY, MICHIGAN, MORE PARTICULARLY DESCRIBED AS:

COMMENCING AT THE EAST 1/4 CORNER OF SAID SECTION 30 AND PROCEEDING ALONG THE EAST AND WEST 1/4 LINE OF SAID SECTION 30 S. 85°45'03" W. 942.80 FEET AND S. 32°42'01" E. 26.68 FEET AND S. 65°18'11" W. 258.97 FEET AND S. 24°35'28" E. 35.10 FEET TO A POINT ON THE NORTHERLY RIGHT-OF-WAY LINE OF ADAMS ROAD (VARIABLE WIDTH); THENCE THE FOLLOWING FOUR (4) COURSES ALONG SAID NORTHERLY RIGHT-OF-WAY LINE: 1) S. 63°06'17" W. 1519.71 FEET, 2) 420.15 FEET ALONG THE ARC OF A CURVE TO THE RIGHT, RADIUS 1325.00 FEET, CENTRAL ANGLE 18°10'05" AND A CHORD THAT BEARS S. 72°11'19" W. 418.39 FEET, 3) S. 08°43'39" E. 15.00 FEET, 4) 19.46 FEET ALONG THE ARC OF A CURVE TO THE RIGHT, RADIUS 1340.00 FEET, CENTRAL ANGLE 00°49'55", AND A CHORD THAT BEARS S. 81°41'19" W. 19.46 FEET TO THE POINT OF BEGINNING; THENCE CONTINUING ALONG SAID NORTHERLY RIGHT—OF—WAY LINE 340.95 FEET ALONG THE ARC OF A CURVE TO THE RIGHT, RADIUS 1340.00 FEET, CENTRAL ANGLE 14°34'43", AND A CHORD THAT BEARS S. 89°23'38" W. 340.03 FEET: THENCE N. 37°11'39" W. 27.94 FEET; THENCE N. 08°30'03" E. 154.41 FEET; THENCE S. 82°12'07" E. 354.24 FEET; THENCE S. 07°47'53" W. 124.46 FEET TO THE POINT OF BEGINNING AND CONTAINING 1.28 ACRES OF LAND

QUANTITIES SHOWN ABOVE ARE FOR PERMIT PURPOSES ONLY. THE CONTRACTOR IS SOLELY RESPONSIBLE FOR DETERMINING THE ACTUAL SCOPE OF WORK IN ACCORDANCE WITH THESE CONTRACT

WATERMAIN QUANTITIES: 2" DOMESTIC WATER SERVICE

REMOVE EXISTING BULKHEAD

5" PVC SDR 23.5 LEAD

SANITARY SEWER QUANTITIES:

2" SHUT-OFF


' INLET

CLEAN OUT

DOCUMENTS.

12" C76 CL IV

6" UNDERDRAIN

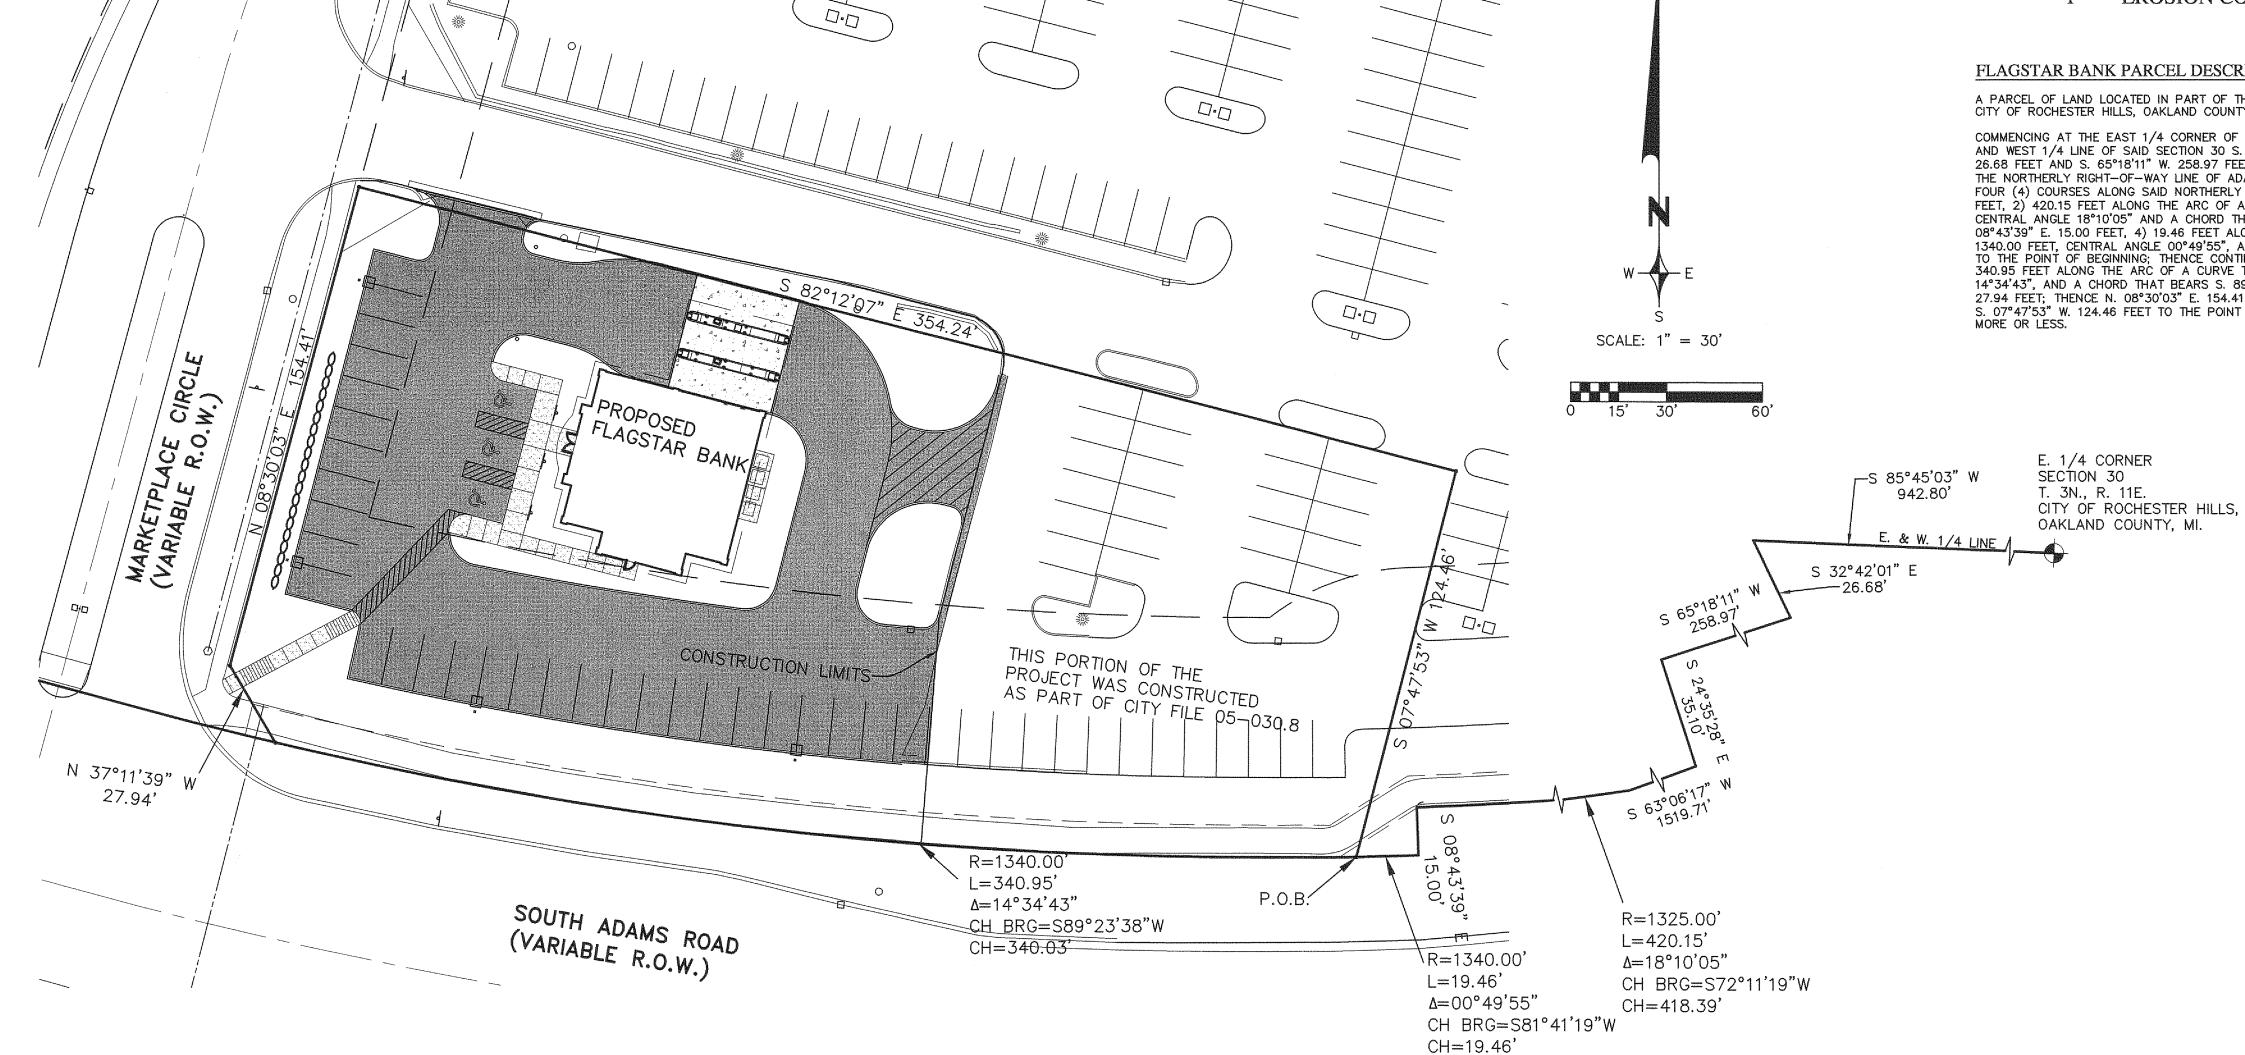

SHAWNI R. SLASSIN EMENTERN 47337

1 EA

3 EA

161 LF


230 LF

3 EA

1 EA

NOT FOR CONSTRUCTION CITY FILE 05-030.9

REVISIONS PER CITY REVIEW	DATE BY 5/10/13 SRB	REVISIONS	DATE BY	REVISIONS	DATE BY	REVISIONS	DATE BY	ZEIMET W EZNIAK Civil Engineers & Land Surveyors 40024 GRAND RIVER AVE, SUITE 100 NOVI, MICHIGAN 48375 P: (248) 442-1101 F: (248) 442-1241 www.zeimetwozniak.com	MISS DIGSYSTEM, INC, 1-800-482-7171 THREE FULL WORKING DAYS BEFORE YOU DIG, CALL THE MISS DIG SYSTEM	CLIENT: MICHAEL BOGGIO 30100 TELEGRAPH RD., SUITE 216 BINGHAM FARMS, MI 48025 248.258.5155	COVER SHEET FLAGSTAR BANK ROCHESTER HILLS, MICHIGAN, SECTION 30	$ \begin{array}{c ccccccccccccccccccccccccccccccccccc$
								r: (240) 442-1101 r. (240) 442-1241 www.temtetwozmax.com				Ju Srb

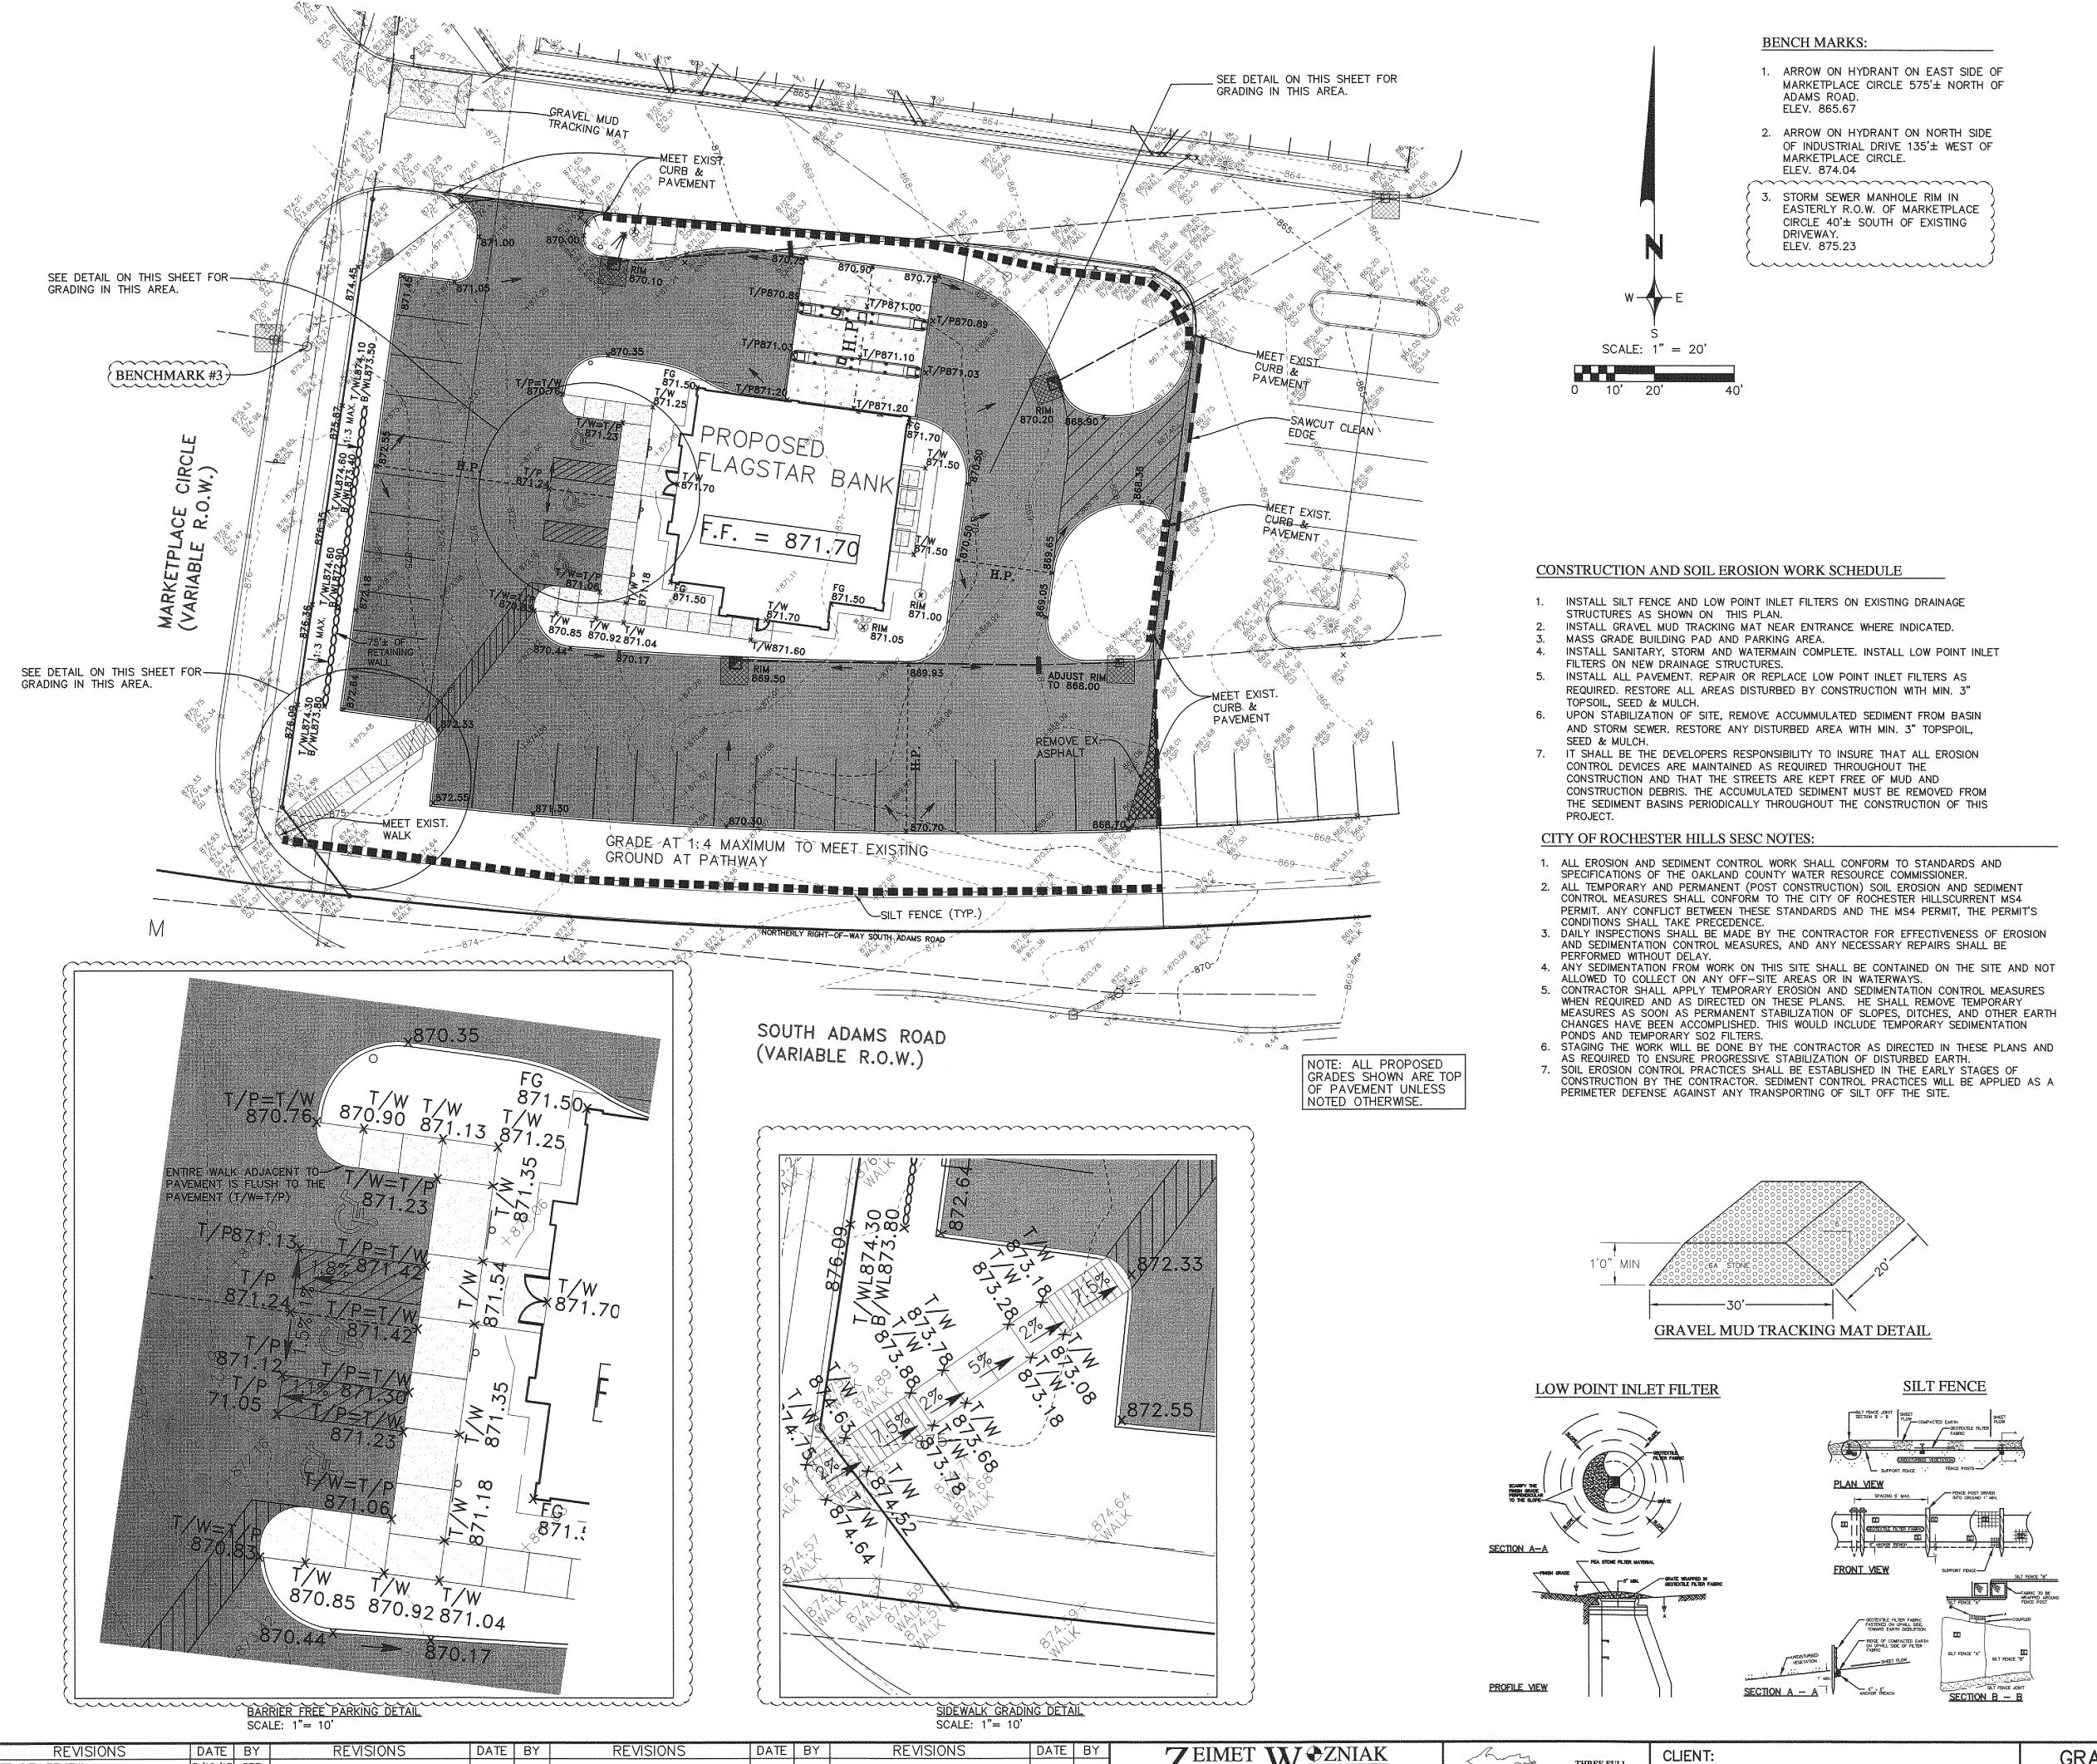

GRADING LEGEND:

EROSION CONTROL LEGEND: GEOTEXTILE SILT FENCE

T/C = TOP OF CURBT/W = TOP OF WALK T/P = TOP OF PAVEMENT T/B = TOP OF BANKG = GROUNDD = DITCH

F.F. = FINISH FLOOR

BL = BRICK LEDGE


BF = BASEMENT FLOOR

GU = GUTTERF.G. = FINISH GRADE GRAVEL MUD TRACKING MAT

LOW POINT INLET FILTER

THIS PLAN ILLUSTRATES THE MINIMUM EROSION CONTROLS NEEDED TO PREVENT SILTS FROM LEAVING THE SITE AND IS SUBJECT TO CHANGE AS CONDITIONS IN THE FIELD WARRANT.

LEGEND

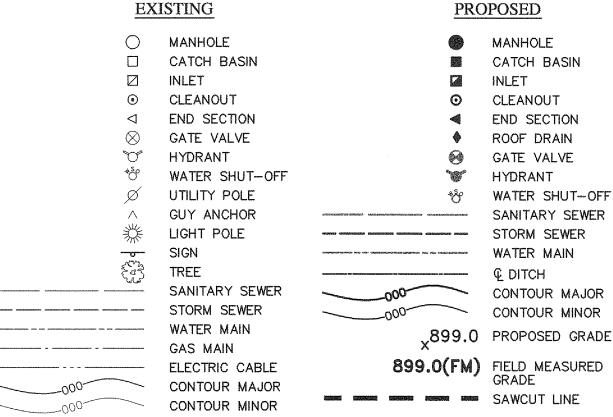

 EXISTING TOPOGRAPHY SHOWN AS SURVEYED BY ZWA 3-27-13. 2. RESTORE ALL DISTURBED AREAS DUE TO GRADING WITH MIN. 3" TOPSOIL, SEED & MULCH.


+100.00 **SPOT ELEVATION**

- 3. PEAT, OR ANY OTHER UNSUITABLE MATERIALS ENCOUNTERED IN CONSTRUCTION AREAS SHALL BE REMOVED AND BACKFILLED WITH COMPACTED SUITABLE MATERIAL (95% DENSITY). ALL ON-SITE WORK SHALL CONFORM, AT A MINIMUM, TO THE CURRENT STANDARDS AND SPECIFICATIONS OF THE CITY OF ROCHESTER HILLS.
- 4. ALL WORK WITHIN THE CONSTRUCTION LIMITS SHALL CONFORM TO THE CURRENT STANDARDS AND SPECIFICATIONS OF THE CITY OF ROCHESTER

THE LOCATIONS OF EXISTING UNDERGROUND UTILITIES ARE SHOWN IN AN APPROXIMATE WAY ONLY AS DISCLOSED BY AVAILABLE UTILITY COMPANY RECORDS AND HAVE NOT BEEN INDEPENDENTLY VERIFIED BY THE COMPANY. NO GUARANTEE IS EITHER EXPRESSED OR IMPLIED AS TO THE COMPLETENESS OR ACCURACY THEREOF. THE CONTRACTOR SHALL DETERMINE THE EXACT LOCATION OF ALL EXISTING UTILITIES BEFORE COMMENCING WORK. AND AGREES TO B FULLY RESPONSIBLE FOR ANY AND ALL DAMAGES WHICH MIGHT BE OCCASIONED BY THE CONTRACTOR'S FAILURE TO EXACTLY LOCATE AND PRESERVE ANY AND ALL UNDERGROUND UTILITIES. THE CONTRACTOR SHALL NOTIFY THE DESIGN ENGINEER IMMEDIATELY IF A CONFLICT IS APPARENT.

NOTICE:

CONSTRUCTION SITE SAFETY IS THE SOLE RESPONSIBILITY OF THE CONTRACTOR. NEITHER THE OWNER NOR THE ENGINEER SHALL BE EXPECTED TO ASSUME ANY RESPONSIBILITY FOR SAFETY OF THE WORK, OF PERSONS ENGAGED IN THE WORK, OF ANY NEARBY STRUCTURES, OR OF ANY OTHER PERSONS.

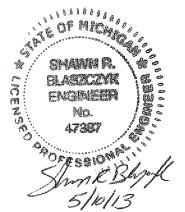

NOTE: THE SOIL EROSION CONTROL FOR THIS PLAN IS APPROVED UNDER PERMIT RHC/2005-1571/30/CO AS AMENDED ON MAY 8, 2007 BY THE OCDC.

NOT FOR CONSTRUCTION CITY FILE 05-030.9

GRADING & EROSION CONTROL PLAN FLAGSTAR BANK

ROCHESTER HILLS, MICHIGAN, SECTION 30

THREE FULL

WORKING DAYS

BEFORE YOU DIG,

DIG SYSTEM

MISS DIG SYSTEM, INC. CALL THE MISS

1-800-482-7171

MICHAEL BOGGIO

30100 TELEGRAPH RD., SUITE 216

248.258.5155

BINGHAM FARMS, MI 48025

& ASSOCIATES

Civil Engineers & Land Surveyors

NOVI. MICHIGAN 48375

P: (248) 442-1101 F: (248) 442-1241 www.zeimetwozniak.com

40024 GRAND RIVER AVE, SUITE 100

DATE 4/1/13 SCALE HOR: 1" = 20' VER: 1" = N/A DESIGNED BY JOB NO. 13122 SRB DRAWN BY SHEET CE-2


PER CITY REVIEW

5/10/13 SRB

CURRENT STANDARDS AND SPECIFICATIONS OF THE CITY OF ROCHESTER

THE LOCATIONS OF EXISTING UNDERGROUND UTILITIES ARE SHOWN IN AN APPROXIMATE WAY ONLY AS DISCLOSED BY AVAILABLE UTILITY COMPANY RECORDS AND HAVE NOT BEEN INDEPENDENTLY VERIFIED BY THE COMPANY. NO GUARANTEE IS EITHER EXPRESSED OR IMPLIED AS TO THE COMPLETENESS OR ACCURACY THEREOF. THE CONTRACTOR SHALL DETERMINE THE EXACT LOCATION OF ALL EXISTING UTILITIES BEFORE COMMENCING WORK, AND AGREES TO BE FULLY RESPONSIBLE FOR ANY AND ALL DAMAGES WHICH MIGHT BE OCCASIONED BY THE CONTRACTOR'S FAILURE TO EXACTLY LOCATE AND PRESERVE ANY AND ALL UNDERGROUND UTILITIES. THE CONTRACTOR SHALL NOTIFY THE DESIGN ENGINEER IMMEDIATELY IF A CONFLICT IS APPARENT.

CONSTRUCTION SITE SAFETY IS THE SOLE RESPONSIBILITY OF THE CONTRACTOR. NEITHER THE OWNER NOR THE ENGINEER SHALL BE EXPECTED TO ASSUME ANY RESPONSIBILITY FOR SAFETY OF THE WORK, OF PERSONS ENGAGED IN THE WORK, OF ANY NEARBY STRUCTURES, OR OF ANY OTHER PERSONS.

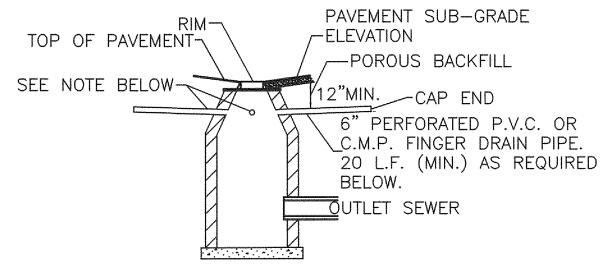

1.) WHERE INTAKE STRUCTURE IS LOCATED AT CURB LINE, PROVIDE TWO 20' LENGTHS @ 180' AND PARALLEL TO

2.) WHERE INTAKE STRUCTURE IS WITHIN PAVED AREA,

PROVIDE (4) 20' LENGTHS @ 90' ADDITIONAL FINGER DRAIN MAY BE REQUIRED AS

DIRECTED BY THE SOILS ENGINEER IN THE FIELD.

TYPICAL FINGER DRAIN DETAIL NO SCALE

SANITARY SEWER BASIS OF DESIGN

BLDG. AREA (S.F.) BLDG. USE UNIT FACTOR UNITS Bank 0.40/1,000 s.f. 1.13

No. of people = 3.5ppu x 1.13 units = 3.96 people

Average daily flow = $\underline{100\text{gpcpd x } 3.96 \text{ people}} = 0.001\text{cfs}$ $(7.5 \times 24 \times 3600)$

Peak daily flow = $4 \times 0.001 = 0.004$ cfs An 8" sewer at 0.40% (minimum) has a capacity of 0.76cfs.

WATERMAIN BASIS OF DESIGN

Initial Service Connections = Total Service Connections = 3.96 (number of people) Initial Design Average Day Flow = 0 MGD Initial Maximum Day Flow = 0 MGD Total Design Average Day Flow = $(3.96 \times 120)/1,000,000 = 0.0005 \text{ MGD}$ Total Maximum Day Flow = $3 \times 0.0005 = 0.0015 \text{ MGD}$

	WATERMAIN STRUCTURES								
T	Northing	Easting	STRUCTURE						
Ī	4532.81	6683.10	W.S.O.						

	STORM STRUCTU	RES
Northing	Easting	STRUCTURE
4414.19	6731.62	INL 59A
4444.69	6620.66	INL 60
4344.32	6651.02	INL 64

_	SANITARY STRUCTURES									
	Northing	Easting	STRUCTURE							
	4360.73	6697.51	C.O.							

LEGEND

PROPOSED MANHOLE CATCH BASIN INLET CLEANOUT END SECTION ROOF DRAIN GATE VALVE HYDRANT WATER SHUT-OFF ----- SANITARY SEWER STORM SEWER

SANITARY SEWER ---- STORM SEWER ----- WATER MAIN GAS MAIN ELECTRIC CABLE CONTOUR MAJOR CONTOUR MINOR

+100.00 SPOT ELEVATION

SIGN

TREE

EXISTING

MANHOLE

INLET

O

禁

~~o~

CATCH BASIN

CLEANOUT

END SECTION

GATE VALVE

UTILITY POLE

GUY ANCHOR

WATER SHUT-OFF

HYDRANT

LIGHT POLE WATER MAIN € DITCH CONTOUR MAJOR CONTOUR MINOR ,899.0 PROPOSED GRADE

SANITARY SEWER NOTES:

- 1. ALL CONSTRUCTION SHALL CONFORM TO THE CURRENT STANDARDS AND SPECIFICATIONS OF THE AGENCY HAVING JURISDICTION OVER THAT WORK. 2. ALL SANITARY SEWER BUILDING LEADS WILL BE SOLID WALL PVC SDR 23.5
- 3. SANITARY SEWER DROP CONNECTIONS MUST BE EXTERNAL TYPE.
- 4. THE MINIMUM SLOPE FOR 6" SANITARY BUILDING LEADS IS 1.00%. 5. ALL PROPOSED SEWERS SHALL HAVE CHEMICALLY WELDED JOINTS.

WATERMAIN NOTES:

- 1. ALL CONSTRUCTION SHALL CONFORM TO THE CURRENT STANDARDS AND SPECIFICATIONS OF THE AGENCY HAVING JURISDICTION OVER THAT WORK. 2. ALL HYDRANTS, INCLUDING NOZZLES AND PROJECTIONS SHALL BE 3' MINIMUM FROM EDGE OF SIDEWALK, OR 6' MINIMUM FROM BACK OF CURB.
- 3. THE WATERMAIN WILL HAVE A MINIMUM OF 6 FEET OF COVER. 4. THE CONTRACTOR SHALL DETERMINE DEGREE OF BEND FOR THE WATERMAIN FITTINGS. PIPE DEFLECTIONS SHALL NOT EXCEED 75% OF THE MANUFACTURER'S
- MAXIMUM ALLOWABLE DEFLECTION. 5. WATERMAIN SHALL BE CEMENT-LINED (DOUBLE THICKNESS), DUCTILE IRON PIPE,
- 6. A VERTICAL SEPARATION OF 18 INCHES MUST BE MAINTAINED BETWEEN THE WATERMAIN AND SANITARY SEWERS, STORM SEWERS, OR OTHER PROPOSED UTILITIES.
- 7. ALL GATE VALVES SHALL BE RESILIENT WEDGE OR SEATED TYPE GATE VALVES (E.J.I.W. OR U.S. PIPE). 8. PER THE SOIL BORINGS, ALL WATERMAIN SHALL REQUIRE POLYWRAP ((8 MILS)
- 9. RESTRAINED RODDED JOINTS SHALL BE USED AT ALL VERTICAL BENDS. THE NUMBER OF RESTRAINED RODDED JOINTS REQUIRED SHALL BE DETERMINED BY THE MANUFACTURER, SUBJECT TO APPROVAL BY THE CITY ENGINEER. 10. USE HYDRANT CONNECTION DETAIL 'A' (STANDARD DETAIL SHEET A).

11. NO FDC IS PROPOSED.

- 1. PROPOSED STRUCTURE COVERS/GRATES SHALL BE PROVIDED AS REQUIRED ON
- THE CITY OF ROCHESTER HILLS' STANDARD DETAIL SHEETS. 2. FINGER DRAINS TO BE 20' IN EACH DIRECTION AT 90° ANGLES FROM INLET
- STRUCTURES LOCATED IN PAVED AREAS. 3. STRUCTURAL CALCULATIONS AND SHOP DRAWINGS, SIGNED AND SEALED BY A PROFESSIONAL ENGINEER (REGISTERED IN THE STATE OF MICHIGAN) SHALL BE SUBMITTED TO THE CITY FOR REVIEW PRIOR TO CONSTRUCTION OF ALL STORM
- SEWER STRUCTURES GREATER THAT 6 FEET IN DIAMETER. 4. PROPOSED ROOF DRAINS SHALL BE SCHEDULE 40 PVC PIPE WITH CHEMICALLY WELDED JOINTS.
- 5. PROPOSED STORM SEWER PIPE SHALL BE REINFORCED CONCRETE CLASS IV WITH RUBBER GASKETS AND CLASS B BEDDING.

GENERAL NOTES:

" OF MICH

CM PONE

No.


47887

- 1. M.D.O.T. CLASS II BACKFILL TO BE COMPACTED IN 6" LAYERS TO 95% OF
- MAXIMUM UNIT WEIGHT. 2. ABOVE REQUIRED UNDER OR WITHIN A 1 ON 1 SLOPE OF EXISTING OR
- PROPOSED PAVEMENT. 3. ALL CONTRACTORS SHALL NAME ZEIMET-WOZNIAK & ASSOCIATES AS

ADDITIONALLY INSURED ON ALL INSURANCE POLICIES.

NOT FOR CONSTRUCTION CITY FILE 05-090.3

REVISIONS DATE BY REVISIONS DATE | BY REVISIONS DATE | BY Wassociates DATE 4/1/13 SCALE HOR: 1" = 20' VER: 1" = N/A REVISIONS DATE | BY UTILITY PLAN THREE FULL 5/10/13 SRB PER CITY REVIEW MICHAEL BOGGIO WORKING DAYS DESIGNED BY FLAGSTAR BANK JOB NO. 13122 Civil Engineers & Land Surveyors BEFORE YOU DIG, MISS DIG SYSTEM, INC. CALL THE MISS SRB 30100 TELEGRAPH RD., SUITE 216 40024 GRAND RIVER AVE, SUITE 100 DIG SYSTEM NOVI. MICHIGAN 48375 1-800-482-7171 BINGHAM FARMS, MI 48025 ROCHESTER HILLS, MICHIGAN, SECTION 30 DRAWN BY SHEET CE-3 248.258.5155 P: (248) 442-1101 F: (248) 442-1241 www.zeimetwozniak.com SRB

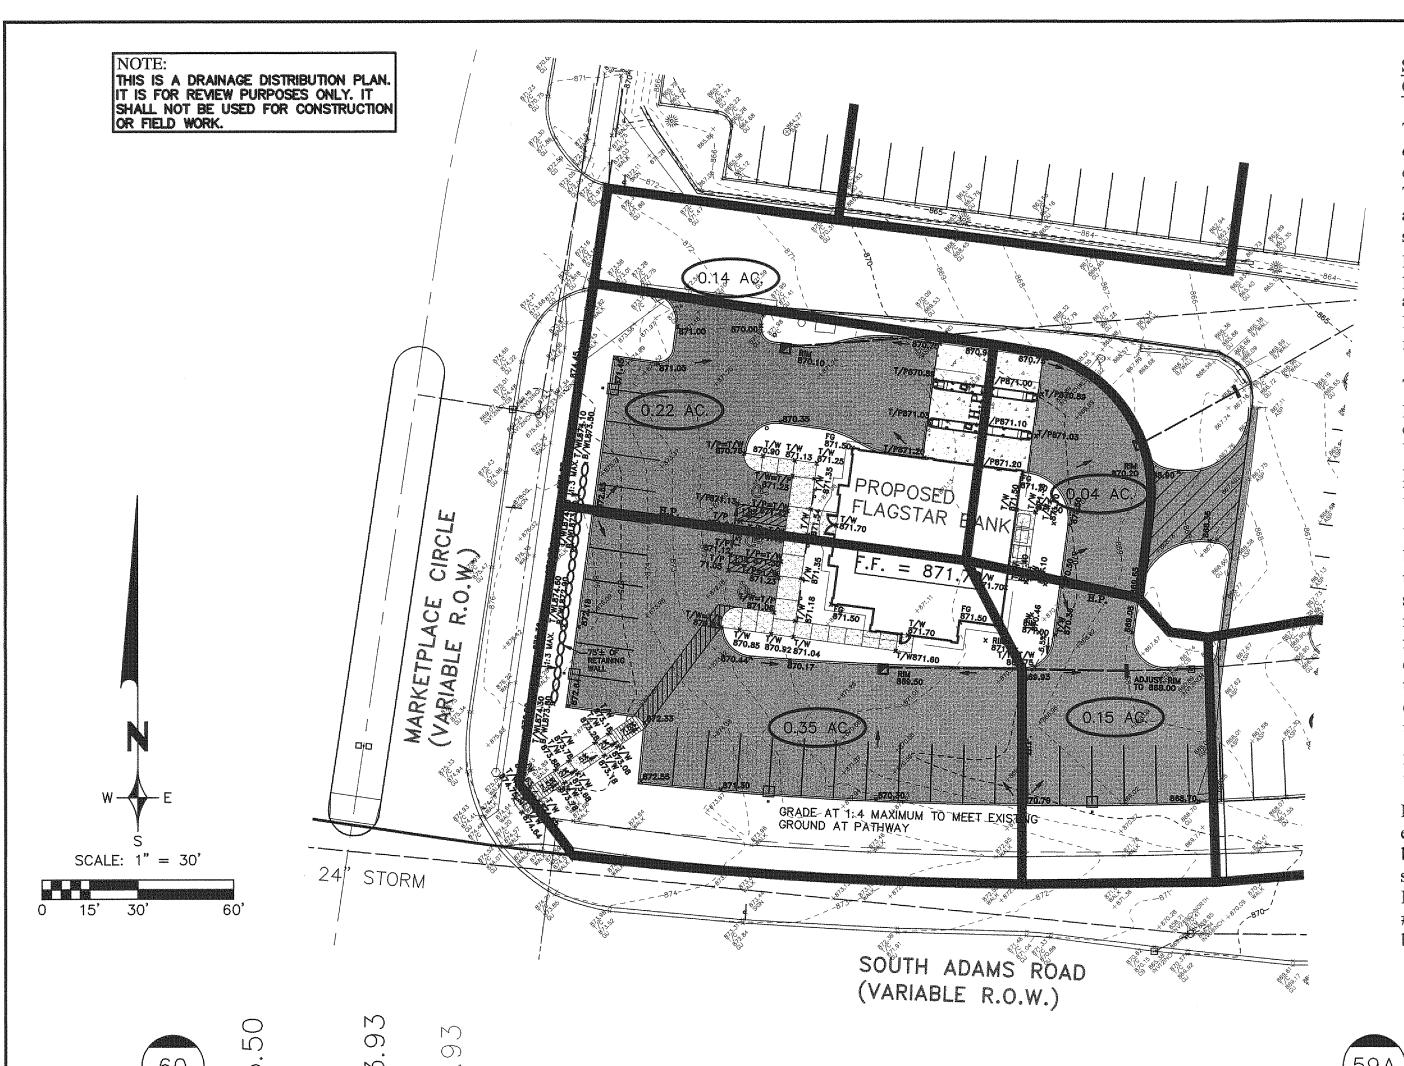

DATE BY 5/10/13 SRB

REVISIONS

PER CITY REVIEW

REVISIONS

DATE BY

REVISIONS

STORM WATER MANAGEMENT SYSTEM OVERVIEW

The storm water management system for this project will consist of collection, pretreatment, detention, and discharge of treated storm water.

The storm water runoff from all roads, buildings and parking areas shall be collected using the proposed storm sewer system. The storm sewer shall collect the runoff at all low points in the road and parking areas and at intermediate points along both as necessary to prevent excessive flow to any one structure. The system is designed to handle a 10-year storm event with an initial time of concentration of 15

The storm sewer shall discharge into an approved pretreatment system which may include sedimentation basins or mechanical treatment chambers such as Storm Ceptor, Vortechnic's, Aquaswirl, or an approved equivalent. The pretreatment system shall treat all collected storm water for a 10-year event.

Upon the completion of pretreatment, the storm water shall be discharged into the existing 8.36 acre wetland located in the central portion of the site. The wetland is capable of storing more than a 100-year storm without any detrimental impact to adjacent properties. This allows us to provide further treatment of the storm water improving both its' quality and quantity. The large storage volume also reduces the chances of downstream flooding as well. A controlled outlet will be placed within the wetland to slowly discharge the treated storm water to the proposed storm sewer in Adams Road that ultimately discharges to the existing MDOT storm water system.

By discharging treated water to and storing within the existing wetland, the hydrologic condition of the wetland will be greatly improved. Note that the temporary sedimentation/detention basins are permitted under MDEQ Permit #05-63-0278-P. The MDEQ issued permit #06-63-0005-P on June 16, 2006 for the permanent sediment basins and wetland storage.

1"=2' V

ZEIMET W ZNIAK ASSOCIATES

Civil Engineers & Land Surveyors 40024 GRAND RIVER AVE, SUITE 100 NOVI, MICHIGAN 48375 P: (248) 442-1101 F: (248) 442-1241 www.zeimetwozniak.com

STORMWATER MANAGEMENT CALCULATIONS THIS SITE IS PART OF A MASTER PLAN THAT WAS BUILT PRIOR TO THE ADOPTION OF THE 2008 STORMWATER MANAGEMENT STANDARDS (SEE ZWA PLANS 97144 "PROPOSED RETAIL BUILDING 'A'", CITY FILE 05-030.5 FOR DETAILS OF THE EXISTING SEDIMENTATION BASIN AND WETLAND DETENTION AREA BEING UTILIZED FOR THIS

THE FOLLOWING CALCULATIONS ARE TO SIZE THE PROPOSED SEDIMENT BASIN FOR STORAGE AND TREATMENT OF THE FIRST FLUSH VOLUME FOR THE CONTRIBUTING AREA, WHICH INCLUDES THIS PROJECT.

CONTRIBUTING AREA = 15.2 ACRES (ULTIMATE)

PROJECT).

USING THE CURRENT OCDC STANDARDS FOR CALCULATING FIRST FLUSH VOLUME:

RUNOFF COEFFICIENT CALCULATION (OVERALL)

PAVEMENT: 63.04 AC. @ 0.95 = 59.89 BUILDING: 16.72 AC. @ 0.95 = 15.88 $3.40 \text{ AC.} \bigcirc 1.00 = 3.40$ LANDSCAPE: <u>34.01</u> AC. @ 0.25 = <u>8.50</u>

C = 87.67/117.17 = 0.75 USE <u>0.80</u>

 $Vff = 4320 \times A \times C = 4320 \times 15.2 \times 0.80$ = 52,531 CF REQUIRED

BINGHAM FARMS, MI 48025

VOLUME PROVIDED:

	ELEV.	AREA(SF)	AVG. AREA (SF)	DEPTH (FT)	VOL.(CF)
	849.5	20,194	19.590	0.5	9,795
	849	18,985	13,030	0.0	3,730
	848	16,650	17,818	1.0	17,818
	040	10,000	15,538	1.0	15,538
	847	14,425	17 766	1.0	17 766
	846	12,307	13,366	1.0	13,366
	0.45.7		12,000	0.3	<u> 3.600</u>
845.7		11,693			60,117 CF

AT ELEVATION 849.5 A STORAGE VOLUME OF 60,117 CF IS PROVIDED.

SIZE OUTLET:

(ULTIMATE CONDITIONS)

A = 15.2 ACRES QA = 0.20 x 15.2 = 3.04 CFS

AM = (V/HW) = 52,531/3.8 = 13,823.9A = 0.3988 (13,823.9) 3.8/172,800 = 0.0622

USE A 12" DIAMETER PIPE WITH 1.5' OF 3" PVC GROUTED INTO THE DOWNSTREAM INVERT OF THE PIPE ...

SIZE HOLES IN STANDPIPE:

HW = 3.8'

AM = (V/HW) = 52,531/3.8 = 13,823.9A = 0.3988 (13,823.9) 3.8/172,800 = 0.0622

A 1" HOLE HAS AN AREA = 0.0055 SF

NO. OF 1" HOLES = 0.0622/0.0055 = 11.3

USE 12-1" DIAMETER HOLES AT ELEV. 845.7


SIZE OVERFLOW WEIR (100-YR.)

 $Q = CLH^{3/2}$

C = 3.33, H = 0.5Q = Q100 = CIA = 0.80(6.87)(15.2) = 83.5 CFS

 $83.5 = 3.33L (0.5)^{(3/2)}$ L = 70.9 SAY 71'


			-				ZE	IMET\WOZN	IAK								the second		1	
I =	175/(T+25)	C=	0.90	T=	15	MIN.			SHEET	1	OF	1		M	larch 23, 20	07				
	10-year storm													M	larch 29, 20	13				
PROJECT:	Flagstar Bank				JOB NO.	97144	· de l'an Marian de la company de l'	COMMUNIT	Y:	Rocheste	r Hills	annya ata isa aga najaraga ata a gagan galapa ataga kacama	COUNTY:	Oakland	authority party property of the party of the party	Service participates and the control of the control	en africant con expression contract in contract	Sellility of the Committee of the Commit	orderes where the filter is a result of a constitution and the	endiner of the investment end to settlemen
	:	· · · · · · · · · · · · · · · · · · ·			·							***************************************		·			-			
FROM	ТО	INCRE-		EQUIV.	TOTAL	Т	I	Q=CIA	CAPAC-	DIAM.	LENGTH	SLOPE	SLOPE	VEL.	TIME	H.G.	GR. ELEV.		INV. ELEV.	
MH	MH	MENT	C	AREA	AREA	TIME	(IN	C.F.S.	ITYOF	OF	OF	OF	OF	FLOW	OF	ELEV.	UPPER	LOWER	UPPER	LOWER
INPUT		ACRES		100%	100%	(MIN.)	PER	FLOW	SEWER	PIPE	LINE	PIPE	HG	FULL	FLOW	UPPER	END	END	END	END
		(A)		ACRES	ACRES		HOUR)		(C.F.S.)	(IN.)	(FT.)	(%)	(%)	(FT./	(MIN.)	END				
				CA	SUM CA					and the second s	7,27,210,27			SEC.)						
60	59	0.21	0.90	0.19	0.19	15.00	4.38	0.83	6.6	12	194	3.40	3.40	8.4	0.4	66.30	70.10	63.47	65.50	58.90
		0.21	0.70	0.17	U.17	13.00	7.50	0.00	0.0	12	127	J. 10	3.10		1	59.70	1	00.17	03.30	36.20
64	63	0.36	0.90	0.32	0.32	15.00	4.38	1.42	5.3	12	96	2.20	2.20	6.7	0.2	65.52	69.50	68.00	64.72	62.61
																63.41				
59A	59	0.09	0.90	0.08	0.00	15.00	4.38	2.17	7.8	12	95	4.80	4.80	9.9	0.2	64.08	70.20	63.47	63.28	58.72
																59.52				

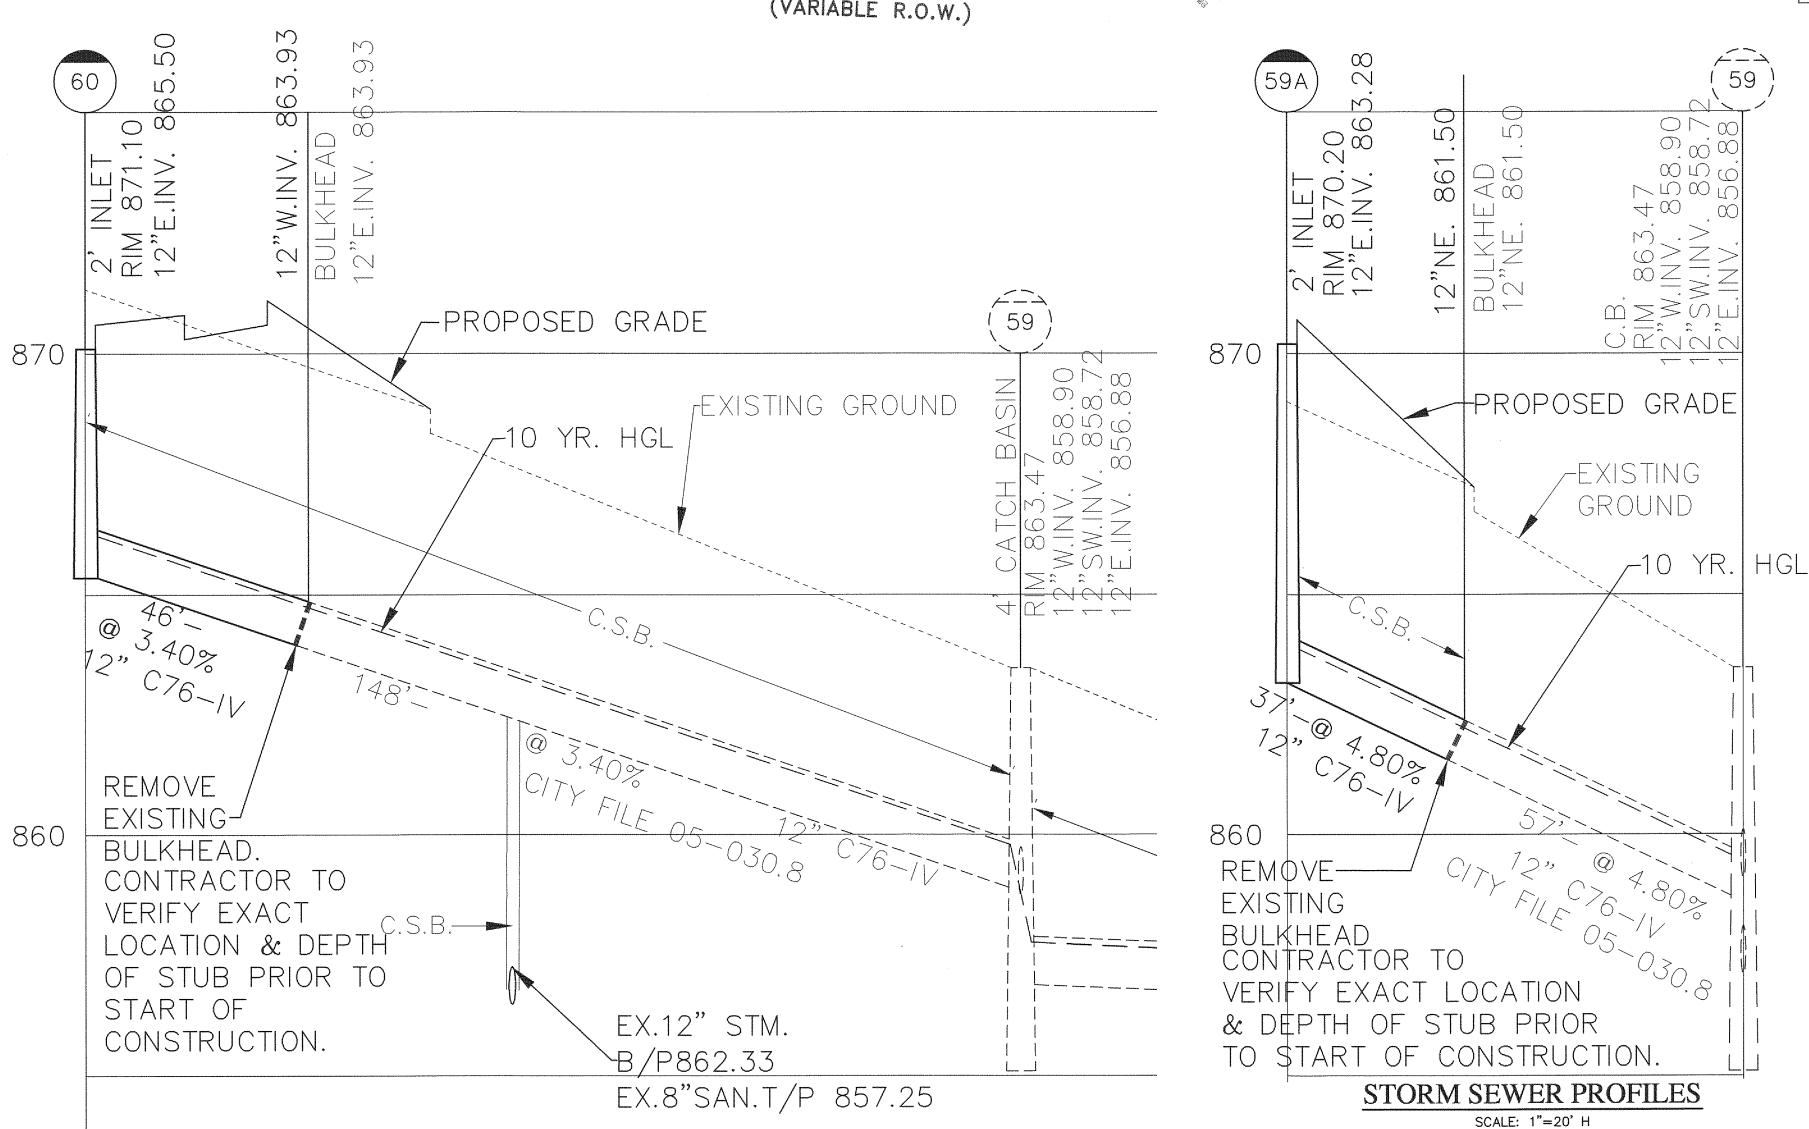



DATE BY

REVISIONS

DATE BY

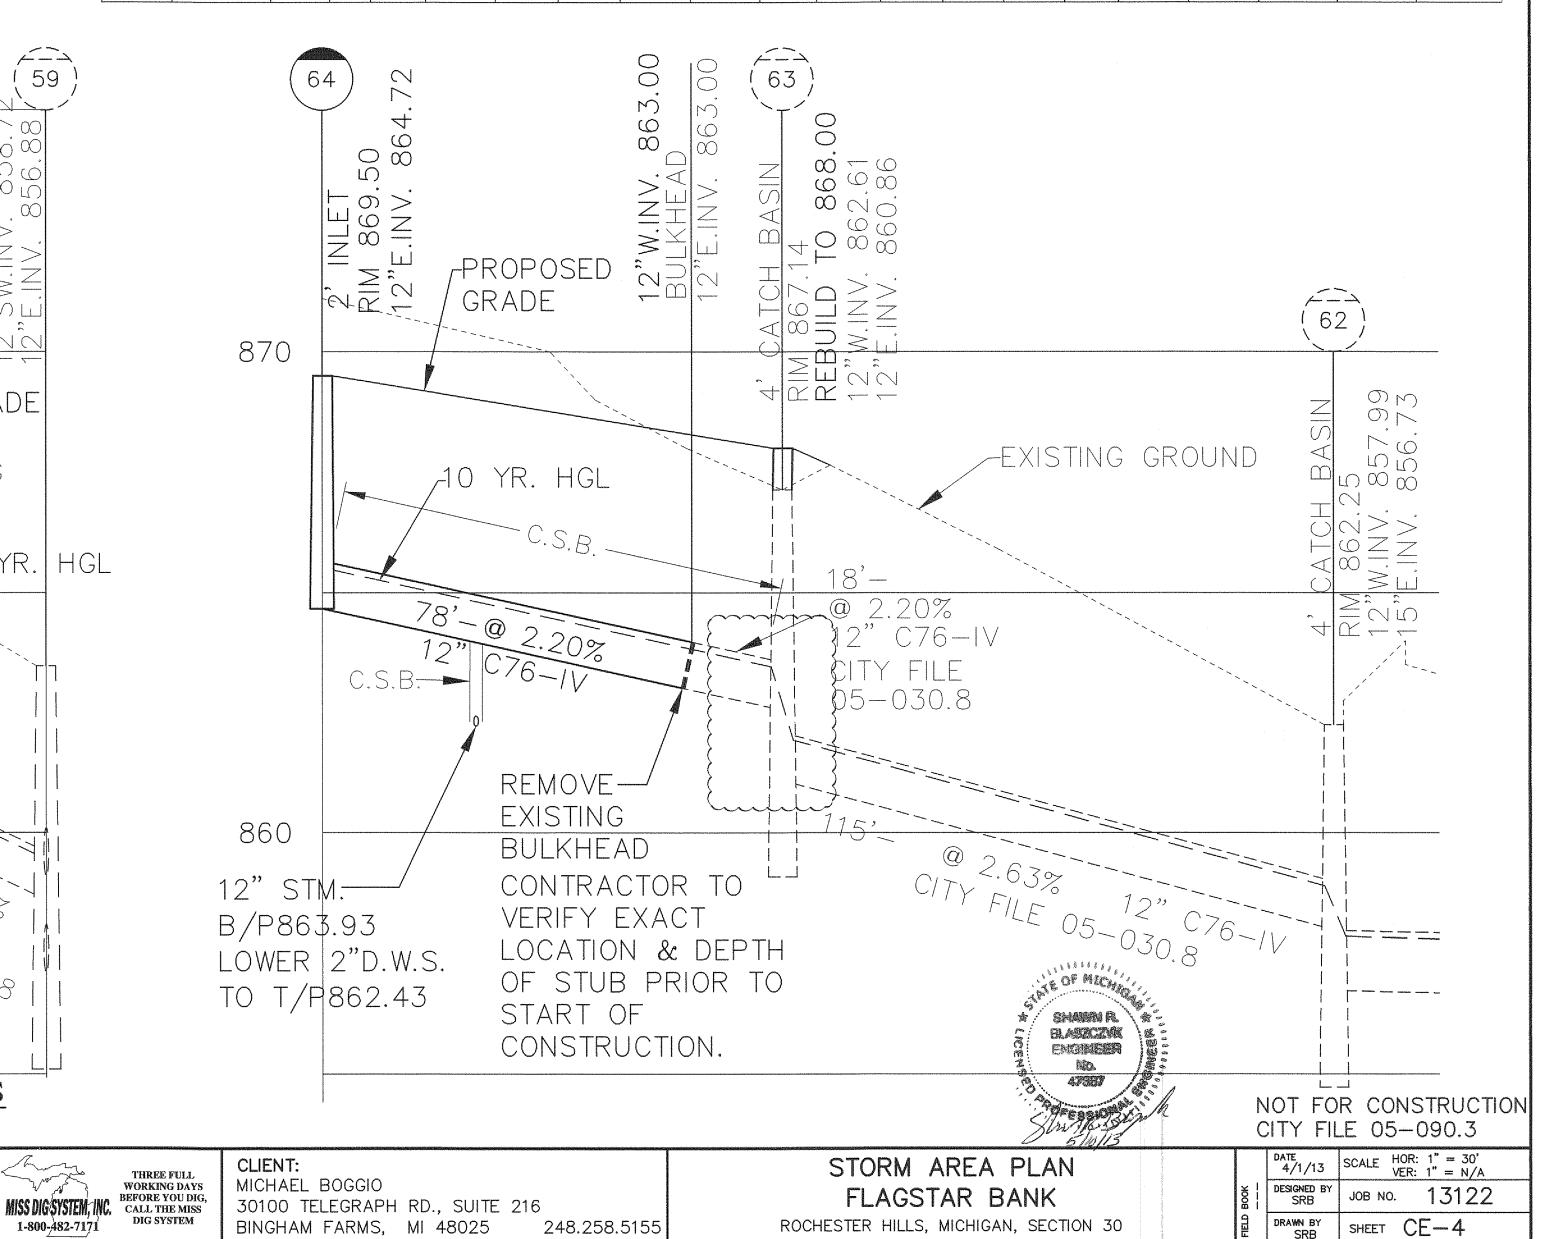

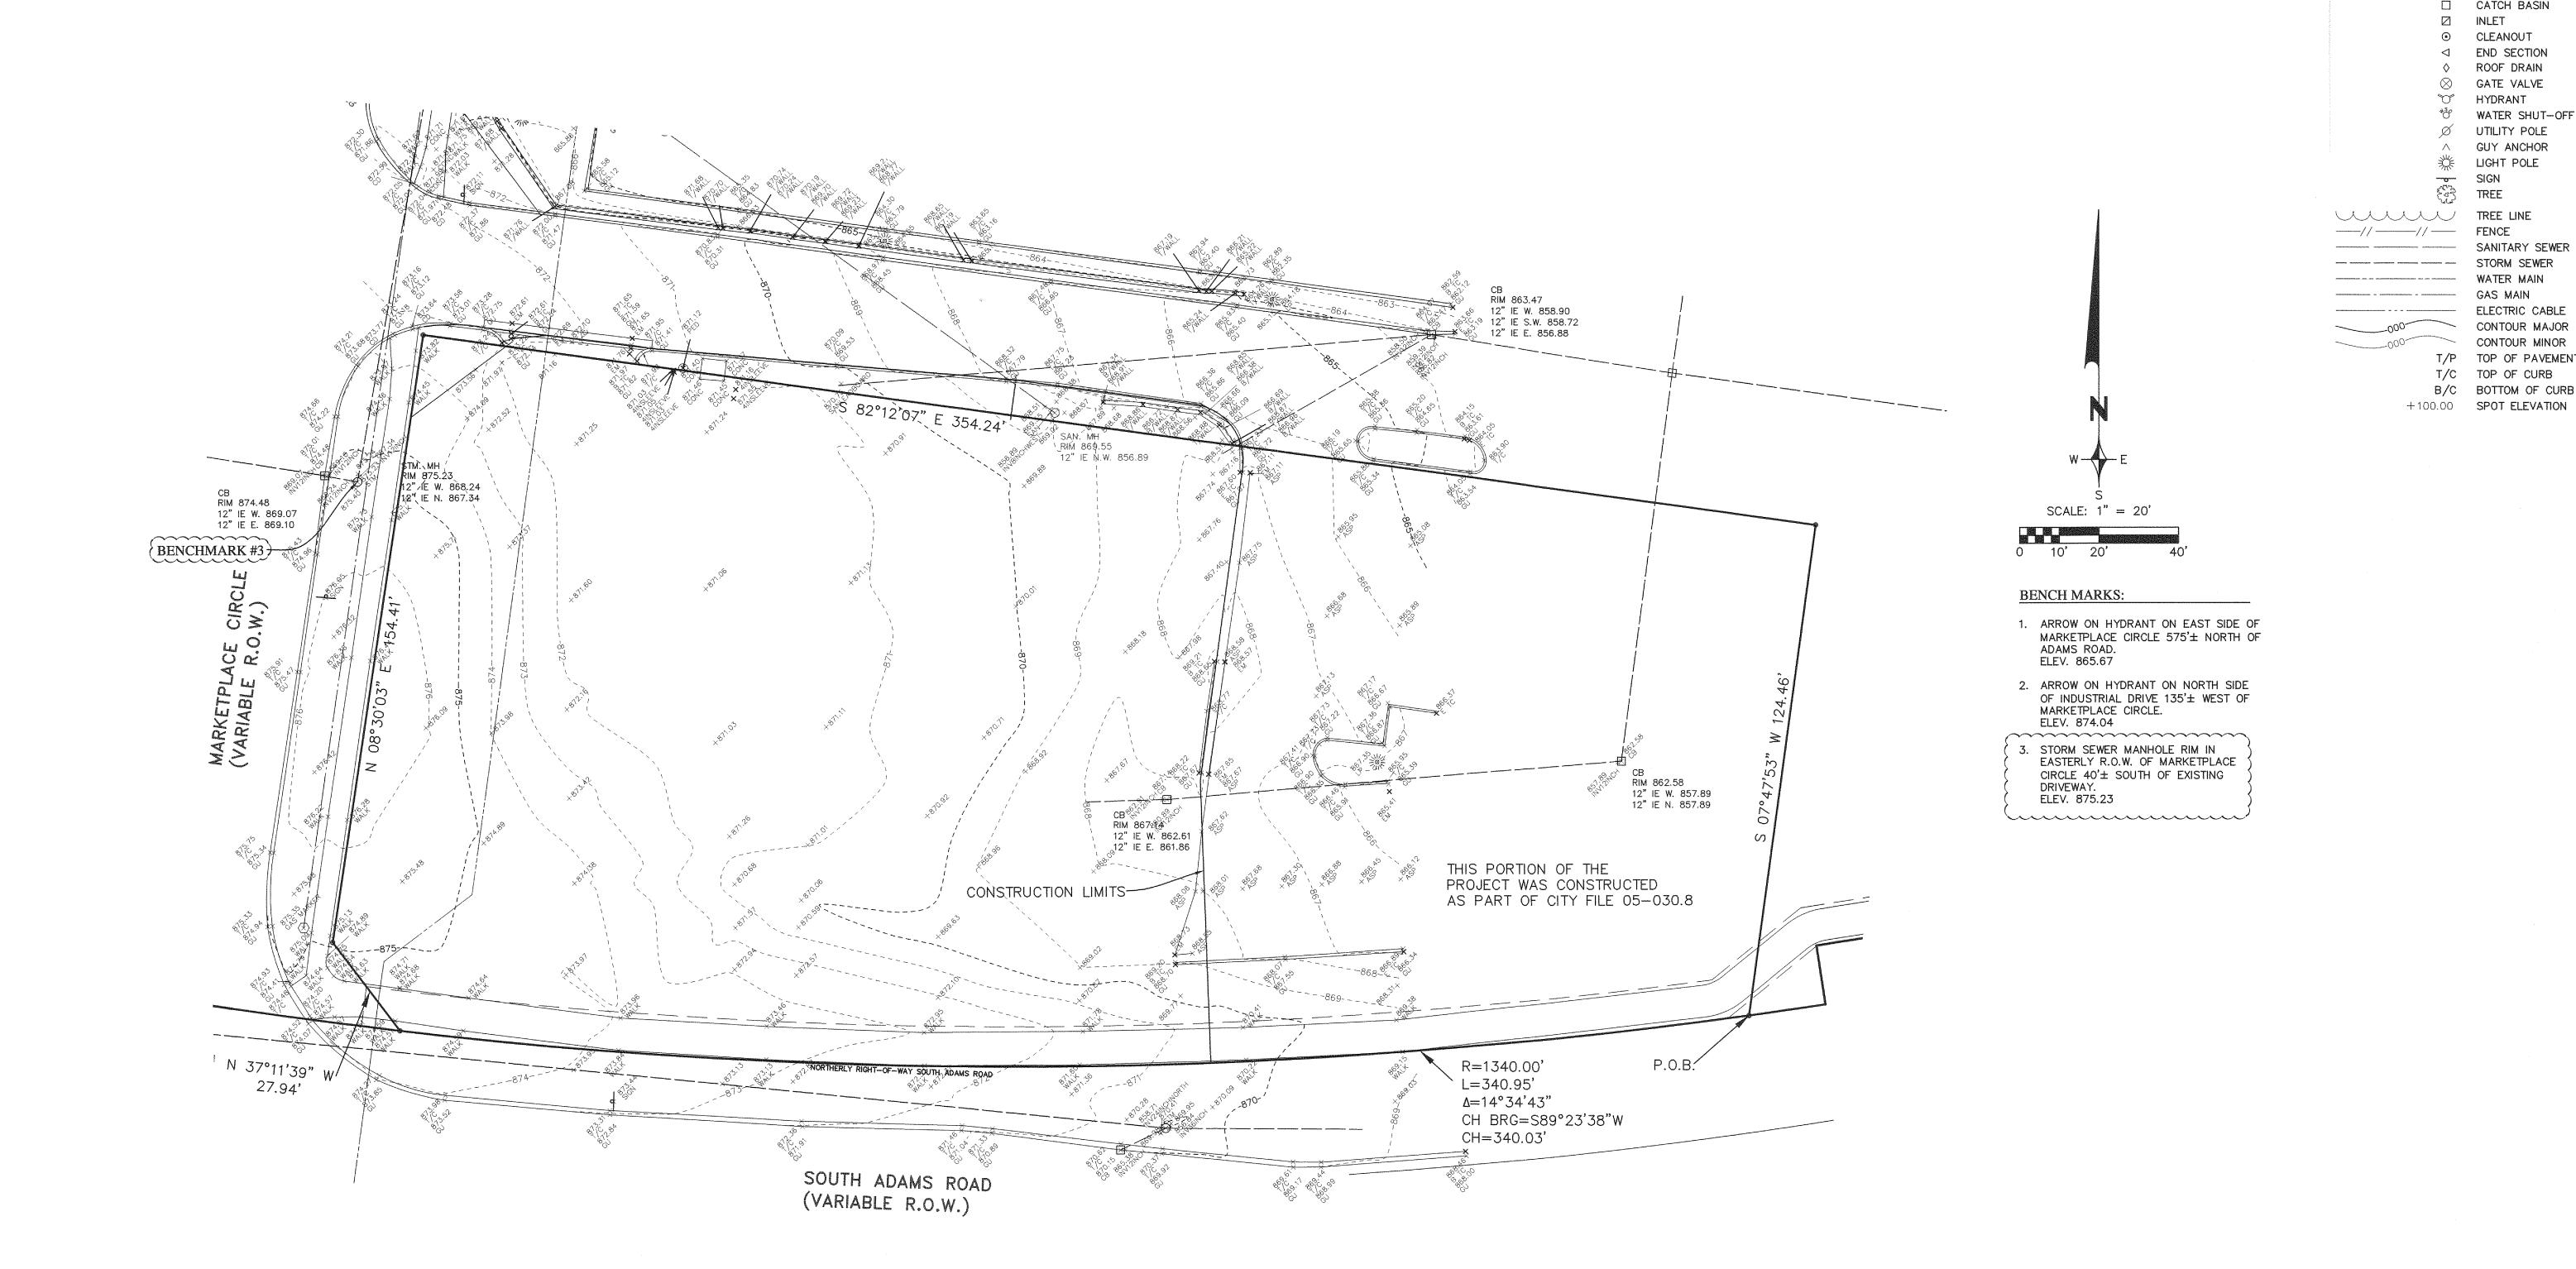

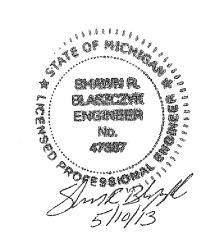

EXISTING LEGEND

MANHOLE ☐ CATCH BASIN

THYDRANT

Ø UTILITY POLE GUY ANCHOR

☆ LIGHT POLE

TREE

--- WATER MAIN

-o- SIGN

WATER SHUT-OFF

CONTOUR MAJOR CONTOUR MINOR T/P TOP OF PAVEMENT T/C TOP OF CURB B/C BOTTOM OF CURB


☑ INLET CLEANOUT ROOF DRAIN GATE VALVE

NOT FOR CONSTRUCTION CITY FILE 05-090.3

REVISIONS REVISIONS ZEIMET W& ZNIAK
ASSOCIATES REVISIONS DATE 4/1/13 SCALE HOR: 1" = 20' VER: 1" = N/A DATE BY DATE BY 5/10/13 SRB DATE BY DATE BY REVISIONS CLIENT: EXISTING CONDITIONS THREE FULL WORKING DAYS PER CITY REVIEW MICHAEL BOGGIO DESIGNED BY SRB JOB NO. 13122 MISS DIG SYSTEM, INC.

1-800-482-7171

WORKING DAYS
BEFORE YOU DIG,
CALL THE MISS
DIG SYSTEM FLAGSTAR BANK Civil Engineers & Land Surveyors
40024 GRAND RIVER AVE, SUITE 100
NOVI, MICHIGAN 48375
P: (248) 442-1101 F: (248) 442-1241 www.zeimetwozniak.com 30100 TELEGRAPH RD., SUITE 216 BINGHAM FARMS, MI 48025 248.258.5155 DRAWN BY SRB SHEET CE-5 ROCHESTER HILLS, MICHIGAN, SECTION 30

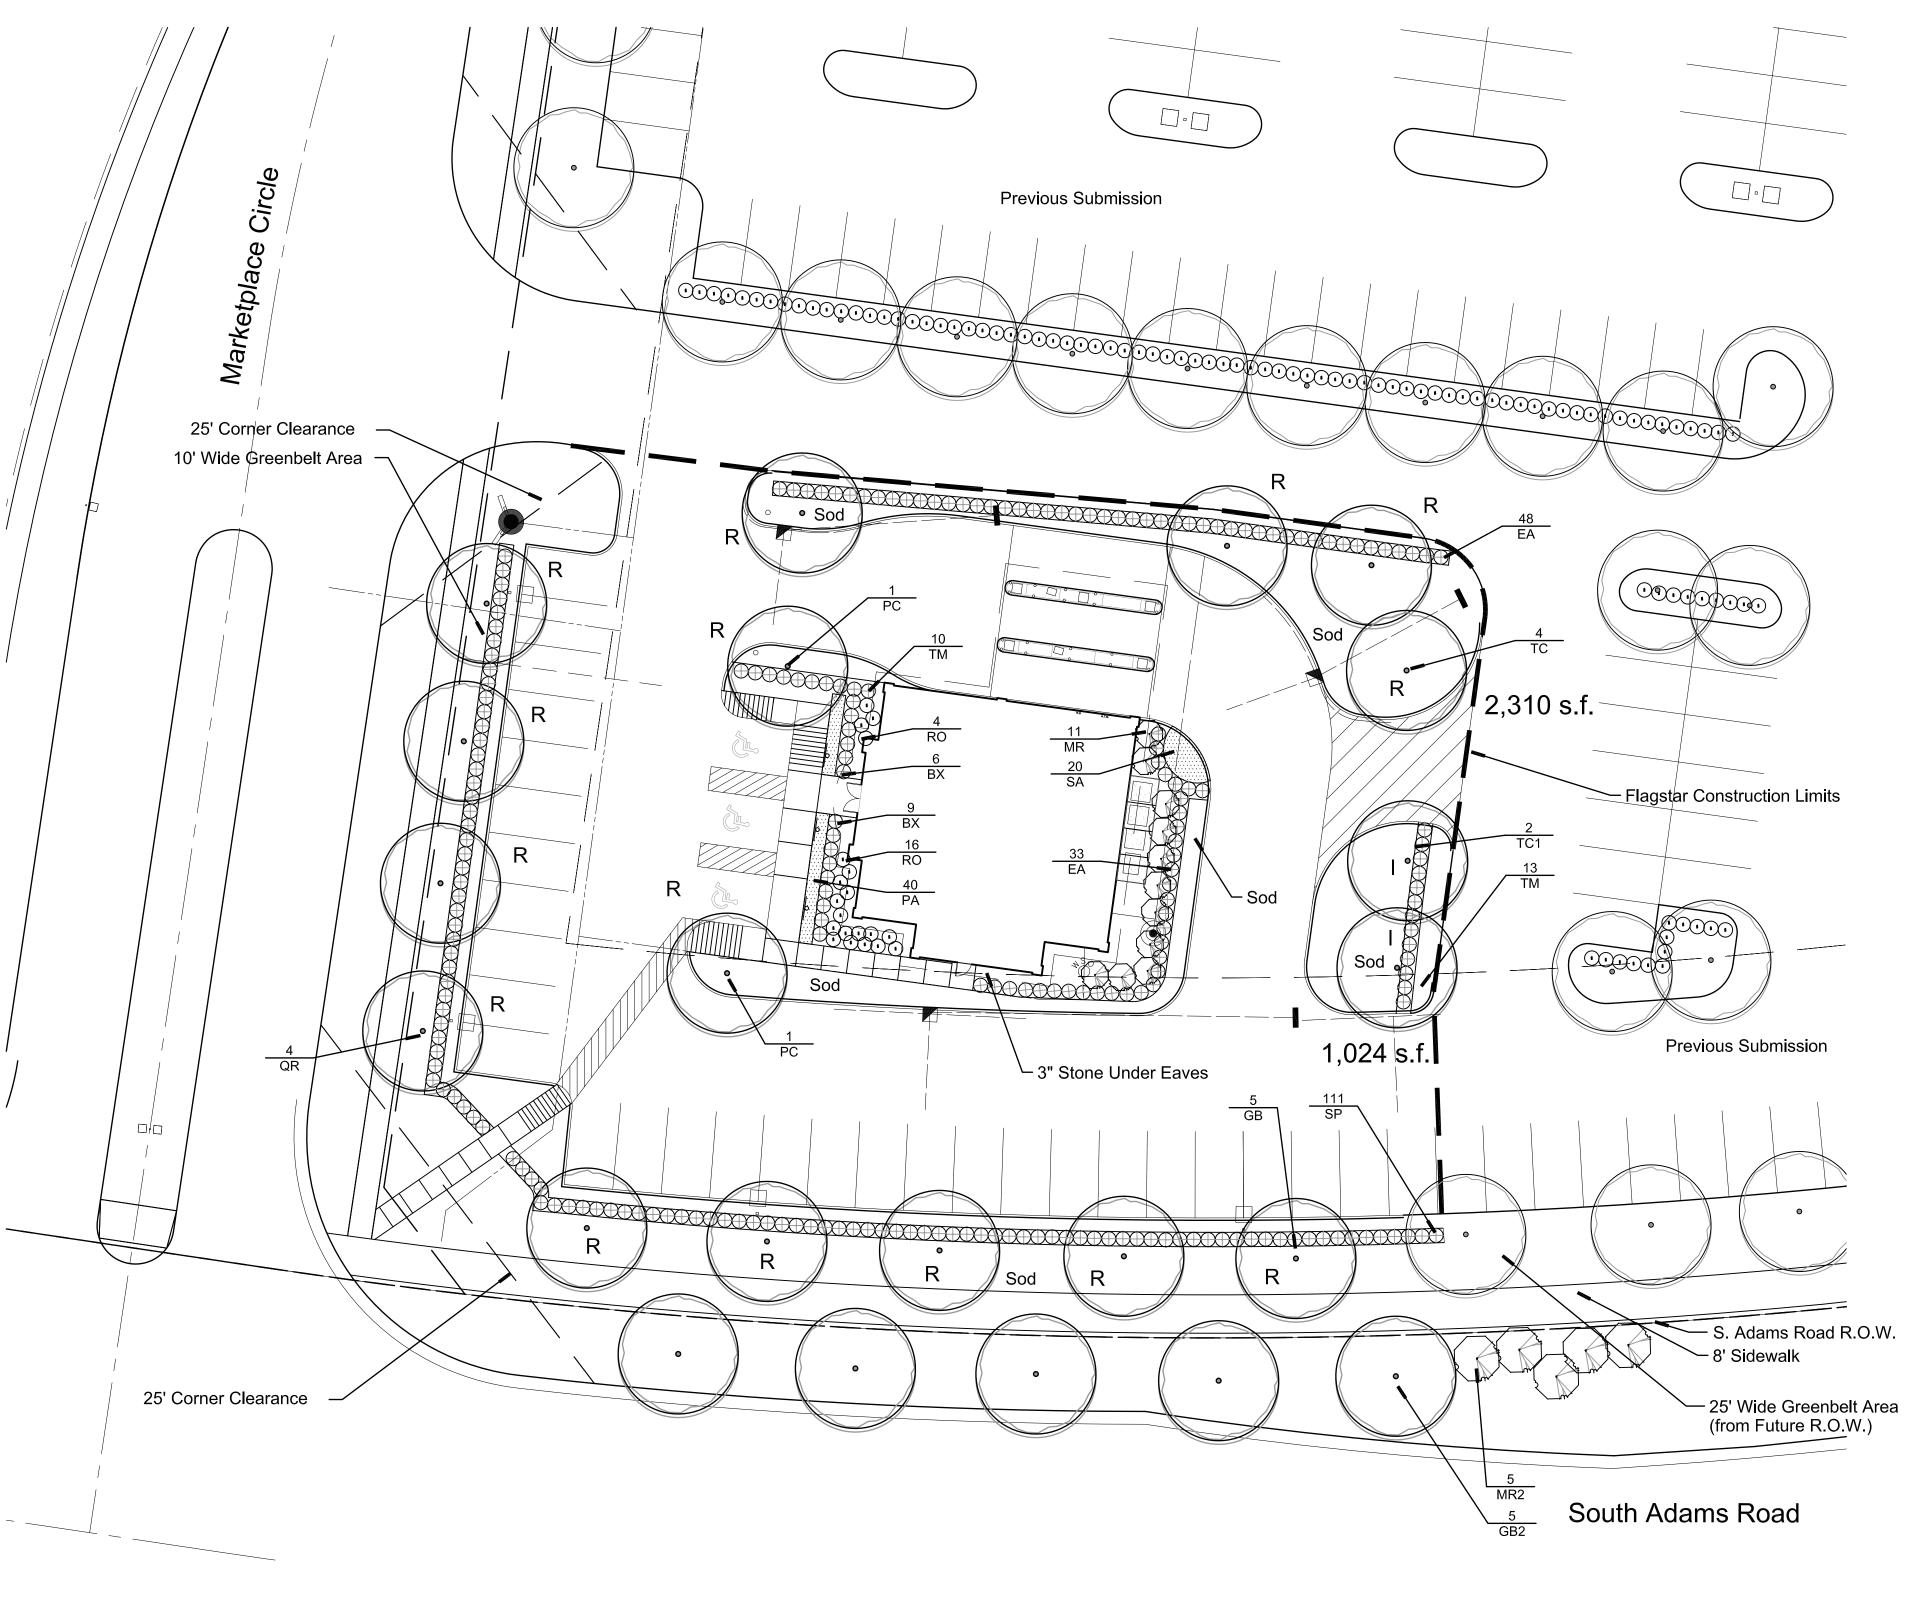

Landscape Summary

Parking Lot Landscaping Spaces Shown 33 Spaces Landscape Area Required 600 s.f. (150 s.f. per 10 Spaces) Landscape Area Shown 3,334 s.f.* Trees Required 2 Trees (1 Tree per 300 s.f.) Trees Shown 2 Trees

Right of Way Landscaping** Adams Road

Frontage 180 l.f. 5 Trees (1 per 35') Trees Required Trees Provided 5 Trees 5 Trees (1 per 35') Ornamental Trees Required Ornamental Trees Provided 5 Trees

Marketplace Drive Frontage

Trees Required 2 Trees (1 per 35')

Trees Provided 0 (Payment to Tree Fund) 2 Trees (1 per 35') Ornamental Trees Required 0 (Payment to Tree Fund) Ornamental Trees Provided

* As measured from the back of curb and Excluding Sidewalks.

** ROW Plantings will Require a RCOC Permit. If the Permit is Not Granted, the Value of Required Trees Shall be Placed in the City Tree Fund.

Environmental Statement

No natural features exist. This site has been recently mass graded.

Additional Notes:

1. All Landscaped Areas Shall be Irrigated with an Automatic, Underground System. 2. Islands Shall be Sod.

3. Owner Shall be Responsible for Replacing Damaged Plant Material Due to Utility Maintenance.

4. Prior to the release of the Performance Bond, the City of Rochester Hills Forestry Division must inspect all landscape plantings including but not limited to existing trees replacement trees, buffer plantings, and parking lot islands and the Forestry Division must inspect all right-of-ways to identify any plantings new or existing that pose a hazard to the safe use of the right-of-way. Forestry may require the developer to remove and possibly replace any such trees. 5. All trees and shrubs must be planted at least 10' from the edge of a public roadway

Shade trees and shrubs must be planted at least 5' from the edge of a public walkway. Evergreen and ornamental trees must be planted at least 10' from the edge of a public walkway. All trees and shrubs must be planted at least 10' from any fire hydrant. Shade and evergreen trees must be planted at least 15' from the nearest overhead wire and at least 10' from the nearest underground utility.

6. No tree or shrub may be planted within the triangular area formed at the intersection of

any street right-of-way at a distance of 25' from their point of intersection. No tree or shrub may be planted in the triangular area formed at the intersection of any driveway with a public sidewalk at a distance along each line of 15' from their point if intersection. 7. Prior approval is required to plant any tree or shrub in the public right-of-way. 8. No substitutions or changes of location or plant types shall be made without the approval of the developer and the City of Rochester Hills Landscape Architect.

City's Landscape Architect has Final Right of Approval for the the Release of the Performance and Maintenance Bonds. 9. The developer and/or the City of Rochester Hills Landscape Architect shall have the right, at any stage of the installation, to reject any work or material that does not meet the requirements of the plans or specifications.

10. Replacement trees may not be planted within the drip line of existing trees.

12. Trees may not be planted within 4' of any property line.

Utility Maintenance Statement: If, in the event, Utility Maintenance Results in the Removal of Landscaping, as Shown on this Plan,

it Will be the Owner's Responsibility to Repair and

Replace Shrubs and Trees that are Located within the Utility Easements.

Plant List

sym.	qty.	botanical name	common name	caliper	spacing	root	height	price		total
Parkin		sland Trees		7.22	-			*		
TC1	2	Tilia cordata 'Greenspire'	Greenspire Linden	3.0"	as shown	B&B		\$ 425.00	\$	850.00
							Sub Tota	l	\$	850.0
Right o									101	
GB2	5	Ginko biloba	Ginko	3.0"	as shown	B&B		\$ 425.00	\$	2,125.0
MR2	5	Malus sargentii	Sargent Crab	2.0"	as shown	B&B	0.1.	\$ 200.00	\$	1,000.0
Dielet e	£ \ \ /	Trans Daid into City Trans Frond					Sub Tota	l,	\$	3,125.0
Right o	or vvay	Trees Paid into City Tree Fund Deciduous Tree		3.0"				\$ 425.00	\$	850.0
	2	Ornamental Tree		2.0"				\$ 200.00	\$	400.0
		Offiairiefilai free		2.0			Sub Tota		\$	1,250.0
Replac	ement	Trees					Oub Tota		Ψ	1,200.0
GB	5	Ginko biloba	Ginko	3.0"	as shown	B&B		\$ 425.00	\$	2,125.0
PC	2	Pyrus calleryana 'Redspire'	Redspire Pear	3.0"	as shown	B&B		\$ 425.00	\$	850.0
QR	4	Quercus rubra	Red Oak	3.0"	as shown	B&B		\$ 425.00	\$	1,700.0
TC	4	Tilia cordata 'Greenspire'	Greenspire Linden	3.0"	as shown	B&B		\$ 425.00	\$	1,700.0
	15	trees, 30 credits					Sub Tota	I	\$	6,375.0
Genera	al Plant	tings								
BX	15	Buxus microphylla 'Wintergreen'	Wintergreen Boxwood		as shown	B&B	24"	\$ 45.00	\$	675.0
EA	81	Euonymus alta 'Compact'	Compact Burning Bush		as shown	B&B	30"-36"	\$ 50.00	\$	4,050.0
MR	11	Malus sargentii	Sargent Crab	2.0"	as shown	B&B		\$ 200.00	\$	2,200.0
40	50	Pennisetum a. 'Little Bunnies'	Dwarf Fountain Grass		Full, we	ell roote	d 1 gal.	\$ 15.00	\$	750.0
20	37	Rosa 'Nearly Wild'	Nearly Wild Rose		as shown		24"	\$ 45.00	\$	1,665.0
SA	20	Hosta x 'Antioch'	Antioch Hosta		Full, we	ell roote	d 1 gal.	\$ 15.00	\$	300.0
SP	111	Spirea j. 'Anthony Waterer'	Anthony Waterer Spirea		as shown		30"-36"	\$ 50.00	\$	5,550.0
TM	23	Taxus x media 'Densiformis'	Dense Yew		as shown		30"-36"	\$ 50.00	\$	1,150.0
	576	Kentucky Blue Grass, (S.Y.)						\$ 4.00	\$	2,304.0
		Irrigation System							\$	35,000.0
		***					Sub Tota	ı	\$	53,644.0

LANDSCAPE REQUIREMENTS

- The work shall consist of providing all necessary materials, labor, warrants, equipment, tools and supervision required for the completion as shown on the drawings.
- The plant materials shall conform to type stated on the plant list. Sizes shall be the minimum stated on the plant list or larger. All measurements shall be in accordance with the latest edition of the "A.A.N. Standards for nursery stock."
- The plant material shall be nursery grown and inspected by the owner's representative before planting. The owner's representative reserves the right to reject any plant material at any time. 4. Plants designated "B & B" shall be balled and burlapped with firm balls of earth.

5. The contractor is responsible for planting the materials at the correct

- grades and spacing. The plants shall be oriented as to give the best appearance. When the plant has been properly set, the pit shall be backfilled with a topsoil mixture, gradually filling, patting and settling with water. 7. All plant materials shall be pruned and injuries repaired. The amount of
- of roots from transplanting. Cuts should be flush, leaving no stubs. Cuts over 1" shall be painted with tree paint. 8. The contractor agrees to guarantee all plant materials for the period of two years. At that time the owner's representative reserves the right for a final inspection. Plant material with 25% die back, as determined by the owner's representative shall be replaced.
- This guarantee includes the furnishing of new plants, labor and materials. These new plants shall also be guaranteed for the period of one year. 9. Topsoil shall be friable, fertile topsoil of clay loam character containing at least 5% but not more than 20% by weight of organic matter with a PH range from 6.0 to 7.0.

pruning shall be limited to the removal of dead or injured twigs and to compensate for the loss

- Soil shall be free from clay lumps, coarse sand, plant roots, sticks and other foreign materials. 10. Seed mix shall consist of the following types and proportions: Kentucky Blue Grass - "Baron/Cheriadelphi" 60%
- Chewing Chewing Fescue 15% Perennial Rye Grass 10% Weed content shall not exceed 19
- 11. Sod shall be two year old "Baron/Cheriadelphi" Kentucky Blue Grass grown in a sod

- 12. The Contractor shall verify all rights of way, easements, property lines and limits of work,
- etc. prior to commencing work. 13. The Contractor shall be responsible for contacting and coordinating with all pertinent utility companies 72 hours in advance of any digging to make himself familiar with all underground utilities, pipes and structures. The Contractor shall take sole responsibility
- 14. The Contractor shall not willfully proceed with construction as designed when it is obvious that unknown obstructions and/or grade differences exist. Such conditions shall be immediately brought to the attention of the owner's representative and/or Landscape Architect. The Contractor shall assume full responsibility for all necessary revisions due to failure to give such notification.
- 15. Any discrepancies between dimensioned layout and actual field conditions shall be reported to the Owner's representative and Landscape Architect. Failure to make such discrepancies known will result in Contractor's responsibility and liability for any changes and associated cost.

16. The Contractor to verify percolation of all planting pits prior to installation of plant


Overhead Line Statement: No Overhead Lines Exist

Loading Area Statement: Proposed Landscaping and/or Walls Shall

ALLEN DESIGN 557 CARPENTER • NORTHVILLE, MI 48167 248.467.4668 • Fax 248.349.0559

Email: jca@wideopenwest.com

Seal:

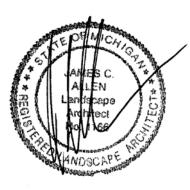

Landscape Plan

Project

Adams Marketplace Flagstar Bank Rochester Hills, Michigan

Prepared for:


Zeimet Wozniak & Associates 40024 Grand River Avenue, Suite 100 Novi, Michigan 48375 248.442.1101

Revision:	Issued:
Site Plan Submission	February 22, 200
Revised per City	March 23, 2007
Revised per City	April 24, 2007
Revised per City	June 15, 2007
Revised	May 8, 2013

Job Number:

07-009

Drawn By: Checked By:

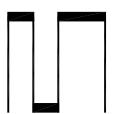

0' 5' 10' 20'

NORTH

Sheet No.

L-^{*}

DECIDUOUS TREE PLANTING DETAIL

TREE PIT SHALL BE 3 TIMES THE

SIZE OF THE ROOT BALL.

STAKE TREES JUST BELOW

FIRST BRANCH USING 2-3"

WIDE BELT-LIKE NYLON OR

PLASTIC STRAPS. CONNECT

ALLOW FOR SOME FLEXING

REMOVE AFTER ONE (1)

TREE SHALL BEAR SAME

AS IT BORE ORIGINALLY.

RELATION TO FINISH GRADE

REMOVE ALL TAGS, STRING,

DO NOT PRUNE TERMINAL LEADER.

PRUNE ONLY DEAD OR BROKEN

PLASTIC AND OTHER MATERIALS

WINTER SEASON.

NOTES:

BRANCHES.

FROM TREE TO STAKE OPPOSITE

TREE WRAP TO BE SECURED WITH BIO-

DEGRADABLE MATERIAL

REMOVE AFTER FIRST

USE 2 HARDWOOD STAKES

TO A DEPTH OF 18" BELOW

AROUND BASE OF TREE.

PER TREE. DRIVE STAKES INTO

TREE PIT. REMOVE AFTER ONE

1) WINTER SEASON. WIRE OR ROPE

- MULCH 4" DEPTH W/ FINLEY SHREDDED

HARDWOOD BARK, MULCH SHALL BE

NATURAL IN COLOR. LEAVE 3" CLEAR

MOUND TO FORM 3" EARTH SAUCER

REMOVE ALL NON-BIODEGRADABLE

MATERIALS FROM THE ROOTBALL.

DOWN ALL BURLAP FROM 1/3 OF

PLANTING MIX AS SPECIFIED

- UNDISTURBED SOIL

CUT DOWN WIRE BASKET AND FOLD

UNDISTURBED SOIL 6-8" OUTSIDE ROOTBALL

THROUGH A HOSE SHALL NOT BE ALLOWED.

EVERGREEN TREE PLANTING DETAIL

TREE PIT SHALL BE 3 TIMES THE

STAKE TREES JUST BELOW

FIRST BRANCH USING 2-3"

WIDE BELT-LIKE NYLON OR

PLASTIC STRAPS, CONNECT

ALLOW FOR SOME FLEXING.

REMOVE AFTER ONE (1)

TREE SHALL BEAR SAME

AS IT BORE ORIGINALLY.

RELATION TO FINISH GRADE

DO NOT PRUNE TERMINAL LEADER.

PRUNE ONLY DEAD OR BROKEN

PLASTIC AND OTHER MATERIALS

REMOVE ALL TAGS, STRING,

WINTER SEASON.

NOTES:

BRANCHES.

FROM TREE TO STAKE OPPOSITE.

USE 2 HARDWOOD STAKES

TO A DEPTH OF 18" BELOW

AROUND BASE OF TREE.

PER TREE. DRIVE STAKES INTO

TREE PIT. REMOVE AFTER ONE

(1) WINTER SEASON. WIRE OR ROPE

- MULCH 4" DEPTH W/ FINELY SHREDDED

NATURAL IN COLOR. LEAVE 3" CLEAR

- MOUND TO FORM 3" EARTH SAUCER

CUT DOWN WIRE BASKET AND FOLD

REMOVE ALL NON-BIODEGRADABLE

MATERIALS FROM THE ROOTBALL.

DOWN ALL BURLAP FROM 1/3 OF

- PLANTING MIX AS SPECIFIED

- UNDISTURBED SOIL

UNDISTURBED SOIL 6-8" OUTSIDE ROOTBALL

THROUGH A HOSE SHALL NOT BE ALLOWED

SHRUB PLANTING DETAIL

TREE SHALL BEAR SAME

AS IT BORE ORIGINALLY.

BRANCHES.

RELATION TO FINISH GRADE

REMOVE ALL TAGS, STRING,

DO NOT PRUNE TERMINAL LEADER.

PRUNE ONLY DEAD OR BROKEN

PLASTIC AND OTHER MATERIALS

— MULCH 3" DEPTH W/ FINELY SHREDDED

HARDWOOD BARK MULCH, MULCH

PULL MULCH 3" AWAY FROM TRUNK

SHALL BE NATURAL IN COLOR.

EARTH SAUCER AROUND SHRUB

REMOVE ALL NON-BIODEGRADABLE

FOLD DOWN ALL BURLAP FROM TOP

MATERIALS FROM THE ROOTBALL

PLANTING MIX. AS SPECIFIED

1/3 OF ROOTBALL.


SCARIFY SUBGRADE


UNDISTURBED SOIL


The mix shall be applied at a rate of 200 lbs./acre


Adequately Screen Loading Areas from Public R.O.W.


for any cost incurred due to damage of said utilities.

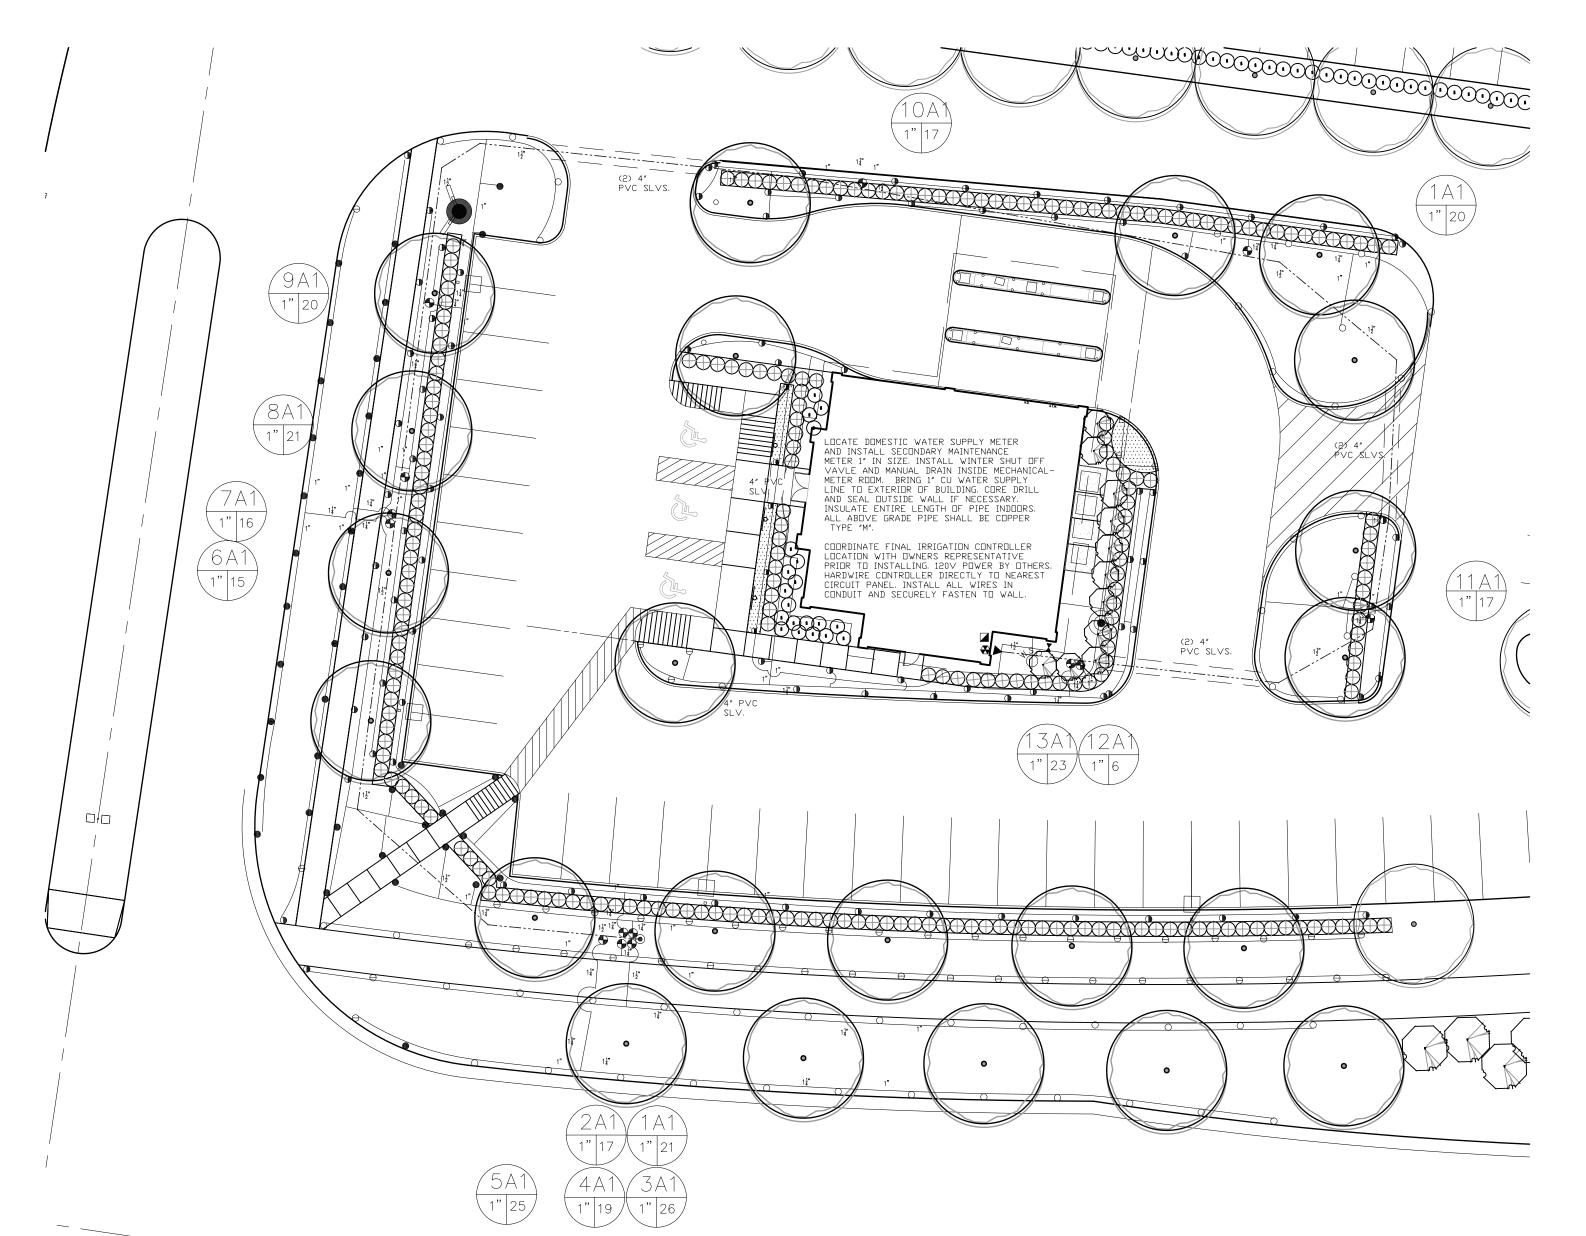

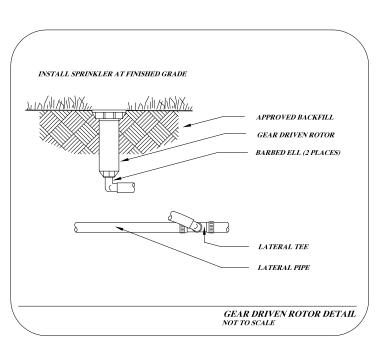

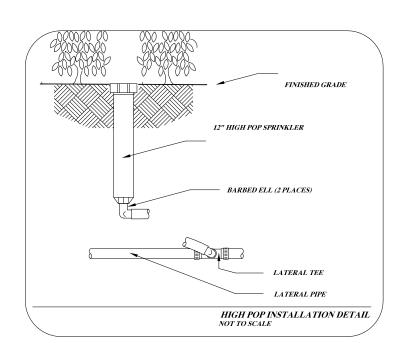

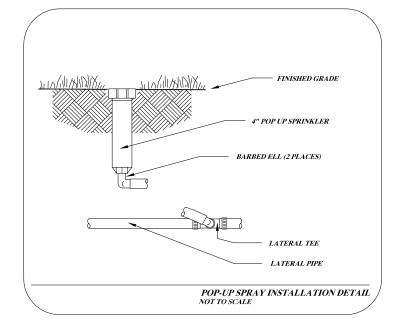


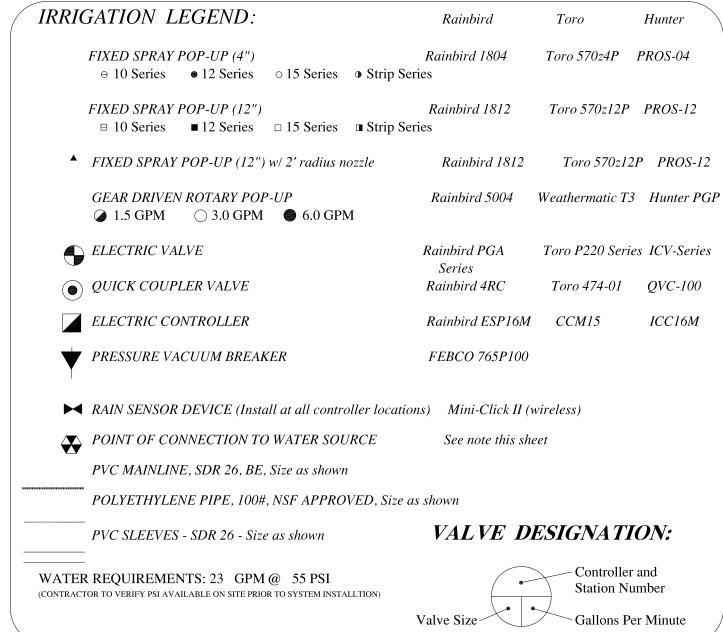



NOTES:


- 1. Refer to the specifications for installation details and descriptions, as well as, construction methods
- which will be accepted.
- 2. All work shall be in compliance with all local, state, and federal codes and ordinances.
- 3. All electrical connections shall be made using 3m DBY splice kits. 4. All control wiring downstream of the controller shall be single strand copper 14AWG UL approved
- for direct bury. 5. All clamps shall be stainless steel worm gear type clamps. Pipes 1-1/2" or larger shall be double
- 6. Pipe routing is schematic. All heads are to be field adjusted to within 2' to take into consideration any obstruction. Final head placements are subject to the landscape architects approval.
- 7. All sprinkler heads shall be mounted on 2 elbow poly swing joints as specified. 8. Contractor to verify final controller location with owner's authorized representative prior to
- installation. 9. All pipe not sized downstream of control valve is 1".
- 10. All sleeves shall be PVC 160# (see specifications).
- 11. Irrigation contractor's point of connection to water source shall be as noted on this sheet. Locate and connect to indicated water source. All pipe installed above grade shall be copper type "M".
- 12. 120v power to the controller locations should be provided owner. Coordinate with owner's representative. Hardwire controller directly to nearest circuit panel. Place all wires in conduit per
- 13. Design pressure does not take into account seasonal supply fluctuations. Periods of drought may cause temporary pressure losses to the city water supply resulting in inadequate irrigation system performance. Irrigation design is based on normal weather conditions and typical municipal water
- supply abilities. 14. Irrigation contractor shall be responsible for determining and maintaining the irrigation schedule during the project construction and throughout the length of the warranty period. The irrigation
- schedule shall deliver 1" of precipitation per week +/- natural rainfall quantities for turf grass. Landscape material shall recieve adjusted amounts of precipitation to maintain proper plant health.
- 15. Landscape and turf grass shall be irrigated separately.
- 16. Rotors and spray zones may not be combined to operate at the same time. 17. The Hours of operation for Lawn Irrigation System Shall not be During the Hours
- of 5:00 A.M. to 9:00 A.M. and from 5:00 P.M. to 9:00 P.M.




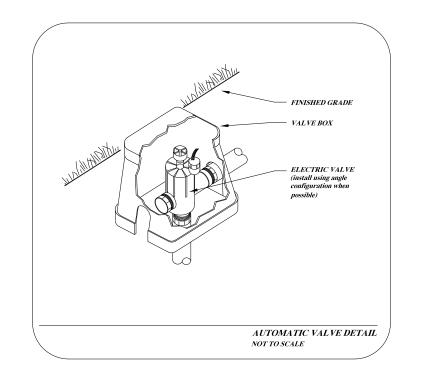


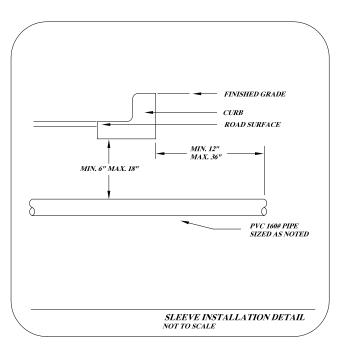

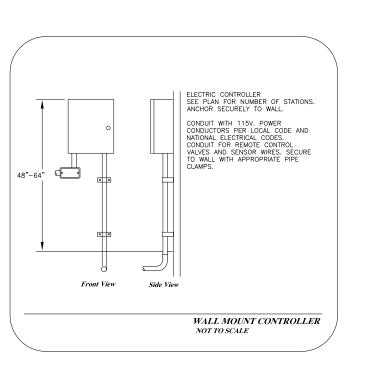

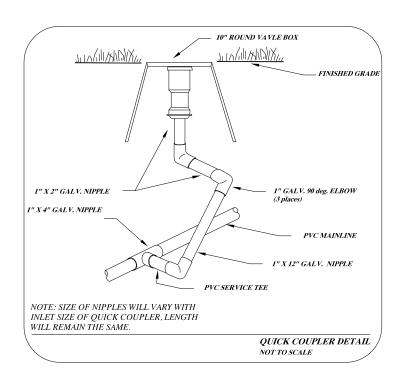

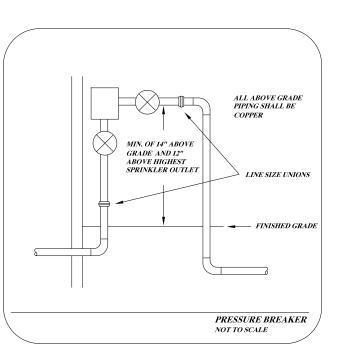

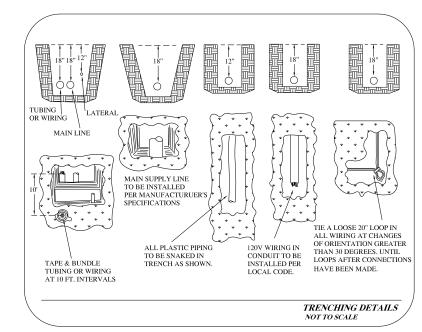



4843 Kittery NW Comstock Park, Michigan 49321 Tel. (248) 789-0330 (616) 745-5779 email: abarnes@lqdassets.org www.lqdassets.org



Seal:

Irrigation Plan

Project

Adams Marketplace Flagstar Bank Rochester Hills, Michigan

Prepared for:


Zeimet Wozniak & Associates 40024 Grand River Avenue, Suite 100 Novi, Michigan 48375 248.442.1101

Revision: Issued: Site Plan Submission February 22, 2007 Revised per City March 23, 2007 Revised per City April 24, 2007 Revised per City June 15, 2007 May 8, 2013

Job Number:

07-009

Checked By: Drawn By:

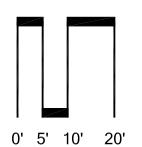



Sheet No.