

KEYNOTES

(REFER ONLY TO NOTES THAT ARE INDICATED BY NUMERICAL KEY ON PLAN):

- 1. NEW CONCRETE RAMP. RAMP TO SLOPE AT 1:12 FROM FINISH FLOOR TO FINISH GRADE. CONCRETE TO BE A MINIMUM 6" THICK 4000 PSI WITH 6 X 6 W 1.4 X W 1.4 WWF ON 6" DRAINABLE BASE ON COMPACTED FILL. VERIFY DIFFERENCE IN GRADE ON SITE. WHERE APPLICABLE FOR ADA COMPLIANCE INSTALL SIDE FLARES TO DRAMP W/MAX SLOPE OF 1:10. SEE PLAN FOR LOCATIONS.
- RAMP W/ MAX SLOPE OF 1:10. SEE PLAN FOR LOCATIONS.
 2. NEW CONCRETE PAD. CONCRETE TO BE A MINIMUM 6" THICK 4000 PSI WITH 6 X 6 W 1.4 X W 1.4 WWF ON 6" DRAINABLE BASE ON COMPACTED FILL. PAD TO SIT FLUSH WITH FINISHED FLOOR AND HAVE POSITIVE SLOPE
- AWAY FROM BUILDING.

 3. NEW CONCRETE PAD. CONCRETE TO BE A MINIMUM 6" THICK 4000 PSI WITH 6 X 6 W 1.4 X W 1.4 WWF ON 6"
- 4. 1-1/2" PAINTED METAL HANDRAIL ON 6" RAISED CURB.
- 5. DUMPSTER LOCATION IN EXISTING ENCLOSURE.

TO SIT FLUSH WITH ADJACENT GRADE.

6. 6" SCHEDULE 40 CONCRETE FILLED PIPE BOLLARDS, TYP. SEE DETAIL 3/AS1.0 FOR MORE INFORMATION.

DRAINABLE BASE ON COMPACTED FILL, PAD TO SIT FLUSH WITH ADJACENT GRADE.

- 7. 6" SCHEDULE 40 CONCRETE FILLED PIPE BOLLARDS, TYP. EA SIDE OF OPENING. SEE DETAIL 9/A4.0 FOR MORE INFORMATION.
- 8. EXISTING BOLLARD TO REMAIN. REPAIR/REPLACE AS NECESSARY. CONTRACTOR TO PREP AND COVER WITH MCCUE BOLLARD COVER.
- 9. NEW CONCRETE PAD AND PROPANE TANKS. COORDINATE WITH MANUFACTURE FOR LOCATION AND SIZE OF PAD, TANK AND NUMBER OF BOLLARDS. BOLLARDS TO RECEIVE MCCUE BOLLARD COVERS. CONCRETE TO BE A MINIMUM 6" THICK 4000 PSI WITH 6 X 6 W 1.4 X W 1.4 WWF ON 6" DRAINABLE BASE ON COMPACTED FILL. PAD
- 10. INSTALL NEW AUTOMATIC SLIDING BI-PARTING ALUM. DOORS IN EXISTING STOREFRONT OPENING, SEE A0.0 DOOR SCHEDULE FOR MORE INFORMATION. FIELD VERIFY HEIGHT AND WIDTH OF OPENING.
- 11. INSTALL NEW AUTOMATIC SLIDING BI-PARTING ALUM. DOORS IN NEW MASONRY OPENING, SEE A0.0 DOOR SCHEDULE FOR MORE INFORMATION.
- 12. CONTRACTOR TO INSTALL NEW ALUMINUM AND GLASS DOUBLE DOOR AND FRAME IN MERCHNEY GREENHOUSE PROVIDED OPENING, SEE MERCHNEY DRAWINGS FOR MORE INFORMATION.
- 13. EXISTING WINDOWS AT STOREFRONT TO HAVE WHITE FROSTED LLUMAR WINDOW FILM APPLIED TO INSIDE
- 14. SECURITY VENDOR TO PROVIDE AND INSTALL KNOX BOX FOR FIRE DEPARTMENT WHERE INDICATED. VERIFY FINAL LOCATION WITH AUTHORITY HAVING JURISDICTION.
- 15. INSTALL NEW MAN DOOR AND FRAME IN EXISTING MASONRY OPENING.
- 16. INSTALL DOOR BELL @ MAN DOOR WHERE INDICATED.
- 17. INSTALL BIG-EYE VIEWER @ MAN DOOR WHERE INDICATED.
- 18. NEW 8' X 10' INSULATED SECTIONAL DOOR LOCATION WITH MANUAL OPERATION IN MODIFIED MASONRY OPENING. SEE A0.1 DOOR SCHEDULE FOR MORE INFORMATION. SEE STRUCTURAL.
- 19. NEW 6' X 9' INSULATED SECTIONAL DOOR LOCATION WITH AUTOMATIC OPERATION IN EXISTING MASONRY OPENING. SEE A0.1 DOOR SCHEDULE FOR MORE INFORMATION.
- 20. NEW 10' X 10' INSULATED SECTIONAL DOOR LOCATION WITH AUTOMATIC OPERATION IN NEW MASONRY OPENING. SEE A0.1 DOOR SCHEDULE FOR MORE INFORMATION. SEE STRUCTURAL.
- 21. EXTENT OF VINYL PLANK FLOORING FOR EXPANDED CLOTHING AREA. USE ONE SIDED BEVEL PLANK @ POINT OF TRANSITION TO CONCRETE. VERIFY EXTENT OF PLANK FLOORING WITH TSC PROVIDED FINAL FIXTURE PLAN PRIOR TO INSTALLATION. SUPPLIED BY TSC AND INSTALLED BY CONTRACTOR. AREA NOT TO EXCEED 3,000 SQ.
- 22. DRESSING ROOMS ARE STICK BUILT BY CONTRACTOR. CONTRACTOR TO ASSEMBLE AND ANCHOR DRESSING ROOM AND ALL COMPONENTS TO WALL AND/OR FLOOR. CONTRACTOR TO PROVIDE AND INSTALL (2) 24" X 60" (1/4" POLISHED PLATE GLASS 1 PIECE), ONE ON THE EXTERIOR SIDE OF DOOR AND ONE ON THE INTERIOR WALL PARALLEL TO THE FRONT WALL, HUNG WITH STANDARD MIRROR CLIPS PER MANUFACTURER RECOMMENDATIONS. WHERE BOTTOM EDGE OF THE REFLECTING SURFACE IS AT 18" A.F.F., AND (4) FOUR HOOKS ON DRESSING ROOM WALL. MOUNT (2) TWO HOOKS TO MEET ACCESSIBILITY ACCESS (48" MAX. A.F.F. / 46" MAX. A.F.F. IF MOUNTED OVER THE BENCH) AND (2) TWO HOOKS AT 60" A.F.F. VERIFY LOCATION W/ FINAL FIXTURE PLAN AND TSC PROJECT MANAGER. SEE DETAIL 15 ON SHEET A4.0.
- 23. TSC TO SUPPLY, CONTRACTOR TO INSTALL NEW DURULITE DOOR(S) @ NEW FIXTURE WALL. VERIFY LOCATION W/ FINAL FIXTURE PLAN.
- 24. EXISTING RESTROOMS TO BE RE-USED. THOROUGHLY STEAM CLEANED AND DISINFECTED. ALL PENETRATIONS TO BE REPAIRED AND PAINTED. REPLACE ALL FIXTURES AND FLOORING AS INDICATED ON TENANT FLOOR PLAN PER TENANTS STANDARD CRITERIA PLANS, AND CONSISTENT WITH ALL APPLICABLE CODES. PROVIDE ALL ELECTRICAL ITEMS PER STANDARD CRITERIA PLANS AND AS REFERENCED IN ELECTRICAL ITEMS SECTION.
- 25. CONTRACTOR TO INSTALL NEW OWNER PROVIDED BATHROOM ACCESSORIES AS REQUIRED. SEE BATHROOM DETAILS A4.0. ALL ACCESSORIES INSTALLED SHALL COMPLY WITH CURRENT ADA STANDARDS.
- 26. NEW HIGH/LOW WATER COOLER. SEE PLUMBING FOR FIXTURE TYPE. SEE 1 & 2 / A4.0 FOR MORE INFORMATION.
- 27. CONTRACTOR TO INSTALL NEW MANAGER'S OFFICE. NEW WALLS TO BE CONSTRUCTED OF 3 5/8" MTL STUDS @ 16" O.C. WITH 5/8" GYP. BD. ON BOTH SIDES TO DECK W/ 3-5/8" BATT INSULATION INSIDE WALLS AND 6" BATT INSULATION ABOVE CEILING. INSTALL ANY AND ALL ITEMS SUCH AS HVAC. SEE MECHANICAL AND ELECTRIC. REWORK SPRINKLER HEADS TO NEW CEILING HEIGHT PER LOCAL CODE REQUIREMENTS. CONTRACTOR TO SUBMIT SPRINKLER SHOP DRAWINGS TO LOCAL FIRE MARSHAL PRIOR TO INSTALLATION.
- 28. CONTRACTOR TO BOLT DOWN SAFE IN MANAGER'S OFFICE. VERIFY LOCATION WITH STORE MANAGER.
- 29. EXISTING ROOM TO BE RE-USED FOR EMPLOYEE LOUNGE. THOROUGHLY STEAM CLEANED AND DISINFECTED. ALL PENETRATIONS TO BE REPAIRED AND PAINTED. REPLACE ALL FIXTURES AND FLOORING AS INDICATED ON TENANT FLOOR PLAN PER TENANTS STANDARD CRITERIA PLANS, AND CONSISTENT WITH ALL APPLICABLE CODES. PROVIDE ALL ELECTRICAL ITEMS PER STANDARD CRITERIA PLANS AND AS REFERENCED IN ELECTRICAL ITEMS SECTION
- 30. INSTALL NEW TSC PROVIDED EMPLOYEE LOUNGE COUNTER AND SINK. SEE DETAIL 6/A4.0 FOR NEW COUNTER AND SINK.
- 31. CONTRACTOR TO INSTALL NEW IT ROOM. NEW WALLS TO BE CONSTRUCTED OF 3 5/8" MTL STUDS @ 16" O.C. WITH 5/8" GYP. BD. ON BOTH SIDES. SEE PLAN FOR WALLS EXTENDING TO DECK. INSTALL ANY AND ALL ITEMS SUCH AS HVAC. SEE MECHANICAL AND ELECTRIC. REWORK SPRINKLER HEADS TO NEW ROOM PER LOCAL CODE REQUIREMENTS. CONTRACTOR TO SUBMIT SPRINKLER SHOP DRAWINGS TO LOCAL FIRE MARSHAL PRIOR TO INSTALLATION.
- 32. CONTRACTOR TO MOUNT 36" LONG 6" PVC PIPE ABOVE DOOR WITH SCREW CAPS EACH END TO HOUSE FINAL CONSTRUCTION DOCUMENTS. CONTRACTOR TO PRINT FINAL SET AND PLACE IN PVC PIPE
- 33. INSTALL 3/4" X 4' x 8' FIRE RETARDANT PLYWOOD PHONE BOARD. SEE ELECTRICAL, DETAIL 10/A4.0.
- 34. CONTRACTOR TO INSTALL 1 1/2" EMT CONDUIT FROM EXISTING D-MARK LOCATION TO 8' A.F.F. ABOVE TSC PHONE BOARD LOCATION; WITH PULL STRING.
- 35. CONTRACTOR TO INSTALL NEW PET WASH ROOM. SEE DETAIL 1/A5.1 FOR WALL CONSTRUCTION. SEE PLAN FOR WALLS EXTENDING TO DECK. INSTALL ANY AND ALL ITEMS SUCH AS PLUMBING AND ELECTRICAL. SEE PLUMBING AND ELECTRICAL. CONTRACTOR TO INSTALL ALL TSC PROVIDED EQUIPMENT IN ROOM. CONTRACTOR TO ACCESS PLAN EXPRESS FOR COMPLETE PET WASH DETAIL SHEETS.
- 36. CONTRACTOR TO INSTALL NEW WELLNESS CENTER. SEE DETAIL 1/A5.2 FOR WALL CONSTRUCTION. SEE PLAN FOR WALLS EXTENDING TO DECK. INSTALL ANY AND ALL ITEMS SUCH AS PLUMBING AND ELECTRICAL. SEE PLUMBING AND ELECTRICAL. CONTRACTOR TO INSTALL ALL TSC PROVIDED EQUIPMENT IN ROOM. CONTRACTOR TO ACCESS PLAN EXPRESS FOR COMPLETE WELLNESS CENTER SHEETS.
- 37. CONTRACTOR TO INSTALL NEW WATER HEATER MOUNTED ABOVE NEW MOP SINK. SEE DETAILS 6&7/A5.1. SEE PLUMBING.
- 38. INSTALL FIXTURES IN STOCKROOM PER GUIDELINES THIS SHEET. SEE TSC FINAL FIXTURE PLAN FOR LOCATIONS
- 39. TSC TO DELIVER, CONTRACTOR TO CIRCUIT AND INSTALL SERVICE DISCONNECT FOR NEW BALER. VERIFY CIRCUIT LOCATION IN FIELD W/TSC PM. INSTALL 4" DIA. PVC PIPE 8 FEET LONG BEHIND BALER @ 36" A.F.F. FOR BALER WIRE. SEE ELECTRICAL. SUSPEND FLEX-LINE OVERHEAD.
- 40. EXISTING TRANSFORMER AND ELECTRICAL PANEL TO BE REUSED, SEE ELECTRICAL.
- 41. CONTRACTOR TO FILL DEMOED TRENCHES WITH GRAVEL AND HIGH STRENGTH CONCRETE. FILL ALL REMAINING CONCRETE CRACKS WITH HIGH STRENGTH CONCRETE. CONTRACTOR TO AGITATE GRAVEL IN ALL REFRIGERATED PITS TO FILL ALL VOIDS PRIOR TO CONCRETE INSTALLATION. CONCRETE TO BE A MINIMUM OF 4" THICK 4,000 PSI WITH 6 X 6 W 1.4 X W 1.4 WWF ON 6" DRAINABLE BASE ON COMPACTED FILL.
- 42. EXISTING ACCESS TO ROOF WITH LADDER AND ROOF HATCH.
- 43. EXISTING FIRE RISER LOCATION.
- 44. EXISTING WATER METER LOCATION.
- 45. CONTRACTOR TO PROVIDE NEW DOCK BUMPERS AT OVERHEAD DOOR LOCATION.

FLOOR PLAN

SCALE: 3/32"=1'-0"



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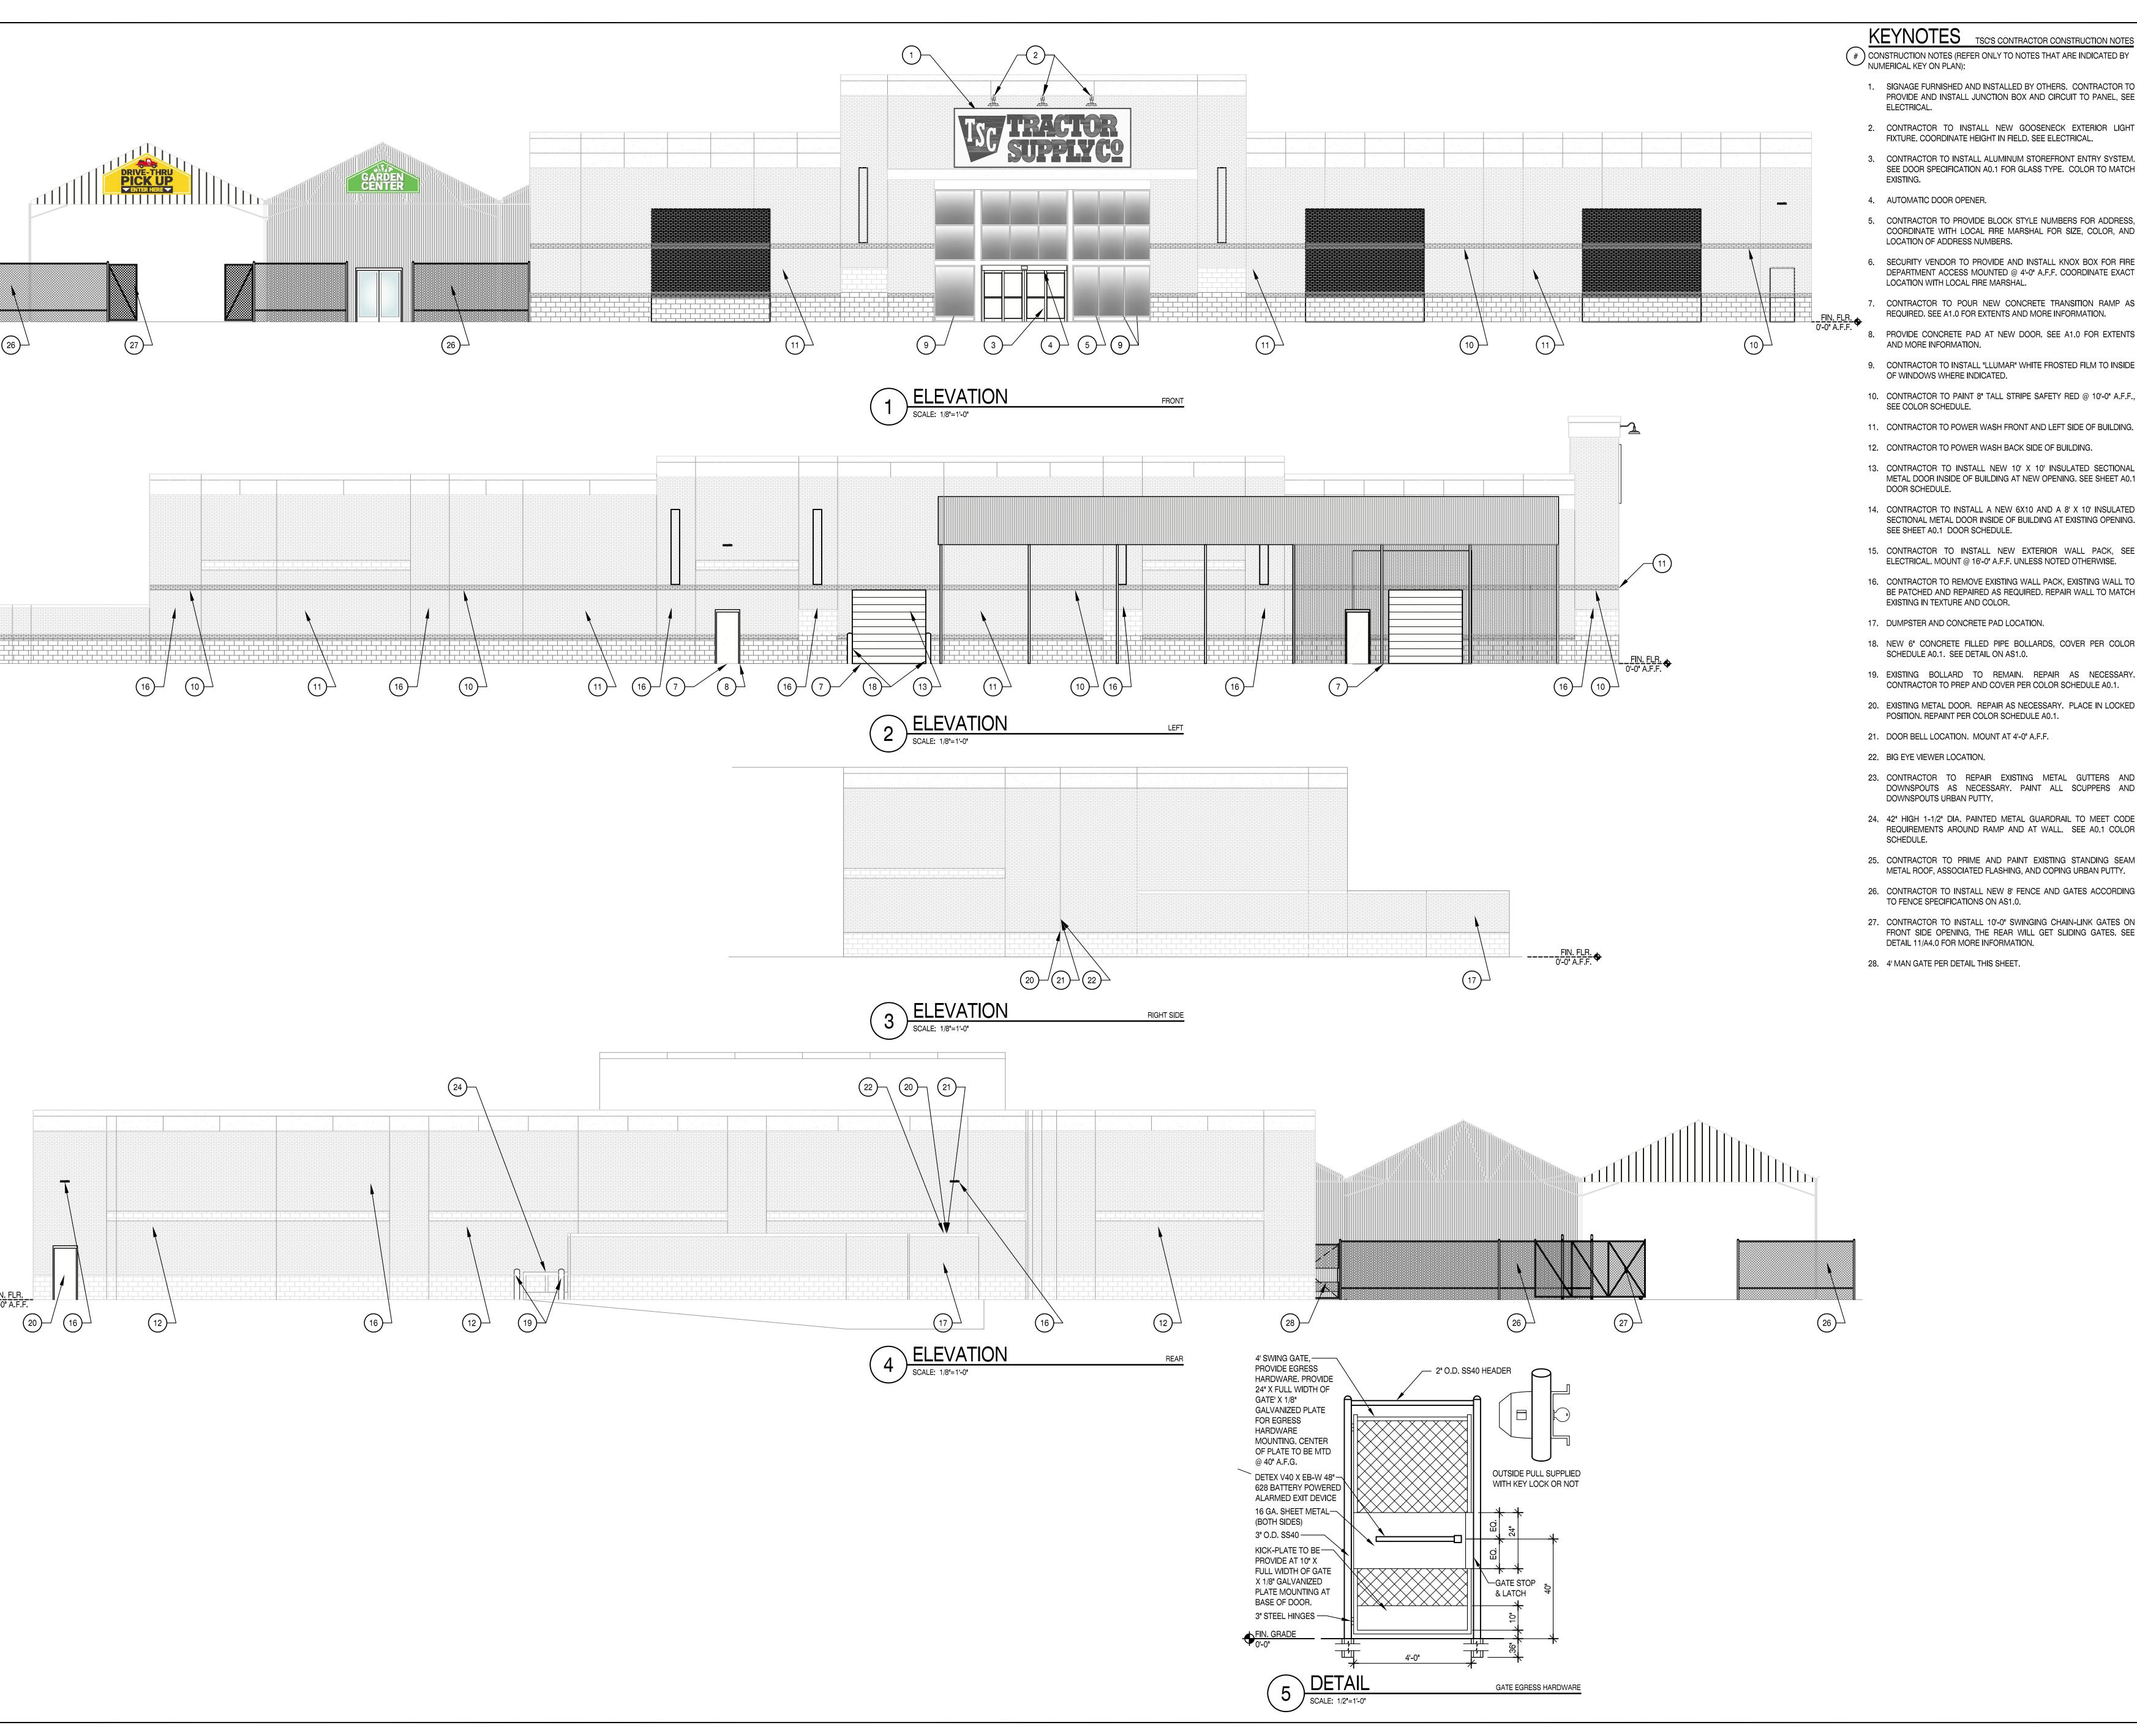
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ARCHITECTURAL FLOOR PLAN

Sheet Number:

A1.0



KEYNOTES TSC'S CONTRACTOR CONSTRUCTION NOTES (#) CONSTRUCTION NOTES (REFER ONLY TO NOTES THAT ARE INDICATED BY

- 1. SIGNAGE FURNISHED AND INSTALLED BY OTHERS. CONTRACTOR TO PROVIDE AND INSTALL JUNCTION BOX AND CIRCUIT TO PANEL, SEE
- 2. CONTRACTOR TO INSTALL NEW GOOSENECK EXTERIOR LIGHT
- 3. CONTRACTOR TO INSTALL ALUMINUM STOREFRONT ENTRY SYSTEM. SEE DOOR SPECIFICATION A0.1 FOR GLASS TYPE. COLOR TO MATCH
- 5. CONTRACTOR TO PROVIDE BLOCK STYLE NUMBERS FOR ADDRESS, COORDINATE WITH LOCAL FIRE MARSHAL FOR SIZE, COLOR, AND LOCATION OF ADDRESS NUMBERS.
- 6. SECURITY VENDOR TO PROVIDE AND INSTALL KNOX BOX FOR FIRE DEPARTMENT ACCESS MOUNTED @ 4'-0" A.F.F. COORDINATE EXACT LOCATION WITH LOCAL FIRE MARSHAL.
- 7. CONTRACTOR TO POUR NEW CONCRETE TRANSITION RAMP AS REQUIRED. SEE A1.0 FOR EXTENTS AND MORE INFORMATION.
- 8. PROVIDE CONCRETE PAD AT NEW DOOR. SEE A1.0 FOR EXTENTS
- 9. CONTRACTOR TO INSTALL "LLUMAR" WHITE FROSTED FILM TO INSIDE OF WINDOWS WHERE INDICATED.
- 10. CONTRACTOR TO PAINT 8' TALL STRIPE SAFETY RED @ 10'-0" A.F.F.,
- 11. CONTRACTOR TO POWER WASH FRONT AND LEFT SIDE OF BUILDING.
- 12. CONTRACTOR TO POWER WASH BACK SIDE OF BUILDING.
- 13. CONTRACTOR TO INSTALL NEW 10' X 10' INSULATED SECTIONAL METAL DOOR INSIDE OF BUILDING AT NEW OPENING. SEE SHEET A0.1
- 14. CONTRACTOR TO INSTALL A NEW 6X10 AND A 8' X 10' INSULATED SECTIONAL METAL DOOR INSIDE OF BUILDING AT EXISTING OPENING. SEE SHEET A0.1 DOOR SCHEDULE.
- 15. CONTRACTOR TO INSTALL NEW EXTERIOR WALL PACK, SEE ELECTRICAL. MOUNT @ 16'-0" A.F.F. UNLESS NOTED OTHERWISE.
- 16. CONTRACTOR TO REMOVE EXISTING WALL PACK, EXISTING WALL TO BE PATCHED AND REPAIRED AS REQUIRED. REPAIR WALL TO MATCH EXISTING IN TEXTURE AND COLOR.
- 17. DUMPSTER AND CONCRETE PAD LOCATION.
- 18. NEW 6' CONCRETE FILLED PIPE BOLLARDS, COVER PER COLOR SCHEDULE A0.1. SEE DETAIL ON AS1.0.
- CONTRACTOR TO PREP AND COVER PER COLOR SCHEDULE A0.1.
- 20. EXISTING METAL DOOR. REPAIR AS NECESSARY. PLACE IN LOCKED POSITION. REPAINT PER COLOR SCHEDULE A0.1.
- 21. DOOR BELL LOCATION. MOUNT AT 4'-0" A.F.F.
- 23. CONTRACTOR TO REPAIR EXISTING METAL GUTTERS AND DOWNSPOUTS AS NECESSARY. PAINT ALL SCUPPERS AND
- 24. 42" HIGH 1-1/2" DIA. PAINTED METAL GUARDRAIL TO MEET CODE REQUIREMENTS AROUND RAMP AND AT WALL. SEE A0.1 COLOR
- 25. CONTRACTOR TO PRIME AND PAINT EXISTING STANDING SEAM METAL ROOF, ASSOCIATED FLASHING, AND COPING URBAN PUTTY.
- 26. CONTRACTOR TO INSTALL NEW 8' FENCE AND GATES ACCORDING TO FENCE SPECIFICATIONS ON AS1.0.
- 27. CONTRACTOR TO INSTALL 10'-0" SWINGING CHAIN-LINK GATES ON FRONT SIDE OPENING, THE REAR WILL GET SLIDING GATES. SEE DETAIL 11/A4.0 FOR MORE INFORMATION.
- 28. 4' MAN GATE PER DETAIL THIS SHEET.



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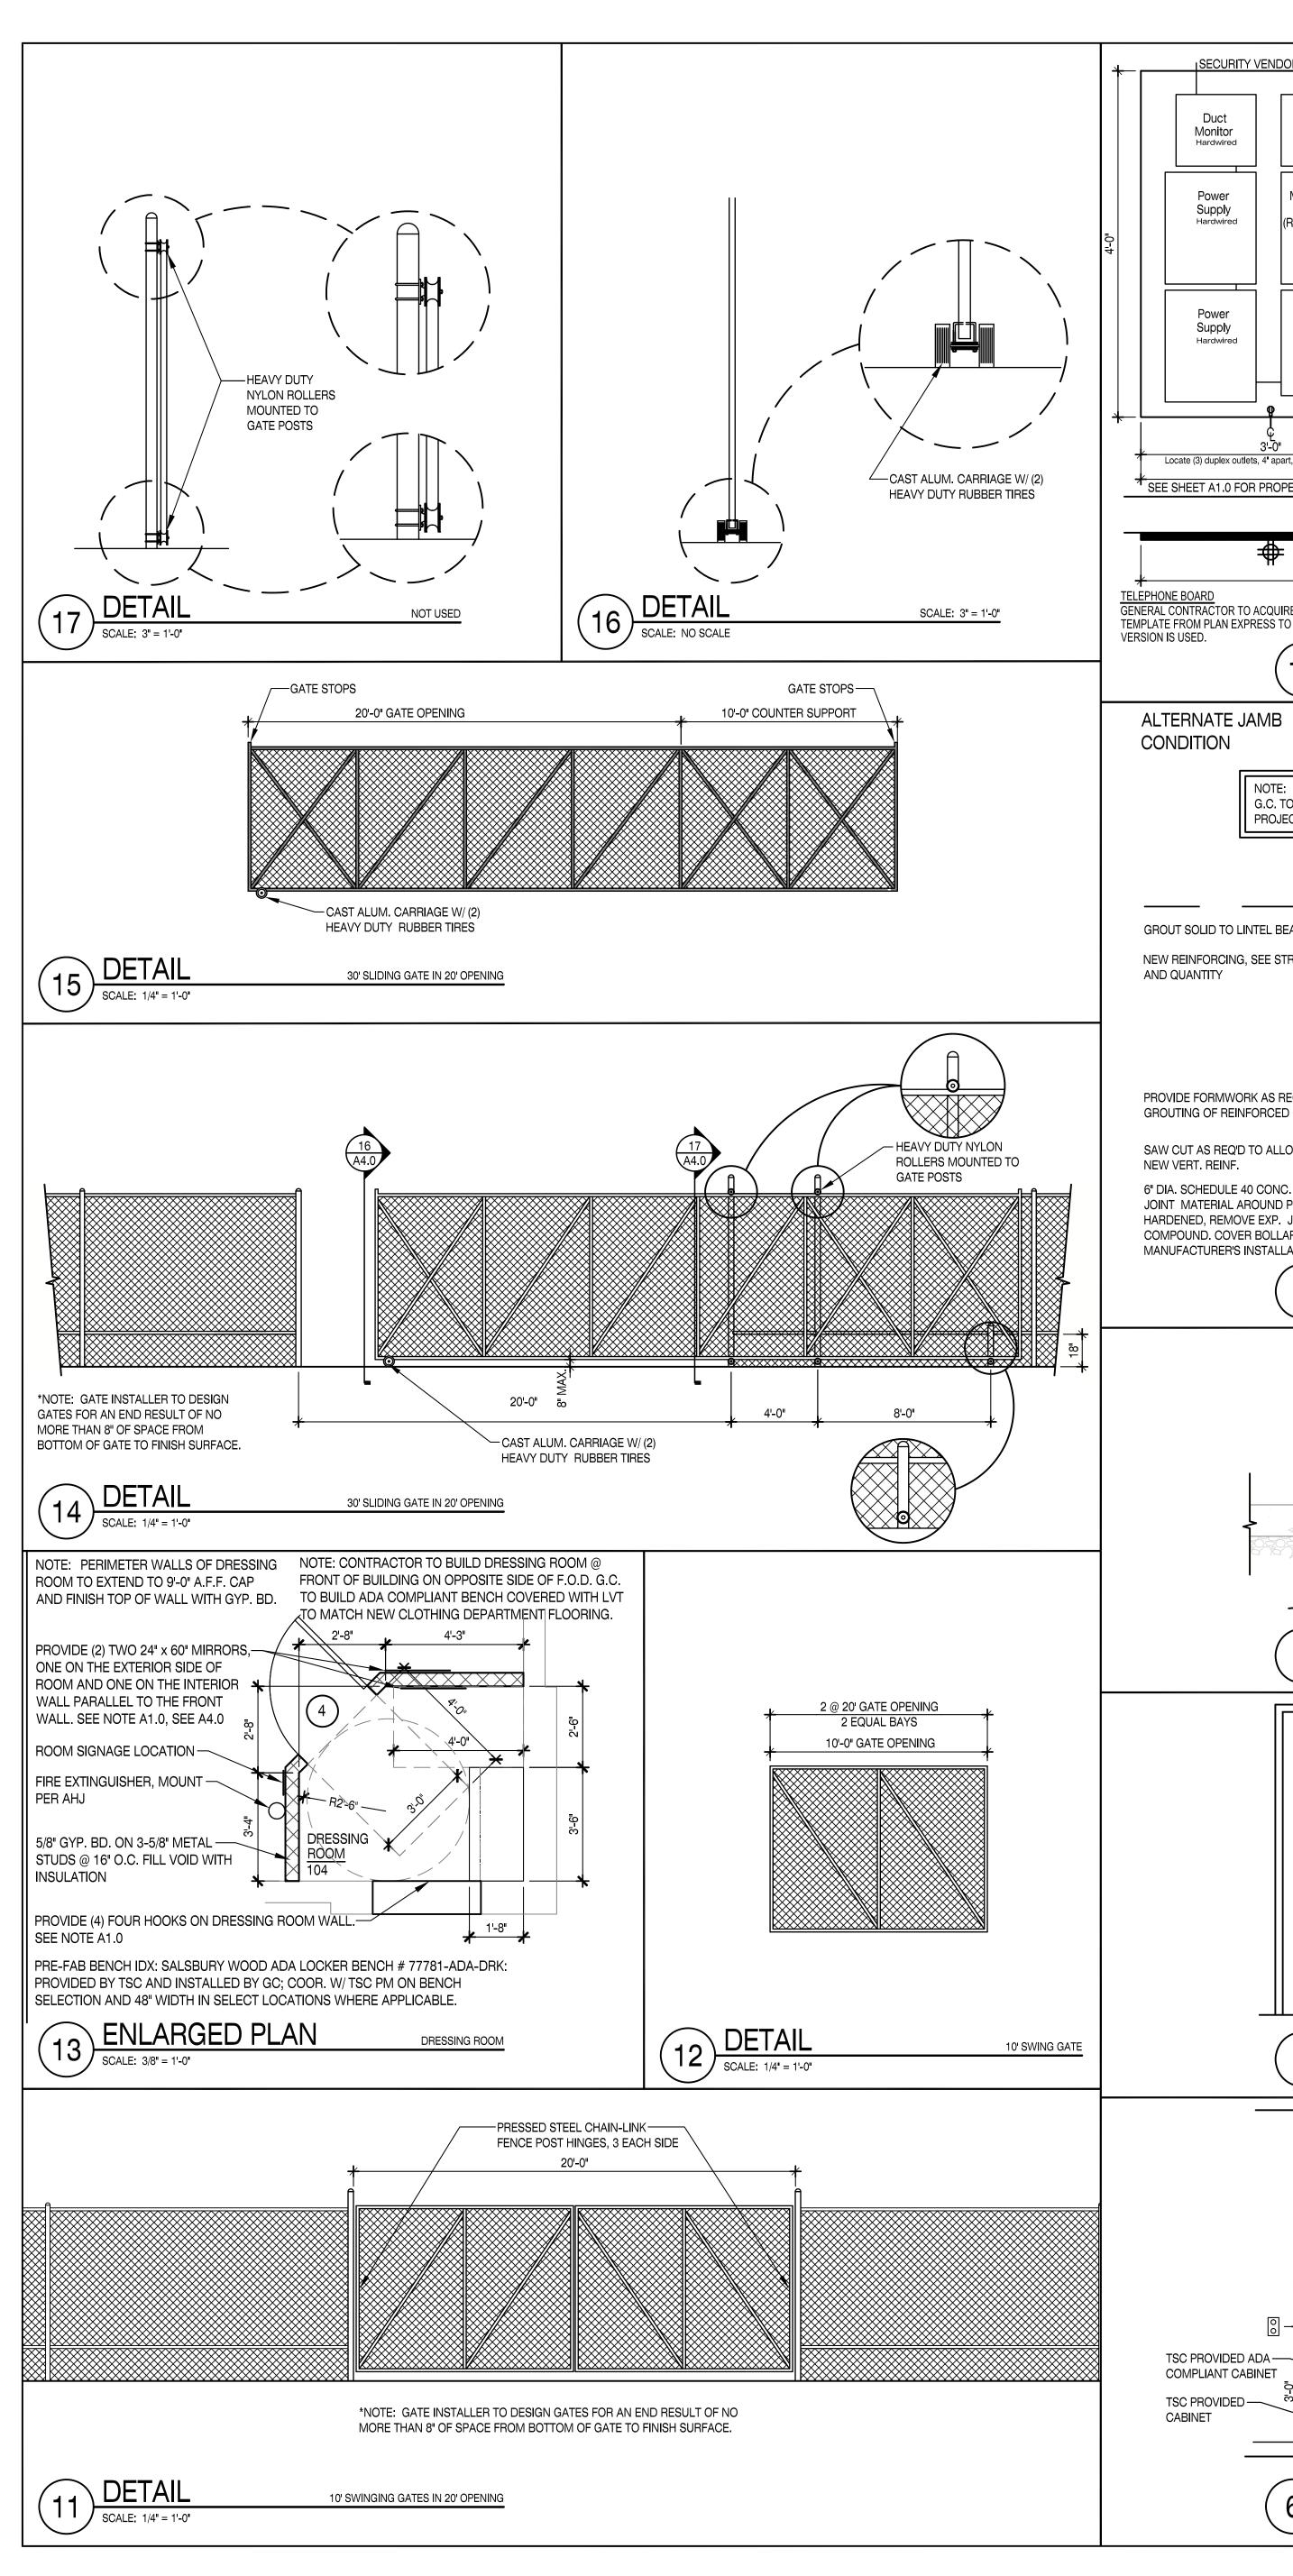
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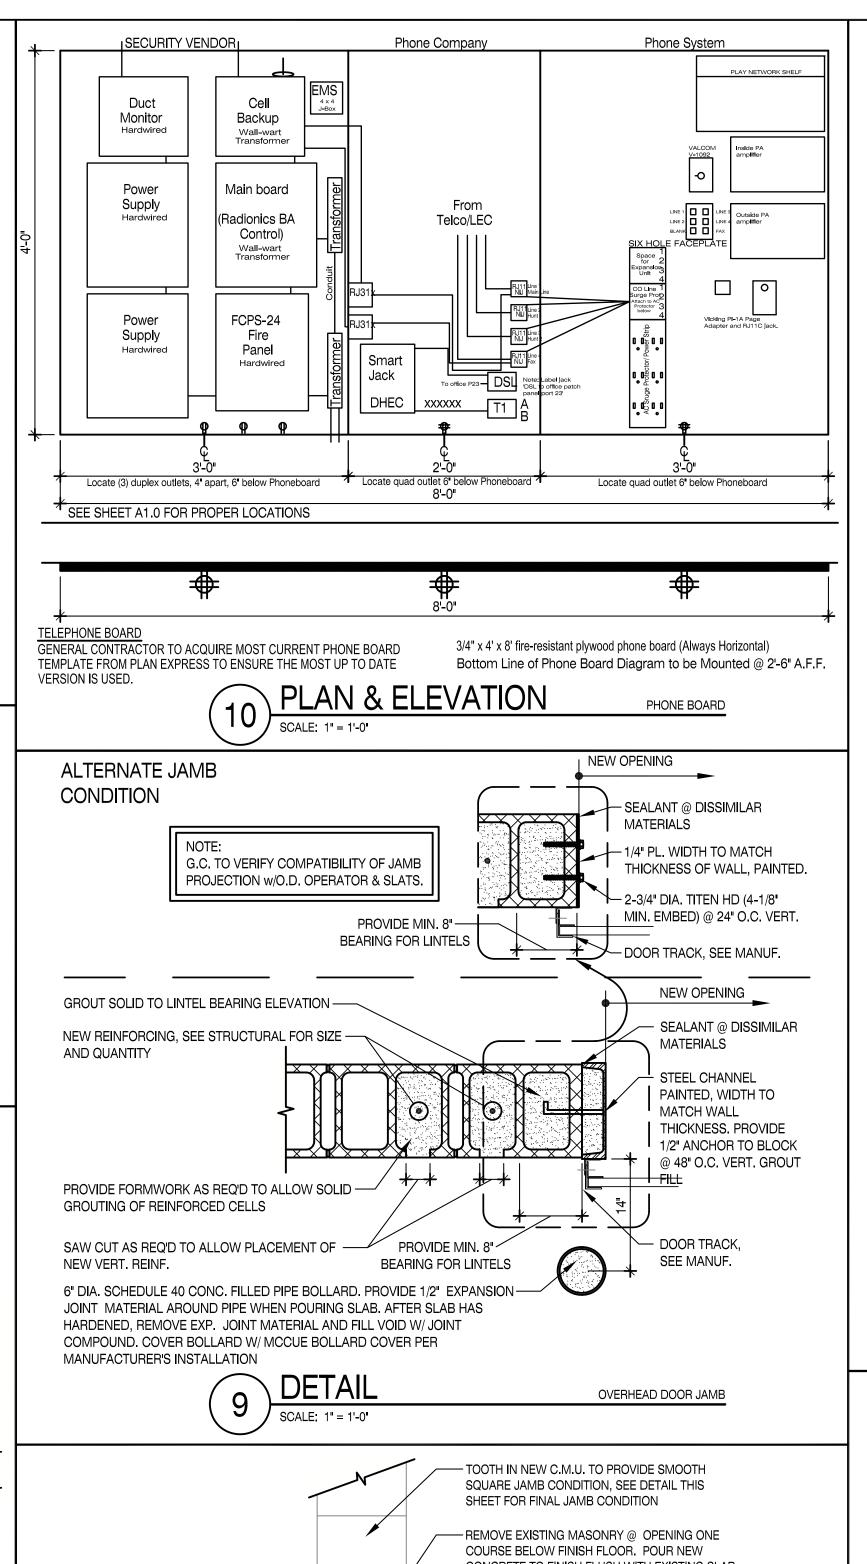
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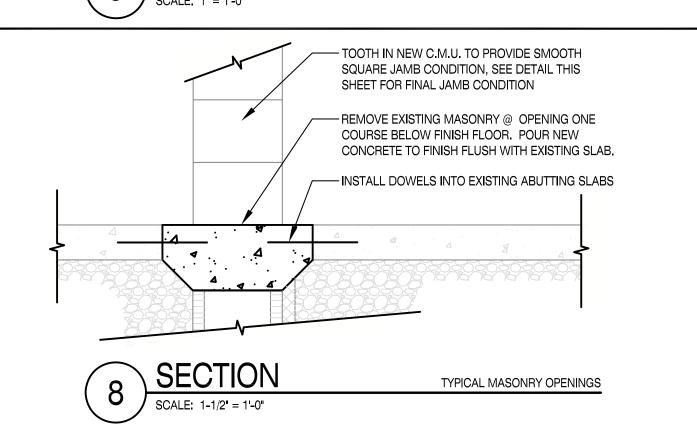
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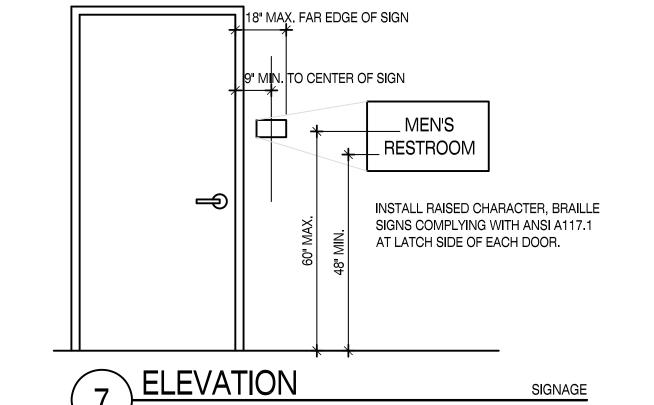
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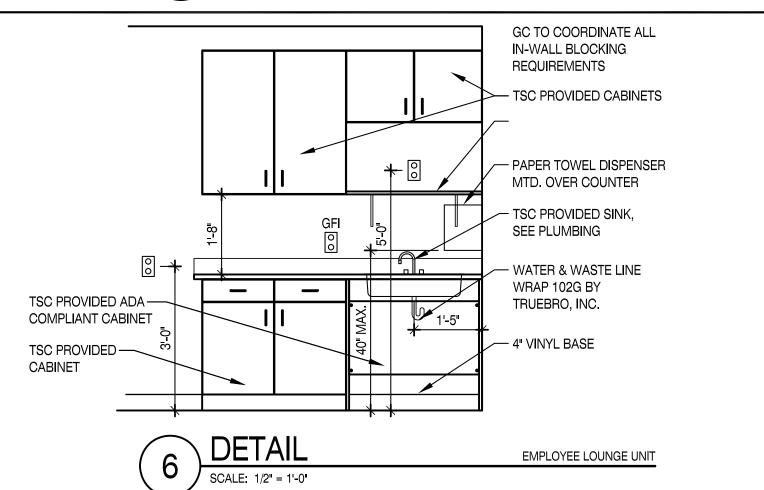
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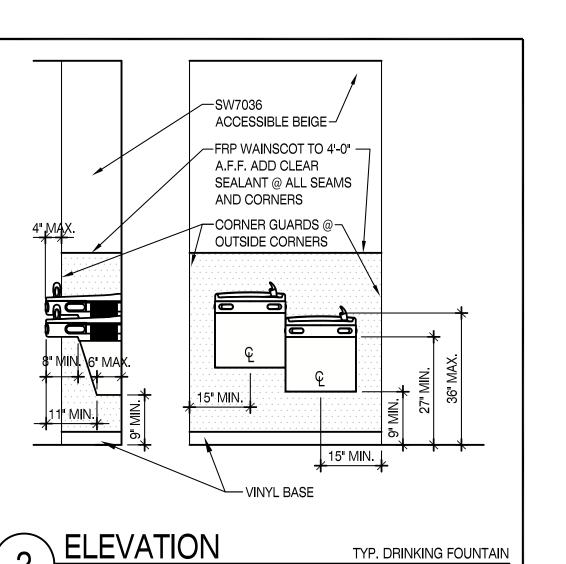













TOILET ACCESSORIES SCHEDULE

SCALE: 1/2"=1'-0"

TOILLT ACCESSOFILES SCHILDOLL					
ACCESS. NO.	TYPE	MANUFACTURER	MODEL#	MOUNTING HT.	
A	TOILET PAPER DISPENSER	F.B.O., I.B.C.			
B	GRAB BAR	BRADLEY	8320-001-18 8320-001-36 8320-001-42	39" - 41" TO BOTTOM 33" - 36" TO TOP, MAX. 33" - 36" TO TOP, MAX.	
\bigcirc	SOAP DISPENSER	F.B.O., I.B.C.		40" MAX. TO CONTROL	
0	VERDEDRI	WORLD DRYER	Q-974A	40" TO BOTTOM OF UNIT	
E	MIRROR (1/4" POLISHED PLATE GLASS) 1 PIECE			40" TO BOTTOM OF REFLECTIVE SURFACE	
F	PAPER TOWEL DISPENSER	F.B.O., I.B.C.		40" MAX. TO CONTROL	
G	SMARTDRI PLUS	WORLD DRYER	K-974P2	40" TO BOTTOM OF UNIT	
H	16" X 36" STAINLESS STEEL PANEL	F.B.C., I.B.C.		40" TO TOP OF PANEL	


ALL HAND DRYERS, SOAP DISPENSERS, MIRRORS, STAINLESS STEEL PANELS, AND GRAB BARS TO BE PROVIDED AND

- FLUSH CONTROL SHALL BE LOCATED ON THE OPEN SIDE OF THE WATER CLOSET PER ICC/ANSI 117,1 SECTION 604.6.
- FPR WAINSCOT TO 4'-0" A.F.F. ON ALL WALLS EXCEPT CMU UNLESS NOTED OTHERWISE. COLOR: XA WHITE, FINISH:
- ALL PLUMBING FIXTURES TO BE ANCHORED PER ALL ANCHOR POINTS. PROVIDE CEILING BATT INSULATION FOR RESTROOMS.
- NO BATHROOM ITEMS SHALL BE LOCATED FROM FLOOR TO CEILING WITHIN 18" OF THE EDGE OF THE PULL SIDE OF THE

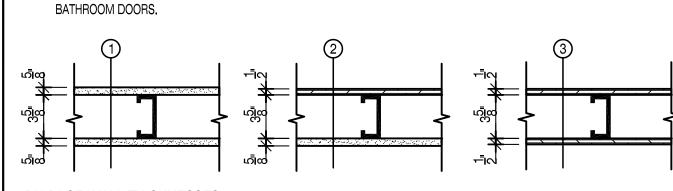

DH PACE WALL THICKNESSES

- 5/8" TYPE "X" GYP. BD. BOTH SIDES OF 3 5/8" METAL STUDS
- 5/8" TYPE "X" GYP. BD. ON CORE SIDE AND 1/2" F.R. PLYWOOD IN STOCKROOM ON 3 5/8" METAL STUDS
- 3. 1/2" F.R. PLYWOOD BOTH SIDES OF 3 5/8" METAL STUDS
- 4. 1/2" F.R. PLYWOOD BOTH SIDES OF 6" METAL STUDS

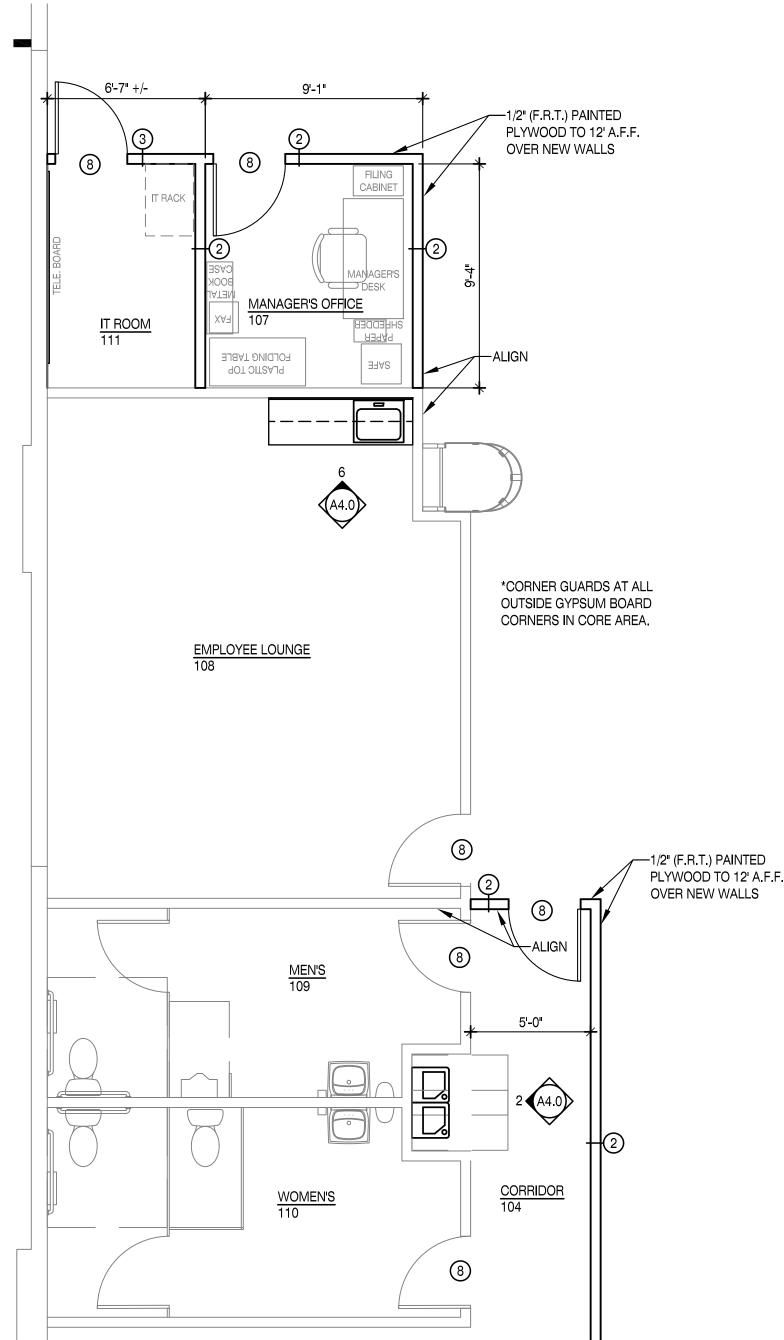

\ ENLARGED RESTROOM CORE PLAN

SCALE: 1/4"=1'-0"



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Job Number:	2195
<u>Date:</u>	03.17.2022
Revisions:	

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SCHEDULES & DETAILS

A4.0 Sheet Number: