

## REGIONAL CRITERIA

TYPICAL SINGLE TENANT BUILDING ELEVATIONS -

## PALETTE A

- 1 RUNNING BOND BRICK, NO COURSES
- 2 MODERN EXTERIOR WALL SCONCES PER STARBUCKS
- 3 LIGHT NEUTRAL TEXTURED BRICK
- 4 WARM VERTICAL WOOD
- 5 LIGHT GRAY PAINTED EIFS



Main Entrance Elevation


Patio Elevation



- typical.



Rear Elevation

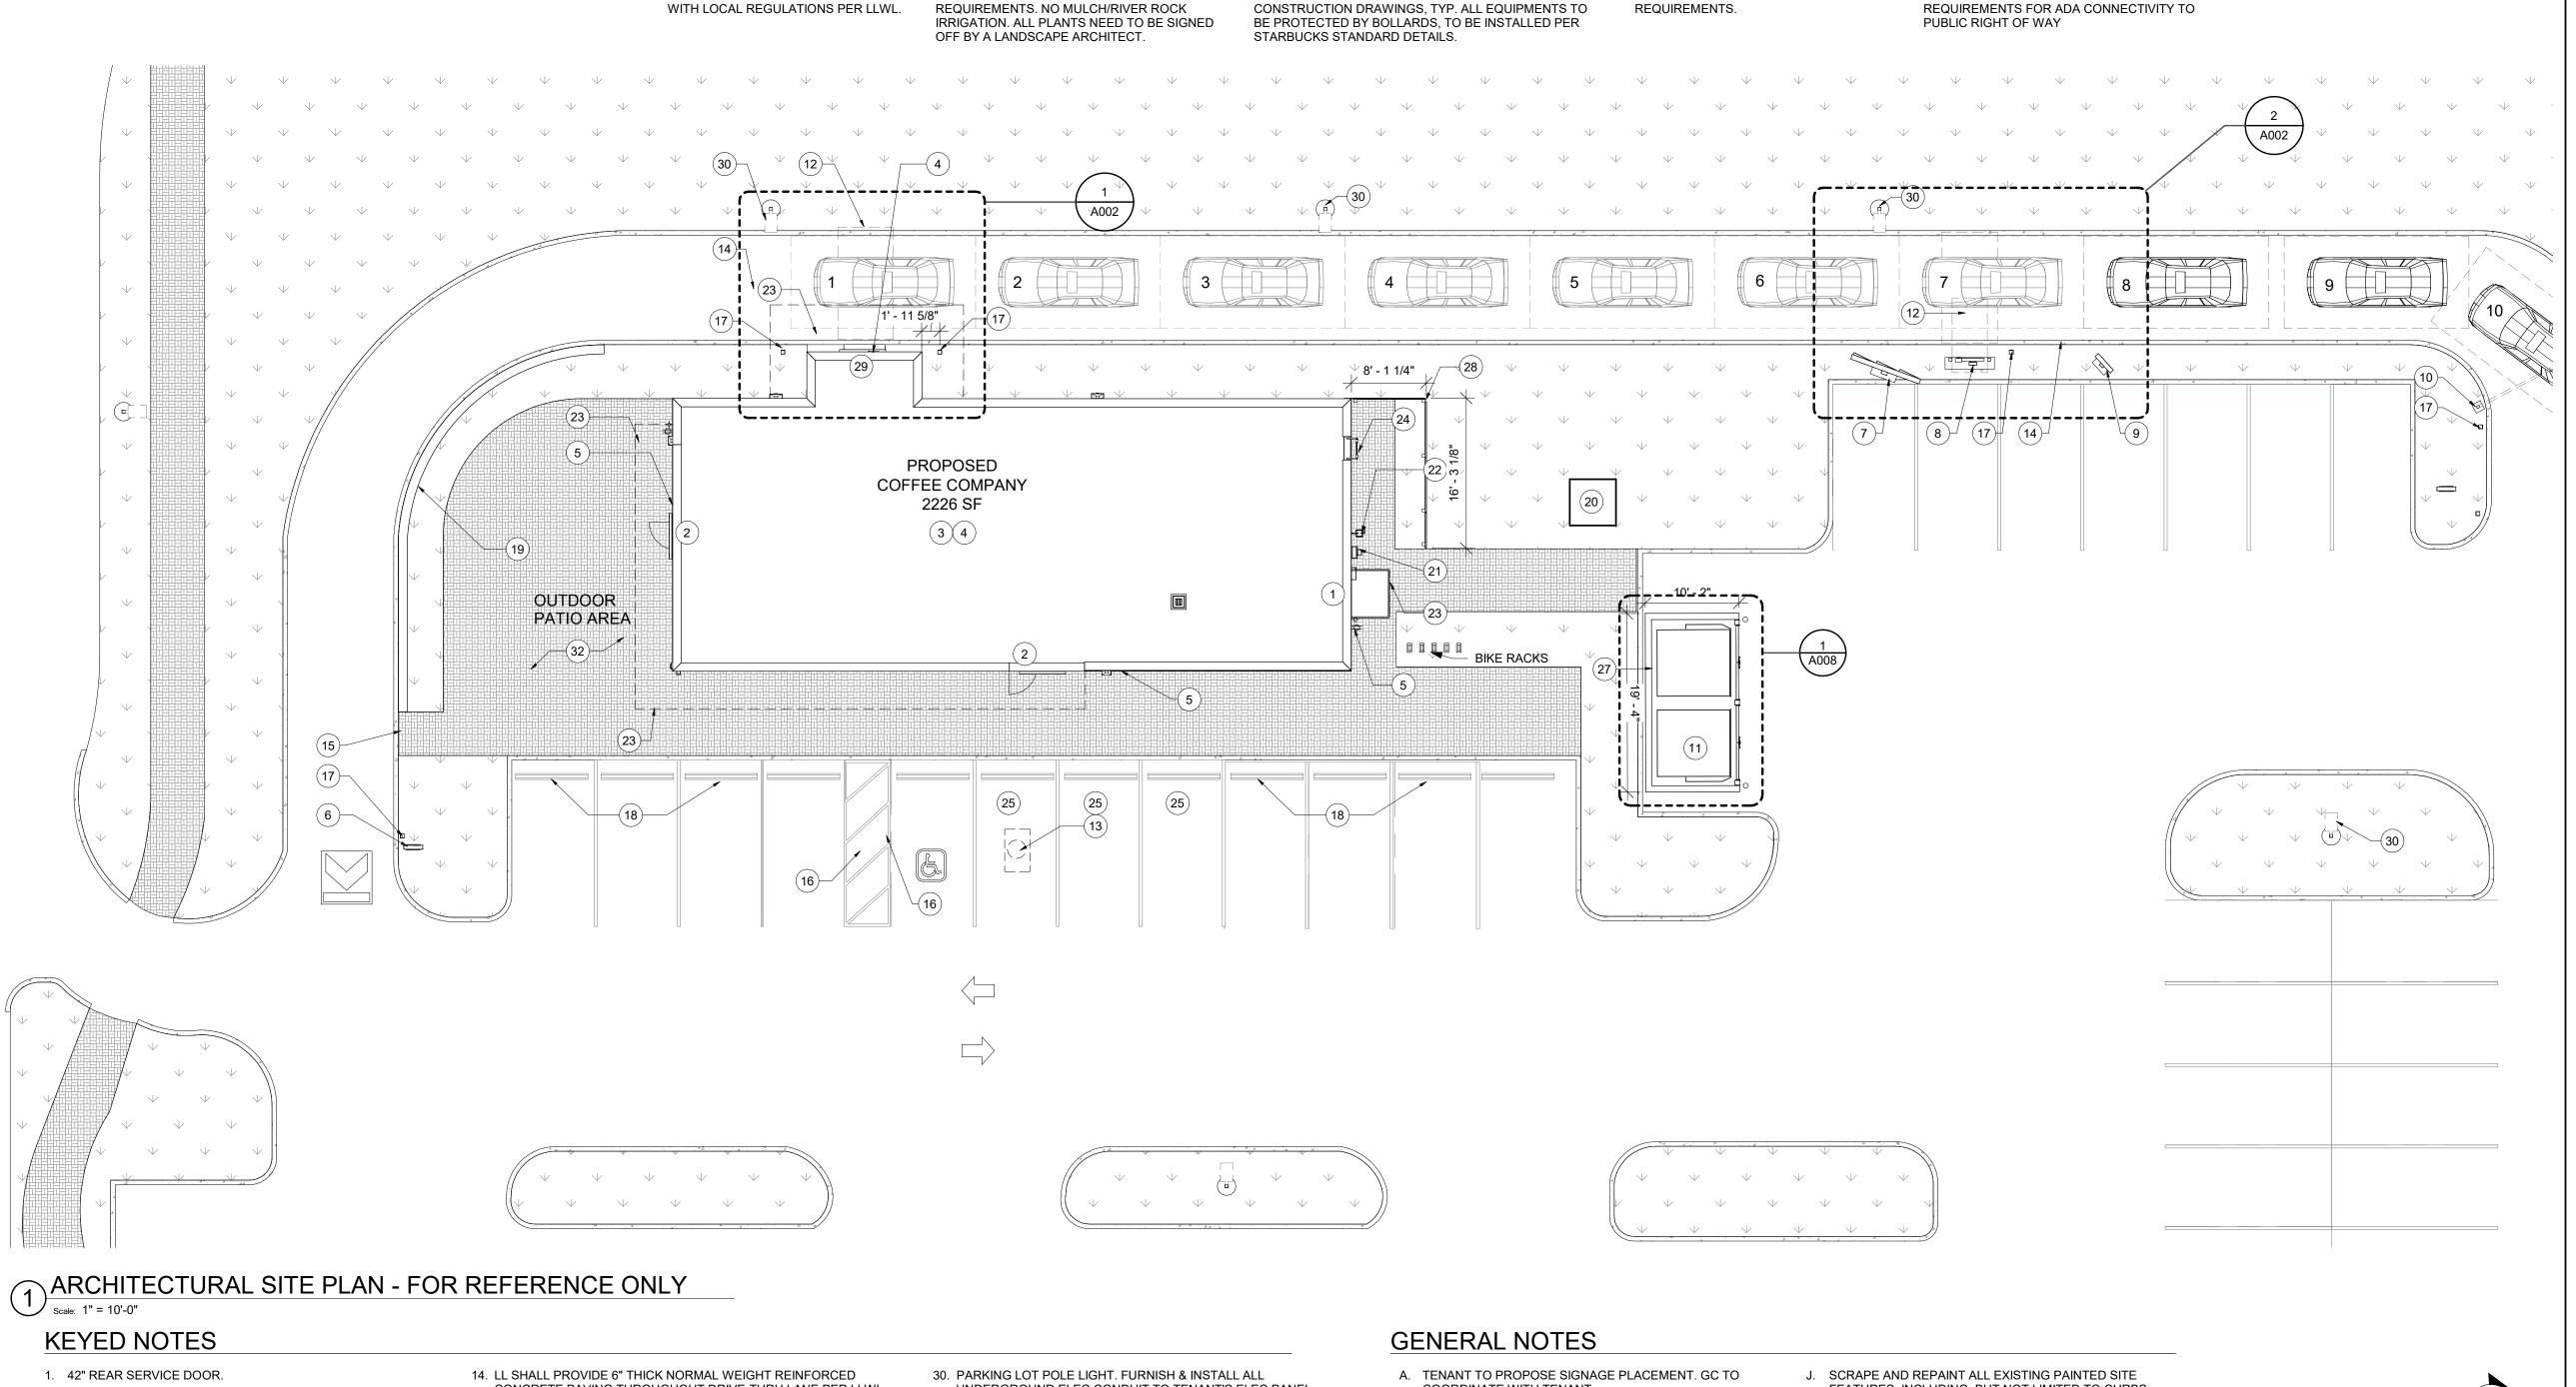

FINAL LOCATION OF ALL DT AND PARKING EQUIPMENT

TO BE COORDINATED PER STARBUCKS

LL TO PROVIDE PHOTOMETRICS PLAN PER

LLWL'S MINIMUM ILLUMINATION

LL TO PROVIDE AN ACCESSIBLE PATH OF

TRAVEL IN ACCORDANCE WITH FEDERAL

- 2. 36" STOREFRONT ENTRY DOOR.
- 3. PROVIDE PROTECTIVE BOLLARDS ON BOTH SIDES OF EXTERIOR UTILITY SERVICES ADJACENT TO VEHICULAR TRAFFIC. EXAMPLES INCLUDE FIRE STAND PIPE, GAS AND ELECTRICAL METERS, SITE TRANSFORMERS, ETC.
- 4. TENANT SIGNAGE VENDOR TO COORDINATE APPROVALS AND PERMITS FOR EXTERIOR SIGNAGE SEPARATELY AS
- 5. PROVIDE COVERED EXTERIOR ELECTRICAL OUTLETS AND HOSE BIBBS PER LANDLORD WORK LETTER. SEE EXTERIOR ELEVATIONS FOR MORE INFORMATION.
- 6. FREESTANDING ILLUMINATED DRIVE THRU 'EXIT ONLY / THANK YOU' SIGN.
- 7. 5-PANEL FREESTANDING MENU BOARD.
- 8. DIGITAL ORDER SCREEN AND CANOPY. REFER TO DOS CONTROL BOX DETAILS FOR MORE INFO.
- 9. FREESTANDING PRE-MENU BOARD.
- 10. FREESTANDING CLEARANCE BAR.
- 11. TRASH ENCLOSURE PER CIVIL PROVIDE KEYED,

DETAILS FOR MORE INFORMATION.

- FROST-FREE RECESSED HOSE BIB PER LLWL 12. INSTALL VEHICLE DETECTOR LOOP @ CENTERLINE FOR ORDER POINT & DRIVE THRU WINDOW. REFER TO SITE
- 13. GREASE TRAP LOCATION. SCHIER GB-75 GREASE TRAP SPEC PER TENANT'S VENDOR; TO BE COORDINATED.

- CONCRETE PAVING THROUGHOUT DRIVE-THRU LANE PER LLWL.
- 15. SITE STRIPING & CURB CUTS PER CIVIL.
- 16. ADA PARKING AND STRIPING.
- 17. 5" SQUARE NON-ILLUMINATED BOLLARD. REFER TO TECHNICAL SPECIFICATIONS.
- 18. CONCRETE WHEEL STOPS ALONG STOREFRONT SIDEWALK (TYP.)
- 19. 24" H X 12" W CAST IN-PLACE CONCRETE KNEEL WALL. PROVIDE OPENINGS AT GRADE FOR PROPER SITE DRAINIAGE OF PATIO.
- 20. PROPOSED TRANSFORMER LOCATION. SEE CIVIL FOR
- ADDITIONAL INFORMATION.
- 21. ELECTRICAL METER LOCATION
- 22. GAS METER LOCATION
- 23. INDICATES CANOPY ABOVE
- 24. ROOF ACCESS LADDER
- 25. "MOBILE ORDER PARKING SIGN". LL TO PROVIDE FOOTING AND POST. SIGN BY STARBUCKS, INSTALLED BY VENDOR
- 26. PYLON SIGNAGE. SEE SHEET A205 FOR DETAILS.
- 27. LL TO INSTALL MATURE LANDSCAPING TO PROVIDE SCREENING OF UTILITIES, TRANSFORMER, AND/OR EQUIPMENT. REFER TO LANDSCAPE PLAN FOR MORE INFORMATION.
- 28. UTILITY SCREEN, SEE DETAIL 3/A003.
- 29. DRIVE THRU WINDOW, AIR CURTAIN, & SHELF BY LL. REFER TO SITE DETAILS FOR MORE INFORMATION.

# UNDERGROUND ELEC CONDUIT TO TENANT'S ELEC PANEL; SEE PHOTOMETRIC PLAN ON CIVIL SHEETS FOR SPEC INFO;

31. ACCESSIBLE PATH OF TRAVEL IN ACCORDANCE WITH FEDERAL REQUIREMENTS FOR ADA CONNECTIVITY TO PUBLIC RIGHT OF WAY.

SEE SITE DETAILS FOR FOUNDATION

LL TO PROVIDE LANDSCAPE PLAN PER LLWL


AND TENANT CRITERIA PACKAGE PRESCRIBED

LL TO FURNISH AND INSTALL AN

IRRIGATION SYSTEM IN COMPLIANCE

- 32. CONCRETE PATIO WITH FLOAT TROWELED FINISH (TRAVERSE BRUSH & STEEL FINISH)
- COORDINATE WITH TENANT.
- B. LANDSCAPING TO BE PROVIDED PER ZONING CODE AND SUSTAINABILITY REQUIREMENTS.
- C. DRIVE-THRU EQUIPMENT INCLUDING VEHICLE DETECTION LOOP, WIRELESS COMMUNICATION AND MONITORS SHALL BE COORDINATED BY TENANT CONSTRUCTION MANAGER. REFER TO ELECTRICAL DRAWINGS FOR ADDITIONAL REQUIREMENTS.
- D. PROVIDE 6" (150MM) THICK CONCRETE PAVING THE LENGTH OF THE DRIVE-THRU LANE, EXTENT TO INCLUDE DRIVE-THRU ENTRY POINT THROUGH WINDOW STANDING PAD.
- E. GENERAL CONTRACTOR TO APPLY CONCRETE SEALER TO ALL EXTERIOR CONCRETE PATIO AND WALKWAY SURFACES.
- F. GENERAL CONTRACTOR TO VERIFY ALL EXISTING ELEVATIONS AND BUILDING CONDITIONS IN FIELD PRIOR TO START OF CONSTRUCTION.
- G. PROVIDE DETECTABLE WARNING (IF APPLCABLE PER LOCAL CODE) AT TRANSITION FROM SIDEWALK TO DRIVE AISLE.
- H. ACCESSIBLE PARKING SPACES AND ACCESS AISLES SHALL HAVE SURFACE SLOPE NOT TO EXCEED 2% IN ALL DIRECTIONS.
- I. REFER TO ELECTRICAL DRAWINGS FOR SITE RELATED ELECTRICAL WORK.

- FEATURES, INCLUDING, BUT NOT LIMITED TO CURBS, BOLLARDS, RAILINGS AND SITE LIGHTING BASES.
- K. SEE SHEET A002 FOR ARCHITECTURAL SITE DETAILS.

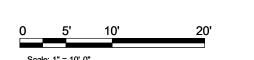



NOTE: SITE PLAN PREPARED IN REFERENCE TO THE LANDLORD CIVIL PLAN RECEIVED: 10/11/2021

NOTE: ALL SIGNAGE UNDER SEPARATE PERMIT, SHOWN FOR COORDINATION PURPOSES ONLY.

LEGEND

NEW CONCRETE DRIVE THRU LANE

PROJECT

NORR PROJECT NO.: NICH20-0161

## ROCHESTER, MI FUTURE COFFEE SHOP

ADAMS ROAD ROCHESTER, MI

DEVELOPER

ROBERT B. AIKENS AND ASSOCIATES 350 N. OLD WOODWARD SUITE 300 BIRMINGHAM, MI 48009

ARCHITECT

# **NORR**

(248) 283-2387

325 North La Salle Street, Suite 500 Chicago, Illinois 60654

## STRUCTURAL ENGINEER

CASE ENGINEERING INC. 796 Merus Court St. Louis, MO 63026 [636] 349.1600

MEP ENGINEER

CASE ENGINEERING INC. 796 Merus Court St. Louis, MO 63026 [636] 349.1600

CIVIL ENGINEER

SPICER GROUP 230 S. Washington Ave. Saginaw, MI 48607 [989] 754.4440

NOTES

This drawing has been prepared solely for the use of the client, and there are no representations of any kind made by NORR to any party with whom NORR has not entered into a contract.


SHEET INFORMATION
ISSUES / REVISIONS

DESCRIPTION 01/2X/2022 20% SHELL CD SET

SHEET TITLE

ARCHITECTURAL SITE PLAN

SHEET NUMBER

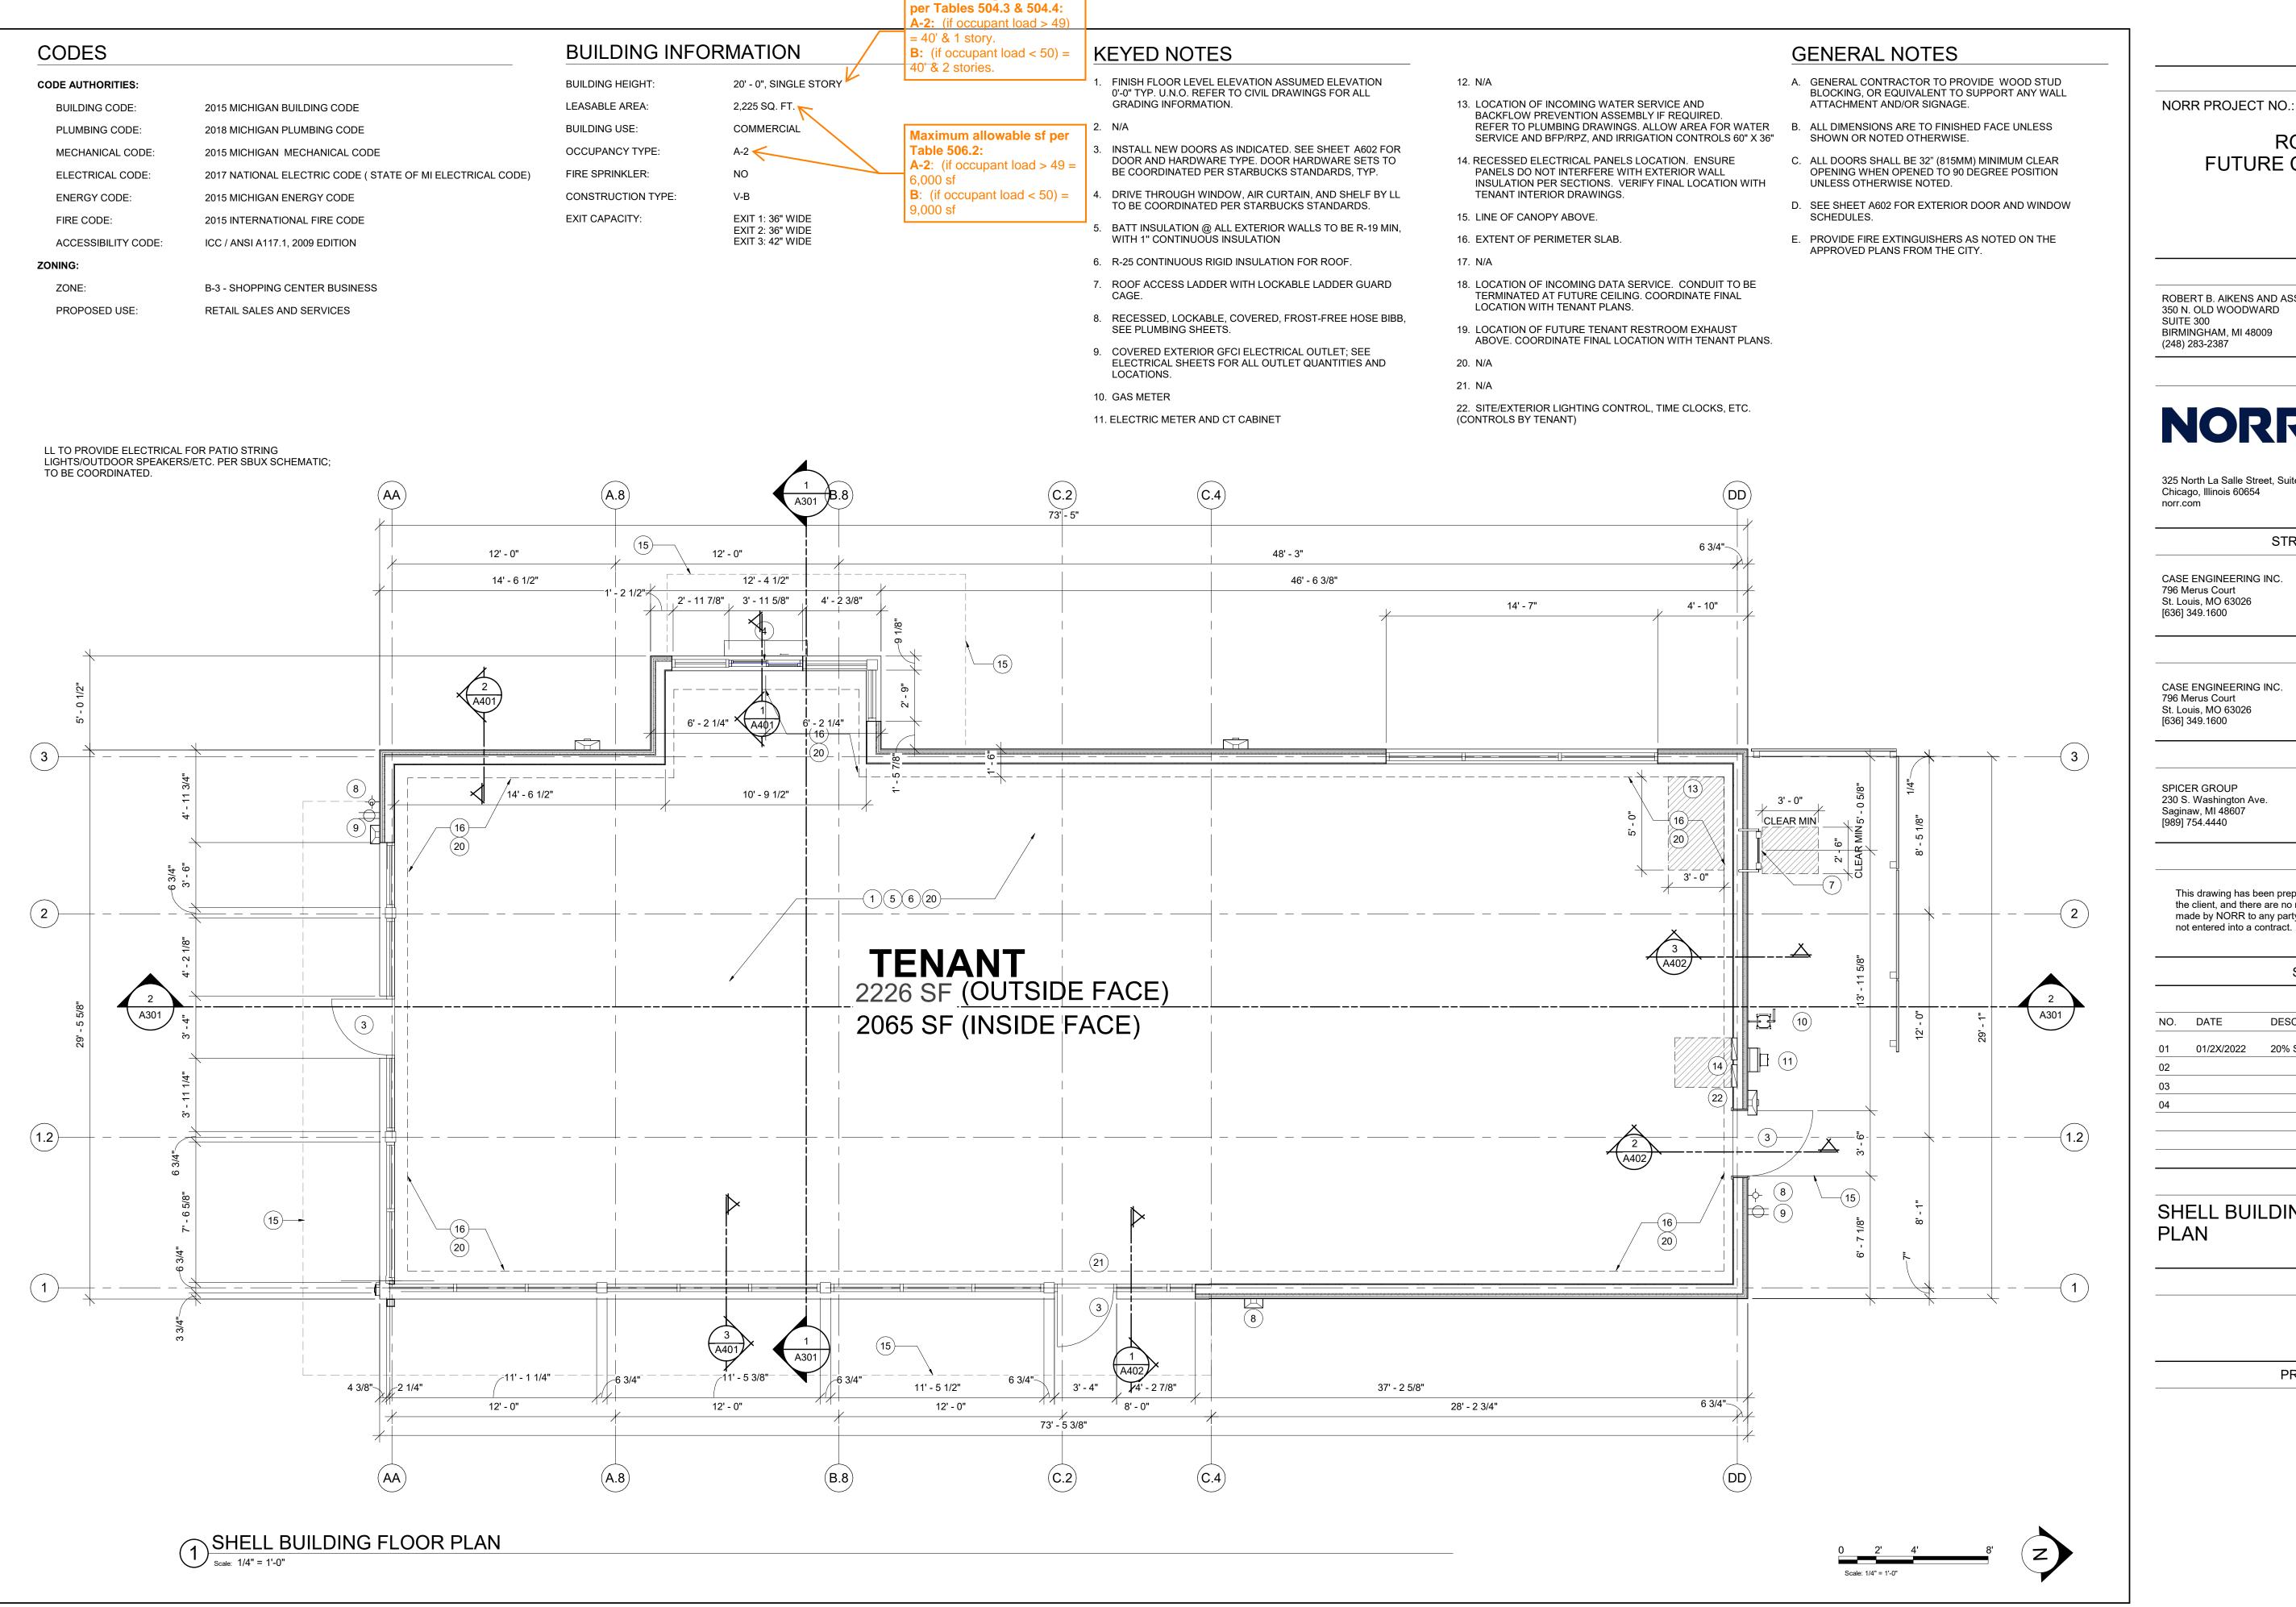

Maximum height & stories

DEVELOPER

ADAMS ROAD

ROCHESTER, MI

ROBERT B. AIKENS AND ASSOCIATES 350 N. OLD WOODWARD SUITE 300 BIRMINGHAM, MI 48009

ARCHITECT

PROJECT

NICH20-0161

ROCHESTER, MI

FUTURE COFFEE SHOP

# **NORR**

325 North La Salle Street, Suite 500 Chicago, Illinois 60654

STRUCTURAL ENGINEER

CASE ENGINEERING INC. 796 Merus Court St. Louis, MO 63026

MEP ENGINEER

CASE ENGINEERING INC. 796 Merus Court St. Louis, MO 63026 [636] 349.1600

CIVIL ENGINEER

SPICER GROUP 230 S. Washington Ave. Saginaw, MI 48607 [989] 754.4440

NOTES

This drawing has been prepared solely for the use of the client, and there are no representations of any kind made by NORR to any party with whom NORR has not entered into a contract.

> SHEET INFORMATION ISSUES / REVISIONS DESCRIPTION


01/2X/2022 20% SHELL CD SET


SHEET TITLE

## SHELL BUILDING FLOOR PLAN

SHEET NUMBER

A100

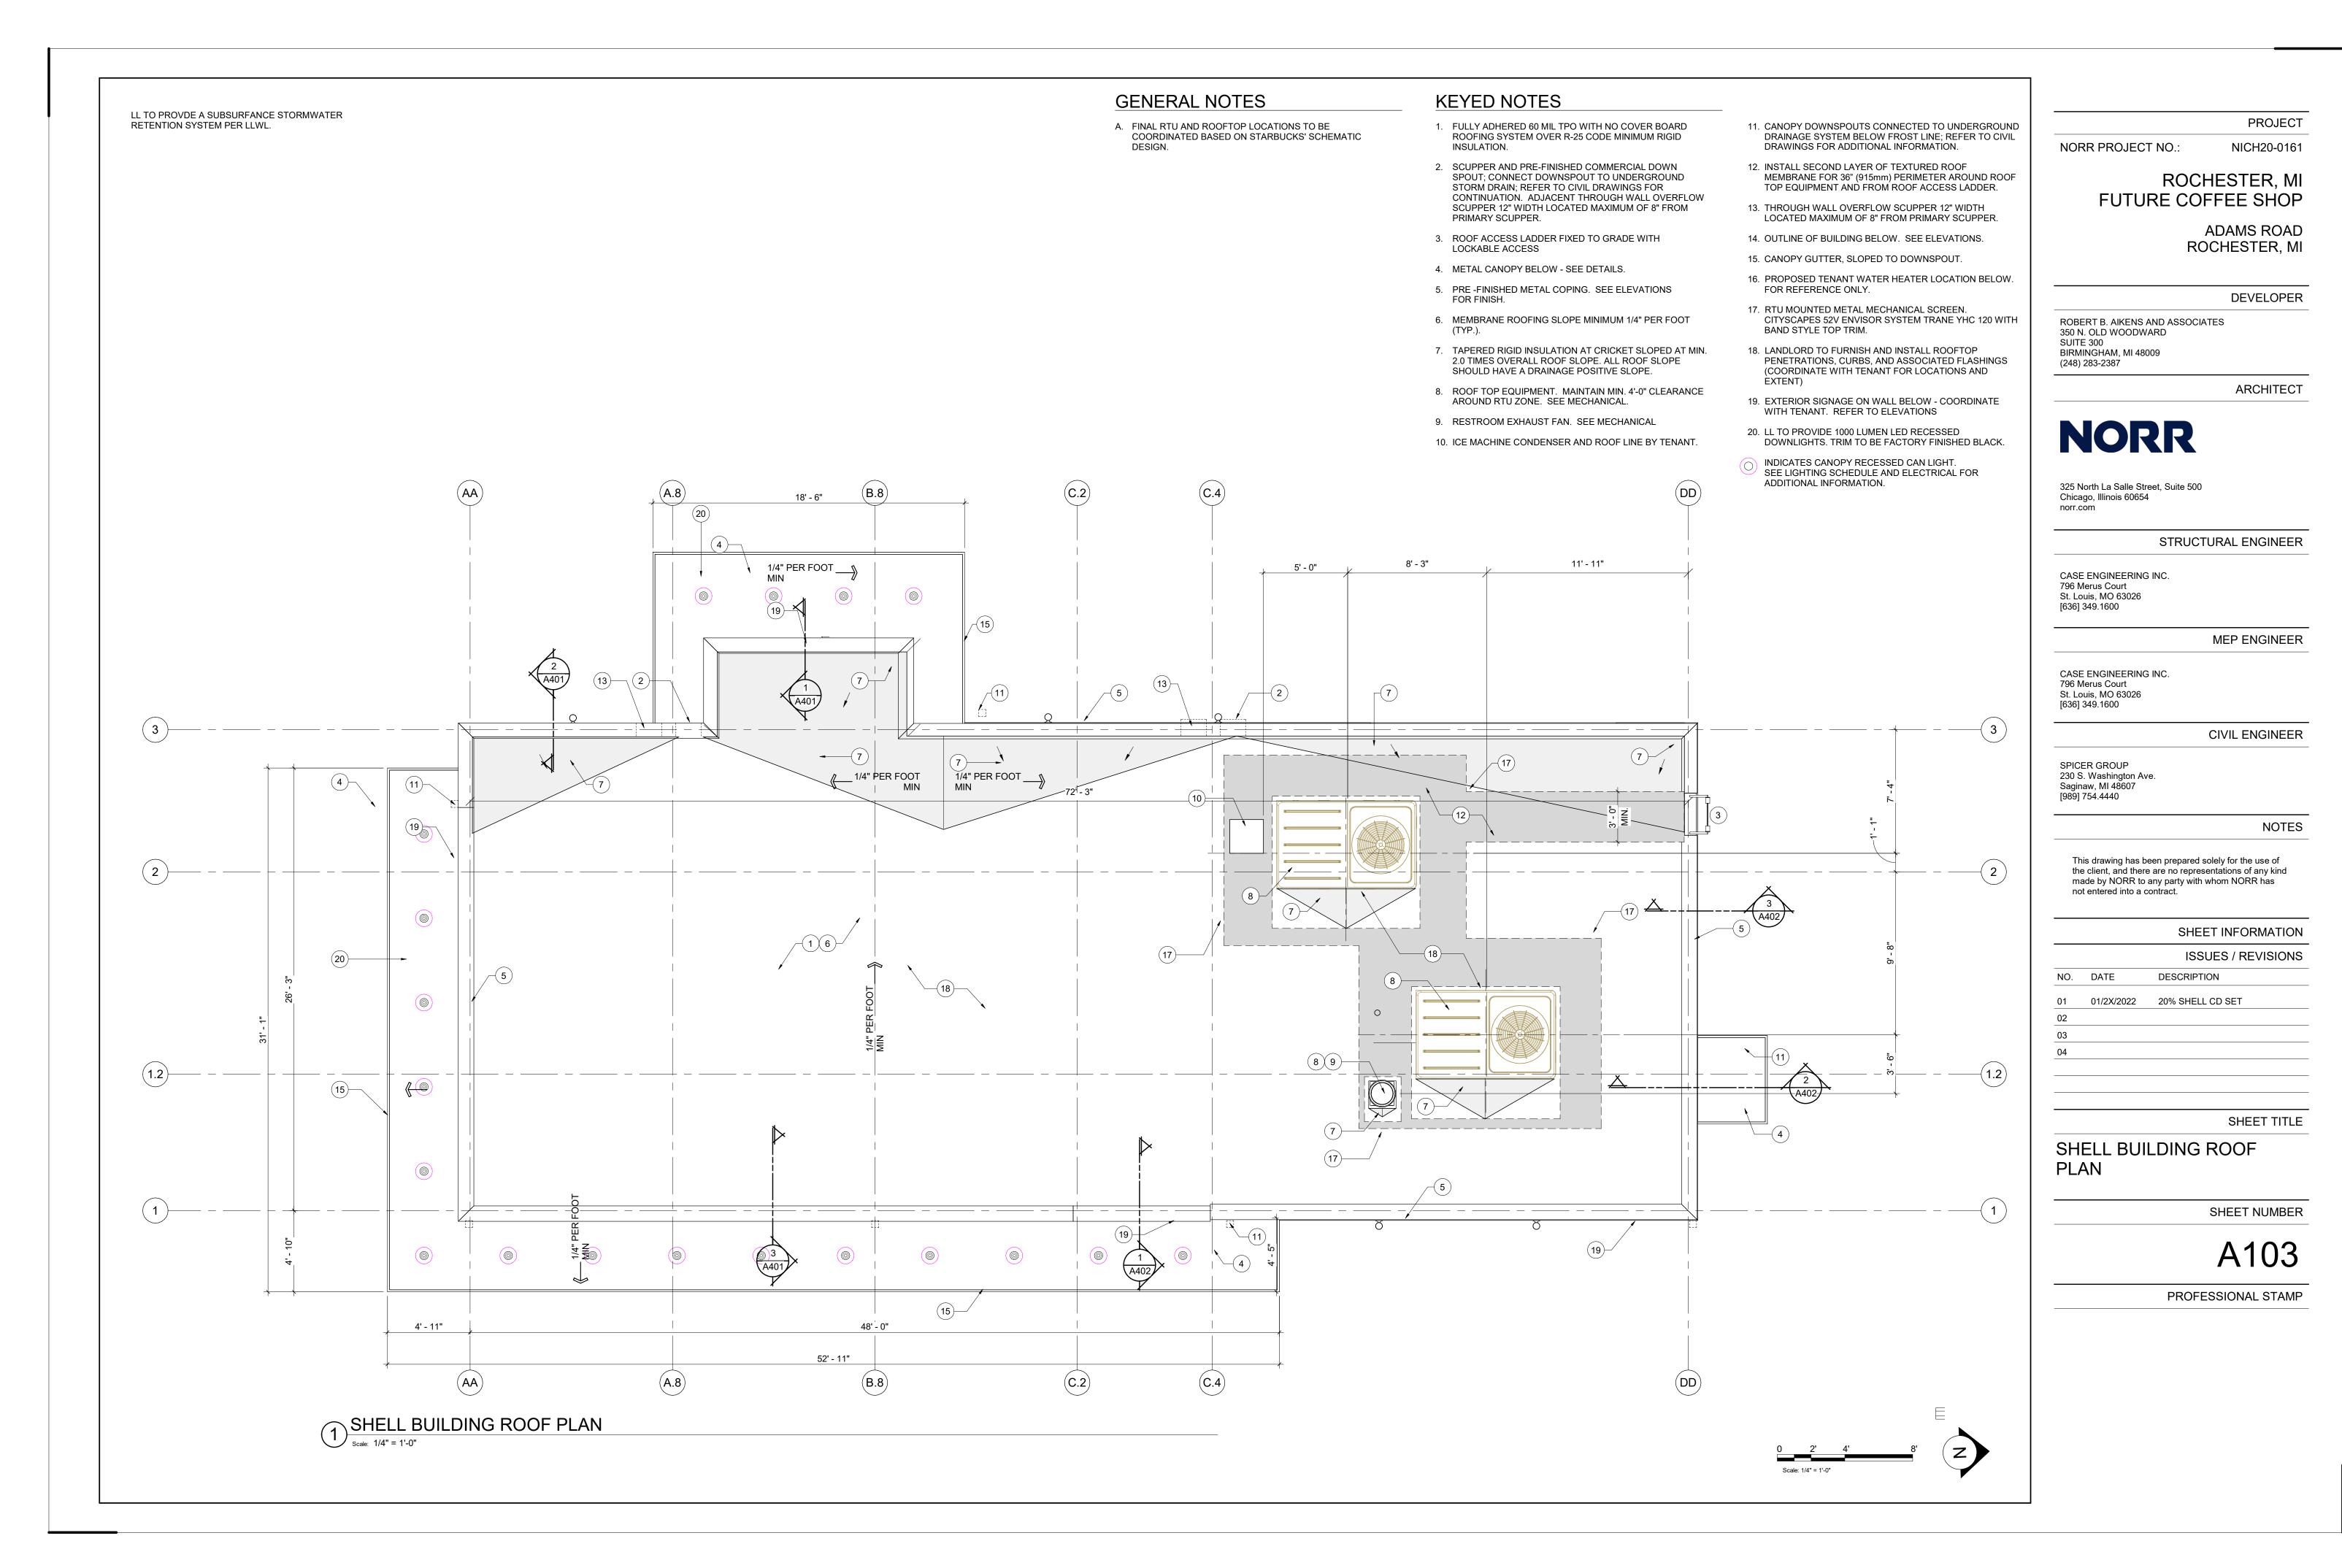

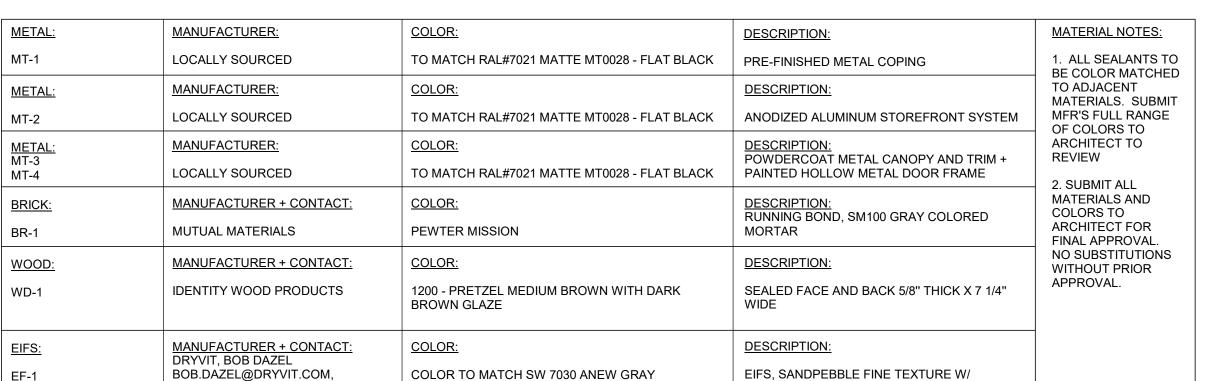


STRATOTONE COLORANT

734.276.0404



PALETTE A

FINAL SIGNAGE LOCATIONS TO BE CONFIRMED AND COORDINATED PER STARBUCKS VENDOR'S SIGNAGE PACKAGE.

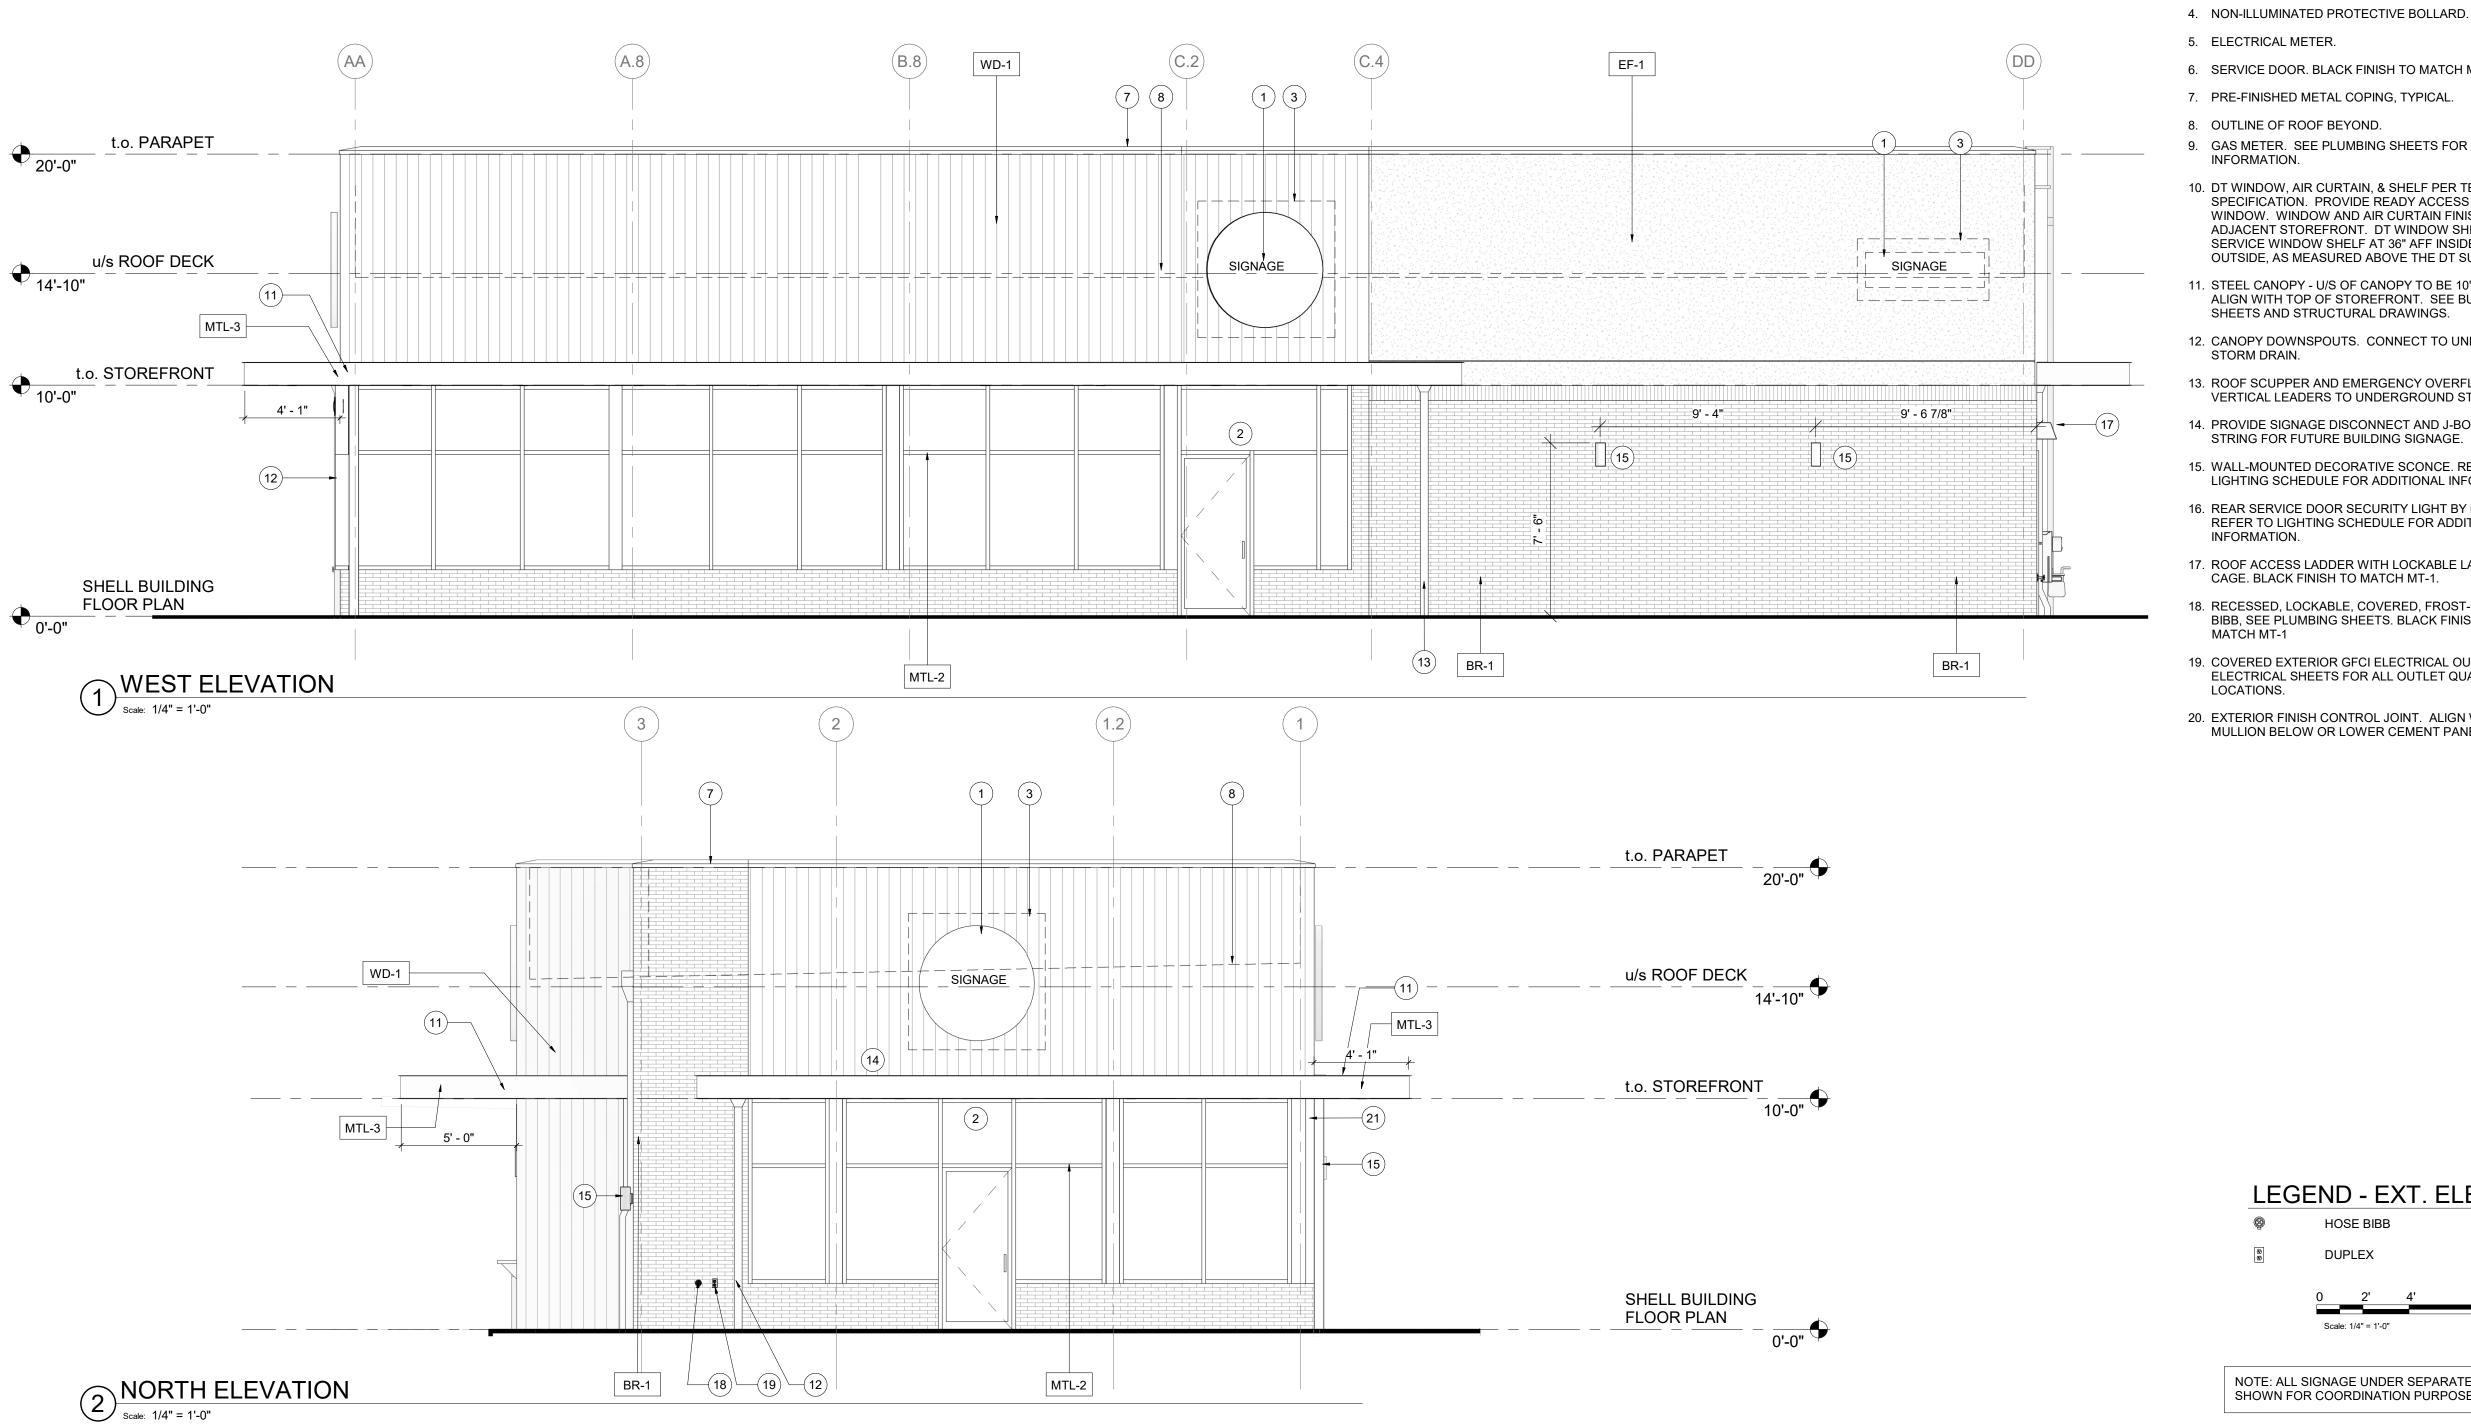

## **GENERAL NOTES**

- A. GENERAL CONTRACTOR SHALL COORDINATE WITH ELECTRICAL CONTRACTOR TO FURNISH AND INSTALL ELECTRICAL CIRCUITS INCLUDING ALL CONDUIT, WIRE, CONNECTIONS AND BREAKER AT PANEL BOARD NECESSARY TO SERVE SIGNAGE.
- B. GENERAL CONTRACTOR TO PROVIDE FIRE TREATED WOOD STUD BLOCKING OR EQUIVALENT TO SUPPORT SIGNAGE. GC TO CORRDINATE FINAL LOCATIONS WITH TENANT AND TENANT SIGNAGE VENDOR.
- C. FINAL SIGNAGE TO BE CONFIRMED AND COORDINATED PER STARBUCKS VENDOR'S SIGNAGE PACKAGE.

## **KEYED NOTES**

- 1. TENANT SIGNAGE VENDOR TO COORDINATE APPROVALS AND PERMITS FOR EXTERIOR SIGNAGE SEPARATELY AS REQUIRED. FINAL LOCATIONS TO BE COORDINATED PER TENANT'S SIGNAGE PACKAGE.
- 2. INSTALL 3" (75MM) HIGH BLACK ACRYLIC STORE ADDRESS ON GLAZING ABOVE MAIN ENTRY DOOR OR PER LOCAL JURISDICTIONAL CODE REQUIREMENTS.
- 3. 3/4" MARINE GRADE PLYWOOD BLOCKING FOR EXTERIOR SIGNAGE. EXTEND BLOCKING 8" (205MM) MIN. BEYOND
- EDGE OF SIGNAGE.
- ELECTRICAL METER.
- 6. SERVICE DOOR. BLACK FINISH TO MATCH MT-4.
- 7. PRE-FINISHED METAL COPING, TYPICAL.
- 8. OUTLINE OF ROOF BEYOND.
- 9. GAS METER. SEE PLUMBING SHEETS FOR ADDITIONAL INFORMATION.
- 10. DT WINDOW, AIR CURTAIN, & SHELF PER TENANT SPECIFICATION. PROVIDE READY ACCESS DT SERVICE WINDOW. WINDOW AND AIR CURTAIN FINISH TO MATCH ADJACENT STOREFRONT. DT WINDOW SHELF: INSTALL SERVICE WINDOW SHELF AT 36" AFF INSIDE AND 42" AFF OUTSIDE, AS MEASURED ABOVE THE DT SURFACE
- 11. STEEL CANOPY U/S OF CANOPY TO BE 10'-0" AFF AND TO ALIGN WITH TOP OF STOREFRONT. SEE BUILDING DETAIL SHEETS AND STRUCTURAL DRAWINGS.
- 12. CANOPY DOWNSPOUTS. CONNECT TO UNDERGROUND
- 13. ROOF SCUPPER AND EMERGENCY OVERFLOW. CONNECT VERTICAL LEADERS TO UNDERGROUND STORM DRAIN.
- 14. PROVIDE SIGNAGE DISCONNECT AND J-BOX W/ PULL STRING FOR FUTURE BUILDING SIGNAGE.
- 15. WALL-MOUNTED DECORATIVE SCONCE. REFER TO LIGHTING SCHEDULE FOR ADDITIONAL INFORMATION.
- 16. REAR SERVICE DOOR SECURITY LIGHT BY LANDLORD REFER TO LIGHTING SCHEDULE FOR ADDITIONAL INFORMATION.

MATCH MT-1

- 17. ROOF ACCESS LADDER WITH LOCKABLE LADDER GUARD CAGE. BLACK FINISH TO MATCH MT-1.
- 18. RECESSED, LOCKABLE, COVERED, FROST-FREE HOSE BIBB, SEE PLUMBING SHEETS. BLACK FINISH TO
- 19. COVERED EXTERIOR GFCI ELECTRICAL OUTLET; SEE ELECTRICAL SHEETS FOR ALL OUTLET QUANTITIES AND LOCATIONS.
- 20. EXTERIOR FINISH CONTROL JOINT. ALIGN WITH VERTICAL MULLION BELOW OR LOWER CEMENT PANEL JOIN BELOW.

LEGEND - EXT. ELEV.

NOTE: ALL SIGNAGE UNDER SEPARATE PERMIT, SHOWN FOR COORDINATION PURPOSES ONLY.

HOSE BIBB

DUPLEX

PROJECT

NICH20-0161

NORR PROJECT NO.:

ROCHESTER, MI FUTURE COFFEE SHOP

> ADAMS ROAD ROCHESTER, MI

> > DEVELOPER

ROBERT B. AIKENS AND ASSOCIATES 350 N. OLD WOODWARD SUITE 300 BIRMINGHAM, MI 48009

ARCHITECT

# **NORR**

(248) 283-2387

325 North La Salle Street, Suite 500 Chicago, Illinois 60654

STRUCTURAL ENGINEER

CASE ENGINEERING INC. 796 Merus Court St. Louis, MO 63026 [636] 349.1600

MEP ENGINEER

CASE ENGINEERING INC. 796 Merus Court St. Louis, MO 63026 [636] 349.1600

CIVIL ENGINEER

SPICER GROUP 230 S. Washington Ave. Saginaw, MI 48607 [989] 754.4440

NOTES

This drawing has been prepared solely for the use of the client, and there are no representations of any kind made by NORR to any party with whom NORR has not entered into a contract.

SHEET INFORMATION ISSUES / REVISIONS DESCRIPTION 01/2X/2022 20% SHELL CD SET

SHEET TITLE

## **BUILDING EXTERIOR ELEVATIONS**

SHEET NUMBER

A201

METAL:	MANUFACTURER:	COLOR:	DESCRIPTION:	MATERIAL NOTES:
MT-1	LOCALLY SOURCED	TO MATCH RAL#7021 MATTE MT0028 - FLAT BLACK	PRE-FINISHED METAL COPING	1. ALL SEALANTS TO BE COLOR MATCHED
METAL:	MANUFACTURER:	COLOR:	DESCRIPTION:	TO ADJACENT MATERIALS. SUBMIT
MT-2	LOCALLY SOURCED	TO MATCH RAL#7021 MATTE MT0028 - FLAT BLACK	ANODIZED ALUMINUM STOREFRONT SYSTEM	MFR'S FULL RANGE OF COLORS TO
METAL: MT-3	MANUFACTURER:	COLOR:	DESCRIPTION: POWDERCOAT METAL CANOPY AND TRIM +	ARCHITECT TO REVIEW
MT-4	LOCALLY SOURCED	TO MATCH RAL#7021 MATTE MT0028 - FLAT BLACK	PAINTED HOLLOW METAL DOOR FRAME	2. SUBMIT ALL
BRICK:	MANUFACTURER + CONTACT:	COLOR:	DESCRIPTION: RUNNING BOND, SM100 GRAY COLORED	MATERIALS AND COLORS TO
BR-1	MUTUAL MATERIALS	PEWTER MISSION	MORTAR	ARCHITECT FOR FINAL APPROVAL.
WOOD:	MANUFACTURER + CONTACT:	COLOR:	DESCRIPTION:	NO SUBSTITUTIONS WITHOUT PRIOR
WD-1	IDENTITY WOOD PRODUCTS	1200 - PRETZEL MEDIUM BROWN WITH DARK BROWN GLAZE	SEALED FACE AND BACK 5/8" THICK X 7 1/4" WIDE	APPROVAL.
EIFS:	MANUFACTURER + CONTACT: DRYVIT, BOB DAZEL	COLOR:	DESCRIPTION:	
EF-1	BOB.DAZEL@DRYVIT.COM, 734.276.0404	COLOR TO MATCH SW 7030 ANEW GRAY	EIFS, SANDPEBBLE FINE TEXTURE W/ STRATOTONE COLORANT	



FINAL SIGNAGE LOCATIONS TO BE CONFIRMED AND COORDINATED PER STARBUCKS VENDOR'S SIGNAGE PACKAGE.

# 1 12 EF1 2 3 WD-1 Lo. PARAPET 20'-0" Wis ROOF DECK 14'-10" WINTLS Lo. STOREFRONT 10'-0" SHELL BUILDING FLOOR PLAN 0'-0"

## GENERAL NOTES

- A. GENERAL CONTRACTOR SHALL COORDINATE WITH ELECTRICAL CONTRACTOR TO FURNISH AND INSTALL ELECTRICAL CIRCUITS INCLUDING ALL CONDUIT, WIRE, CONNECTIONS AND BREAKER AT PANEL BOARD NECESSARY TO SERVE SIGNAGE.
- B. GENERAL CONTRACTOR TO PROVIDE FIRE TREATED WOOD STUD BLOCKING OR EQUIVALENT TO SUPPORT SIGNAGE. GC TO CORRDINATE FINAL LOCATIONS WITH TENANT AND TENANT SIGNAGE VENDOR.
- C. FINAL SIGNAGE LOCATIONS TO BE CONFIRMED AND COORDINATED PER STARBUCK VENDOR'S SIGNAGE PACKAGE.

## **KEYED NOTES**

- 1. TENANT SIGNAGE VENDOR TO COORDINATE APPROVALS AND PERMITS FOR EXTERIOR SIGNAGE SEPARATELY AS REQUIRED. FINAL LOCATIONS TO BE COORDINATED PER TENANT'S SIGNAGE PACKAGE.
- EXTERIOR FINISH CONTROL JOINT. ALIGN WITH VERTICAL MULLION BELOW OR LOWER CEMENT PANEL JOIN BELOW.
- 3. 3/4" MARINE GRADE PLYWOOD BLOCKING FOR EXTERIOR SIGNAGE. EXTEND BLOCKING 8" (205MM) MIN. BEYOND EDGE OF SIGNAGE.
- 4. COVERED EXTERIOR GFCI ELECTRICAL OUTLET; SEE ELECTRICAL SHEETS FOR ALL OUTLET QUANTITIES AND LOCATIONS.
- 5. ELECTRICAL METER.
- 6. SERVICE DOOR. BLACK FINISH TO MATCH MT-4.


- 7. PRE-FINISHED METAL COPING, TYPICAL.
- 8. OUTLINE OF ROOF BEYOND.
- 9. GAS METER. SEE PLUMBING SHEETS FOR ADDITIONAL INFORMATION.
- 10. DT WINDOW, AIR CURTAIN, & SHELF PER TENANT SPECIFICATION. PROVIDE READY ACCESS DT SERVICE WINDOW. WINDOW AND AIR CURTAIN FINISH TO MATCH ADJACENT STOREFRONT.
- 11. STEEL CANOPY. SEE BUILDING DETAIL SHEETS AND STRUCTURAL DRAWINGS.
- 12. CANOPY DOWNSPOUTS. CONNECT TO UNDERGROUND STORM DRAIN.
- 13. ROOF SCUPPER AND EMERGENCY OVERFLOW. CONNECT VERTICAL LEADERS TO UNDERGROUND STORM DRAIN.
- 14. PROVIDE SIGNAGE DISCONNECT AND J-BOX W/ PULL STRING FOR FUTURE BUILDING SIGNAGE.
- 15. WALL-MOUNTED DECORATIVE SCONCE. REFER TO LIGHTING SCHEDULE FOR ADDITIONAL INFORMATION.
- 16. REAR SERVICE DOOR SECURITY LIGHT BY LANDLORD REFER TO LIGHTING SCHEDULE FOR ADDITIONAL INFORMATION.
- 17. ROOF ACCESS LADDER WITH LOCKABLE LADDER GUARD CAGE. BLACK FINISH TO MATCH MT-1.
- 18. RECESSED, LOCKABLE, COVERED, FROST-FREE HOSE BIBB, SEE PLUMBING SHEETS. BLACK FINISH TO MATCH MT-1



© DUPLEX

0 2' 4' 8' Scale: 1/4" = 1'-0"

NOTE: ALL SIGNAGE UNDER SEPARATE PERMIT, SHOWN FOR COORDINATION PURPOSES ONLY.

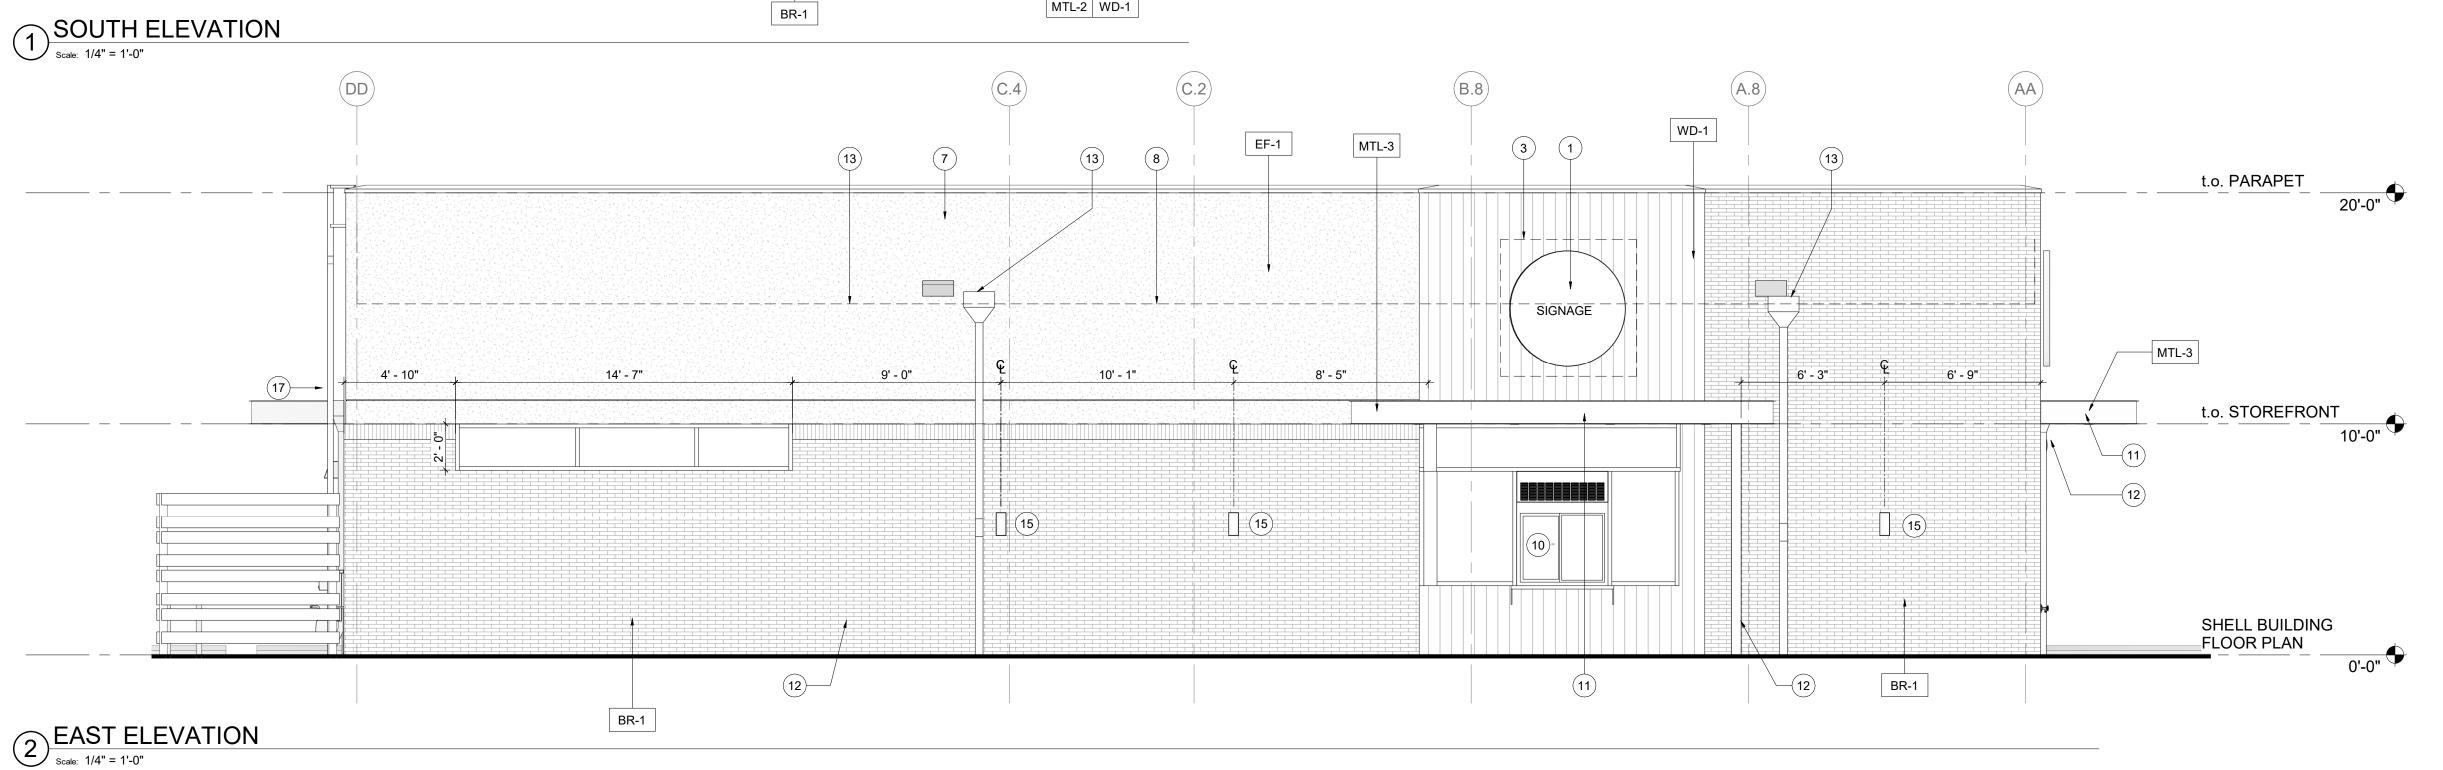

PROJECT

NORR PROJECT NO.:

NICH20-0161

# ROCHESTER, MI FUTURE COFFEE SHOP

ADAMS ROAD ROCHESTER, MI

DEVELOPER

ROBERT B. AIKENS AND ASSOCIATES 350 N. OLD WOODWARD SUITE 300 BIRMINGHAM, MI 48009

ARCHITECT

# **NORR**

(248) 283-2387

325 North La Salle Street, Suite 500 Chicago, Illinois 60654

### STRUCTURAL ENGINEER

CASE ENGINEERING INC. 796 Merus Court St. Louis, MO 63026 [636] 349.1600

MEP ENGINEER

CASE ENGINEERING INC. 796 Merus Court St. Louis, MO 63026 [636] 349.1600

CIVIL ENGINEER

SPICER GROUP 230 S. Washington Ave. Saginaw, MI 48607 [989] 754.4440

NOTES


This drawing has been prepared solely for the use of the client, and there are no representations of any kind made by NORR to any party with whom NORR has not entered into a contract.

# 


# BUILDING EXTERIOR ELEVATIONS

SHEET NUMBER

A202

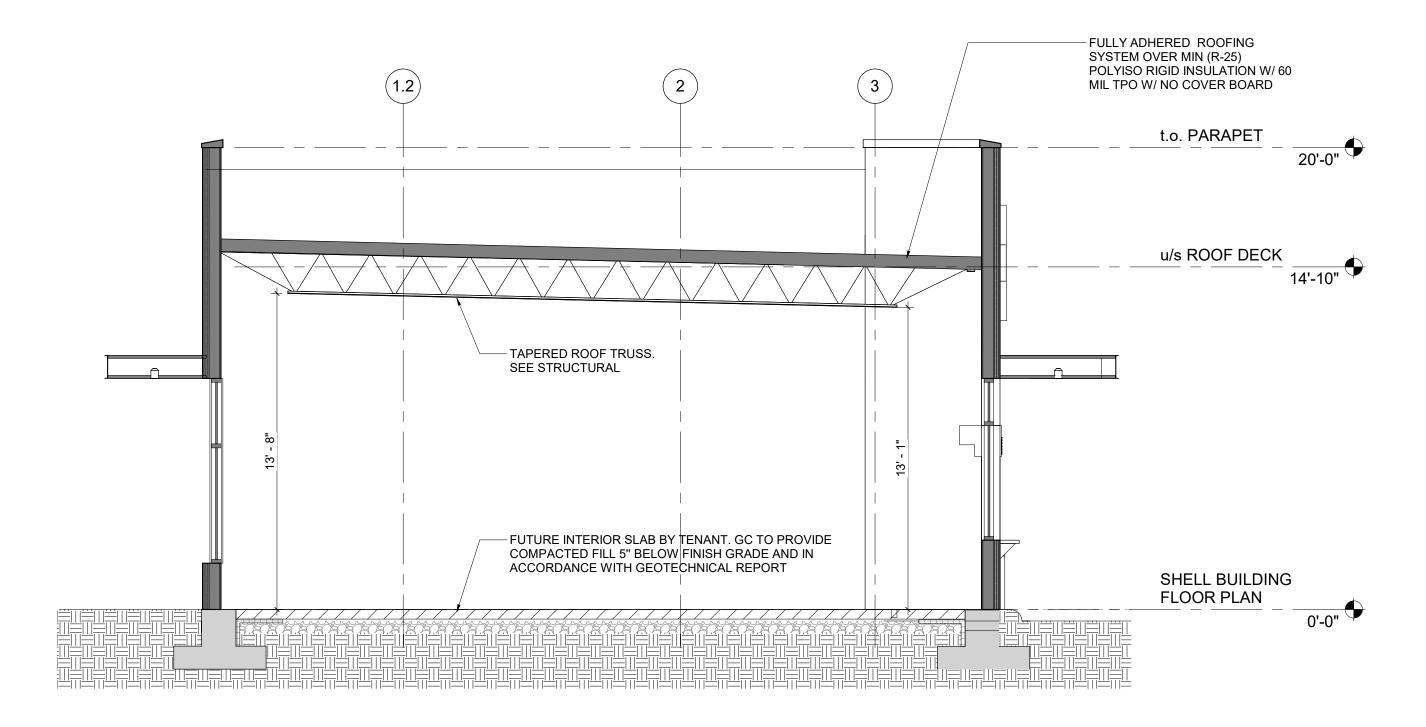



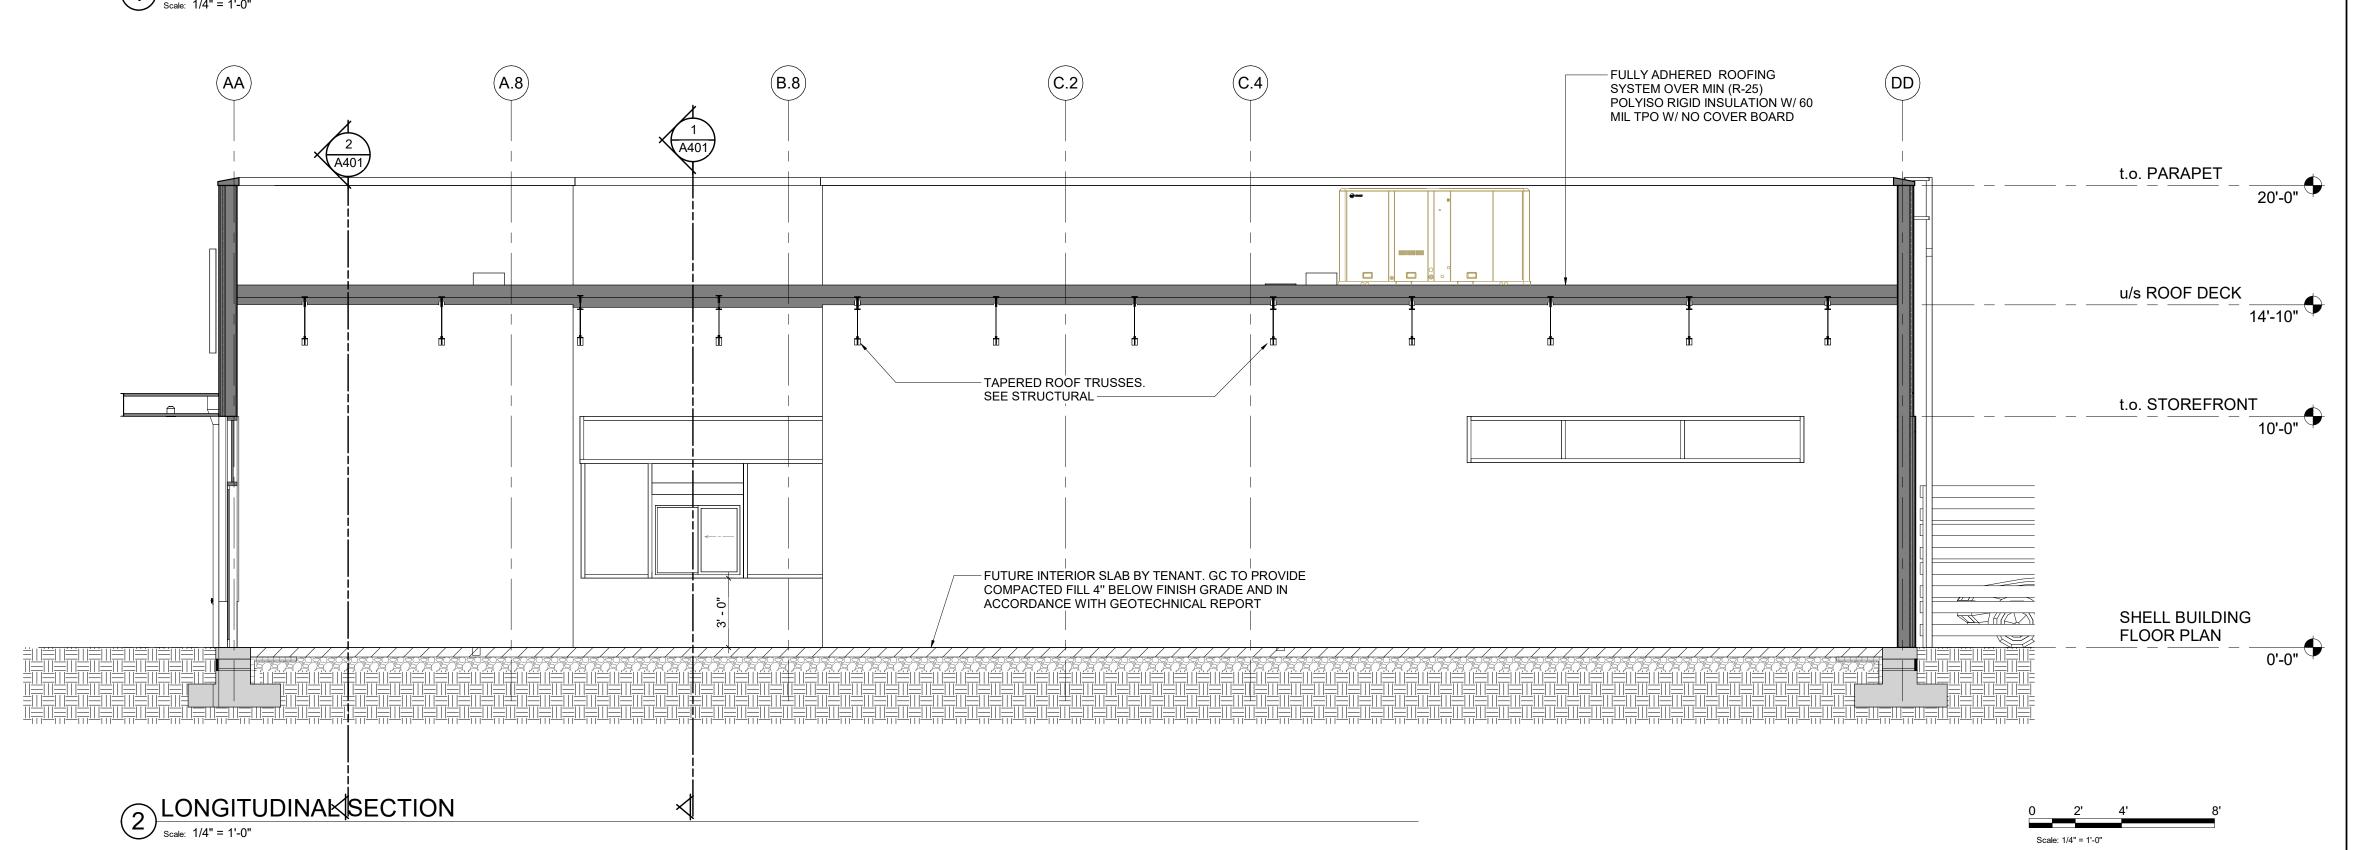

PROJECT

NORR PROJECT NO.:

NICH20-0161

# ROCHESTER, MI FUTURE COFFEE SHOP

ADAMS ROAD ROCHESTER, MI

DEVELOPER

ROBERT B. AIKENS AND ASSOCIATES 350 N. OLD WOODWARD SUITE 300 BIRMINGHAM, MI 48009

ARCHITECT

# **NORR**

(248) 283-2387

325 North La Salle Street, Suite 500 Chicago, Illinois 60654

STRUCTURAL ENGINEER

CASE ENGINEERING INC. 796 Merus Court St. Louis, MO 63026 [636] 349.1600

MEP ENGINEER

CASE ENGINEERING INC. 796 Merus Court St. Louis, MO 63026 [636] 349.1600

CIVIL ENGINEER

SPICER GROUP 230 S. Washington Ave. Saginaw, MI 48607 [989] 754.4440

NOTES

This drawing has been prepared solely for the use of the client, and there are no representations of any kind made by NORR to any party with whom NORR has not entered into a contract.

		SHEET INFORMATION
		ISSUES / REVISIONS
NO.	DATE	DESCRIPTION
01	01/2X/2022	20% SHELL CD SET
02		
03		
04		

**BUILDING SECTIONS** 

SHEET NUMBER

SHEET TITLE

A301