





LINETYPE LEGEND

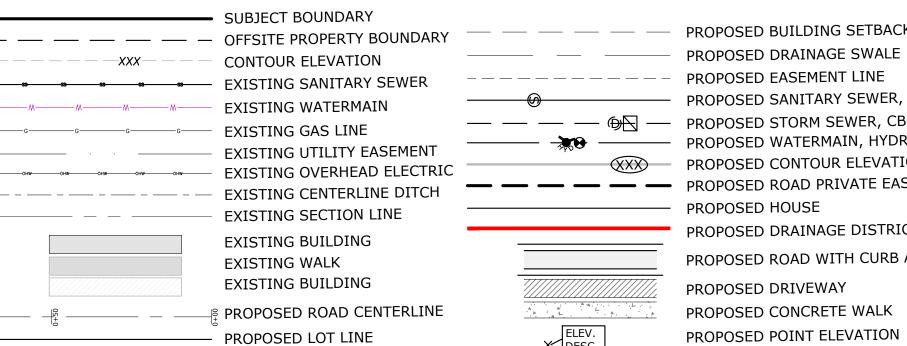

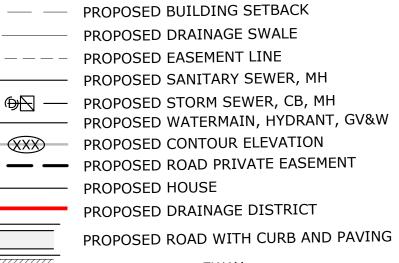


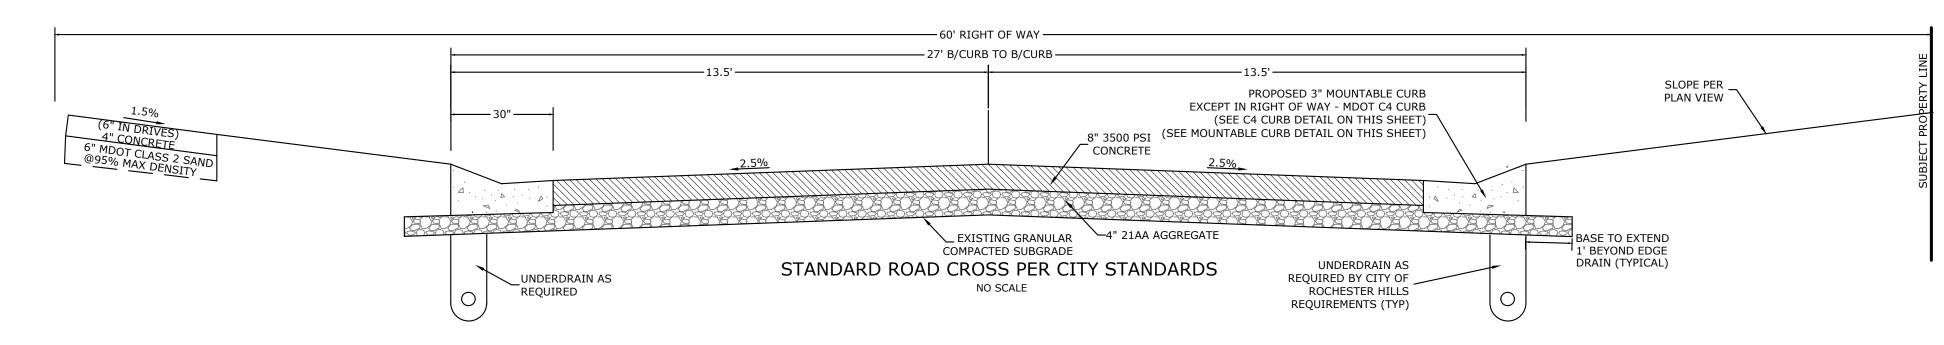


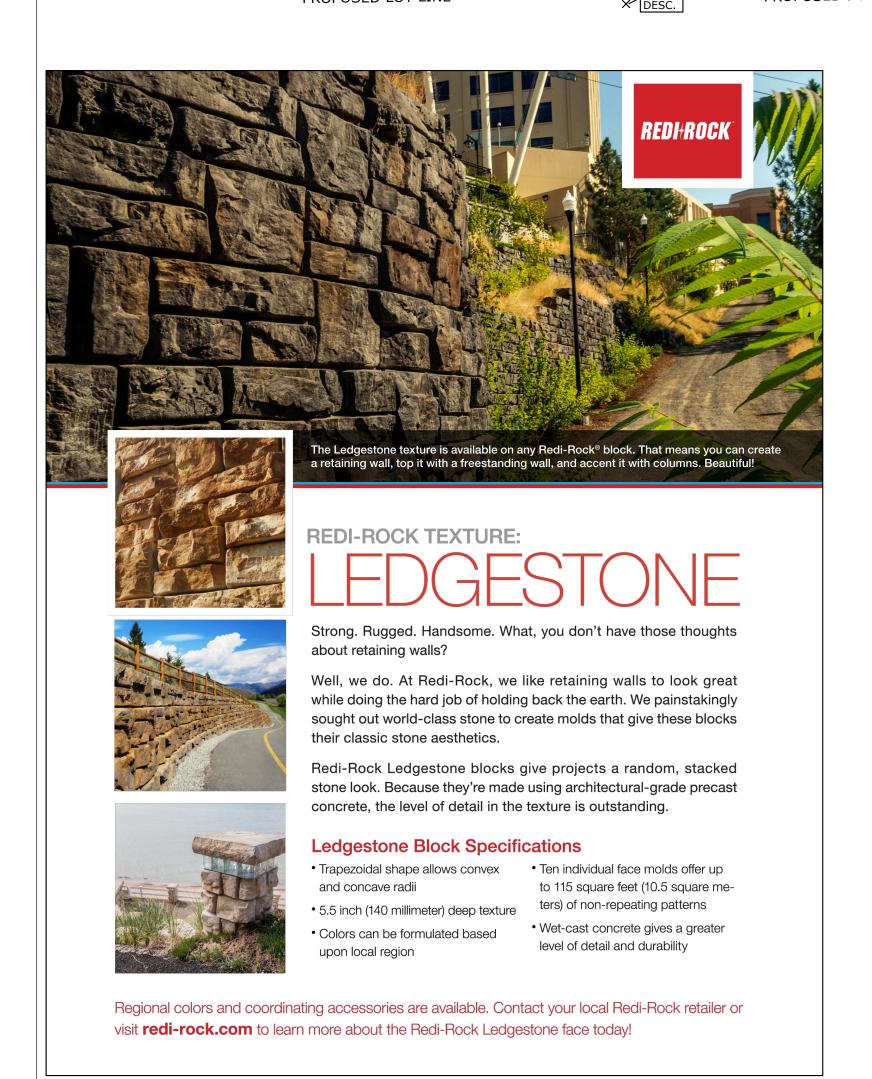


RETAINING WALL NOTES:

- 1. ALL RETAINING WALLS OVER 42" IN HEIGHT WILL REQUIRE A 42" HIGH PROTECTIVE FENCING.
- 2. ALL RETAINING WALLS OVER 48" IN HEIGHT OR GREATER WILL NEED TO BE STRUCTURALLY ENGINEERED.
- 3. RETAINING WALLS TO BE REDI-ROCK TEXTURED LEDGESTONE OR EQUAL

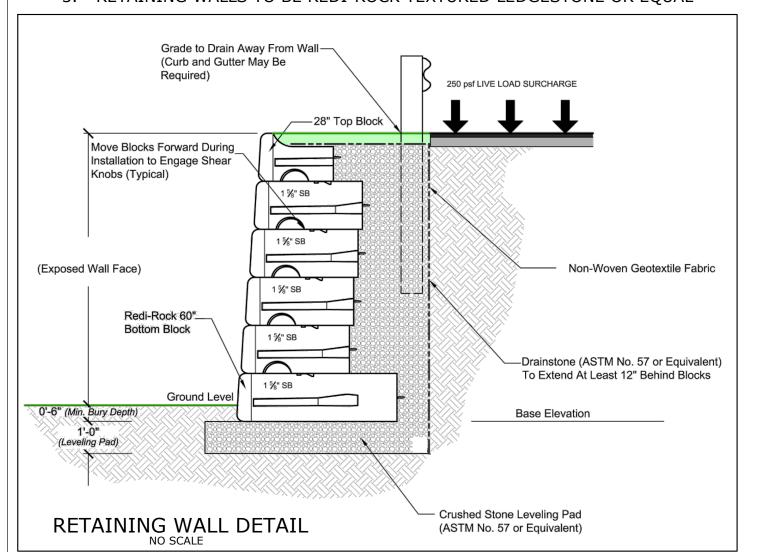

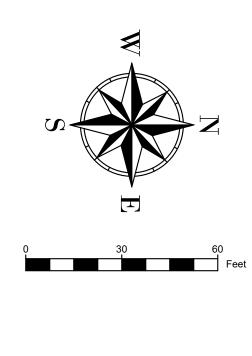

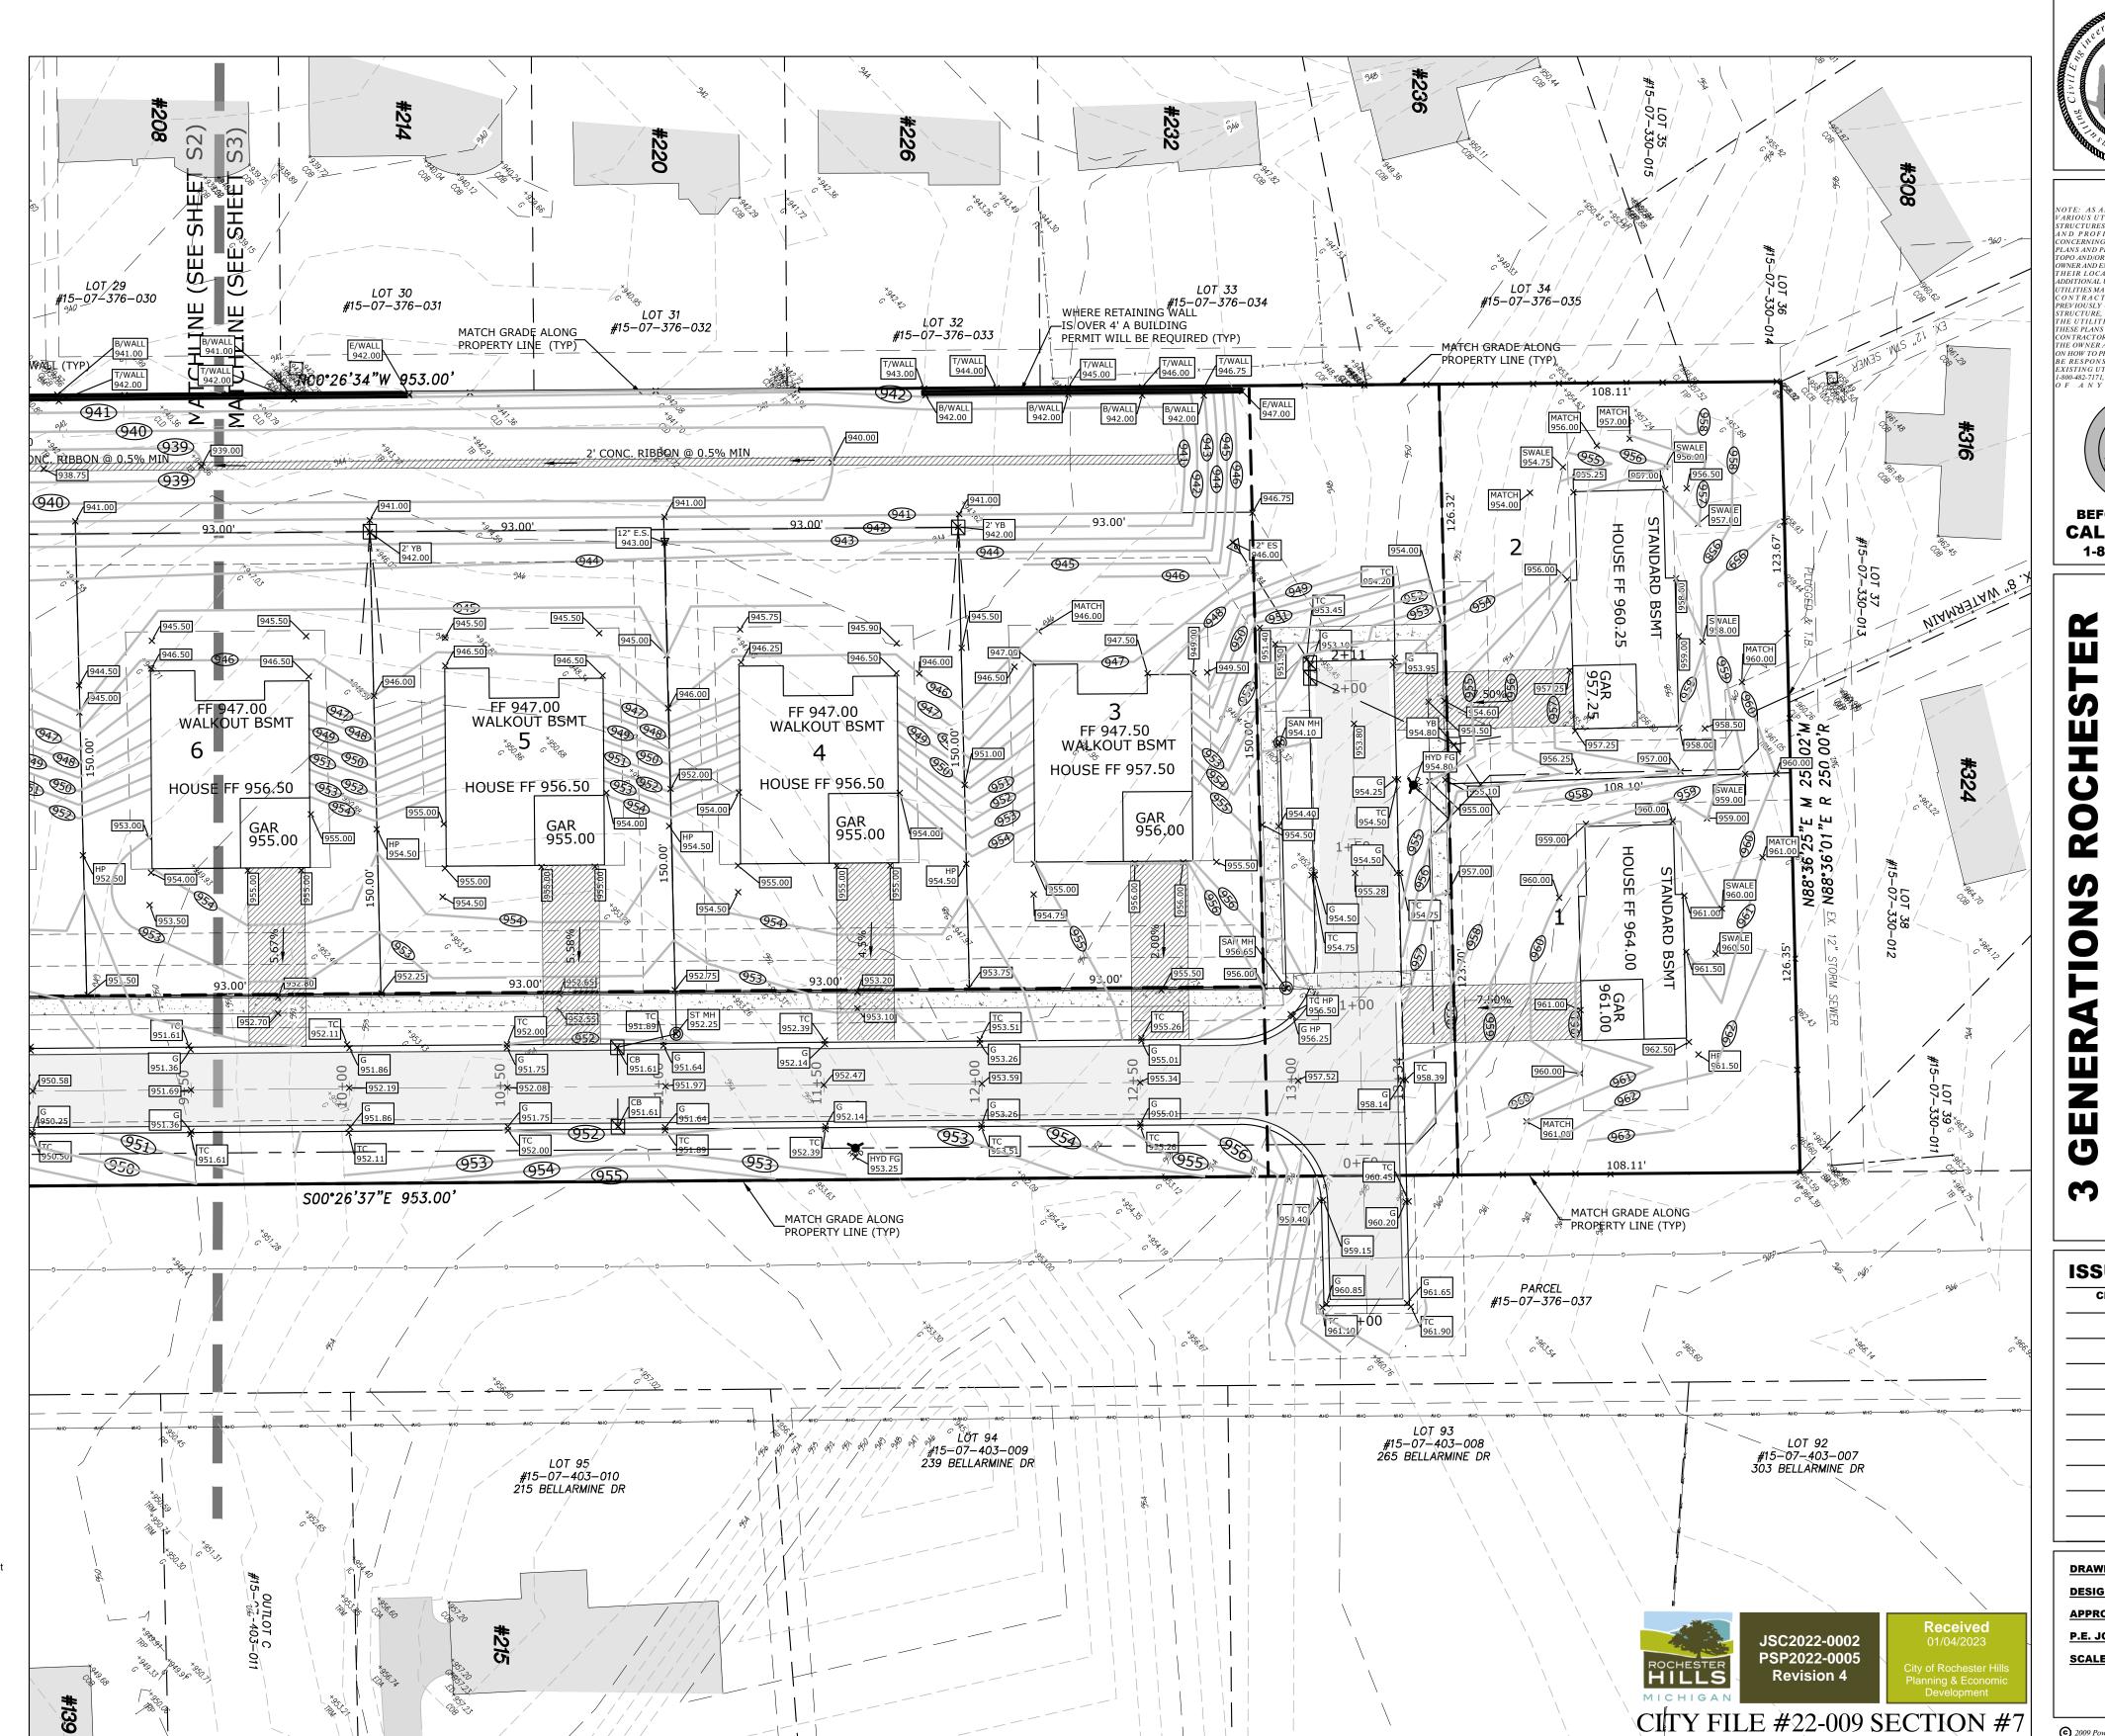







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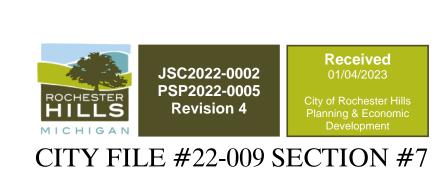
ISSUE DATES CITY SITE PLAN 7/21/2022

DRAWN MCS DESIGNED MCS APPROVED MCP P.E. JOB No. 21-419 SCALE 1"=30'

S3 SITE PLAN



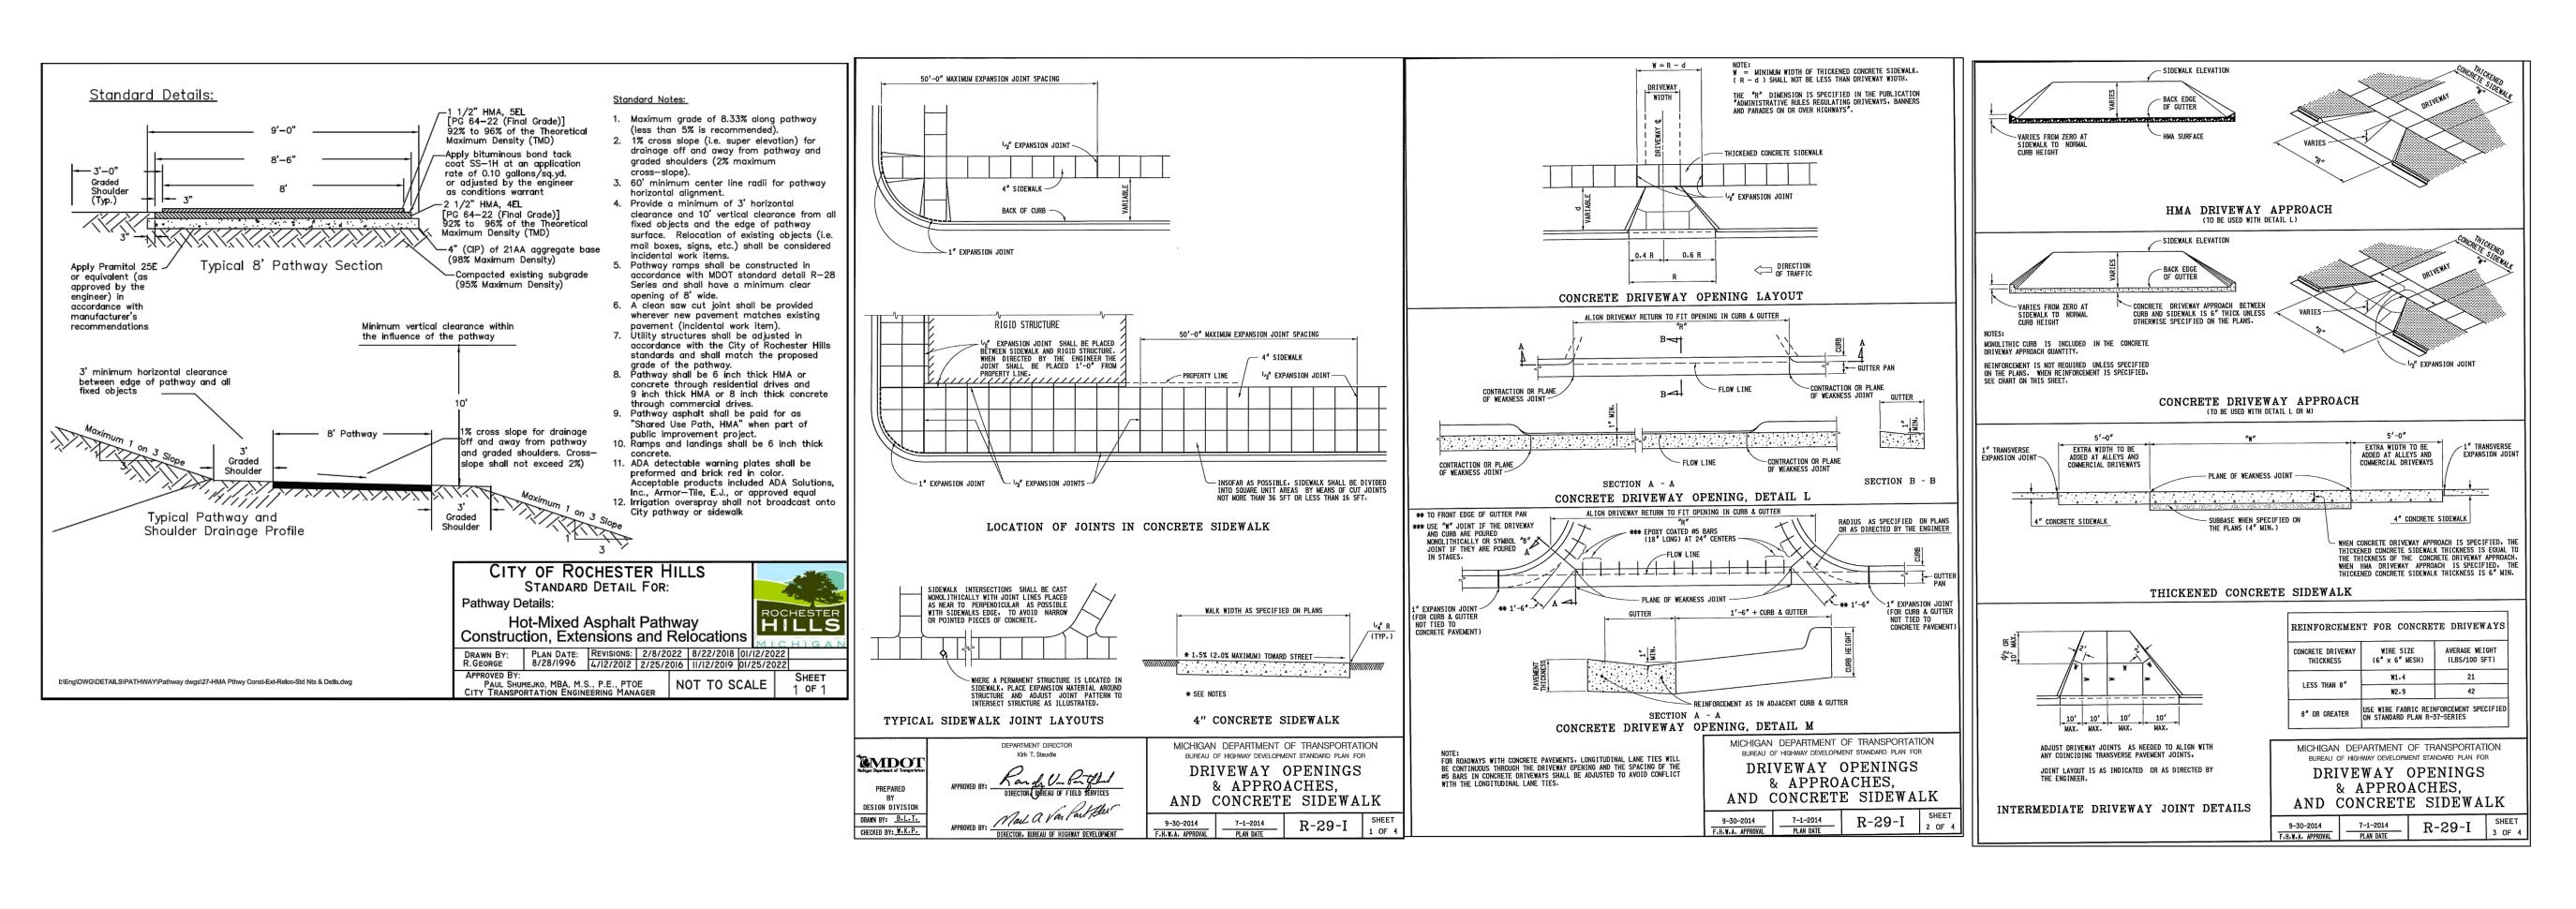

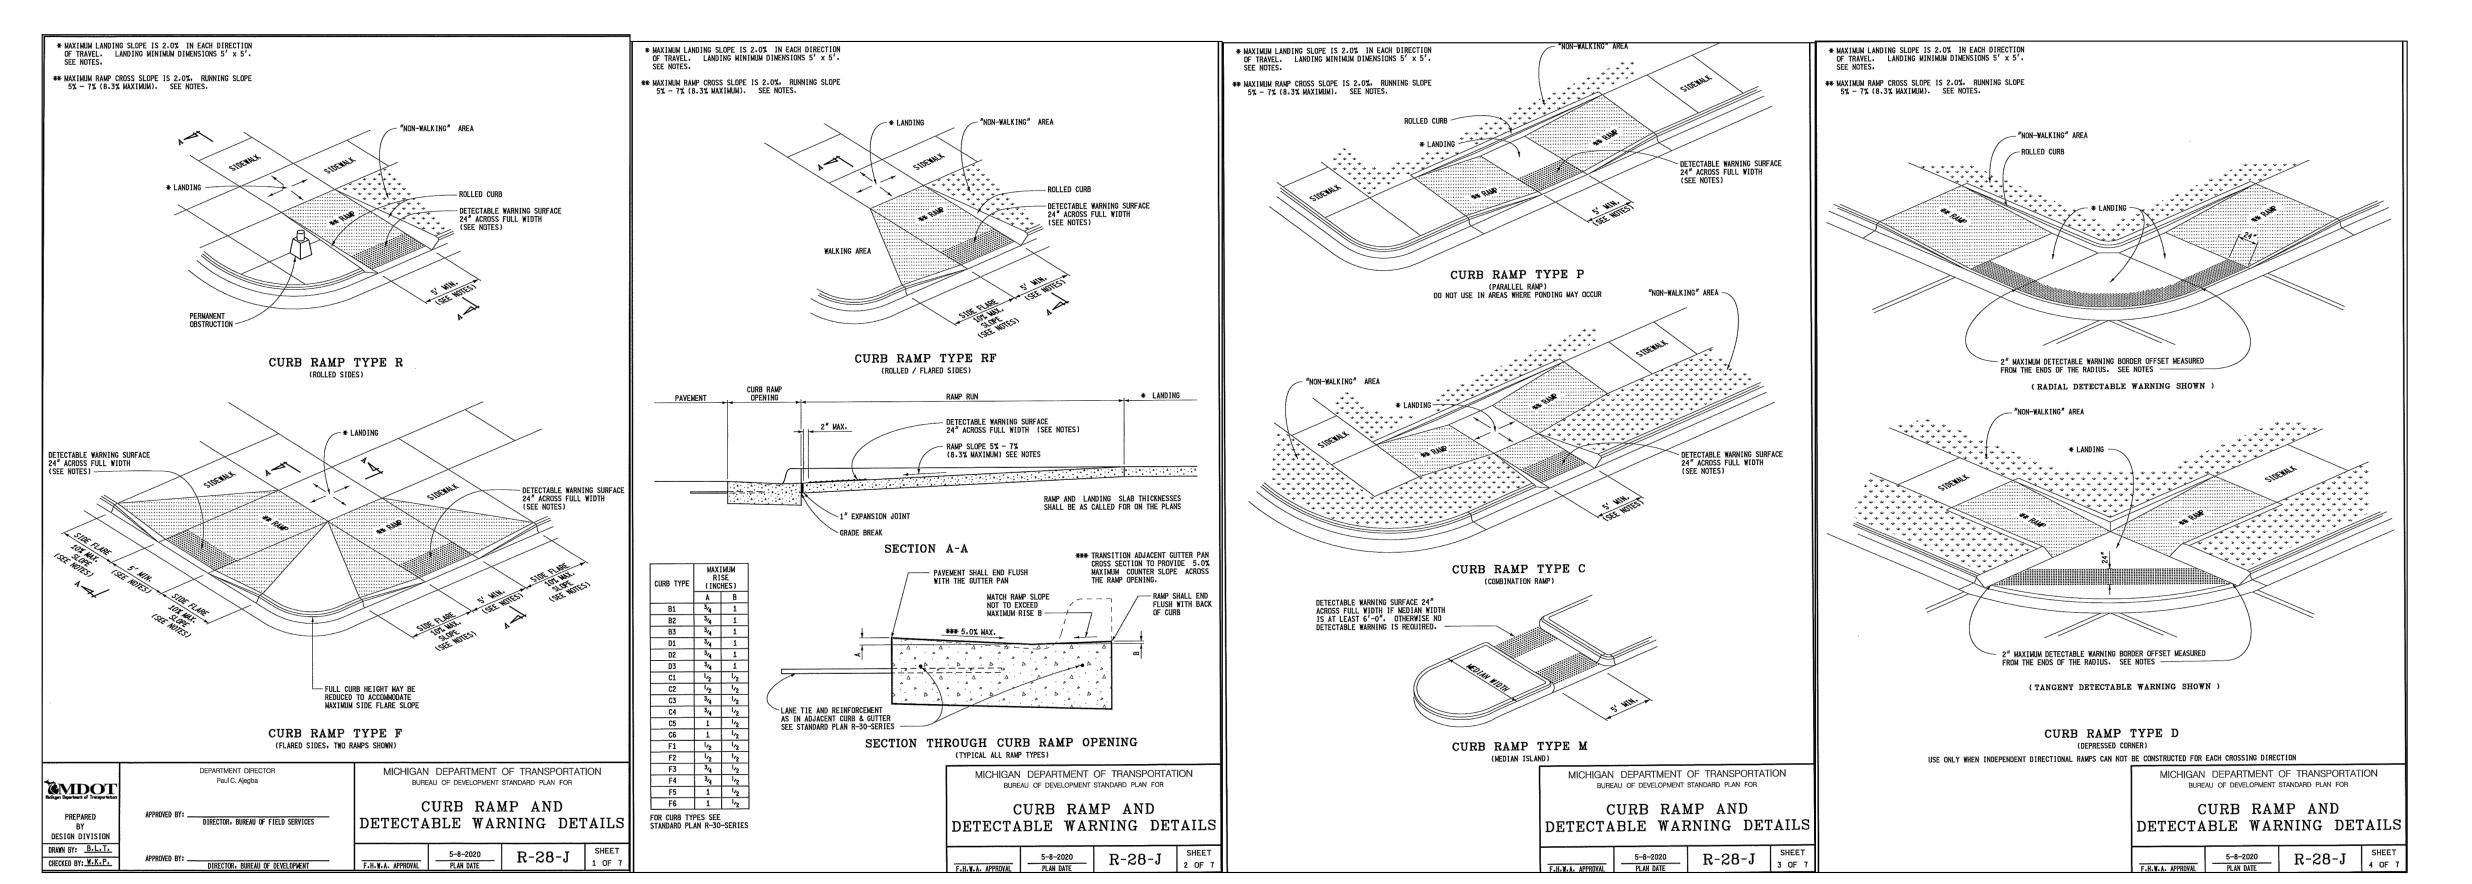



ISSUE DATES

CITY SITE PLAN 7/21/2022

DRAWN MCS DESIGNED MCS APPROVED MCP P.E. JOB No. 21-419

SCALE 1"=30'

S3A

© 2009 Powell Engineering & Associates, LLC

WALTON BOULEVARD, CITY OF ROCHESTER THREE GENERATIONS ROCHESTER HILLS SITE

0


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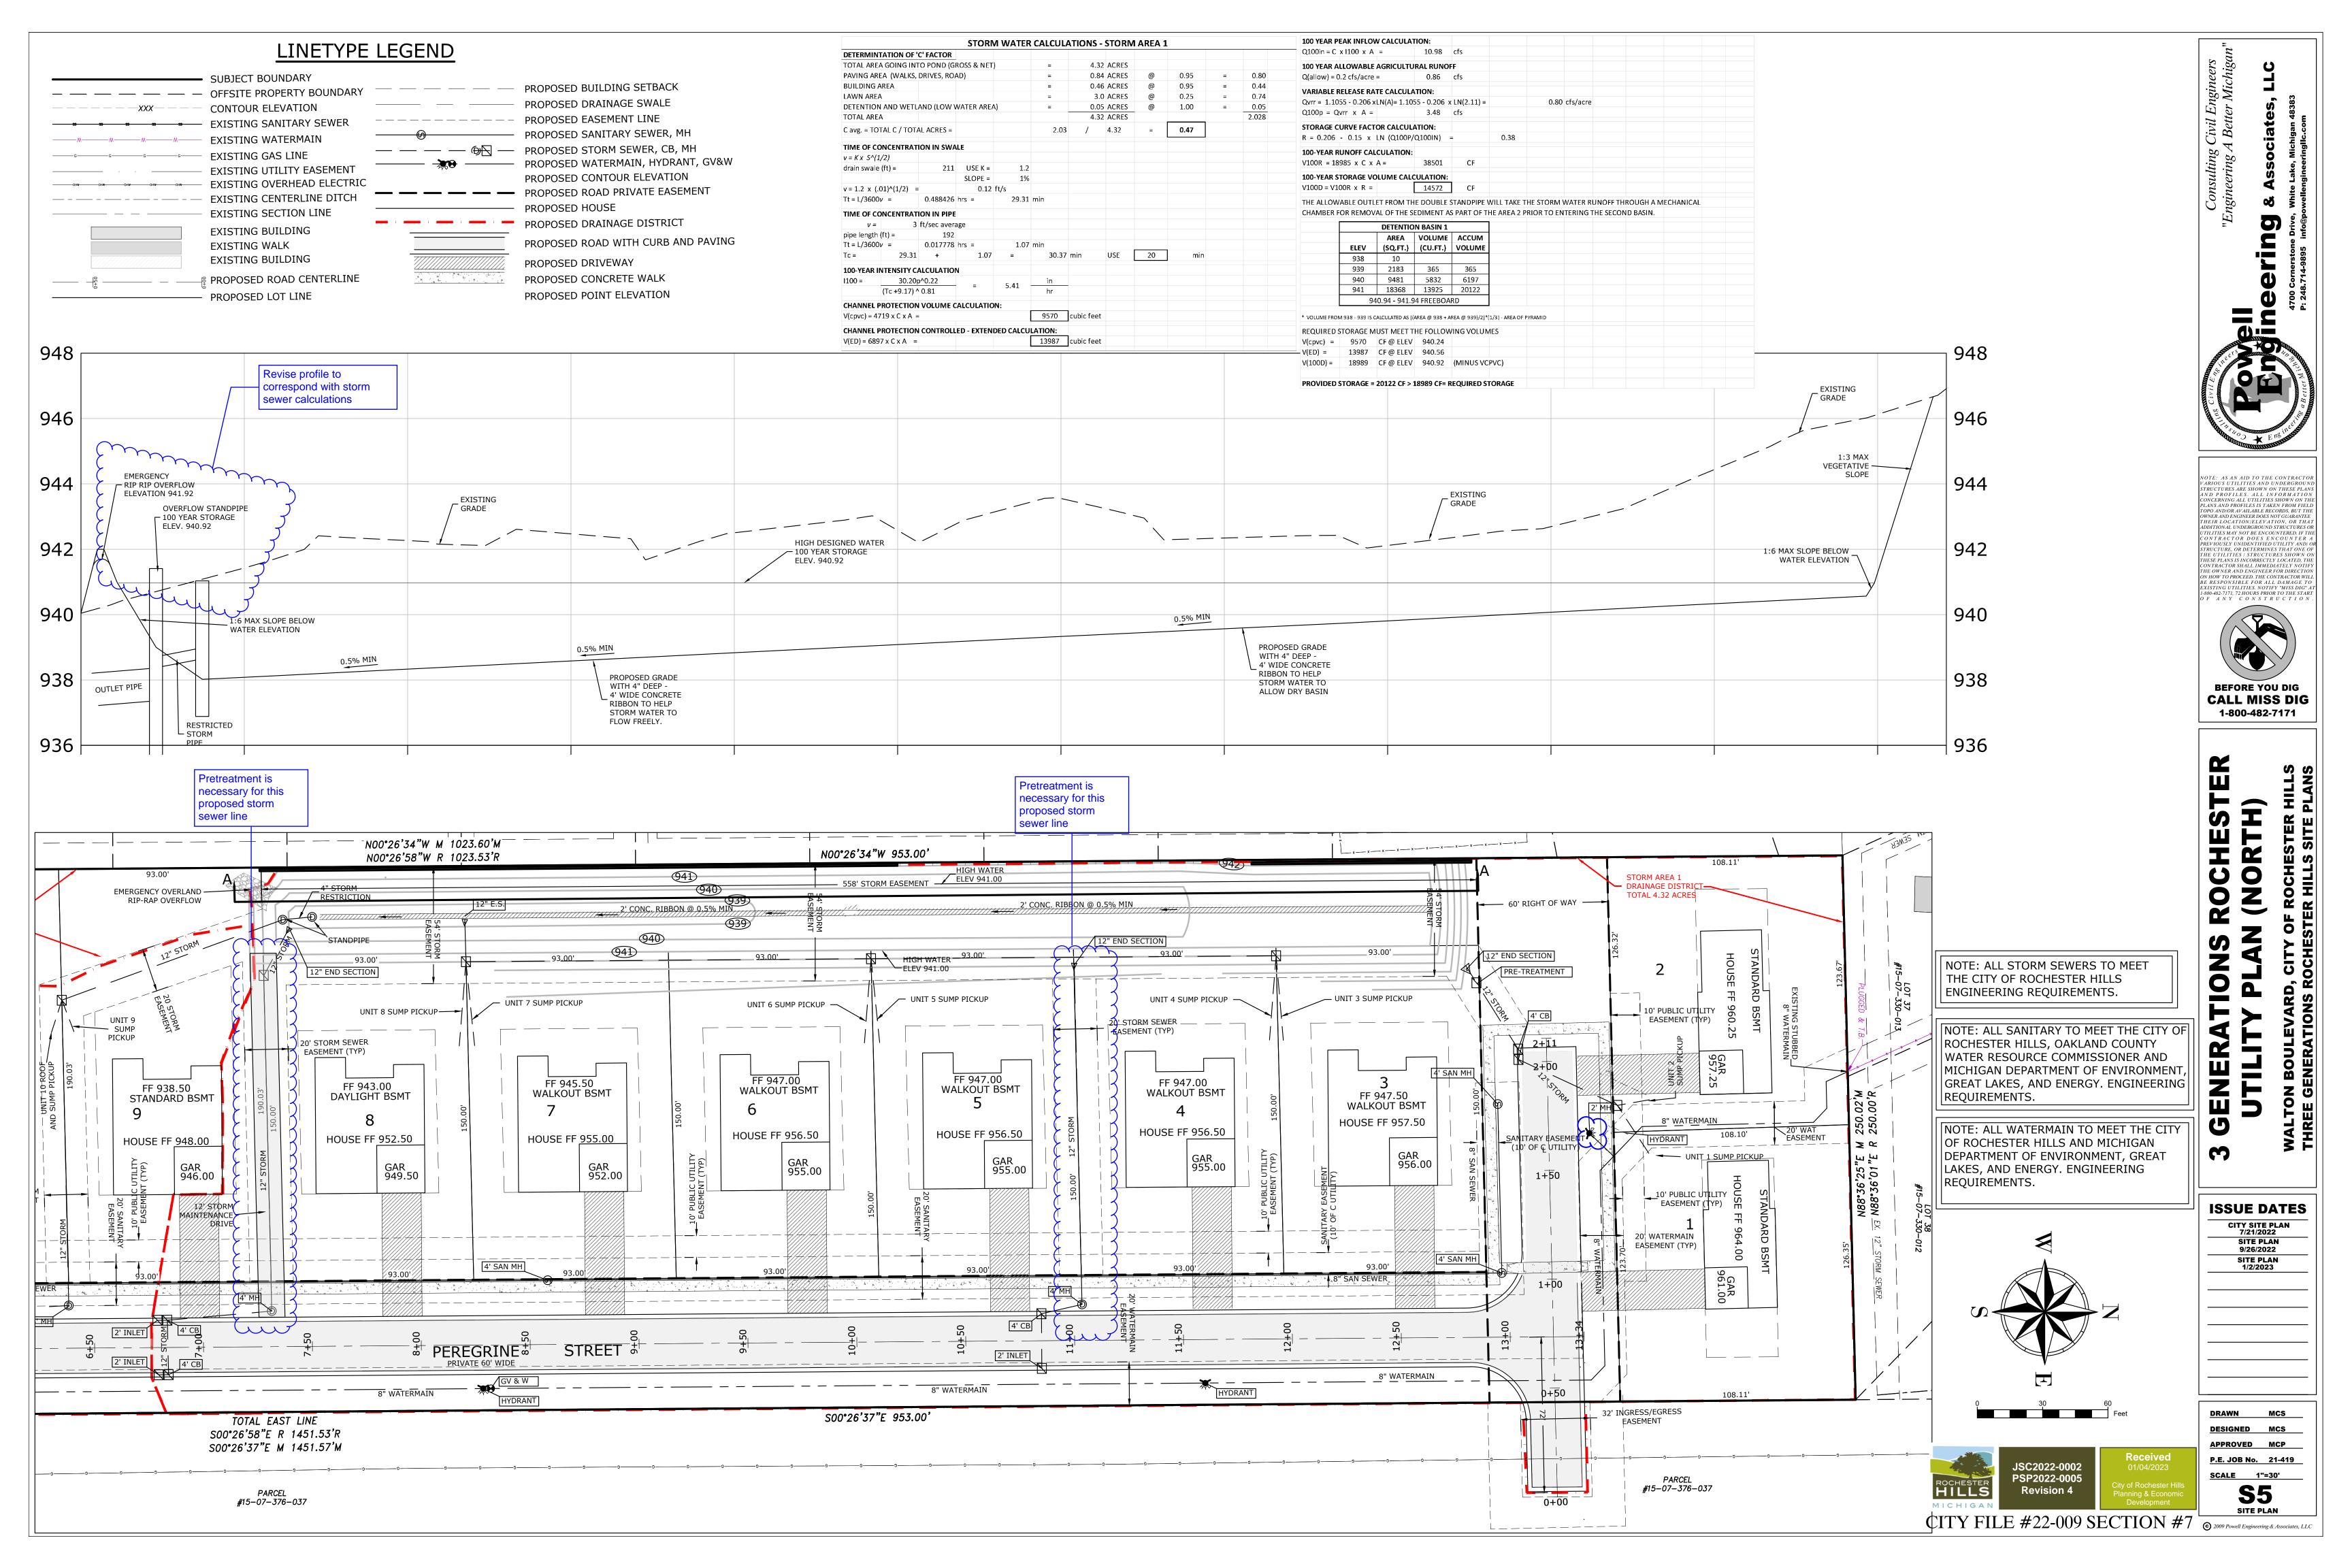
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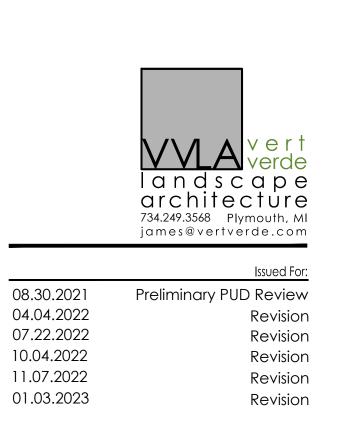
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HESE PLANS IS INCORRECTLY LOCATED, TE
ONTRACTOR SHALL IMMEDIATELY NOTH
THE OWNER AND ENGINEER FOR DIRECTIC

BEFORE YOU DIG







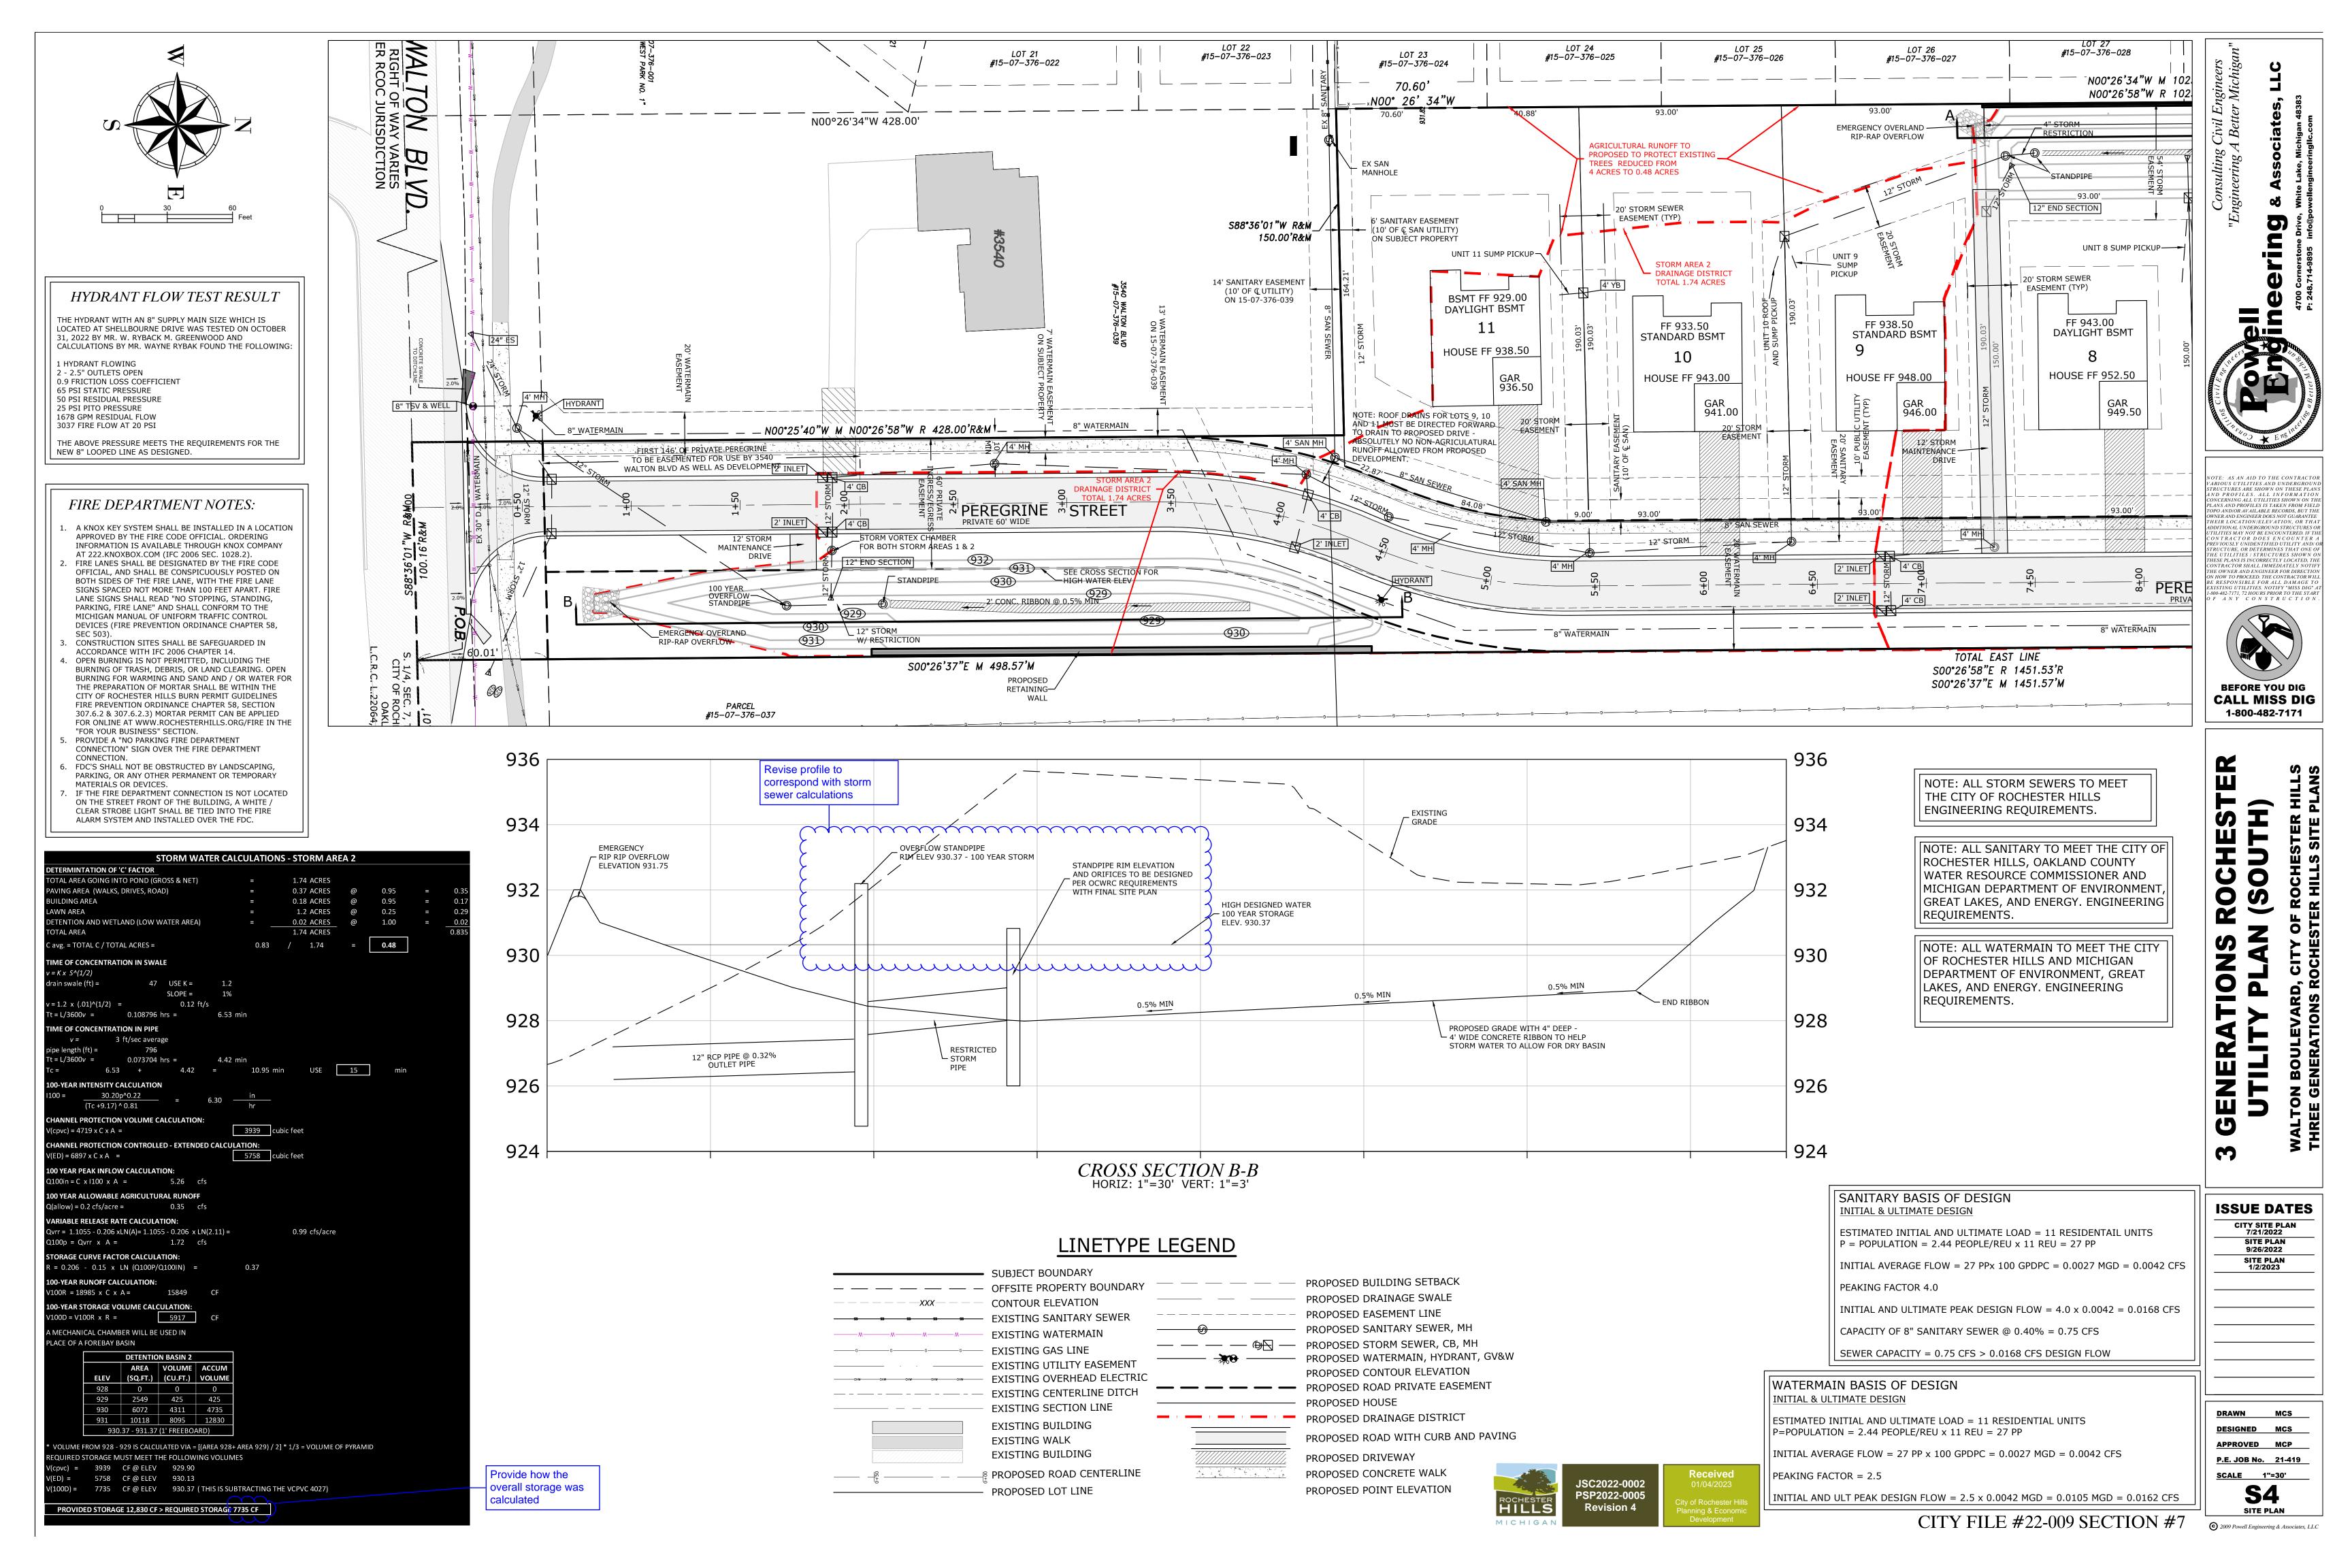

East Walton Boulevard Rochester Hills, Michigan

Project Sponsor:

Three Oaks Communities, LLC P.O. Box 8307 Ann Arbor, MI 48107

Sheet Name:

Tree Removal & Preservation Plan - South

Tree Mitigation Calculations

Tree Exemptions 103 (building envelop (80), poor condition (23))

PROPOSED RETAINING WALLS, SEE CIVIL DRAWINGS —

PEREGRINE STREET

S00°26'58"E R \$451.53'R S00°26'37"E M 1451.57'M

LOT 97 #15-07-451-002

/ NO.6°26'37"W 2480.51' TO.JA

N.-S. 1/4 LINE OF SEC.

LOT 25 #15-07-376-026

LOT 24 #15-07-376-025/

LOT 28 #15-07-376-029

DETENTION BASIN

Regulated Trees Removed 167 (1 to 1 replacement ratio less 23 in poor condition*)

Specimen Trees Saved Specimen Trees Credits 33 (1 - 2" tree credit per saved tree) 233 ((1,064" * 50% = 532" / 2 = 266 2" trees - 33 credits) Specimen Trees Required

Total Replacements Required Total Replacements Provided

*The trees identified as being in poor condition are in such a state of decline with some showing signs of disease, it is our belief that these trees will be dead within the next two (2) years


Drawn:	JG
Checked:	JG
Date:	06.2021
Scale:	1" = 30'-0"

Project Number: 22.004 Sheet Number:

NORTH





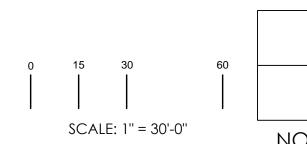


- TREE PROTECTION FENCING, TYP.

LOT 96 #15-07-45

TREE TO BE SAVED, TYP.

NOTE: SEE SHEET L-3 FOR TREE LIST



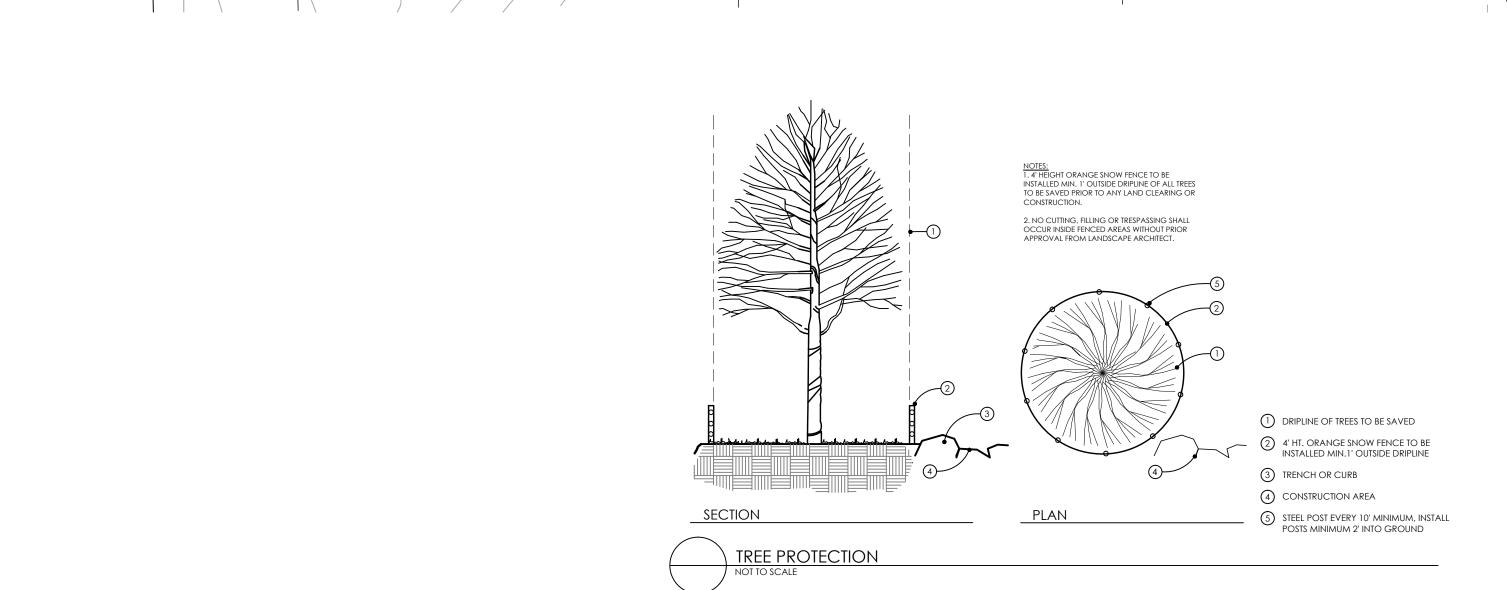

0795#

EXISTING HOUSE

S00°26\37"E M 498.57'M

LOT 101 ##15-07-451-006

10°26'58"W_R_428.00'R&M_

PEREGRINE STREET

LOT 102 ##15-07-451-007

ALTON BLVD.

TREE PROTECTION NOTE

LOT 99 #15-07-451-004

TREES TO BE SAVED, TYP. —

TREE PROTECTION FENCING -

CONCRETE SIDEWALK

TREE TO BE REMOVED, TYP.

SEE CIVIL DRAWINGS

LOT 100 ##15-07-451-005

PROPOSED RETAINING WALLS

No person may conduct any construction or development activity within the drip line of any regulated tree not approved for removal, including but not limited to land clearing, grubbing, trenching, grading, or filling, nor shall any person place solvents, building material, construction equipment, soil deposits, or other harmful materials within the drip line unless authorized by the parks and natural resources

LOT 98 #15-07-451-003

During construction or development activity, persons shall not attach any device or wire to any regulated tree not approved for removal.

Replacement and relocated trees must be staked, fertilized, and mulched and shall be guaranteed by the tree removal permit holder to exhibit a normal growth cycle for at least one year following planting

Regulated Trees Surveyed

Remaining Regulated Trees 311 (414-103)

Trees Required to be Saved 125 (311 x 40%) Regulated Trees Saved Percentage of Trees Saved 44.05% (137/311)

Regulated Trees Required Specimen Trees Removed 39 (1,064")

400 (167+233)

Trees Paid into City Tree Fund

NOT FOR CONSTRUCTION



Issued For:	
Preliminary PUD Review	08.30.2021
Revision	04.04.2022
Revision	07.22.2022
Revision	10.04.2022
Revision	11.07.2022
Revision	01.03.2023

East Walton Boulevard Rochester Hills, Michigan

Project Sponsor:

Three Oaks Communities, LLC P.O. Box 8307 Ann Arbor, MI 48107

Tree Removal & Preservation Plan – North





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Date:	06.2021
Scale:	1'' = 30'-0''

22.004

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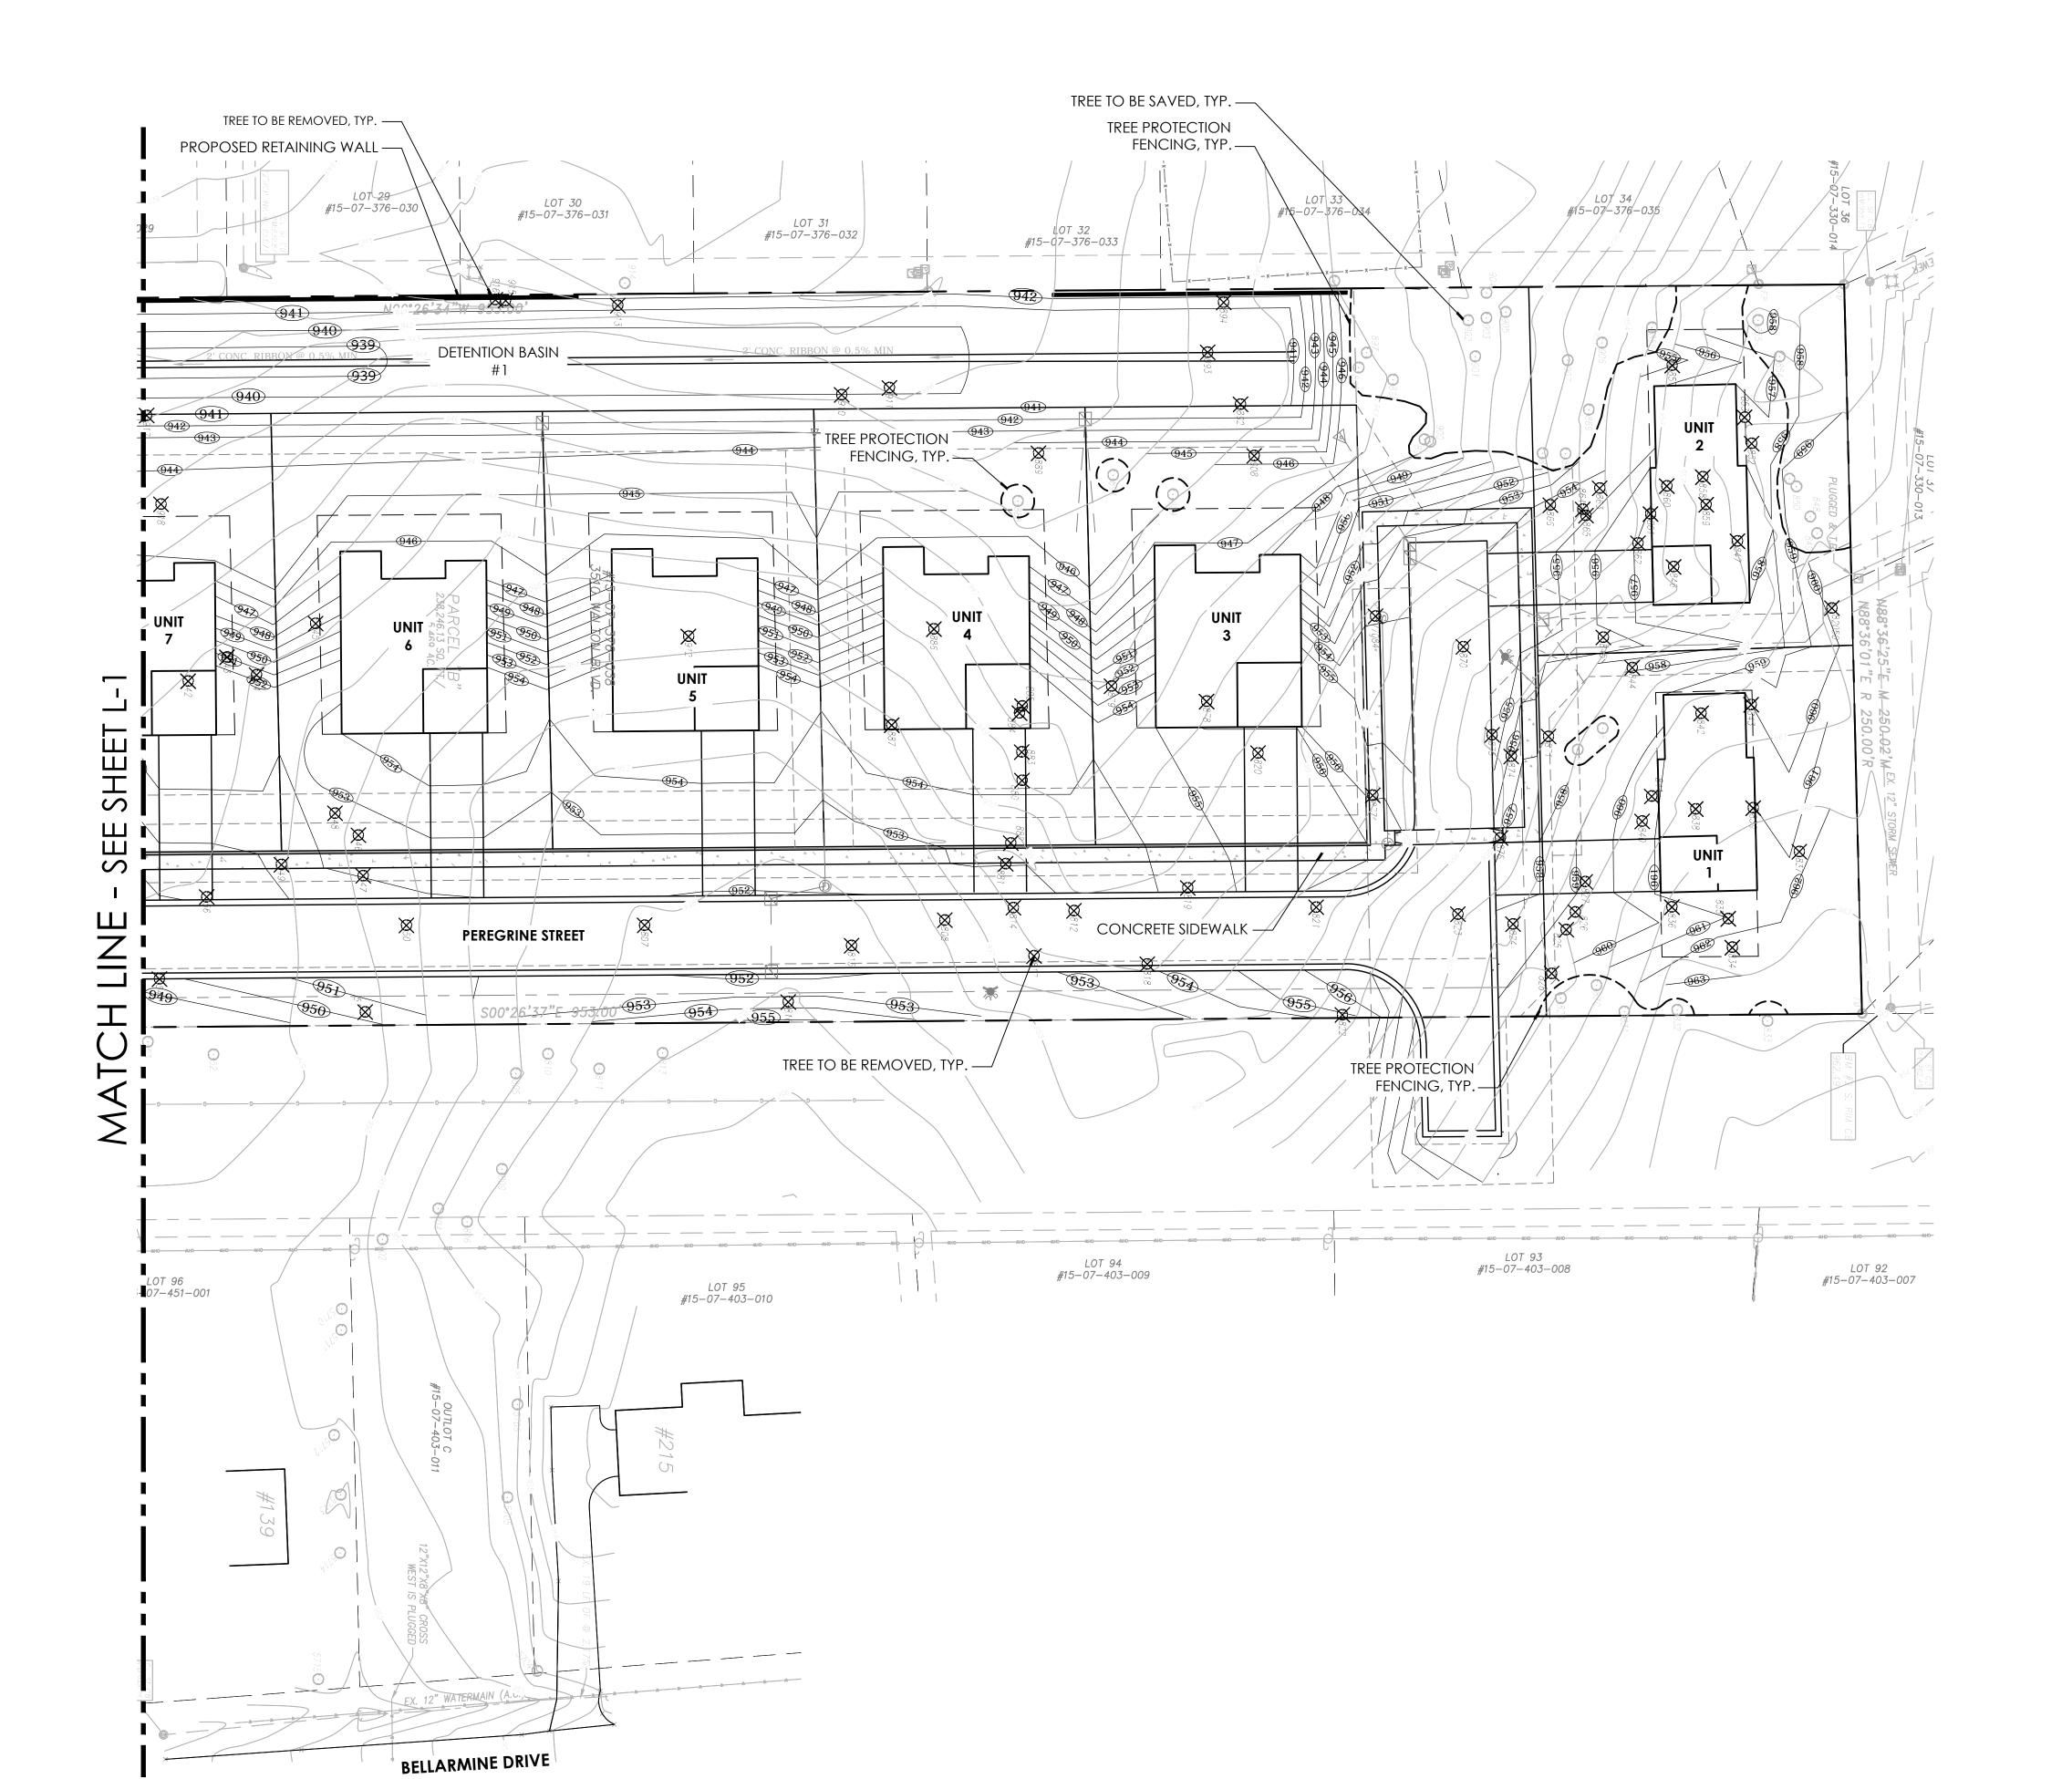
JSC2022-0002 PSP2022-0005 Revision 4



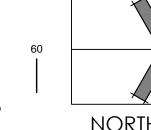

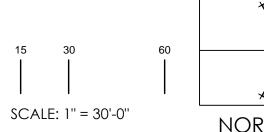NOT FOR CONSTRUCTION





Issued Fo		
Preliminary PUD Reviev	08.30.2021	
Revisio	04.04.2022	
Revisio	07.22.2022	
Revisio	10.04.2022	
Revisio	11.07.2022	
Revisio	01.03.2023	

East Walton Boulevard Rochester Hills, Michigan

Project Sponsor

Three Oaks Communities, LLC P.O. Box 8307 Ann Arbor, MI 48107

Tree List



JG
JG
06.2021
No Scale

Project Number 22.004

Sheet Number

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Common Name

Black Walnut

Black Locust

Black Locust

Black Locust

Black Locust

Norway Maple

Norway Maple

Norway Maple

Silver Maple

Silver Maple

Blue Spruce

Blue Spruce

Black Walnut

Black Locust

Black Cherry

Black Walnut

Mulberry

Blue Spruce

Blue Spruce

1000

5704

5705

5706

5710

5711

5712

5713

5714

5715

11546

77084

80100

82050

Botanical Name

Good

Good

Poor

Fair

Good

931.32

931.80

931.32

931.14

932.12

953.21

950.59

950.74

949.91

949.67

945.64

951.32

942.03

961.05

Robinia pseudoacacia

Acer platanoides

Acer platanoides

Acer saccharinum

Acer saccharinum

Picea pungens

Picea pungens

Picea pungens

Picea pungens

Juglans nigra

Prunus serotina

Juglans nigra

Morus alaba

Robinia pseudoacacia

Acer platanoides

Ulmus americana

Ulmus americana

Juglans nigra

Botanical Name

Juglans nigra

Acer negundo

Acer negundo

Acer negundo

Juglans nigra

Prunus serotina

Acer negundo

Acer negundo

Prunus serotina

Ulmus americana

Pinus strobus

Malus ssp.

Malus ssp.

Malus ssp.

Prunus serotina

Prunus serotina

Prunus serotina

Prunus serotina

Prunus serotina

Populus deltoides

Populus deltoides

Populus deltoides

Acer negundo

Acer negundo

Acer negundo

Acer neaundo

Juglans nigra

Prunus serotina

Juglans nigra

Acer negundo

Malus ssp.

Acer negundo

Acer negundo

Pinus sylvestris

Acer negundo

Pinus sylvestris

Populus deltoides

Populus deltoides

Populus deltoides

Populus deltoides

Ulmus americana

Prunus serotina

Jualans nigra

Malus ssp.

Juglans nigra

Acer negundo

Ulmus americana

Betula alleghaniensis

Betula alleghaniensis

Juglans nigra

Juglans nigra

Quercus alba

Quercus rubra

Quercus rubra

Quercus rubra

Quercus rubra

Quercus rubra

Acer nigrum

Ulmus americana

Ulmus americana

Prunus serotina

Juglans nigra

Acer nigrum

Pinus strobus

Pinus strobus

Prunus serotina

Prunus serotina

Prunus serotina

Prunus serotina

Pinus strobus

Ulmus americana

Ulmus americana

Acer saccharinum

Robinia pseudoacacia

Robinia pseudoacacia

Robinia pseudoacacia

Juglans nigra

Robinia pseudoacacia

Robinia pseudoacacia

Robinia pseudoacacia

Robinia pseudoacacia

Ulmus americana

Robinia pseudoacacia

Robinia pseudoacacia

Robinia pseudoacacia

Robinia pseudoacacia

Ulmus americana

Ulmus americana

Robinia pseudoacacia

Robinia pseudoacacia

Juglans nigra

Ulmus americana

Quercus rubra

Fraxinus

Juglans nigra

Fraxinus

Fraxinus

Malus ssp.

Populus deltoides

Fraxinus

Malus ssp.

Fraxinus

Malus ssp.

Fraxinus

Malus ssp.

Fraxinus

Malus ssp.

Malus ssp.

Fraxinus

Black Walnut

Boxelder

Boxelder

Boxelder

Boxelder

Ash

Ash

Elm

Ash

Apple

6,14

Multi

8,10

10,13

Multi

18,15

918

919

920

922

923

928

930

875

Apple

Black Cherry

White Pine

Black Cherry

Black Cherry

Black Cherry

Black Cherry

Black Cherry

Cottonwood

Cottonwood

Boxelder

Boxelde

Apple

Black Walnut

Black Cherry

Black Walnut

Boxelder

Apple

Boxelde

Scotch Pine

Boxelder

Scotch Pine

Cottonwood

Cottonwood

Cottonwood

Cottonwood

Elm

Ash

Elm

Elm

Elm

Elm

Black Cherry

Black Walnut

Black Walnut

Black Walnut

Black Walnut

Red Oal

Red Oak

Red Oak

Red Oak

Red Oak

Black Maple

Black Cherry

Black Walnut

Black Maple

Black Cherry

Black Cherry

Black Locust

Black Locust

Black Cherry

Black Locust

Black Locust

Black Locust

White Pine

Black Locust

Black Locust

Black Locust

Black Locust

Black Walnut

Black Locust

Silver Maple

Black Locust

Black Locust

19,10

978

White Pine

Elm

Yellow Birch

Yellow Birch

Red Oak

10.7.9.9 Boxelde

Black Walnut

Black Cherry

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955.17

953.79

953.06

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951.93

951.94

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957.01

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956.07

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Botanical Name

Good

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952.85

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940.70

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944.53

Ulmus americana

Ulmus americana

Ulmus americana

Ulmus americana

Prunus serotina

Ulmus americana

Acer saccharum

Picea abies

Picea abies

Picea abies

Picea abies

Ulmus americana

Acer saccharinum

Acer saccharinum

Acer saccharum

Acer saccharinum

Acer saccharum

Acer saccharinum

Ulmus americana

Ulmus americana

Acer saccharinum

Malus ssp.

Acer rubrum

Acer rubrum

Acer rubrum

Acer rubrum

Acer rubrum

Malus ssp.

Carya laciniosa

Acer platanoides

Acer platanoides

Prunus serotina

Acer negundo

Acer negundo

Acer negundo

Acer negundo

Morus alba

Morus alba

Morus alba

Picea abies

Picea abies

Picea abies

Acer saccharinum

Acer saccharum

Acer saccharum

Acer saccharinum

Acer saccharum

Acer saccharum

Acer saccharum

Acer saccharum

Populus deltoides

Populus deltoides

Prunus serotina

Quercus rubra

Juglans nigra

Picea abies

Picea glauca

Acer saccharinum

Populus deltoides

Ulmus americana

Acer platanoides

Acer platanoides

Juglans nigra

Juglans nigra

Morus alba

Fraxinus

Juglans nigra

Prunus serotina

Malus ssp.

Malus ssp.

Malus ssp.

Malus ssp.

Malus ssp.

Malus ssp.

Acer rubrum

Juglans nigra

Juglans nigra

Prunus serotina

Juglans nigra

Morus alba

Juglans nigra

Juglans nigra

Juglans nigra

Juglans nigra

Juglans nigra

Acer platanoides

Prunus serotina

Prunus serotina

Fraxinus

Acer platanoides

Fraxinus

Fraxinus

Malus ssp.

Elm

Norway Spruce

Norway Spruce

Norway Spruce

Silver Maple

Red Maple

Red Maple

Shellbark Hickory

Norway Maple

Norway Maple

Boxelder

Boxelder

Mulberry

Sugar Maple

Norway Spruc

Norway Spruce

Norway Spruce

Silver Maple

Sugar Maple

Cottonwood

Norway Maple

Black Walnut

Norway Spruc

Cottonwood

Mulberry

Norway Maple

Black Walnut

Norway Mapl

Black Walnut

Black Cherry

Red Maple

Norway Mapl

Black Walnut

Black Walnut

Black Cherry

Black Walnut

Black Walnut

Black Walnut

Black Walnut

Black Walnut

26,24

20,30

12,12

16,28

801

821

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823

852

858

932.56

932.74

933.15

933.17

933.33

934.16

935.35

936.56

937.51

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937.58

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939.88

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N/F

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Poor

Fair

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Fair

Good

Fair

Good

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Good

Good

Good

Dead

Poor

Good

Good

Good

Dead

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Good

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Good

Good

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Dead

Good

Good

Poor

Good

Good

Good

Good

Robinia pseudoacacia

Robinia pseudoacacia

Robinia pseudoacacia

Robinia pseudoacacia

Robinia pseudoacacia

Robinia pseudoacacia

Ulmus americana

Juglans nigra

Juglans nigra

Juglans nigra

Quercus alba

Quercus alba

Juglans nigra

Jualans nigra

Juglans nigra

Quercus alba

Juglans nigra

Ulmus americana

Ulmus americana

Ulmus americana

Ulmus americana

Ulmus americana

Ulmus americana

Morus alba

Fraxinus

Fraxinus

Malus ssp.

Malus ssp.

Malus ssp.

Fraxinus

Malus ssp.

Prunus serotina

Pinus sylvestris

Ulmus americana

Gleditsia triacanthos

Prunus serotina

Prunus serotina

Pinus sylvestris

Pinus sylvestris

Quercus rubra

Prunus serotina

Prunus serotina

Quercus rubra

Ulmus americana

Quercus rubra

Pinus sylvestris

Picea pungens

Ulmus americana

Prunus serotina

Ulmus americana

Ulmus americana

Prunus serotina

Ulmus americana

Ulmus americana

Ulmus americana

Ulmus americana

Ulmus americana

Prunus serotina

Prunus serotina

Ulmus americana

Robinia pseudoacacia

Ulmus americana

Prunus serotina

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Ulmus americana

Ulmus americana

Ulmus americana

Ulmus americana

Ulmus americana

Prunus serotina

Juglans nigra

Cretaegus

Malus ssp.

Ulmus americana

Robinia pseudoacacia

Juglans nigra

Cretaegus

Ulmus americana

Acer nigrum

Juglans nigra

Quercus rubra

Quercus rubra

Prunus serotina

Ulmus americana

Ulmus americana

Ulmus americana

Acer nigrum

Acer nigrum

Crataegus

Black Locust

Black Locust

Black Maple

Black Locust

Hawthorn

Black Locust

Black Locust

Black Locust

Black Walnut

Black Walnut

White Oak

White Oak

Black Walnu

Black Walnut

Black Walnut

Black Maple

Black Walnut

Black Cherry

White Oak

Black Walnut

Red Oak

Red Oak

Elm

Ash

Elm

Apple

Apple

Apple

Black Cherry

Scotch Pine

Honevlocus⁻

Black Cherry

Black Cherry

Scotch Pine

Black Cherry

Black Cherry

Elm

Elm

Elm

Ash

Elm

Elm

Elm

Red Oak

Scotch Pine

Blue Spruce

Black Cherry

Black Cherry

Black Walnut

Black Cherry

Black Cherry

Black Locust

Black Cherry

Black Locust

Black Locust

Black Locust

Black Walnut

Black Locust

Black Locust

Black Locust

Hawthorn

Black Locust

Black Locust

Black Locust

Black Cherry

Apple

Elm

Elm

Elm

10,6

9

129

Black Locust

Ash

Black Locust

Hawthorn

Elm

Elm

Black Maple

9,7

11,7,5

Elm

Black Walnut





NOT FOR CONSTRUCTION

Water Plantain (Various Mix) water Plantain (v anous Mi Swamp Milkweed Bidens (Various Mix) Sneezeweed Monkey Flower Ditch Stonecrop Smartweed Sweet Black-Ey ed Susan Broad-Leaf Arrowhead

Mimulus ringens Penthorum sedoides Polygonum pensylvanicum

Low-Profile Prairie Seed Mi	x	
Botanical Name	Common Namo	PLS Ounces/Acre
Botanical Name	Common Name	Ouncesacie
Permanent Grasses:		
Bouteloua curtipendula	Side Oats Grama	10.00
Carex spp.	Prairie Sedge Mix	1.00
Elymus canadensis	Canada Wild Ry e	16.00
Koeleria pyramidata	June Grass	2.00
Panicum virgatum	Switch Grass	1.00
Schizachyrium scoparium	Little Bluestem	28.00
Sporobolus heterolepis	Prairie Dropseed	3.00
	Total	61.00
Temporary Cover:		
Avena sativa	Common Oat	360.00
Lolium multiflorum	Annual Ry e	120.00
	Total	480.00
Forbs:		
Amorpha canescens	Lead Plant	1.00
Anemone cylindrica	Thimbleweed	0.50
Aquilegia canadensis	Wild Columbine	0.50
Asclepias tuberosa	Butterfly Milkweed	2.00
Aster ericoides	Heath Aster	0.25
Aster laevis	Smooth Blue Aster	0.75
Aster novae-angliae Baptisia lactea	New England Aster White Wild Indigo	0.25 1.00
Chamaecrista fasciculata	Partridge Pea	9.00
Coreopsis lanceolata	Sand Coreopsis	1.50
Coreopsis palmata	Prairie Coreopsis	1.00
Dalea candidum	White Prairie Clover	1.50
Dalea purpurea	Purple Prairie Clover	1.50
Echinacea purpurea	Broad-Leaved Purple Coneflower	3.50
Eryngium yuccifolium	Rattlesnake Master	2.50
Kuhunia eupatoides	False Bone-Set	0.50
Lespedeza capitata	Round-Head Bush Clover	2.00
Liatris aspera	Rough Blazing Star	0.50
Lupinus perennis	Wild Lupine	2.00
Monarda fistulosa	Wild Bergamot	0.50
Parthenium integrifolium	Wild Quinine	1.00
Penstemon digitalis	Fox glove Beard Tongue	0.50
Physostegia virginiana	False Dragonhead	0.25
Pycnanthemum virginianum	Common Mountain Mint	1.00
Ratibida pinnata	Y ellow Coneflower	3.00
Rudbeckia hirta	Black-Ey ed Susan	2.00
Rudbeckia subtomentosa	Sweet Black-Eyed Susan	1.00
Silphium integrifolium	Rosin Weed	0.50
Silphium terebinthinaceum	Prairie Dock	2.00
Solidago nemoralis	Old-Field Goldenrod Stiff Goldenrod	0.25 1.00
Solidago rigida	AND ADDRESS OF THE PARTY OF THE	
Tradescantia ohiensis	Common Spiderwort Ironweed (Various Mix)	0.75 1.75
Vernonia spp. Veronicastrum virginianum	Culver's Root	0.25
voromodotram virginianam	Total	49.75

Maintenance Notes

The owner of the property shall be responsible for all maintenance of site landscaping, as follows:

A. Landscaping shall be kept in a neat, orderly and healthy growing condition, free from debris and refuse.

B. Pruning shall be minimal at the time of installation, only to remove dead or diseased branches. Subsequent pruning shall assure proper maturation of plants to achieve their approved purpose.

C. All dead, damaged, or diseased plant material shall be removed immediately and replaced within six (6) months after it dies or in the next planting season, whichever occurs first. For purposes of this section, the planting season for deciduous plants shall be between March 1 and June 1 and from October 1 until the prepared soil becomes frozen. The planting season for evergreen plants shall be between March 1 and June 1. Plant material installed to replace dead or diseased material shall be as close as practical to the size of the material it is intended to replace. The City may notify property owners of the need to replace dead, damaged, or diseased

D. The approved landscape plan shall be considered a permanent record and integral part of the Site Plan Approval. Unless otherwise approved in accordance with the aforementioned procedures, any revisions to or removal of plant materials, or non-compliance with the maintenance requirements of this Section 138-12.109 will place the parcel in non-conformity with the approved landscape plan and be a violation of this ordinance.

E. If protected trees are damaged, a fine shall be issued on an inch-by-inch basis at a monetary rate as defined by the Forestry Department.

To assist in maintaining plant materials in a healthy condition, all landscaped areas (including lawns) shall be provided with an automatic, underground, or drip irrigation system, subject to the following:

A. The Planning Department may approve an alternative form of irrigation for a particular site, or may waive this requirement upon determining that underground irrigation is not necessary for the type of proposed plant

B. All automatic irrigation systems shall be designed to minimize water usage, and shall be shut off during water emergencies, periods of protracted rainfall, or water rationing periods.

C. The irrigation requirement may be waived by the reviewing authority if the project incorporates landscaping that will contribute points towards LEED

certification or an equivalent rating system. Whenever a landscape planting screen or other plantings are required under this ordinance, such plantings shall be installed according to accepted good planting

procedures and in a sound, workmanlike manner. All plant material shall meet


current standards of the American Association of Nurserymen and approved by the American National Standards Institute, Inc. (ANSI 260.1, 1996). A. All plant material shall be true to name in conformance to the current edition of Standardized Plant Names established by the American Joint Committee on

B. All plant material shall be nursery grown in a northern climate; hardy to the climate of Michigan; appropriate for the soil, climatic and environmental conditions; and resistant to disease and insect attack.

C. A minimum four (4) inches of topsoil shall be provided for all lawn areas, ground covers, and planting beds.

D. Artificial plant material is prohibited and shall not be used to meet the requirements of this Article.

Horticultural Nomenclature, or other source accepted by the City.

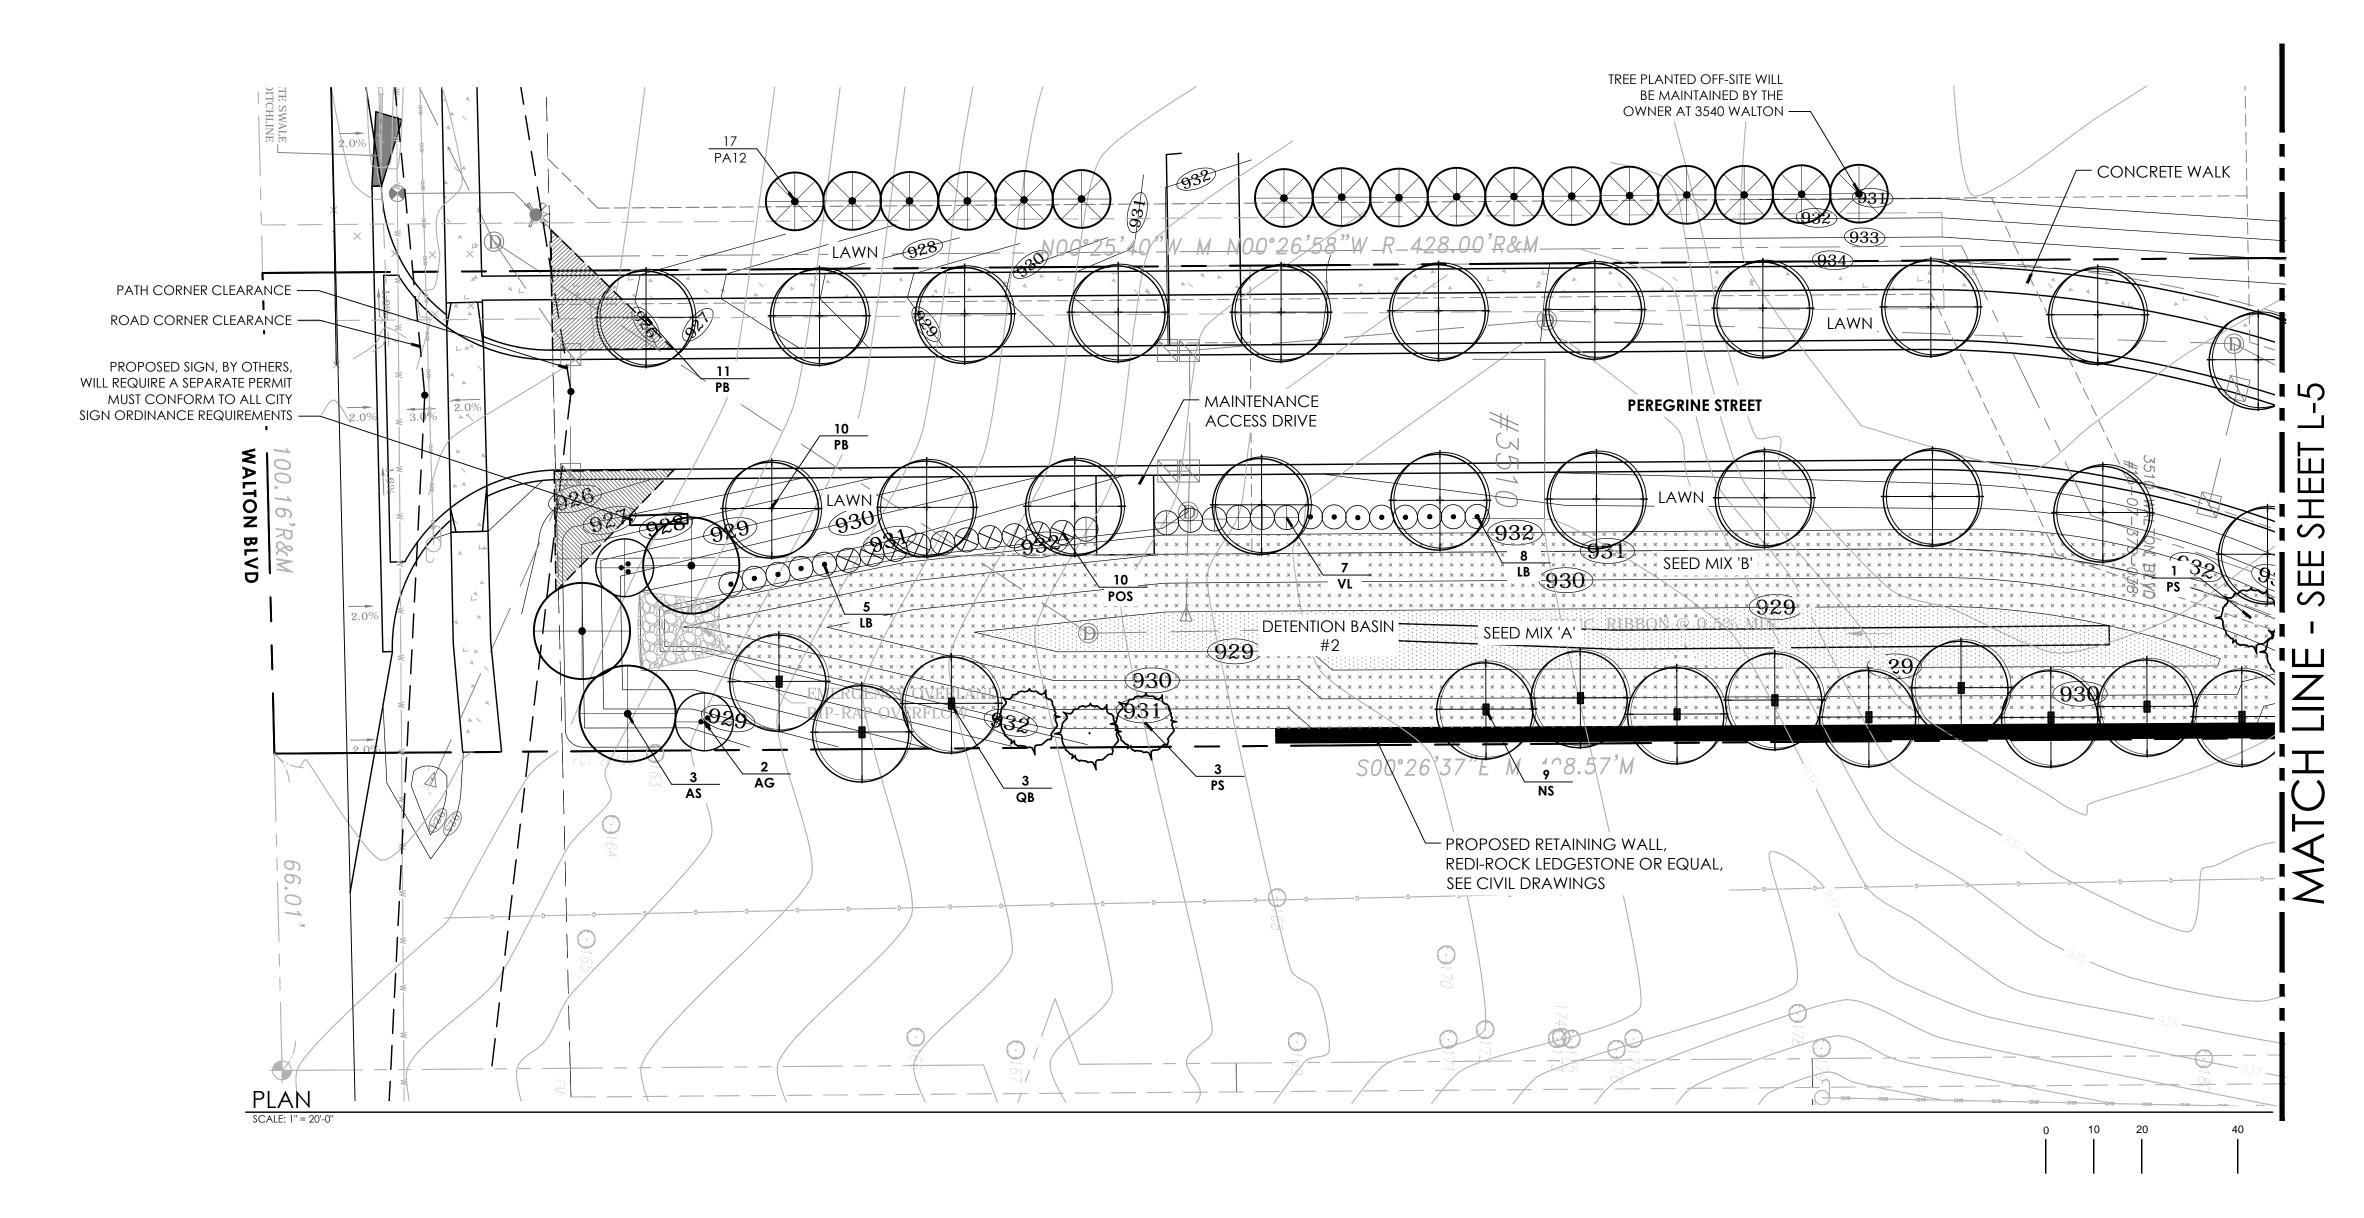

Tree Mitigation Planting Notes

- 1. ALL TREES ARE TO BE PROVIDED BY THE DEVELOPER
- 2. ALL STREET TREES, FRONTAGE TREES, TREES SHOWN IN COMMON AREAS, AND DETENTION BASIN TREES AND SHRUBS SHALL BE PLANTED AS PART OF INITIAL CONSTRUCTION.
- 3. TREES SHOWN TO BE PLANTED ON INDIVIDUAL LOTS SHALL NOT BE PLANTED UNTIL ALL EXTERIOR WORK ON THE UNIT HAS BEEN COMPLETED.
- 4. PLANTINGS SHALL BE COMPLETED PRIOR TO CERTIFICATE OF OCCUPANCY AND SHALL MEET ALL BOND REQUIREMENTS
- 5. SHOULD MITIGATION PLANTING REQUIREMENTS NOT BE COMPLETED, THE BOND WILL BE WITHHELD AND PUT INTO THE CITY'S TREE FUND FOR MITIGATION ELSEWHERE IN THE CITY

ADDITIONAL NOTES:

1. Watering of landscape areas shall only occur between the hours of

2. Prior to the release of the performance bond, the City of Rochester Hills must inspect all landscape plantings

3. All lawn and landscape areas, including rights of way shall be fully irrigated and compliant with Section 138-12.105

4. Any plant material that is designated to be maintained that dies or in damaged during or as a result of construction shall be replaced in kind with like species and sizes

5. All landscaping required pursuant to the City of Rochester Codes and Ordinances shall be maintained in perpetuity

PLANT SCHEDULE

	ITAGE	PLANTINGS									
REES											
QTY	SYM	BOTANICAL NAME	COMMON NAME	SIZE	SPACING	ROOT	COMMENTS		UNIT		TOTAL
2	AG	Amalanchier x g. 'Autumn Brilliance'		6' ht.	as shown	B&B	Minimum 5 stems	\$	325.00	\$	650.00
3	AS	Acer s. 'Green Mountain'	Green Mountain Sugar Maple	3" cal.	as shown	B&B	Single straight trunk	\$	450.00		1,350.00
DETE	NTION	I BASIN PLANTINGS									
TREES											
QTY	SYM	BOTANICAL NAME	COMMON NAME	SIZE	SPACING	ROOT	COMMENTS				
24	NS	Nyssa sylvatica	Blackgum	3" cal.	as shown	B&B	Single straight trunk	\$	450.00	\$	10,800.00
20	PS	Pinus strobus	Eastern White Pine	10' ht.	as shown	B&B	Unsheared, branched to ground		400.00		8,000.00
6	QB	Quercus bicolor	Swamp White Oak	3" cal.	as shown	B&B	Single straight trunk	\$	450.00	\$	2,700.00
SHRU	BS										
25	LB	Lindera benzoin	Spicebush	30" ht.	as shown	cont.	Well rooted	\$	50.00		1,250.00
29	POS	Physocarpus o. 'Summer Wine'	Summer Wine Ninebark	30" ht.	as shown	cont.	Well rooted	\$	50.00		1,450.00
24	VL	Viburnum lentago	Nanny berry Viburnum	30" ht.	as shown	cont.	Well rooted	\$	50.00	\$	1,200.00
TREE	MITIG	ATION PLANTINGS									
TREES											
QTY	SYM	BOTANICAL NAME	COMMON NAME	SIZE	SPACING	ROOT	COMMENTS				
QTY 50	SYM AC	BOTANICAL NAME Abies concolor	COMMON NAME Concolor Fir	SIZE 8' ht.	SPACING as shown	ROOT B&B	COMMENTS Unsheared, branched to ground	\$	400.00	\$	20,000.00
								\$	400.00 400.00		
23 10	AC	Abies concolor Acer r. 'October Glory' Acer s. 'Green Mountain'	Concolor Fir October Glory Red Maple Green Mountain Sugar Maple	8' ht. 2" cal. 2" cal.	as shown as shown as shown	B&B B&B B&B	Unsheared, branched to ground Single straight trunk Single straight trunk	\$	400.00 400.00	\$	9,200.00 4,000.00
50 23 10 35	AC AR AS LT	Abies concolor Acer r. 'October Glory' Acer s. 'Green Mountain' Liriodendron tulipfera	Concolor Fir October Glory Red Maple Green Mountain Sugar Maple Tulip Tree	8' ht. 2" cal. 2" cal. 2" cal.	as shown as shown as shown as shown	B&B B&B B&B B&B	Unsheared, branched to ground Single straight trunk Single straight trunk Single straight trunk	\$ \$	400.00 400.00 400.00	\$ \$ \$	9,200.00 4,000.00 14,000.00
50 23 10 35 8	AC AR AS LT NS	Abies concolor Acer r. 'October Glory' Acer s. 'Green Mountain' Liriodendron tulipfera Nyssa sylvatica	Concolor Fir October Glory Red Maple Green Mountain Sugar Maple Tulip Tree Blackgum	8' ht. 2" cal. 2" cal. 2" cal. 2" cal.	as shown as shown as shown as shown as shown	B&B B&B B&B B&B	Unsheared, branched to ground Single straight trunk Single straight trunk Single straight trunk Single straight trunk	\$ \$ \$	400.00 400.00 400.00 400.00	\$ \$ \$	9,200.00 4,000.00 14,000.00 3,200.00
50 23 10 35 8 19	AC AR AS LT NS PA	Abies concolor Acer r. 'October Glory' Acer s. 'Green Mountain' Liriodendron tulipfera Nyssa sylvatica Picea abies	Concolor Fir October Glory Red Maple Green Mountain Sugar Maple Tulip Tree Blackgum Norway Spruce	8' ht. 2" cal. 2" cal. 2" cal. 2" cal. 8' ht.	as shown as shown as shown as shown as shown as shown	B&B B&B B&B B&B B&B	Unsheared, branched to ground Single straight trunk Single straight trunk Single straight trunk Single straight trunk Unsheared, branched to ground	\$ \$ \$ \$	400.00 400.00 400.00 400.00 400.00	\$ \$ \$ \$	20,000.00 9,200.00 4,000.00 14,000.00 3,200.00 7,600.00
50 23 10 35 8 19 20	AC AR AS LT NS PA PD	Abies concolor Acer r. 'October Glory' Acer s. 'Green Mountain' Liriodendron tulipfera Nyssa sylvatica Picea abies Picea glauca 'Densata'	Concolor Fir October Glory Red Maple Green Mountain Sugar Maple Tulip Tree Blackgum Norway Spruce Black Hills Spruce	8' ht. 2" cal. 2" cal. 2" cal. 2" cal. 8' ht. 8' ht.	as shown as shown as shown as shown as shown as shown as shown	B&B B&B B&B B&B B&B B&B B&B	Unsheared, branched to ground Single straight trunk Single straight trunk Single straight trunk Single straight trunk Unsheared, branched to ground Unsheared, branched to ground	\$ \$ \$ \$	400.00 400.00 400.00 400.00 400.00 400.00	\$ \$ \$ \$	9,200.00 4,000.00 14,000.00 3,200.00 7,600.00 8,000.00
50 23 10 35 8 19 20	AC AR AS LT NS PA PD PM	Abies concolor Acer r. 'October Glory' Acer s. 'Green Mountain' Liriodendron tulipfera Nyssa sylvatica Picea abies Picea glauca 'Densata' Pseudotsuga menziesii	Concolor Fir October Glory Red Maple Green Mountain Sugar Maple Tulip Tree Blackgum Norway Spruce Black Hills Spruce Douglas Fir	8' ht. 2" cal. 2" cal. 2" cal. 2" cal. 8' ht. 8' ht.	as shown	B&B B&B B&B B&B B&B B&B B&B	Unsheared, branched to ground Single straight trunk Single straight trunk Single straight trunk Single straight trunk Unsheared, branched to ground Unsheared, branched to ground Unsheared, branched to ground	\$ \$ \$ \$ \$	400.00 400.00 400.00 400.00 400.00 400.00	\$ \$ \$ \$ \$	9,200.00 4,000.00 14,000.00 3,200.00 7,600.00 8,000.00 4,400.00
50 23 10 35 8 19 20 11	AC AR AS LT NS PA PD PM PS	Abies concolor Acer r. 'October Glory' Acer s. 'Green Mountain' Liriodendron tulipfera Nyssa sylvatica Picea abies Picea glauca 'Densata' Pseudotsuga menziesii Pinus strobus	Concolor Fir October Glory Red Maple Green Mountain Sugar Maple Tulip Tree Blackgum Norway Spruce Black Hills Spruce Douglas Fir Eastern White Pine	8' ht. 2" cal. 2" cal. 2" cal. 2" cal. 8' ht. 8' ht. 8' ht.	as shown as shown as shown as shown as shown as shown as shown as shown	B&B B&B B&B B&B B&B B&B B&B B&B B&B	Unsheared, branched to ground Single straight trunk Single straight trunk Single straight trunk Single straight trunk Unsheared, branched to ground Unsheared, branched to ground Unsheared, branched to ground Unsheared, branched to ground	\$ \$ \$ \$ \$ \$ \$ \$	400.00 400.00 400.00 400.00 400.00 400.00 400.00	\$ \$ \$ \$ \$ \$ \$ \$	9,200.00 4,000.00 14,000.00 3,200.00 7,600.00 8,000.00 4,400.00 8,400.00
50 23 10 35 8 19 20 11 21	AC AR AS LT NS PA PD PM PS QB	Abies concolor Acer r. 'October Glory' Acer s. 'Green Mountain' Liriodendron tulipfera Nyssa sylvatica Picea abies Picea glauca 'Densata' Pseudotsuga menziesii Pinus strobus Quercus bicolor	Concolor Fir October Glory Red Maple Green Mountain Sugar Maple Tulip Tree Blackgum Norway Spruce Black Hills Spruce Douglas Fir Eastern White Pine Swamp White Oak	8' ht. 2" cal. 2" cal. 2" cal. 2" cal. 8' ht. 8' ht. 8' ht. 8' ht. 2" cal.	as shown	B&B B&B B&B B&B B&B B&B B&B B&B B&B B&B	Unsheared, branched to ground Single straight trunk Single straight trunk Single straight trunk Single straight trunk Unsheared, branched to ground Unsheared, branched to ground Unsheared, branched to ground Unsheared, branched to ground Single straight trunk	\$ \$ \$ \$ \$ \$ \$ \$ \$	400.00 400.00 400.00 400.00 400.00 400.00 400.00 400.00 400.00	\$ \$ \$ \$ \$ \$ \$	9,200.00 4,000.00 14,000.00 3,200.00 7,600.00 8,000.00 4,400.00 5,600.00
50 23 10 35 8 19 20 11 21 14	AC AR AS LT NS PA PD PM PS QB	Abies concolor Acer r. 'October Glory' Acer s. 'Green Mountain' Liriodendron tulipfera Nyssa sylvatica Picea abies Picea glauca 'Densata' Pseudotsuga menziesii Pinus strobus Quercus bicolor Quercus coccinea	Concolor Fir October Glory Red Maple Green Mountain Sugar Maple Tulip Tree Blackgum Norway Spruce Black Hills Spruce Douglas Fir Eastern White Pine Swamp White Oak Scarlet Oak	8' ht. 2" cal. 2" cal. 2" cal. 2" cal. 8' ht. 8' ht. 8' ht. 2" cal. 2" cal.	as shown	B&B B&B B&B B&B B&B B&B B&B B&B B&B B&B	Unsheared, branched to ground Single straight trunk Single straight trunk Single straight trunk Single straight trunk Unsheared, branched to ground Unsheared, branched to ground Unsheared, branched to ground Unsheared, branched to ground Single straight trunk Single straight trunk	\$ \$ \$ \$ \$ \$ \$ \$ \$	400.00 400.00 400.00 400.00 400.00 400.00 400.00 400.00 400.00	\$ \$ \$ \$ \$ \$ \$ \$ \$	9,200.00 4,000.00 14,000.00 3,200.00 7,600.00 8,000.00 4,400.00 5,600.00 6,400.00
50 23 10 35 8 19 20 11 21	AC AR AS LT NS PA PD PM PS QB	Abies concolor Acer r. 'October Glory' Acer s. 'Green Mountain' Liriodendron tulipfera Nyssa sylvatica Picea abies Picea glauca 'Densata' Pseudotsuga menziesii Pinus strobus Quercus bicolor	Concolor Fir October Glory Red Maple Green Mountain Sugar Maple Tulip Tree Blackgum Norway Spruce Black Hills Spruce Douglas Fir Eastern White Pine Swamp White Oak	8' ht. 2" cal. 2" cal. 2" cal. 2" cal. 8' ht. 8' ht. 8' ht. 8' ht. 2" cal.	as shown	B&B B&B B&B B&B B&B B&B B&B B&B B&B B&B	Unsheared, branched to ground Single straight trunk Single straight trunk Single straight trunk Single straight trunk Unsheared, branched to ground Unsheared, branched to ground Unsheared, branched to ground Unsheared, branched to ground Single straight trunk	\$ \$ \$ \$ \$ \$ \$ \$ \$	400.00 400.00 400.00 400.00 400.00 400.00 400.00 400.00 400.00	\$ \$ \$ \$ \$ \$ \$ \$ \$	9,200.00 4,000.00 14,000.00 3,200.00 7,600.00 8,000.00 4,400.00 5,600.00 6,400.00
50 23 10 35 8 19 20 11 21 14 16 16	AC AR AS LT NS PA PD PM PS QB QC	Abies concolor Acer r. 'October Glory' Acer s. 'Green Mountain' Liriodendron tulipfera Nyssa sylvatica Picea abies Picea glauca 'Densata' Pseudotsuga menziesii Pinus strobus Quercus bicolor Quercus coccinea Quercus macrocarpa Tilia americana 'Redmond'	Concolor Fir October Glory Red Maple Green Mountain Sugar Maple Tulip Tree Blackgum Norway Spruce Black Hills Spruce Douglas Fir Eastern White Pine Swamp White Oak Scarlet Oak Burr Oak	8' ht. 2" cal. 2" cal. 2" cal. 2" cal. 8' ht. 8' ht. 8' ht. 2" cal. 2" cal. 2" cal.	as shown	B&B B&B B&B B&B B&B B&B B&B B&B B&B B&B	Unsheared, branched to ground Single straight trunk Single straight trunk Single straight trunk Single straight trunk Unsheared, branched to ground Unsheared, branched to ground Unsheared, branched to ground Unsheared, branched to ground Single straight trunk Single straight trunk	\$ \$ \$ \$ \$ \$ \$ \$ \$ \$	400.00 400.00 400.00 400.00 400.00 400.00 400.00 400.00 400.00 400.00 400.00	\$ \$ \$ \$ \$ \$ \$ \$ \$	9,200.00 4,000.00 14,000.00 3,200.00 7,600.00 8,000.00 4,400.00 5,600.00 6,400.00
50 23 10 35 8 19 20 11 21 14 16 16	AC AR AS LT NS PA PD PM PS QB QC QM TA	Abies concolor Acer r. 'October Glory' Acer s. 'Green Mountain' Liriodendron tulipfera Nyssa sylvatica Picea abies Picea glauca 'Densata' Pseudotsuga menziesii Pinus strobus Quercus bicolor Quercus coccinea Quercus macrocarpa Tilia americana 'Redmond'	Concolor Fir October Glory Red Maple Green Mountain Sugar Maple Tulip Tree Blackgum Norway Spruce Black Hills Spruce Douglas Fir Eastern White Pine Swamp White Oak Scarlet Oak Burr Oak	8' ht. 2" cal. 2" cal. 2" cal. 2" cal. 8' ht. 8' ht. 8' ht. 2" cal. 2" cal. 2" cal.	as shown	B&B B&B B&B B&B B&B B&B B&B B&B B&B B&B	Unsheared, branched to ground Single straight trunk Single straight trunk Single straight trunk Single straight trunk Unsheared, branched to ground Unsheared, branched to ground Unsheared, branched to ground Unsheared, branched to ground Single straight trunk Single straight trunk	\$ \$ \$ \$ \$ \$ \$ \$ \$ \$	400.00 400.00 400.00 400.00 400.00 400.00 400.00 400.00 400.00 400.00 400.00	\$ \$ \$ \$ \$ \$ \$ \$ \$	9,200.00 4,000.00 14,000.00 3,200.00
50 23 10 35 8 19 20 11 21 14 16 16 19 STRE	AC AR AS LT NS PA PD PM PS QB QC QM TA	Abies concolor Acer r. 'October Glory' Acer s. 'Green Mountain' Liriodendron tulipfera Nyssa sylvatica Picea abies Picea glauca 'Densata' Pseudotsuga menziesii Pinus strobus Quercus bicolor Quercus coccinea Quercus macrocarpa Tilia americana 'Redmond'	Concolor Fir October Glory Red Maple Green Mountain Sugar Maple Tulip Tree Blackgum Norway Spruce Black Hills Spruce Douglas Fir Eastern White Pine Swamp White Oak Scarlet Oak Burr Oak Redmond American Basswood	8' ht. 2" cal. 2" cal. 2" cal. 2" cal. 8' ht. 8' ht. 8' ht. 2" cal. 2" cal. 2" cal. 2" cal.	as shown as shown	B&B B&B B&B B&B B&B B&B B&B B&B B&B B&B	Unsheared, branched to ground Single straight trunk Single straight trunk Single straight trunk Single straight trunk Unsheared, branched to ground Unsheared, branched to ground Unsheared, branched to ground Unsheared, branched to ground Single straight trunk Single straight trunk Single straight trunk Single straight trunk	\$ \$ \$ \$ \$ \$ \$ \$ \$ \$	400.00 400.00 400.00 400.00 400.00 400.00 400.00 400.00 400.00 400.00 400.00	\$ \$ \$ \$ \$ \$ \$ \$ \$	9,200.00 4,000.00 14,000.00 3,200.00 7,600.00 8,000.00 4,400.00 5,600.00 6,400.00
50 23 10 35 8 19 20 11 21 14 16 16 19	AC AR AS LT NS PA PD PM PS QB QC QM TA	Abies concolor Acer r. 'October Glory' Acer s. 'Green Mountain' Liriodendron tulipfera Nyssa sylvatica Picea abies Picea glauca 'Densata' Pseudotsuga menziesii Pinus strobus Quercus bicolor Quercus coccinea Quercus macrocarpa Tilia americana 'Redmond'	Concolor Fir October Glory Red Maple Green Mountain Sugar Maple Tulip Tree Blackgum Norway Spruce Black Hills Spruce Douglas Fir Eastern White Pine Swamp White Oak Scarlet Oak Burr Oak	8' ht. 2" cal. 2" cal. 2" cal. 2" cal. 8' ht. 8' ht. 8' ht. 2" cal. 2" cal. 2" cal.	as shown	B&B B&B B&B B&B B&B B&B B&B B&B B&B B&B	Unsheared, branched to ground Single straight trunk Single straight trunk Single straight trunk Single straight trunk Unsheared, branched to ground Unsheared, branched to ground Unsheared, branched to ground Unsheared, branched to ground Single straight trunk Single straight trunk	\$ \$ \$ \$ \$ \$ \$ \$ \$ \$	400.00 400.00 400.00 400.00 400.00 400.00 400.00 400.00 400.00 400.00 400.00	\$ \$ \$ \$ \$ \$ \$ \$ \$ \$ \$	9,200.00 4,000.00 14,000.00 3,200.00 7,600.00 8,000.00 4,400.00 5,600.00 6,400.00

Site Landscape Calculations

ROW Frontage - See Sheet L-6 Street Frontage (Walton Blvd.)	100.16 LF	Detention Basin Landscape Basin #1Perimeter	1,198 LF
Deciduous Trees Required	3 Trees (100.16' / 35')	Deciduous Trees Required	18 (1,198' / 100')*1.5
Deciduous Trees Provided	3 Trees	Deciduous Trees Provided	18
Ornamental Trees Required Ornamental Trees Provided	2 Trees (100.16' / 60') 2 Trees	Evergreen Trees Required Evergreen Trees Provided	12 (1,198' / 100') 12
omamonar risso i israed	2 11000	Shrubs Required Shrubs Provided	48 (1,198' / 100')*4 48
Street Trees - internal road			
Road Length	1,505 LF	Basin #2 Perimeter	741 LF
Deciduous Trees Required	43 Trees (1,505' / 35')	Deciduous Trees Required	12 (741' / 100')*1.5
Deciduous Trees Provided	44 Trees	Deciduous Trees Provided	12 (741 7 100) 1.3 12
		Evergreen Trees Required	8 (741' / 100')
NOTE: See Sheet L-6 for Plant So	chedule & Seed Mixes	Evergreen Trees Provided	8
		Shrubs Required	30 (741' / 100')*4

Provide location/distinguish on landscape plan - which proposed plantings are replacement trees vs other required plantings for future inspection purposes.

City Planting Note


Prior approval is required to plant any tree or shrub on the public right-of-way. All trees and shrubs must be planted at least 10' from the edge of the public road. (Trees must be planted at least 15' away from curb or road edge where the speed limit is more than 35 mph.) Shade trees and shrubs must be planted at least 5' from the edge of the public walkway. Evergreen and ornamental trees must be planted at least 10' from the edge of the public walkway. No trees or shrubs may be planted within the triangular area formed at the intersection of any street right-of-way lines at a distance along each line of 25' from their point of intersection. No trees or shrubs may be planted in the triangular area formed at the intersection of any driveway with a public walkway at a distance along each line of 15' from their point of intersection. All trees and shrubs must be planted at least 10' from any fire hydrant. Shade and evergreen trees must be at least 15' away from the nearest overhead wire. Trees must be planted a minimum of 5' from an underground utility, unless the city's Landscape Architect requires a greater distance. Prior to the release of the performance bond, the City of Rochester Hills Forestry Unit needs to inspect all trees, existing or planted, to identify any that pose a hazard to the safe use of the public right-of-way. Forestry may require the developer to remove, and possibly replace, any such trees. The above requirements are incorporated into the plan.

Final tree locations shall be coordinated with the Office of Planning and the Engineering Department to ensure proper location relative to utility and easement locations.





NOT FOR CONSTRUCTION

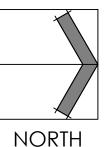

landscape architecture 734.249.3568 Plymouth, MI james@vertverde.com

Preliminary PUD Review 08.30.2021 04.04.2022 07.22.2022 Revision 10.04.2022 Revision 11.07.2022 Revision 01.03.2023 Revision

WALTON OAKS A Planned Unit Development

East Walton Boulevard Rochester Hills, Michigan

Project Sponsor:

Three Oaks Communities, LLC P.O. Box 8307 Ann Arbor, MI 48107

Sheet Name:

Landscape Plan

JG JG Checked: 06.2021 **AS NOTED** Scale:

> Project Number: Sheet Number:

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Know what's below

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	Issued Fo
08.30.2021	Preliminary PUD Revie
04.04.2022	Revisio
07.22.2022	Revisio
10.04.2022	Revisio
11.07.2022	Revisio
01.03.2023	Revisio

East Walton Boulevard Rochester Hills, Michigan

Project Sponsor:

Three Oaks Communities, LLC P.O. Box 8307 Ann Arbor, MI 48107

Landscape Plan Central



Drawn:	JG
Checked:	JG
Date:	06.2021
Scale:	1" = 20'-0"


22.004

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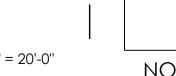


NOTE: SEE SHEET L-4 FOR PLANT SCHEDULE AND SEED MIXES



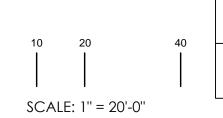


NOT FOR CONSTRUCTION








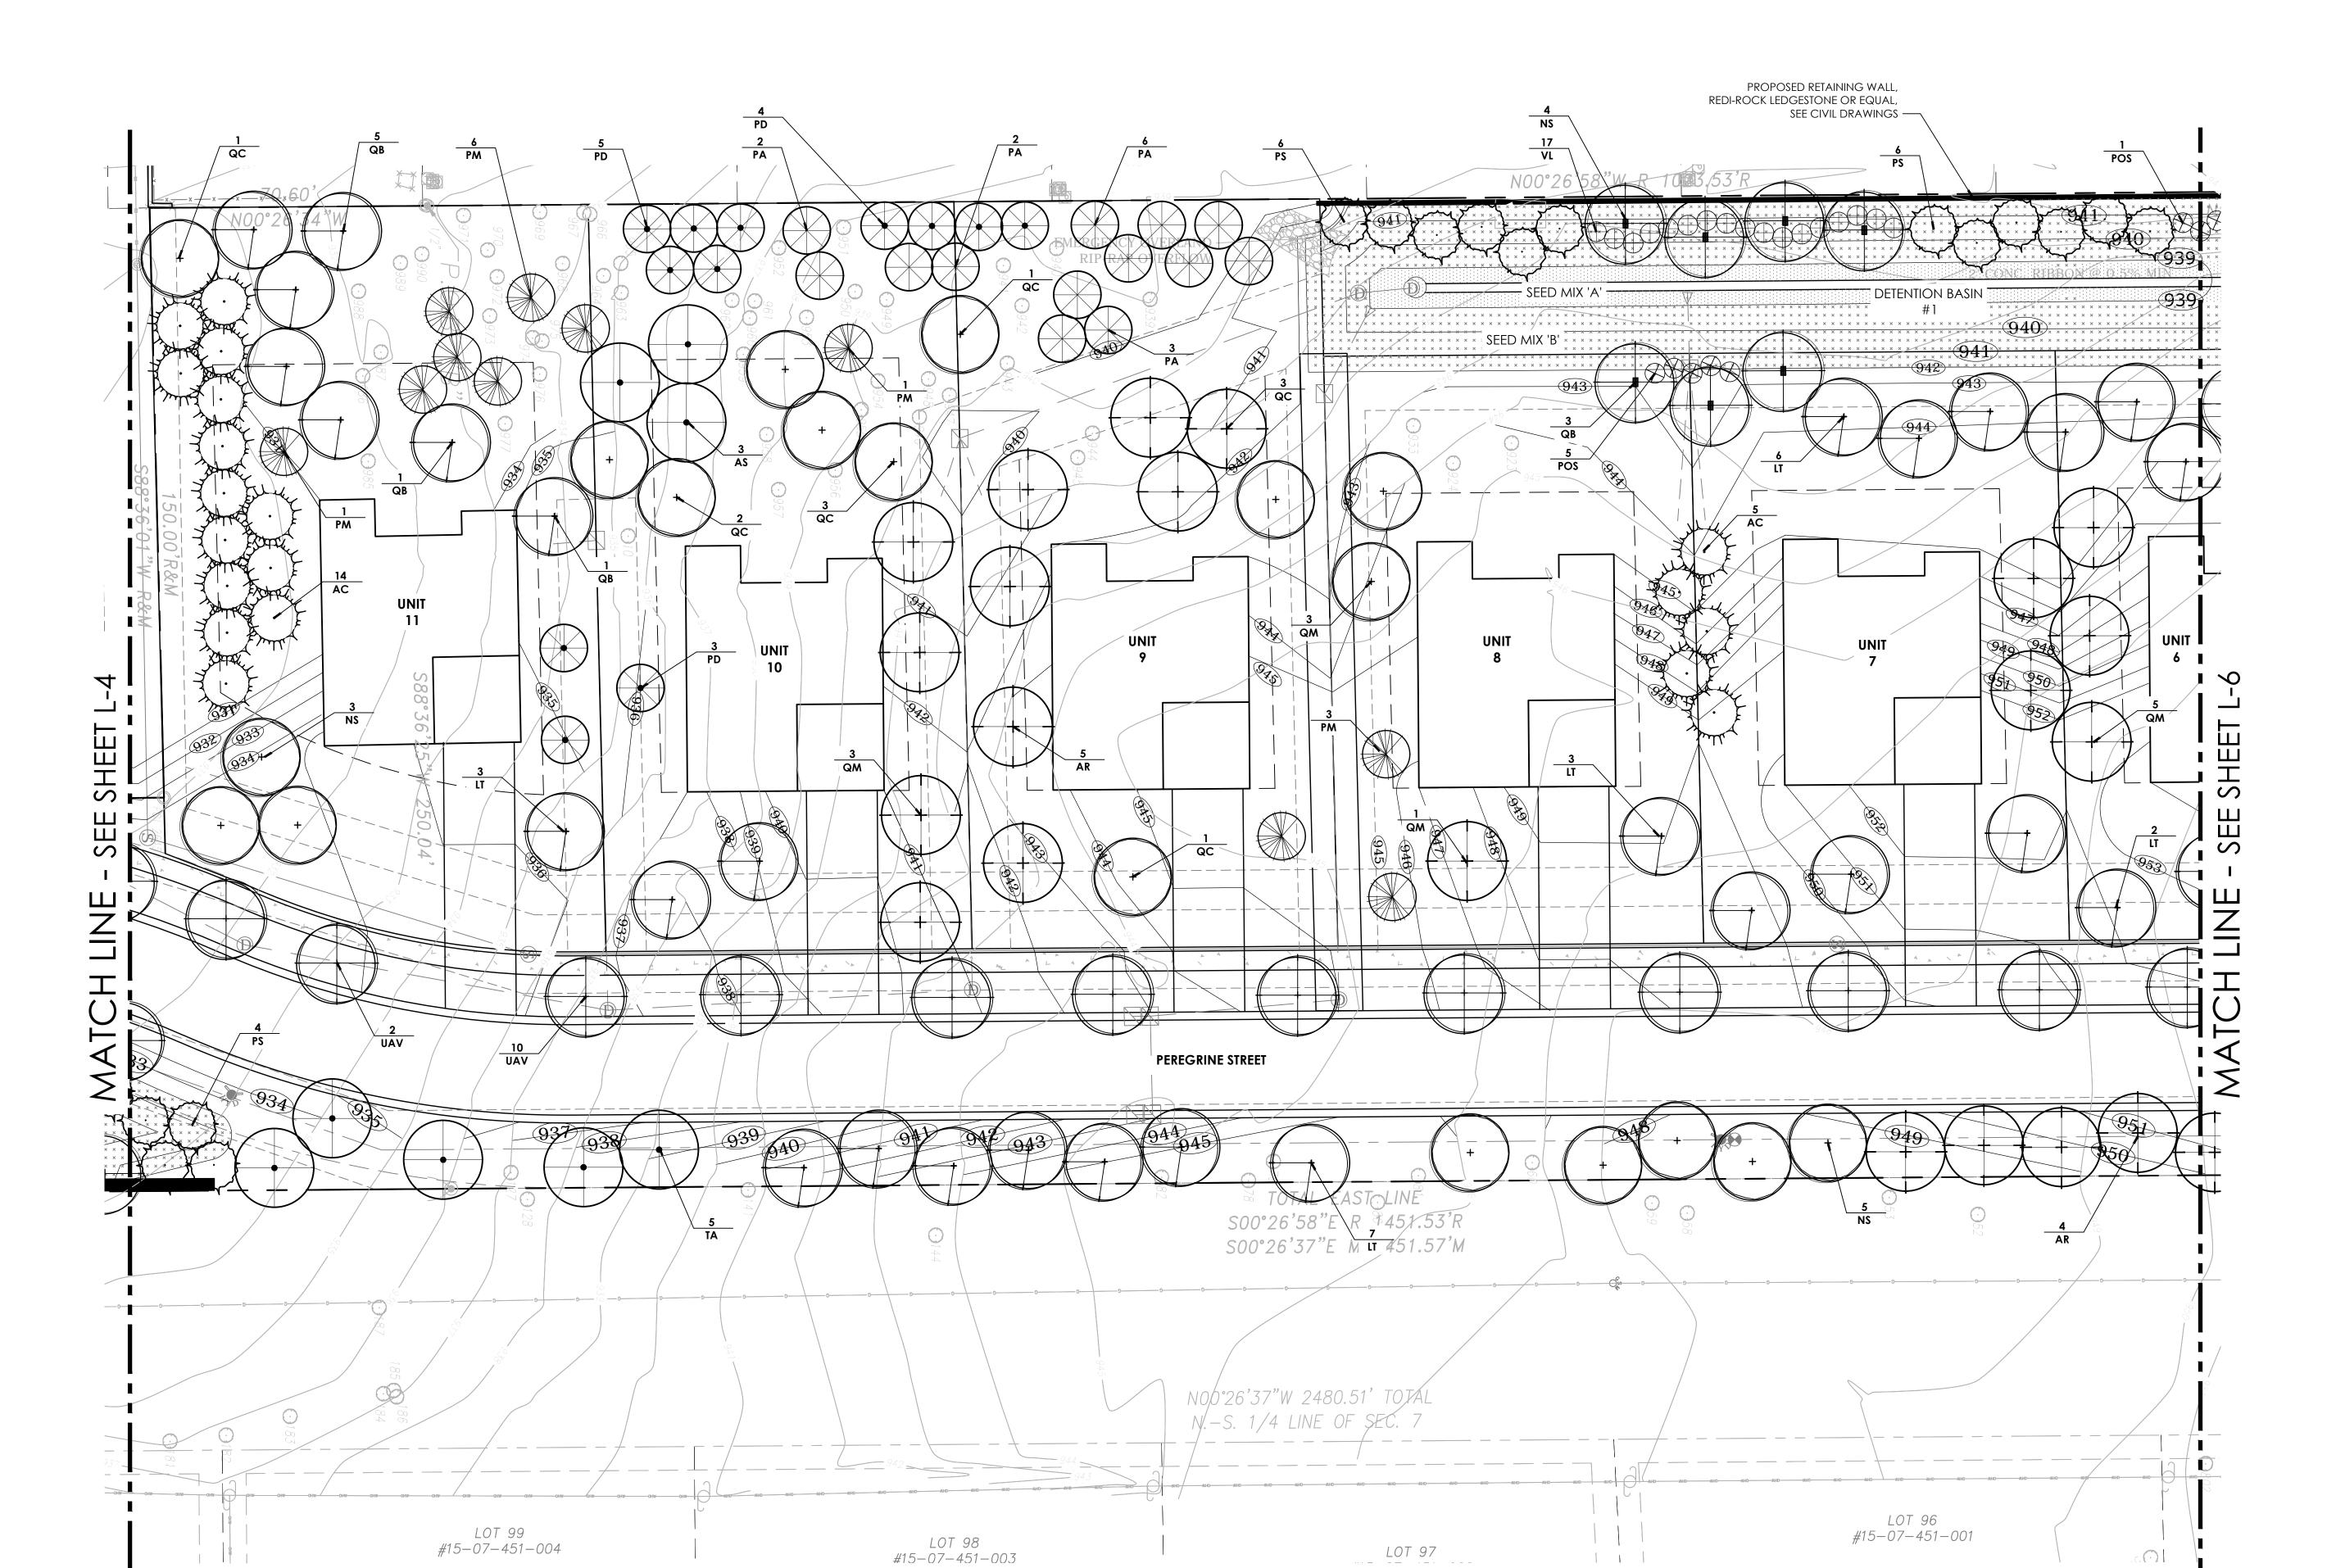

LOT 97

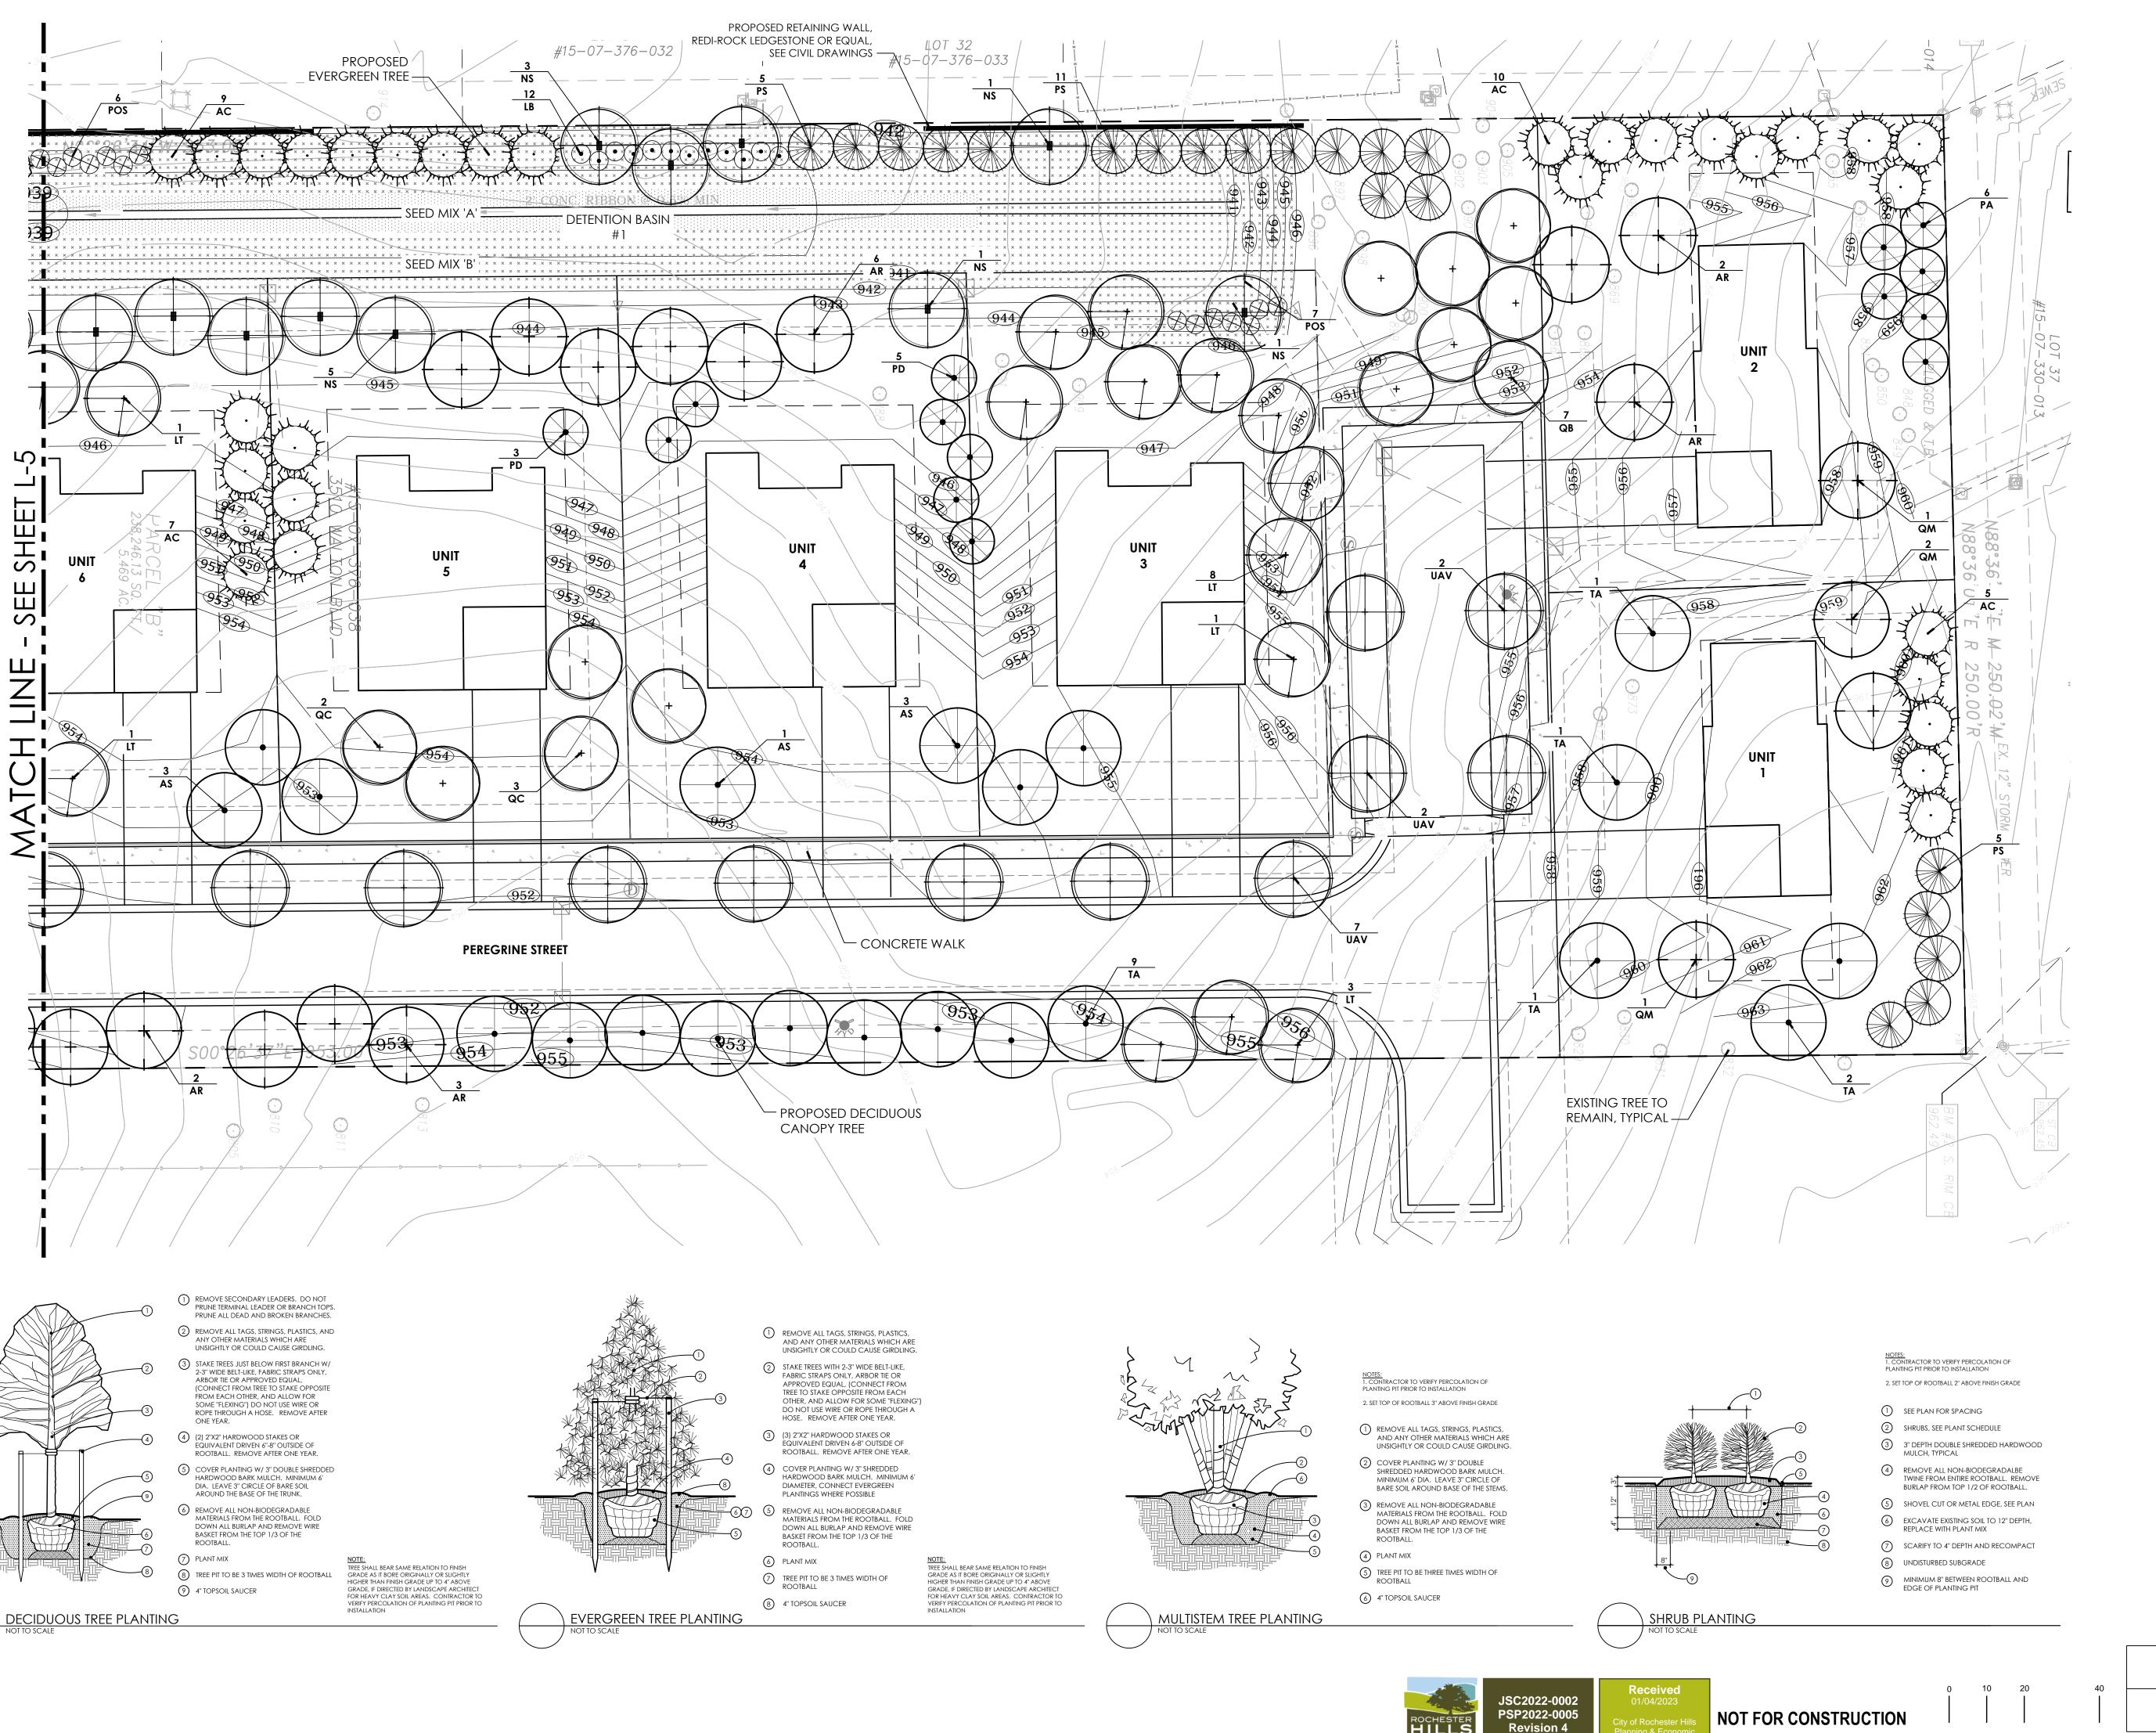



	Issued F
08.30.2021	Preliminary PUD Revie
04.04.2022	Revisi
07.22.2022	Revisi
10.04.2022	Revisi
11.07.2022	Revisi
01.03.2023	Revisi

East Walton Boulevard Rochester Hills, Michigan

Project Sponsor:

Three Oaks Communities, LLC P.O. Box 8307 Ann Arbor, MI 48107

Sheet Name:

Landscape Plan North



Drawn:	JG	
Checked:	JG	
Date:	06.2021	
Scale:	1'' = 20'-0''	

Project Number: Sheet Number:

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SCALE: 1" = 20'-0"

NORTH



FIRE DEPARTMENT

Sean Canto, Fire Chief

From: Vince Foisy
To: Planning Dept.
Date: January 6, 2023

Re: Walton Oaks - Section #7 - City Project # 22-009 Review #3

NOT APPROVED

The street names submitted on the drawings I received by Planning on 1/5/2023 have been reviewed as follows:

The following name(s) is/are Approved:

Prefi	Street	Suffi
X	Name	X
	Peregrine	St

The following name(s) is/are Not Approved:

Prefi	Street	Suffi
X	Name	X

>>> A second street name needed for lots 1 & 2I

NOTE: Requests must not be, Like, Similar and or Sound alike names to ones already approved

To speed your review process up I recommend that you contact me by Email with proposed names prior to your re-submittal:

Email: foisyv@rochesterhills.org

If you have any further questions please contact me at 248.841.2709

VINCENT B. FOISY
Communication Systems Administrator

^{*}No change since REV2