THE TOWNHOMES ON MAPLEHILL TEN LUXURY CONDOMINIUMS

ROCHESTER HILLS, MI

ARCHITECT

THE RON JONA COLLABORATIVE 1066 COMMERCE ST. BIRMINGHAM, MI, 48009 CIVIL ENGINEER/LANDSCAPE ARCHITECT

NOWAK & FRAUS ENGINEERS 46777 WOODWARD AVE PONTIAC, MI 48342 248.332.7931 **OWNER**

MILESTONE DEVELOPMENT 1066 COMMERCE ST. BIRMINGHAM, MI, 48009


PROJECT DATA

BUILDING CODE AUTHORITY: CITY OF ROCHESTER HILLS, MI

CONSTRUCTION CLASSIFICATION: (TABLE 601)V-B

OCCUPANCY CLASSIFICATION: (304.1) R-2 MULTIFAMILY




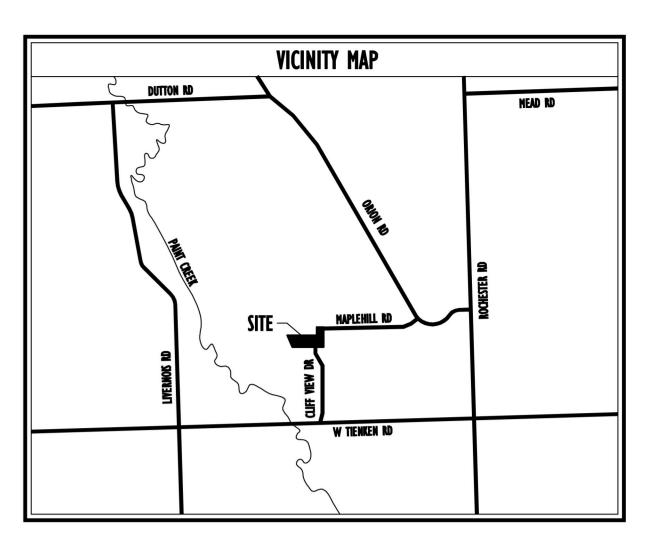

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	REFERENCE	03-26-15	REVISED				
GENE	RAL						
CS-1	TITLE SHEET, SHEET INDEX, AND VICINITY MAP						
	PLANS						
C-1	BOUNDARY, TOPOGRAPHY & TREE SURVEY	•	•				_
C-2	TREE LIST	•	•				_
C-3	PRELIMINARY SITE PLAN		•			-	_
C-4	UTILITY PLAN						_
C-5	STEEP SLOPE PLAN						_
C-6 C-7	SOIL BORINGS STORM MAINT, PLAN						_
	TREE PRESERVATION						_
L-1 L-2	LANDSCAPE PLAN						_
L-Z	LANDSCAFE FLAN						_
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ARCH	ITECTURAL						
A-1	FLOOR PLAN						_
A-2	GARDEN LEVEL PLAN	•	•				_
A-3	ATTIC PLAN	•	•				
A-4	FRONT AND REAR ELEVATIONS		•				_
A-5	SIDE ELEVATIONS						
A-6	ROOF PLAN AND ISOMETRICS						
A-7	SITE DETAILS						
SP-1	SITE PHOTOMETRICS						

SHEET NO.

CS-I

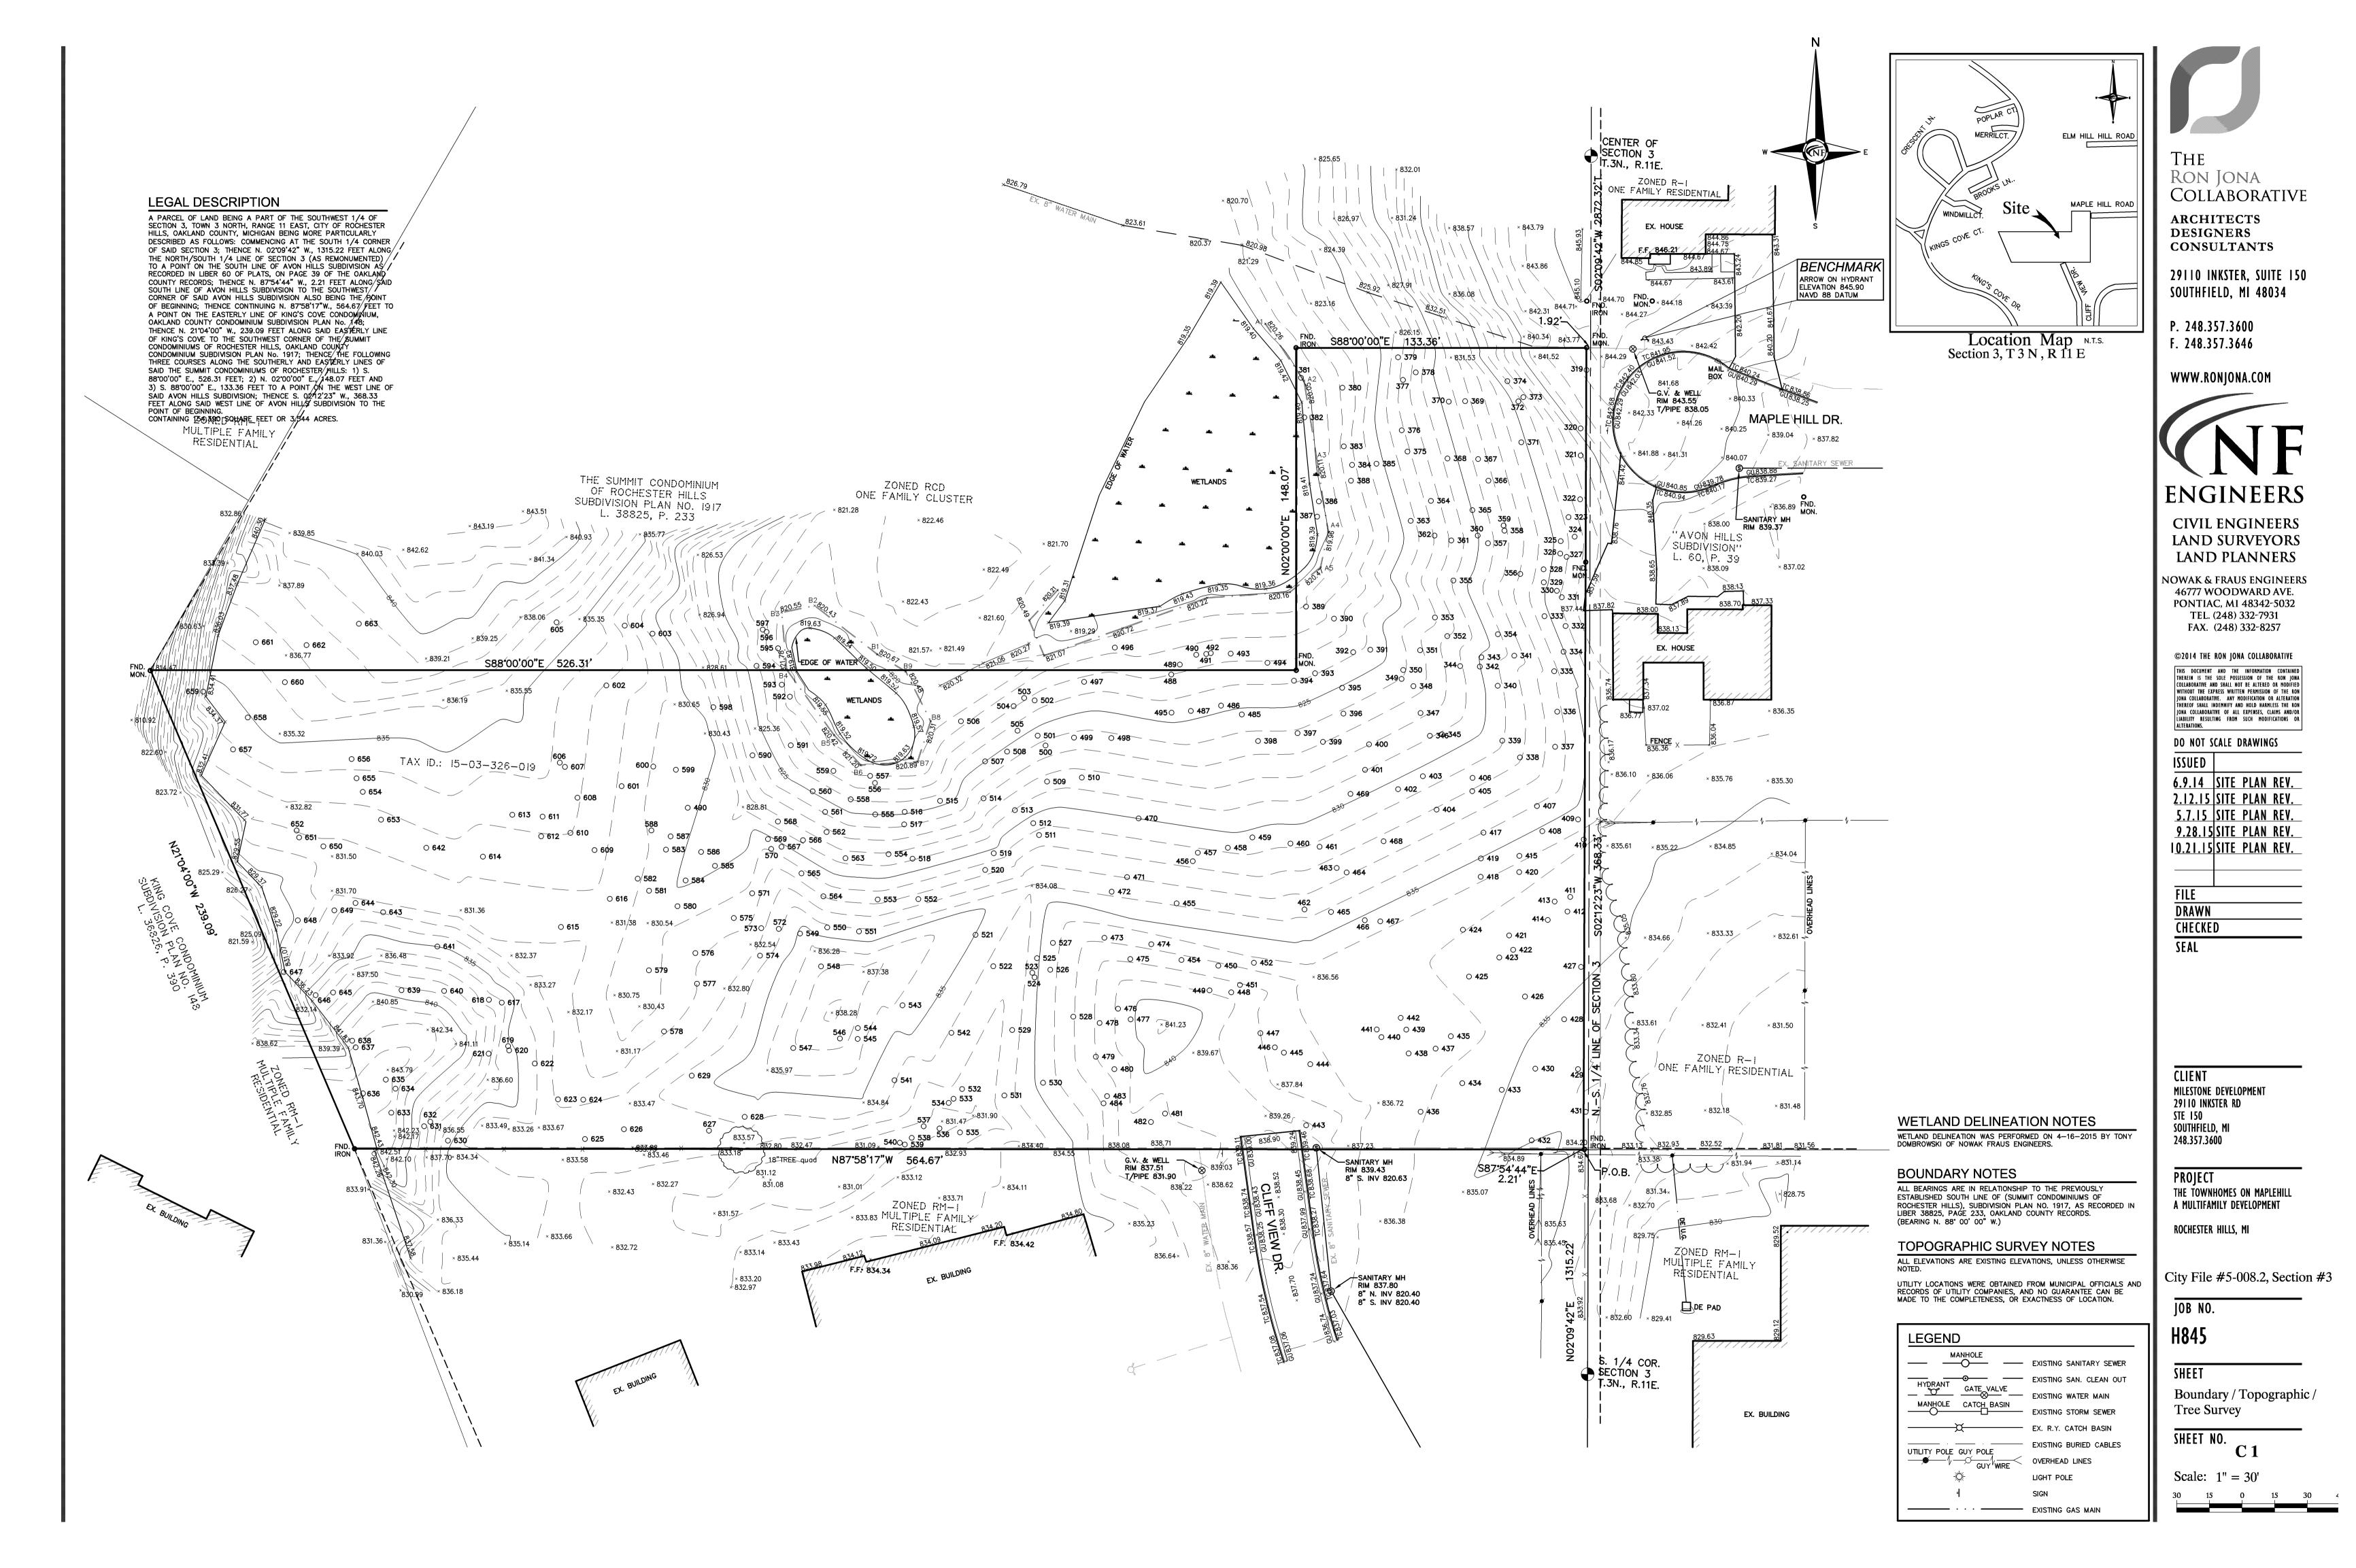

TREE LIST- SURVEY DATE 4/16 /2015

<u>ree #</u> 319	Botanical Name Quercus velutina	<u>Common Name</u> Black Oak	<i><u>Dia.</u></i> 36	<u>Type</u>	Condition Poor
320	Tilia americana	Basswood	28	Multiple	Fair
321	Quercus alba	White Oak	30		Fair
322	Prunus serotina	Black Cherry	6		Poor
323	Prunus serotina	Black Cherry	6		Poor
324 325	Prunus serotina Prunus serotina	Black Cherry Black Cherry	8 8		Poor Fair
326	Prunus serotina	Black Cherry	10		Fair
327	Prunus serotina	Black Cherry	7	Twin	Fair
328	Quercus velutina	Black Oak	9		Fair
329	Quercus velutina	Black Oak	16		Good
330	Prunus serotina	Black Cherry	6		Poor
331	Prunus serotina	Black Cherry	12		Fair
332 333	Prunus serotina Prunus serotina	Black Cherry Black Cherry	17 9		Poor Poor
334	Ulmus americana	American Elm	6		Fair
335	Quercus velutina	Black Oak	9		Good
336	Prunus serotina	Black Cherry	8		Good
337	Quercus velutina	Black Oak	36		Fair
338	Quercus alba	White Oak	10		Poor
339 340	Quercus velutina	Black Oak	16 26		Good Good
341	Quercus velutina Quercus velutina	Black Oak Black Oak	20		Good
342	Quercus velutina	Black Oak	6		Good
343	Quercus velutina	Black Oak	9		Good
344	Quercus velutina	Black Oak	7		Good
345	Quercus velutina	Black Oak	11		Good
346	Quercus velutina	Black Oak	9		Good
347	Quercus velutina	Black Oak	13		Good
348	Quercus velutina	Black Oak	11		Dead
349 350	Quercus velutina Quercus velutina	Black Oak Black Oak	11 11		Fair Good
351	Quercus velutina Quercus velutina	Black Oak	11		Good
352	Quercus velutina	Black Oak	13		Good
353	Prunus serotina	Black Cherry	6		Poor
354	Quercus velutina	Black Oak	8		Good
355	Quercus velutina	Black Oak	42		Fair
356	Quercus velutina	Black Oak	9		Good
357	Quercus velutina	Black Oak	44		Fair
358 359	Prunus serotina Prunus serotina	Black Cherry	6 8		Poor Good
360	Prunus serotina Prunus serotina	Black Cherry Black Cherry	7		Fair
361	Prunus serotina	Black Cherry	8		Poor
362	Prunus serotina	Black Cherry	9		Good
363	Quercus velutina	Black Oak	19		Good
364	Prunus serotina	Black Cherry	8		Good
365	Quercus velutina	Black Oak	6		Good
366	Prunus serotina	Black Cherry	8	Twin	Good
367	Prunus serotina	Black Cherry	17 11	e con o e e cono e e	Good
368 369	Prunus serotina Prunus serotina	Black Cherry Black Cherry	17		Good Good
370	Prunus serotina	Black Cherry	8		Good
371	Quercus velutina	Black Oak	8		Good
372	Quercus velutina	Black Oak	30		Good
373	Tilia americana	Basswood	9	meenmeenmeenmeenmeenmee	Good
374	Prunus serotina	Black Cherry	6	Twin	Good
375	Prunus serotina	Black Cherry	10 8		Good Good
376 377	Prunus serotina Prunus serotina	Black Cherry Black Cherry	10		Poor
378	Prunus serotina	Black Cherry	10		Good
379	Prunus serotina	Black Cherry	6		Good
380	Prunus serotina	Black Cherry	13		Good
381	Quercus alba	White Oak	8		Good
382	Acer saccharinum	Silver Maple	22		Good
383	Prunus serotina	Black Cherry	13	Twin	Poor
384 385	Prunus serotina	Black Cherry	13 9		Poor
385	Prunus serotina Acer rubrum	Black Cherry Red Maple	9 28		Good Good
387	Acer rubrum	Red Maple	20		Good
388	Prunus serotina	Black Cherry	6		Dead
389	Quercus velutina	Black Oak	30		Poor
390	Prunus serotina	Black Cherry	28	Twin	Poor
391	Quercus velutina	Black Oak	8		Good
392	Quercus velutina	Black Oak	24		Good
393 394	Quercus velutina Quercus velutina	Black Oak Black Oak	18 14		Good Good
395	Quercus velutina Quercus velutina	Black Oak	14		Good
396	Prunus serotina	Black Cherry	10		Fair
397	Quercus velutina	Black Oak	20		Good
398	Ulmus americana	American Elm	10		Good
399	Populus grandidentata	Bigtooth Aspen	12		Dead
400	Quercus velutina	Black Oak	20		Good
401	Prunus serotina	Black Cherry	10		Good
402	Prunus serotina	Black Cherry	15 6		Good
403 404	Prunus serotina Quercus bicolor	Black Cherry Swamp White Oak	6 9		Good Good
404	Prunus serotina	Black Cherry	15		Good
406	Prunus serotina	Black Cherry	11	a a a confinita da arteria a da arteria da a	Good
407	Quercus velutina	Black Oak	14		Fair
408	Quercus velutina	Black Oak	15		Good
409	Prunus serotina	Black Cherry	20		Fair
410	Prunus serotina	Black Cherry	6		Fair
411	Quercus velutina	Black Oak	30	R # 24.* *	Poor
412	Prunus serotina	Black Cherry	22	Multiple	Poor
413 414	Quercus velutina Quercus velutina	Black Oak Black Oak	9		Good Good
415	Quercus velutina Quercus velutina	Black Oak	18		Good
416		No tree with this #			
	Quercus velutina	Black Oak	7		Good

ponon						
	419 420	Quercus velutina Quercus velutina	Black Oak Black Oak	14	***************************************	Good
	421	Quercus velutina	Black Oak	6		Good
-	422	Prunus serotina	Black Cherry	10	***************************************	Good
000000	423	Prunus serotina	Black Cherry	9		Good
	424 425	Prunus serotina Prunus serotina	Black Cherry	10 17	Twin	Poor Good
***************************************	425	Quercus velutina	Black Cherry Black Oak	10	IWIII	Good
***************************************	427	Quercus velutina	Black Oak	9		Fair
000000000000000000000000000000000000000	428	Quercus velutina	Black Oak	32	Twin	Good
5 0 0 0 0 0 0 0 0 0 0 0 0 0 0 0 0 0 0 0	429	Ulmus americana	American Elm	20		Dead
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00 00 00 00 00 00 00 00 00 00 00 00 00	432	Morus alba	White Mulberry	16	Twin	Fair
BHHHH BHHHH	433	Ulmus americana	American Elm	9		Good
0 0 0 0 0 0 0 0 0 0 0	434	Acer negundo	Boxelder	8	***************************************	Poor
	435 436	Morus alba Malus spp.	White Mulberry Crabapple spp.	12 10	Multiple	Good Fair
000000	437	Populus deltoides	Eastern Cottonwood	26	Walipio	Good
3	438	Acer negundo	Boxelder	8		Fair
- Consecutive	439	Populus deltoides	Eastern Cottonwood	26		Good
-	440 441	Acer negundo Populus deltoides	Boxelder Eastern Cottonwood	7 22		Poor Good
	442	Morus alba	White Mulberry	9		Fair
	443	Populus deltoides	Eastern Cottonwood	26		Good
_	444	Acer negundo	Boxelder	9	······································	Poor
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	447	Acer negundo	Boxelder	6	RAROOCEA POOCEA ACOCEA ACOCEA ACOCEA ACOCEA ACOCEA ACOCEA	Good
	448	Acer negundo	Boxelder	8		Poor
	449	Populus deltoides	Eastern Cottonwood	22	***************************************	Good
-	450 451	Populus deltoides Populus deltoides	Eastern Cottonwood Eastern Cottonwood	12 20		Good
	452	Prunus serotina	Black Cherry	13		Good
	453	Populus deltoides	Eastern Cottonwood	10	Twin	Good
_	454	Populus deltoides	Eastern Cottonwood	10		Good
-	455 456	Prunus serotina Prunus serotina	Black Cherry Black Cherry	7 6		Good
	457	Quercus bicolor	Swamp White Oak	9	***************************************	Good
	458	Quercus velutina	Black Oak	8		Good
	459	Rhamnus cathartica	Common Buckthorn	6	*************************************	Good
	460 461	Prunus serotina Prunus serotina	Black Cherry Black Cherry	11		Good
	462	Prunus serotina	Black Cherry	20	***************************************	Good
	463	Quercus velutina	Black Oak	7		Good
	464	Prunus serotina	Black Cherry	6		Good
	465 466	Prunus serotina Quercus velutina	Black Cherry Black Oak	15 6	Multiple	Poor Good
	467	Prunus serotina	Black Cherry	20	issiannussiannussiannussiannussiannussiannussiannussiannussi	Good
	468	Prunus serotina	Black Cherry	12	Multiple	Poor
-	469	Quercus velutina	Black Oak	20	N.A. 14: 5 L	Good
	470 471	Prunus serotina Quercus velutina	Black Cherry Black Oak	26 18	Multiple	Poor Good
-	472	Quercus velutina	Black Oak	15	***************************************	Good
	473	Quercus velutina	Black Oak	20		Good
	474	Ulmus americana	American Elm	13	***************************************	Good
	175			10		
	475 476	Prunus serotina Acer negundo	Black Cherry Boxelder	8 13		
	475 476 477	Acer negundo Juniperus virginiana	Boxelder Eastern Red-cedar	8 13 8		Fair Poor
	476 477 478	Acer negundo Juniperus virginiana Morus alba	Boxelder Eastern Red-cedar White Mulberry	13 8 6		Fair Poor Fair
	476 477 478 479	Acer negundo Juniperus virginiana Morus alba Acer negundo	Boxelder Eastern Red-cedar White Mulberry Boxelder	13 8 6 8		Fair Poor Fair Fair
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	476 477 478 479 480 481 482 483 484 485 486 487 488 489 490 491 492 493 494 495 496 497 498 499 500 501 502 503 504 505 506 507	Acer negundo Juniperus virginiana Morus alba Acer negundo Acer negundo Populus deltoides Acer negundo Acer negundo Quercus velutina Prunus serotina Prunus serotina Quercus velutina Quercus velutina Quercus velutina Quercus velutina Quercus velutina Quercus velutina Prunus serotina Quercus velutina Quercus velutina Quercus velutina Prunus serotina	Boxelder Eastern Red-cedar White Mulberry Boxelder Boxelder Boxelder Eastern Cottonwood Boxelder Boxelder Black Oak Black Cherry Black Cherry Black Oak Black Cherry	13 8 6 8 8 9 28 8 6 16 9 9 22 8 9 16 9 20 17 8 14 18 12 16 6 7 14 8 18 20 14 13	Twin Twin Multiple	Fair Poor Fair Good Poor Good Good Poor Good Good Good Good Fair Good Good Good Fair
	476 477 478 479 480 481 482 483 484 485 486 487 488 489 490 491 492 493 494 495 496 497 498 499 500 501 502 503 504 505 506 507 508 509 510 511	Acer negundo Juniperus virginiana Morus alba Acer negundo Acer negundo Populus deltoides Acer negundo Acer negundo Acer negundo Acer negundo Acer negundo Quercus velutina Prunus serotina Prunus serotina Quercus velutina Quercus velutina Quercus velutina Quercus velutina Quercus velutina Quercus velutina Prunus serotina	Boxelder Eastern Red-cedar White Mulberry Boxelder Boxelder Boxelder Eastern Cottonwood Boxelder Boxelder Boxelder Boxelder Boxelder Black Oak Black Cherry Black Cherry Black Oak Black Oak Black Oak Black Oak Black Oak Black Oak Black Cherry Black Oak	13 8 6 8 8 9 28 8 6 16 9 9 22 8 9 16 9 20 17 8 14 18 12 16 6 7 14 8 18 20 14 13 8 7 7 10	Twin Twin Multiple	Fair Poor Fair Good Poor Good Good Poor Good Good Good Fair
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Black Cherry

518 Prunus serotina

Good

519	Prunus serotina	Black Cherry	18		Fair
520	Fraxinus americana	White Ash	17	***************************************	Dead
521	Malus spp.	Crabapple spp.	9		Good
522	Prunus serotina	Black Cherry	12		Good
523 524	Prunus serotina Quercus velutina	Black Cherry Black Oak	11 9		Good Good
525	Prunus serotina	Black Cherry	8	Twin	Good
526	Prunus serotina	Black Cherry	12	IVVIII	Good
527	Prunus serotina	Black Cherry	10	тин н в в ент н в в в постоями протоски протоски протоски протоски протоски протоски протоски протоски протоски п	Good
528		No tree with this #			*****************************
529	Prunus serotina	Black Cherry	8		Good
530	Quercus macrocarpa	Bur Oak	6		Good
531	Acer negundo	Boxelder	16	MAXXXII MAXXII MA	Poor
532	Populus deltoides	Eastern Cottonwood	20	MICO.	Good
533	Populus deltoides	Eastern Cottonwood	22	mark and the second	Good
534 535	Populus deltoides Populus deltoides	Eastern Cottonwood Eastern Cottonwood	26 18	Twin	Good Fair
536	Populus deltoides Populus deltoides	Eastern Cottonwood	22		Good
537	Populus deltoides	Eastern Cottonwood	16	Twin	Good
538	Populus deltoides	Eastern Cottonwood	14		Good
539	Populus deltoides	Eastern Cottonwood	17	nun el el esculur el el el accionata el accionata a accionata a accionata a accionata a accionata a accionata a	Good
540	Populus deltoides	Eastern Cottonwood	18		Good
541	Prunus serotina	Black Cherry	7	III N. H.	Good
542	Acer negundo	Boxelder	7		Fair
543	Acer negundo	Boxelder	9	Twin	Good
544 545	Acer negundo Acer negundo	Boxelder Boxelder	7	Twin	Poor
546	Acer negundo	Boxelder	6		Poor
547	Prunus serotina	Black Cherry	10	***************************************	Good
548	Prunus serotina	Black Cherry	10	MINIAAN DUANIOGERAGOGAGAGAGAGAGAGAGAGAGAGAGAGAGAGAGAGAGA	Good
549	Prunus serotina	Black Cherry	7		Good
550	Rhamnus cathartica	Common Buckthorn	7		Good
551	Ulmus americana	American Elm	9		Good
552	Prunus serotina	Black Cherry	15	Multiple	Poor
553	Prunus serotina	Black Cherry	24	Multiple	Poor
554	Ulmus americana	American Elm	6 7		Good
555 556	Quercus bicolor Prunus serotina	Swamp White Oak Black Cherry	16		Good
557	Ulmus americana	American Elm	10		Good
558	Prunus serotina	Black Cherry	8		Good
559	Prunus serotina	Black Cherry	14		Fair
560	Prunus serotina	Black Cherry	14		Good
561	Ulmus americana	American Elm	8		Good
562	Ulmus americana	American Elm	6		Good
563	Ulmus americana	American Elm	7		Good
564	Ulmus americana	American Elm	11	искори и при при при при при при при при при	Good
565	Ulmus americana	American Elm	11		Good
566 567	Ulmus americana Ulmus americana	American Elm American Elm	15 8	annonen annonen marannon mara	Good Good
568	Prunus serotina	Black Cherry	10		Good
569	Prunus serotina	Black Cherry	12		Good
570	Prunus serotina	Black Cherry	10		Good
571	Prunus serotina	Black Cherry	10	www.memmen.nen.nen.nen.nen.nen.nen.nen.nen.	Good
572	Prunus serotina	Black Cherry	6		Good
573	Prunus serotina	Black Cherry	6		Good
574	Malus spp.	Crabapple spp.	8	~~~~~	Good
575 576	Quercus velutina Quercus velutina	Black Oak Black Oak	17		Good
577	Prunus serotina	Black Cherry	8	жи ее ее ж өее өөө санжоо санжоо санжоо санжоо санжоо	Good
578	Prunus serotina	Black Cherry	17	Multiple	Poor
579	Quercus velutina	Black Oak	16		Good
580	Prunus serotina	Black Cherry	20		Good
581	Quercus velutina	Black Oak	12		Good
582	Quercus velutina	Black Oak	22		Good
583	Prunus serotina	Black Cherry	8	Twin	Poor
584	Prunus serotina	Black Cherry	6		Good
585	Quercus velutina	Black Cherry	19		Good
586 587	Prunus serotina Populus deltoides	Black Cherry Eastern Cottonwood	11 28	Multiple	Good Poor
588	Quercus velutina	Black Oak	18	widitiple	Good
589	Prunus serotina	Black Cherry	17	живе веже место сил это	Good
590	Prunus serotina	Black Cherry	8	шеееш веетоантоантоантоантооантооанто	Good
591	Ulmus americana	American Elm	8		Good
592	Prunus serotina	Black Cherry	8		Good
593	Prunus serotina	Black Cherry	20	Twin	Fair
594	Prunus serotina	Black Cherry	7	THE RESERVE OF THE PROPERTY OF	Good
595 596	Prunus serotina	Black Cherry	7 6	импесения десення на написант на написа	Good Good
596	Malus spp. Prunus serotina	Crabapple spp. Black Cherry	9		Good
598	Ulmus americana	American Elm	16		Good
599	Prunus serotina	Black Cherry	6		Good
600	Rhamnus cathartica	Common Buckthorn	6	Twin	Fair
601	Prunus serotina	Black Cherry	9		Good
602	Prunus serotina	Black Cherry	20	Multiple	Poor
603	Populus grandidentata	Bigtooth Aspen	15		Dead
604	Acer negundo	Boxelder	6		Fair
605	Crataegus spp.	Hawthorn	8	Multiple	Poor
606	Prunus serotina	Black Cherry	8		Good
607 608	Sassafras albidum Ulmus americana	Sassafras American Elm	12 8		Good Good
609	Quercus velutina	Black Oak	8		Good
610	Quercus velutina	Black Oak	8		Good
611	Prunus serotina	Black Cherry	10	Twin	Good
612	Prunus serotina	Black Cherry	7		Good
613	Prunus serotina	Black Cherry	10		Good
614	Prunus serotina	Black Cherry	7		Good
615	Prunus serotina	Black Cherry	24		Good
040	Prunus serotina	Black Cherry	14		Good
616 617	Prunus serotina	Black Cherry	9		Good

619	Prunus serotina	Black Cherry	14		Good
620	Prunus serotina	Black Cherry	7		Good
621	Prunus serotina	Black Cherry	9		Good
622	Prunus serotina	Black Cherry	13	***************************************	Good
623	Prunus serotina	Black Cherry	14		Good
624	Ulmus americana	American Elm	12		Good
625	Rhamnus cathartica	Common Buckthorn	8		Poor
626	Crataegus spp.	Hawthorn	8		Poor
627	Acer negundo	Boxelder	10		Poor
628	Ulmus americana	American Elm	10		Good
629	Prunus serotina	Black Cherry	28		Good
630	Prunus serotina	Black Cherry	14		Good
631	Prunus serotina	Black Cherry	16		Good
632	Ulmus americana	American Elm	18		Good
633	Ulmus americana	American Elm	9		Good
634	Prunus serotina	Black Cherry	6		Good
635	Prunus serotina	Black Cherry	7		Good
636	Prunus serotina	Black Cherry	8		Good
637	Prunus serotina	Black Cherry	8		Good
638	Prunus serotina	Black Cherry	7		Good
639	Ulmus americana	American Elm	16		Good
640	Ulmus americana	American Elm	16		Good
641	Prunus serotina	Black Cherry	22	Twin	Good
642	Populus deltoides	Eastern Cottonwood	17		Good
643	Crataegus spp.	Hawthorn	8	Multiple	Poor
644	Crataegus spp.	Hawthorn	6	Multiple	Poor
645	Prunus serotina	Black Cherry	10		Good
646	Prunus serotina	Black Cherry	8	Twin	Good
647	Prunus serotina	Black Cherry	12		Good
648	Rhamnus cathartica	Common Buckthorn	8	Multiple	Poor
649	Crataegus spp.	Hawthorn	7	Multiple	Poor
650	Prunus serotina	Black Cherry	10		Good
651	Prunus serotina	Black Cherry	8		Good
652	Prunus serotina	Black Cherry	9	***************************************	Good
653	Quercus velutina	Black Oak	8		Good
654	Ulmus americana	American Elm	15		Good
655	Crataegus spp.	Hawthorn	9	Twin	Poor
656	Ulmus americana	American Elm	10	nmenenan menenanan menenan men	Good
657	Prunus serotina	Black Cherry	16	nuseananseananseananseananseananseananseananse	Good
658	Crataegus spp.	Hawthorn	7	Twin	Poor
659	Prunus serotina	Black Cherry	11	т 🗸 🗘 1 1 1	Good
660	Prunus serotina	Black Cherry	9	Twin	Good
661	Rhamnus cathartica	Common Buckthorn	8	Multiple	Poor
662	Crataegus spp.	Hawthorn	10	ividiapie	Poor
663	Ulmus americana	American Elm	9	***************************************	Good
000	Ullius allicitualla	American Lilli			Good




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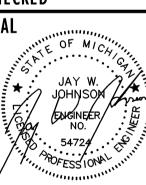
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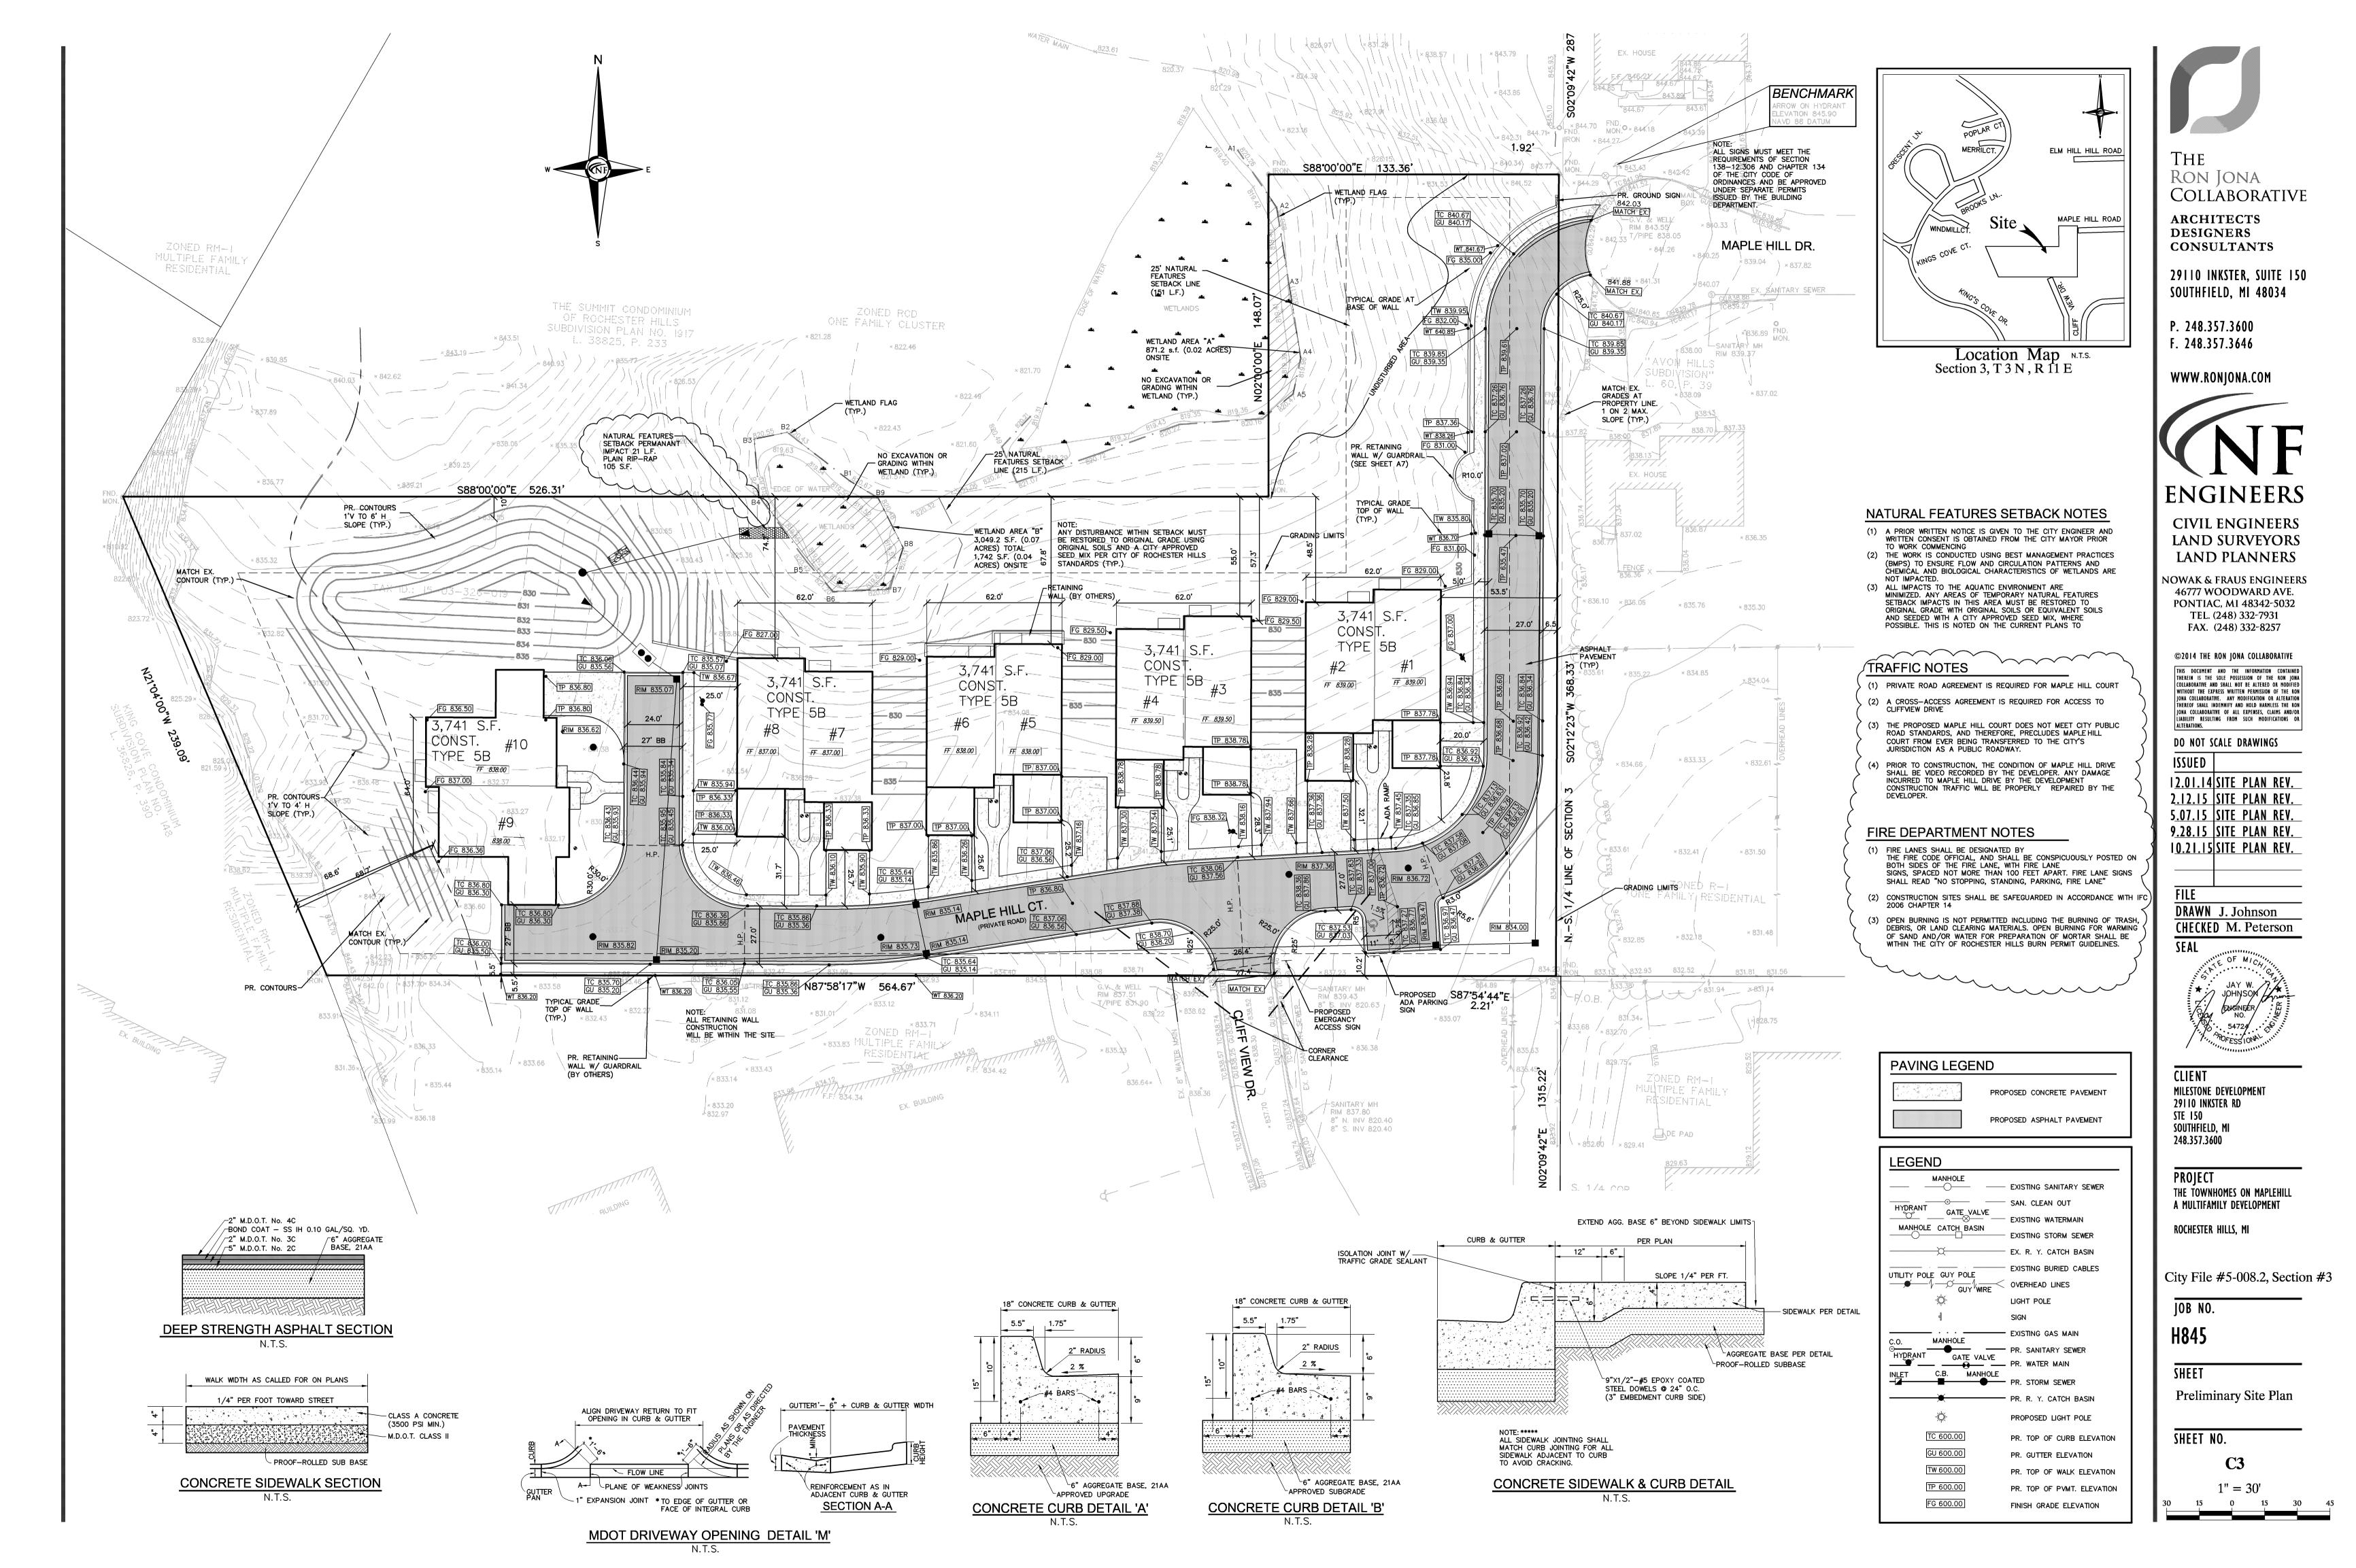
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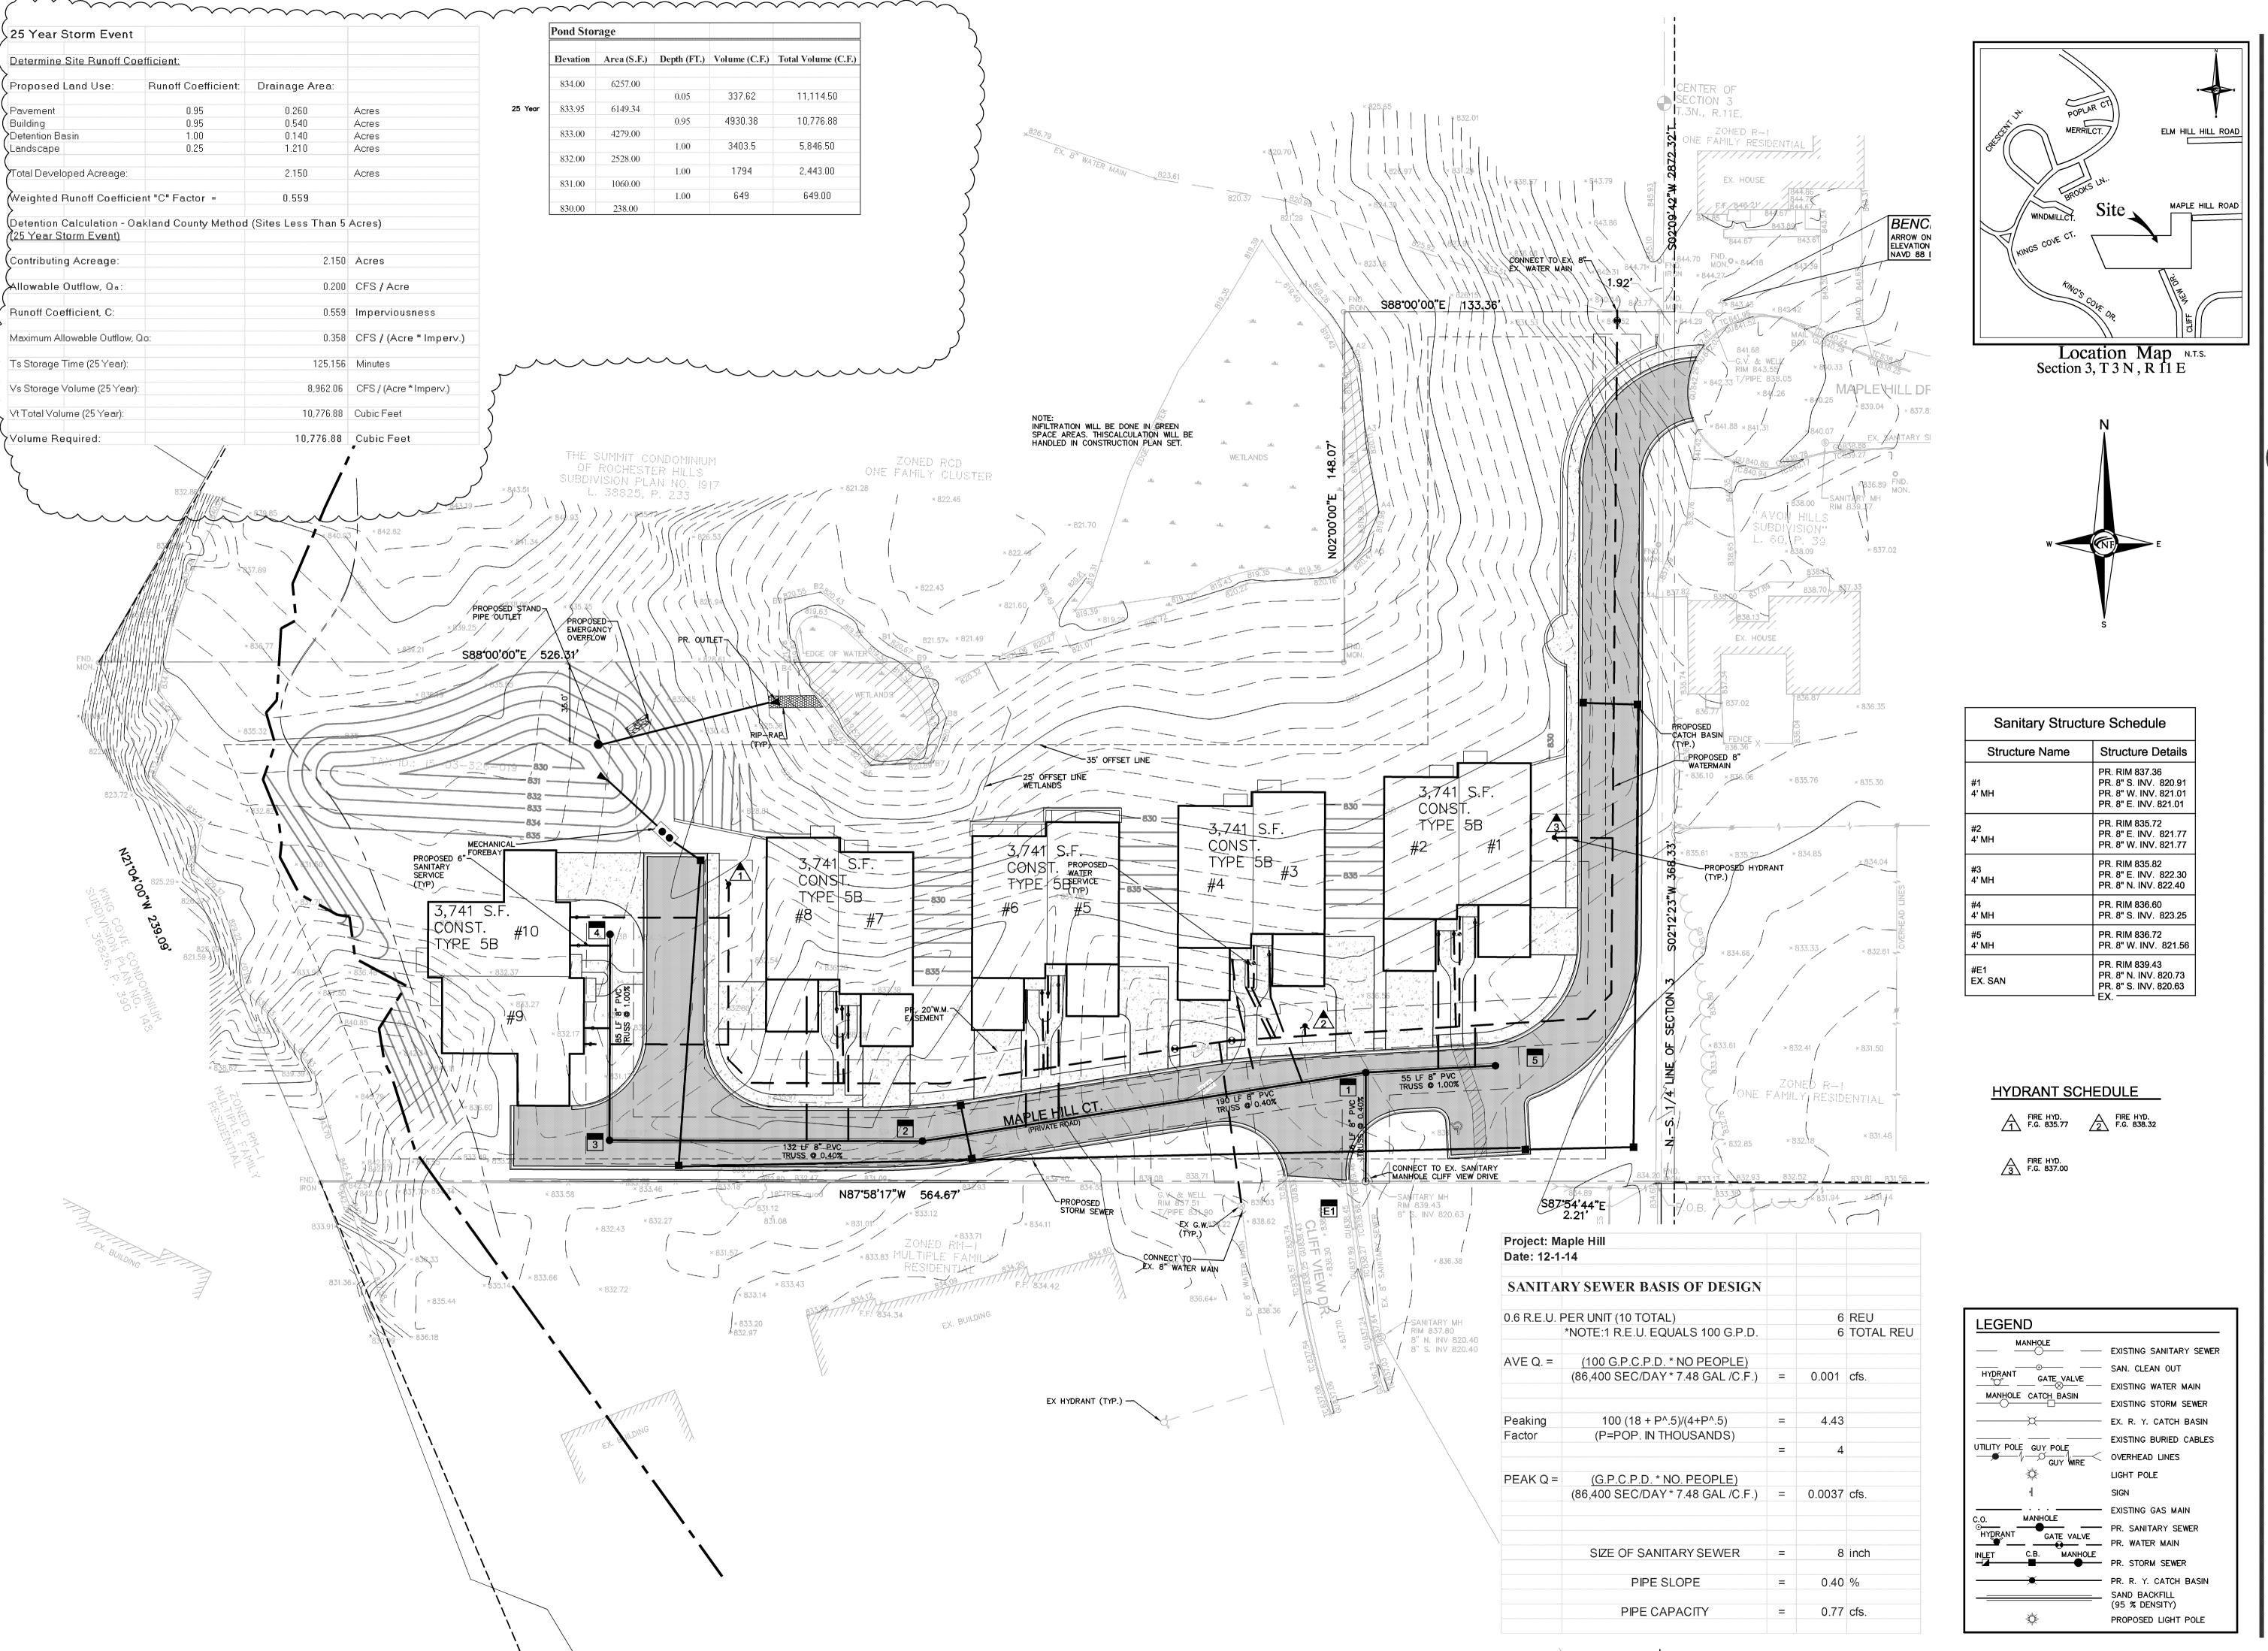
PROJECT
THE TOWNHOMES ON MAPLEHILL A MULTIFAMILY DEVELOPMENT

ROCHESTER HILLS, MI

City File #5-008.2, Section #3

Tree List



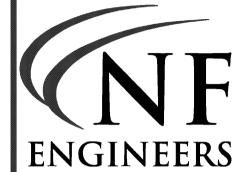



THE Ron Jona Collaborative

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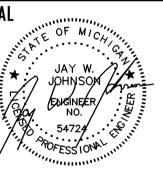
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PROJECT
THE TOWNHOMES ON MAPLEHILL
A MULTIFAMILY DEVELOPMENT

ROCHESTER HILLS, MI

City File #5-008.2, Section #3

JOB NO.

SHEET
Utility Plan

SHEET NO.

C4 1'' = 30'0 15 30



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5.07.15 **SITE PLAN REV.** 9.28.15 SITE PLAN REV. 10.21.15 SITE PLAN REV.

DRAWN J. Johnson CHECKED M. Peterson

MILESTONE DEVELOPMENT 29110 INKSTER RD

THE TOWNHOMES ON MAPLEHILL A MULTIFAMILY DEVELOPMENT





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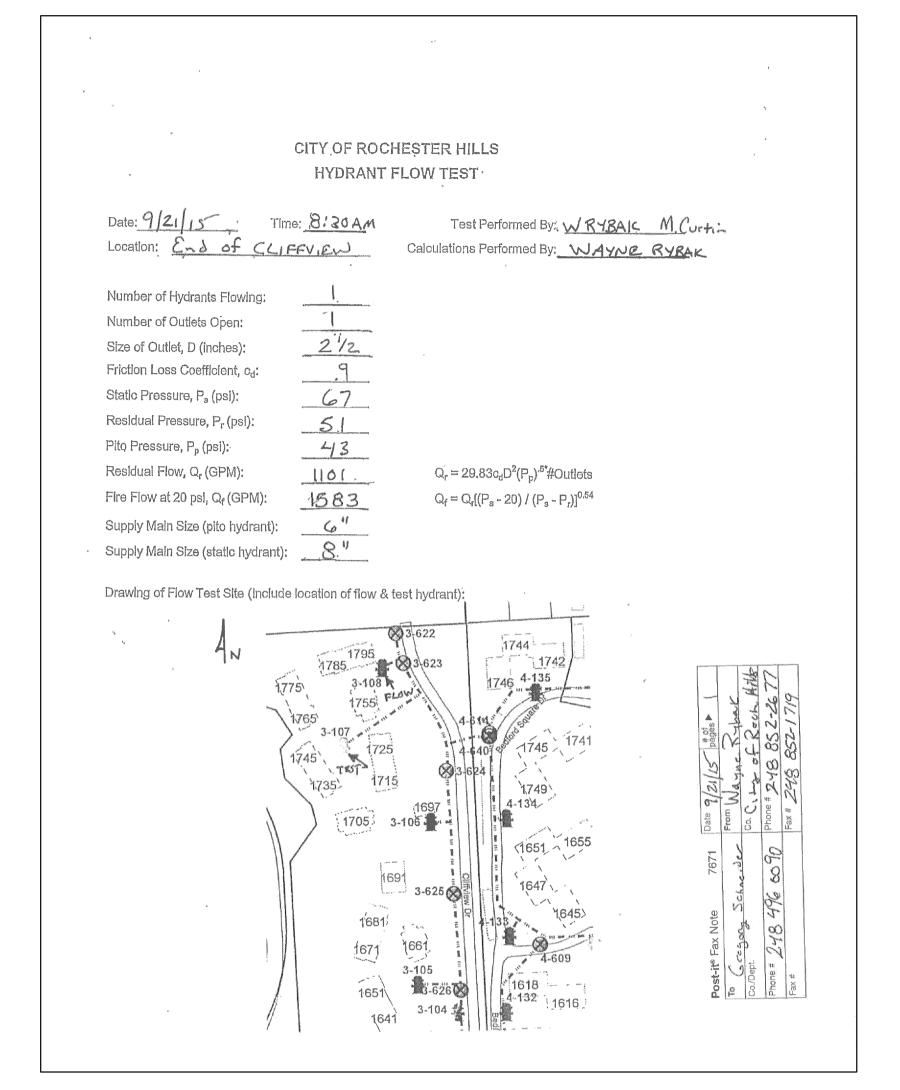
Boring No.: 8	Job No. : 56056	Project: Maplehill Townhomes			
Client: The Ron Jor	na Collaborative	Location: Rochester Hills, Michigan			
Type of Rig: All-Ter	rain Vehicle				
Drilling Method: Solid Stem Augers		Drilled By: I. Mickle			
Ground Surface Ele	evation:	Started: 9/11/2015			
Oroana canace En		Completed: 9/11/2015			


Depth (ft)	Sample Type	N	Strata Change	Soll Classification	w	d	qı
2.5—	LS	3 5 7	.83	Moist Dark Brown Sandy TOPSOIL (10") Medium Compact Moist Brown SAND With Trace Of Gravel &	11.1	134	
5.0	LS	12 14 15	4	Gravel Seam Medium Compact Moist Brown Clayey SAND With Trace Of	6.3	121	
7.5—	LS	8 13 19	6 8	Gravel Compact Moist Brown Clayey SAND With Trace Of Gravel	8.8	143	19
10.0	LS	10 13 17		Extremely Stiff Moist Brown CLAY With Some Silt & Trace Of Gravel	12.8		
12.5			13				
15.0—	LS	42/6"	15	Hard Moist Brown CLAY With Some Silt Bottom of Borehole at 15'	9.7	142	
17.5							
20.0							
22.5							
"N" - Stan	dard Penetrati	on Resistanc	e w - H2O,	% of dry weight K=1 x 10-6 cm/sec Water Enco Density, pcf onfined Compression, psf ct Push At Complete	ountered:	None	<u> </u>

Boring No. 8



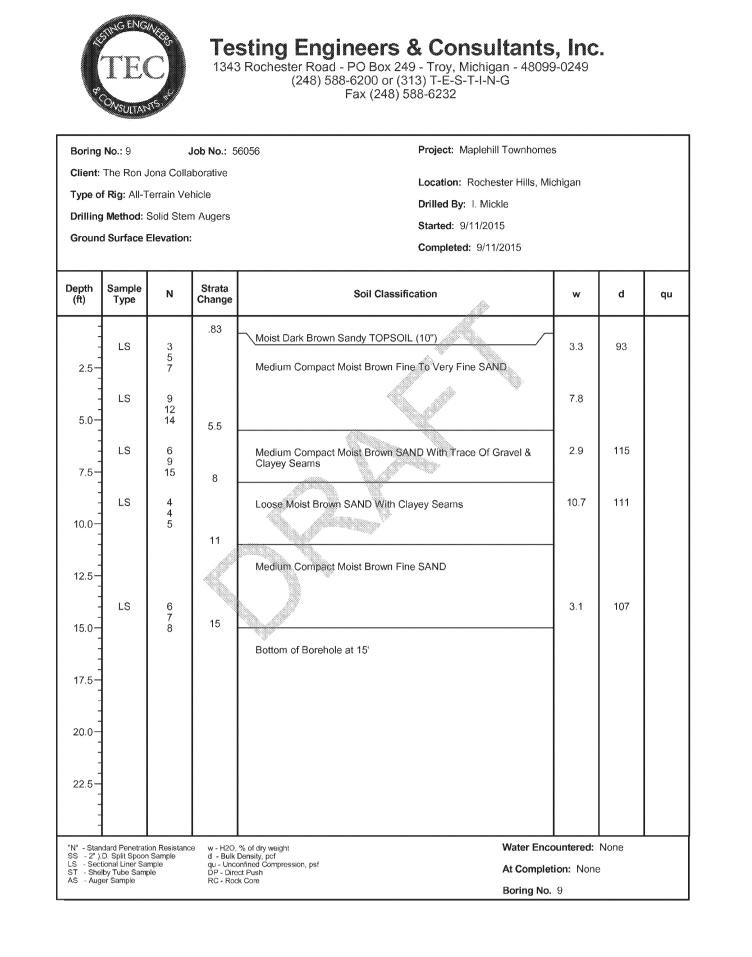

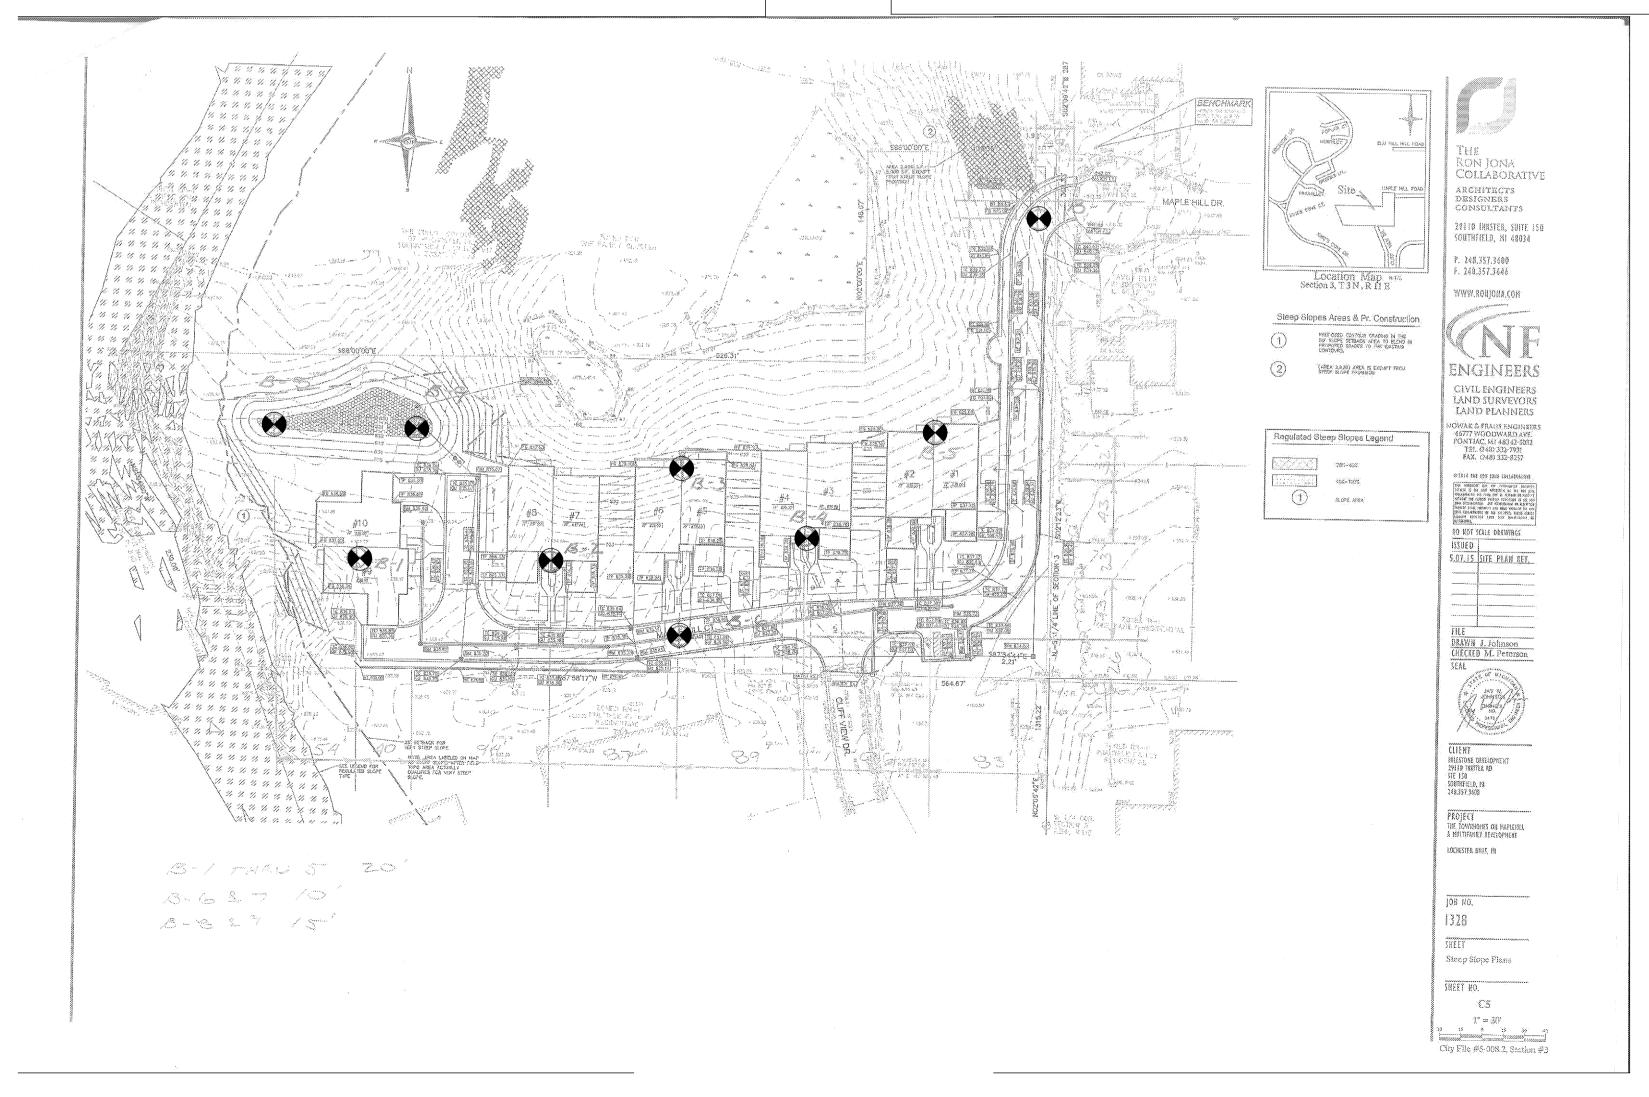

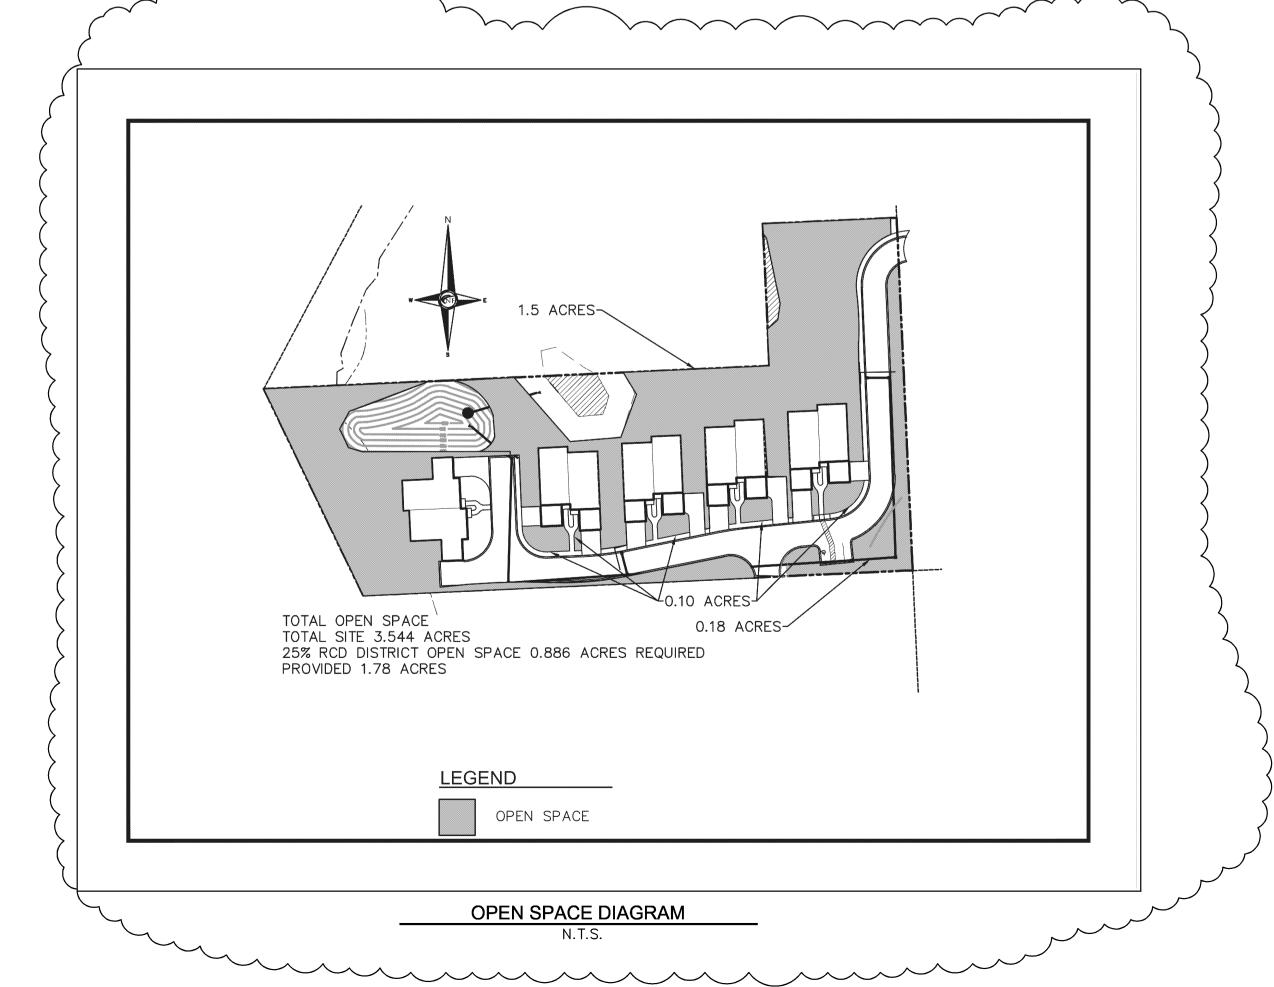




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2.12.15 SITE PLAN REV.
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9.28.15 SITE PLAN REV.
10.21.15 SITE PLAN REV.

FILE
DRAWN J. Johnson
CHECKED M. Peterson

CLIENT
MILESTONE DEVELOPMENT
29110 INKSTER RD
STE 150
SOUTHFIELD, MI
248.357.3600

PROJECT
THE TOWNHOMES ON MAPLEHILL
A MULTIFAMILY DEVELOPMENT

ROCHESTER HILLS, MI

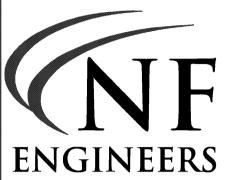City File #5-008.2, Section #3

JOB NO

Soil Borings

SHEET NO.

N.T.S.

Exhibit A

LEGAL DESCRIPTION: PARCEL

A PARCEL OF LAND BEING A PART OF THE SOUTHWEST 1/4 OF SECTION 3, TOWN 3 NORTH, RANGE 11 EAST, CITY OF ROCHESTER HILLS, OAKLAND COUNTY, MICHIGAN BEING MORE PARTICULARLY DESCRIBED AS FOLLOWS: COMMENCING AT THE SOUTH 1/4 CORNER OF SAID SECTION 3; THENCE N. 02°09'42" E., 1315.22 FEET ALONG THE NORTH/SOUTH 1/4 LINE OF SECTION 3 (AS REMONUMENTED) TO A POINT ON THE SOUTH LINE OF AVON HILLS SUBDIVISION AS RECORDED IN LIBER 60 OF PLATS, ON PAGE 39 OF THE OAKLAND COUNTY RECORDS; THENCE N. 87°54'44" W., 2.21 FEET ALONG SAID SOUTH LINE OF AVON HILLS SUBDIVISION TO THE SOUTHWEST CORNER OF SAID AVON HILLS SUBDIVISION ALSO BEING THE POINT OF BEGINNING; THENCE CONTINUING N. 87°58'17"W., 564.67 FEET TO A POINT ON THE EASTERLY LINE OF KING'S COVE CONDOMINIUM, OAKLAND COUNTY CONDOMINIUM SUBDIVISION PLAN No. 148; THENCE N. 21°04'00" W., 239.09 FEET ALONG SAID EASTERLY LINE OF KING'S COVE TO THE SOUTHWEST CORNER OF THE SUMMIT CONDOMINIUMS OF ROCHESTER HILLS, OAKLAND COUNTY CONDOMINIUM SUBDIVISION PLAN No. 1917; THENCE THE FOLLOWING THREE COURSES ALONG THE SOUTHERLY AND EASTERLY LINES OF SAID THE SUMMIT CONDOMINIUMS OF ROCHESTER HILLS: 1) S. 88°00'00" E., 526.31 FEET; 2) N. 02°00'00" E., 148.07 FEET AND 3) S. 88°00'00" E., 133.36 FEET TO A POINT ON THE WEST LINE OF SAID AVON HILLS SUBDIVISION; THENCE S. 0212'23" W., 368.33 FEET ALONG SAID WEST LINE OF AVON HILLS SUBDIVISION TO THE POINT OF BEGINNING. CONTAINING 154,390 SQUARE FEET OR 3.544 ACRES. PARCEL NO. 15-03-326-019



ENGINEERS
NOWAK & FRAUS ENGINEERS
1310 N. STEPHENSON HWY.
ROYAL OAK, MI 48067-1508
TEL. (248) 399-0886
FAX. (248) 399-0805

Prepared For:
Milestone Development
29110 Inkster Rd
Suite 150
Southfield, MI 48034

 SCALE
 DATE
 DRAWN
 JOB NO.
 SHEET

 34
 NTS
 09-22-2015
 N.N.
 H845
 1 of 3

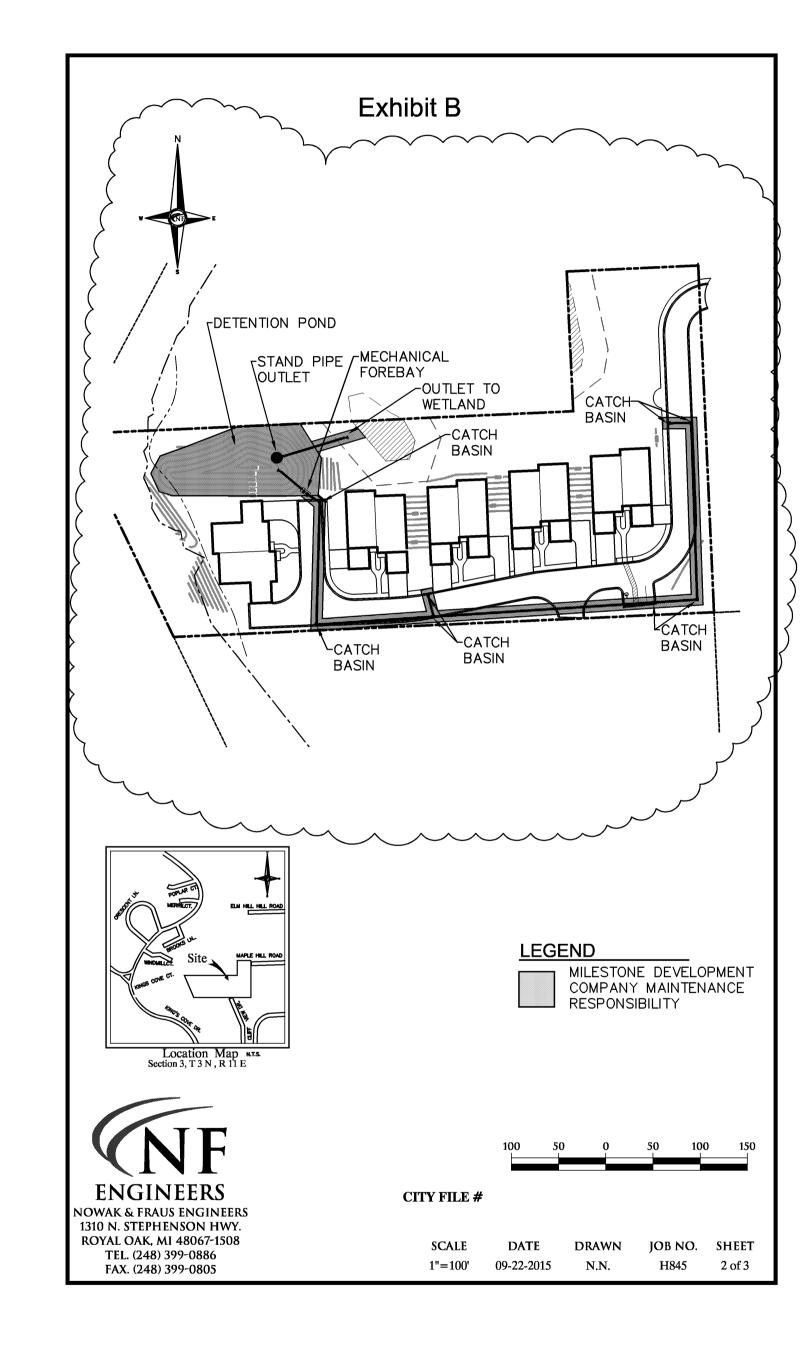


Exhibit C

LEGAL DESCRIPTION: PARCEL

A PARCEL OF LAND BEING A PART OF THE SOUTHWEST 1/4 OF SECTION 3, TOWN 3 NORTH, RANGE 11 EAST, CITY OF ROCHESTER HILLS, OAKLAND COUNTY, MICHIGAN BEING MORE PARTICULARLY DESCRIBED AS FOLLOWS: COMMENCING AT THE SOUTH 1/4 CORNER OF SAID SECTION 3; THENCE N. 02°09'42" E., 1315.22 FEET ALONG THE NORTH/SOUTH 1/4 LINE OF SECTION 3 (AS REMONUMENTED) TO A POINT ON THE SOUTH LINE OF AVON HILLS SUBDIVISION AS RECORDED IN LIBER 60 OF PLATS, ON PAGE 39 OF THE OAKLAND COUNTY RECORDS; THENCE N. 87°54'44" W., 2.21 FEET ALONG SAID SOUTH LINE OF AVON HILLS SUBDIVISION TO THE SOUTHWEST CORNER OF SAID AVON HILLS SUBDIVISION ALSO BEING THE POINT OF BEGINNING; THENCE CONTINUING N. 87°58'17"W., 564.67 FEET TO A POINT ON THE EASTERLY LINE OF KING'S COVE CONDOMINIUM, OAKLAND COUNTY CONDOMINIUM SUBDIVISION PLAN No. 148; THENCE N. 21°04'00" W., 239.09 FEET ALONG SAID EASTERLY LINE OF KING'S COVE TO THE SOUTHWEST CORNER OF THE SUMMIT CONDOMINIUMS OF ROCHESTER HILLS, OAKLAND COUNTY CONDOMINIUM SUBDIVISION PLAN No. 1917; THENCE THE FOLLOWING THREE COURSES ALONG THE SOUTHERLY AND EASTERLY LINES OF SAID THE SUMMIT CONDOMINIUMS OF ROCHESTER HILLS: 1) S. 88°00'00" E., 526.31 FEET; 2) N. 02°00'00" E., 148.07 FEET AND 3) S. 88°00'00" E., 133.36 FEET TO A POINT ON THE WEST LINE OF SAID AVON HILLS SUBDIVISION; THENCE S. 02°12'23" W., 368.33 FEET ALONG SAID WEST LINE OF AVON HILLS SUBDIVISION TO THE POINT OF BEGINNING. CONTAINING 154,390 SQUARE FEET OR 3.544 ACRES. PARCEL NO. 15-03-326-019

	Syste	em Co	ompoi	nent
	Catch Basins, Inlets & Storm Sewers	Detention Pond Mechanical Forebey	Parking areas & Drives	
Maintenance Activities				Frequency
Monitoring / Inspection				
Inspect for pollutants and sediment accumulation	X	Х		Quarterly
Inspect for oil accumulation	X	X		Quarterly
Sweep Parking Areas and Drives			Х	Regularly as necessary
Preventative Maintenance				
Remove accumulated sediment and pollutants (vacuum truck)	X			When ssediment depth has accumulated to within six inches
Remove accumulated oil and gasoline (vacuum truck)	X			Under normal operating conditions at the same time as sediment
Remedial Actions				
Structural repairs	X	Х		As needed
Make adjustments / repairs to ensure proper functioning	X	Х		As needed



W.C.D.P.S. No.

SCALE	DATE	DRAWN	JOB NO.	SHEET	
N.T.S.	09-22-2015	N.N.	H845	3 of 3	




THE
RON JONA
COLLABORATIVE

ARCHITECTS DESIGNERS CONSULTANTS

29110 INKSTER, SUITE 150 SOUTHFIELD, MI 48034

P. 248.357.3600 F. 248.357.3646

WWW.RONJONA.COM

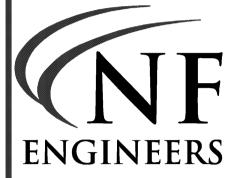

CIVIL ENGINEERS LAND SURVEYORS LAND PLANNERS

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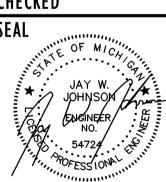
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MILESTONE DEVELOPMENT
29110 INKSTER RD
STE 150
SOUTHFIELD, MI

248.357.3600

PROJECT
THE TOWNHOMES ON MAPLEHILL
A MULTIFAMILY DEVELOPMENT

ROCHESTER HILLS, MI

City File #5-008.2, Section #3

JOB N

H845


SHEET

Storm System
Maintenance Plan

SHEET NO.

C7

1" = 30'

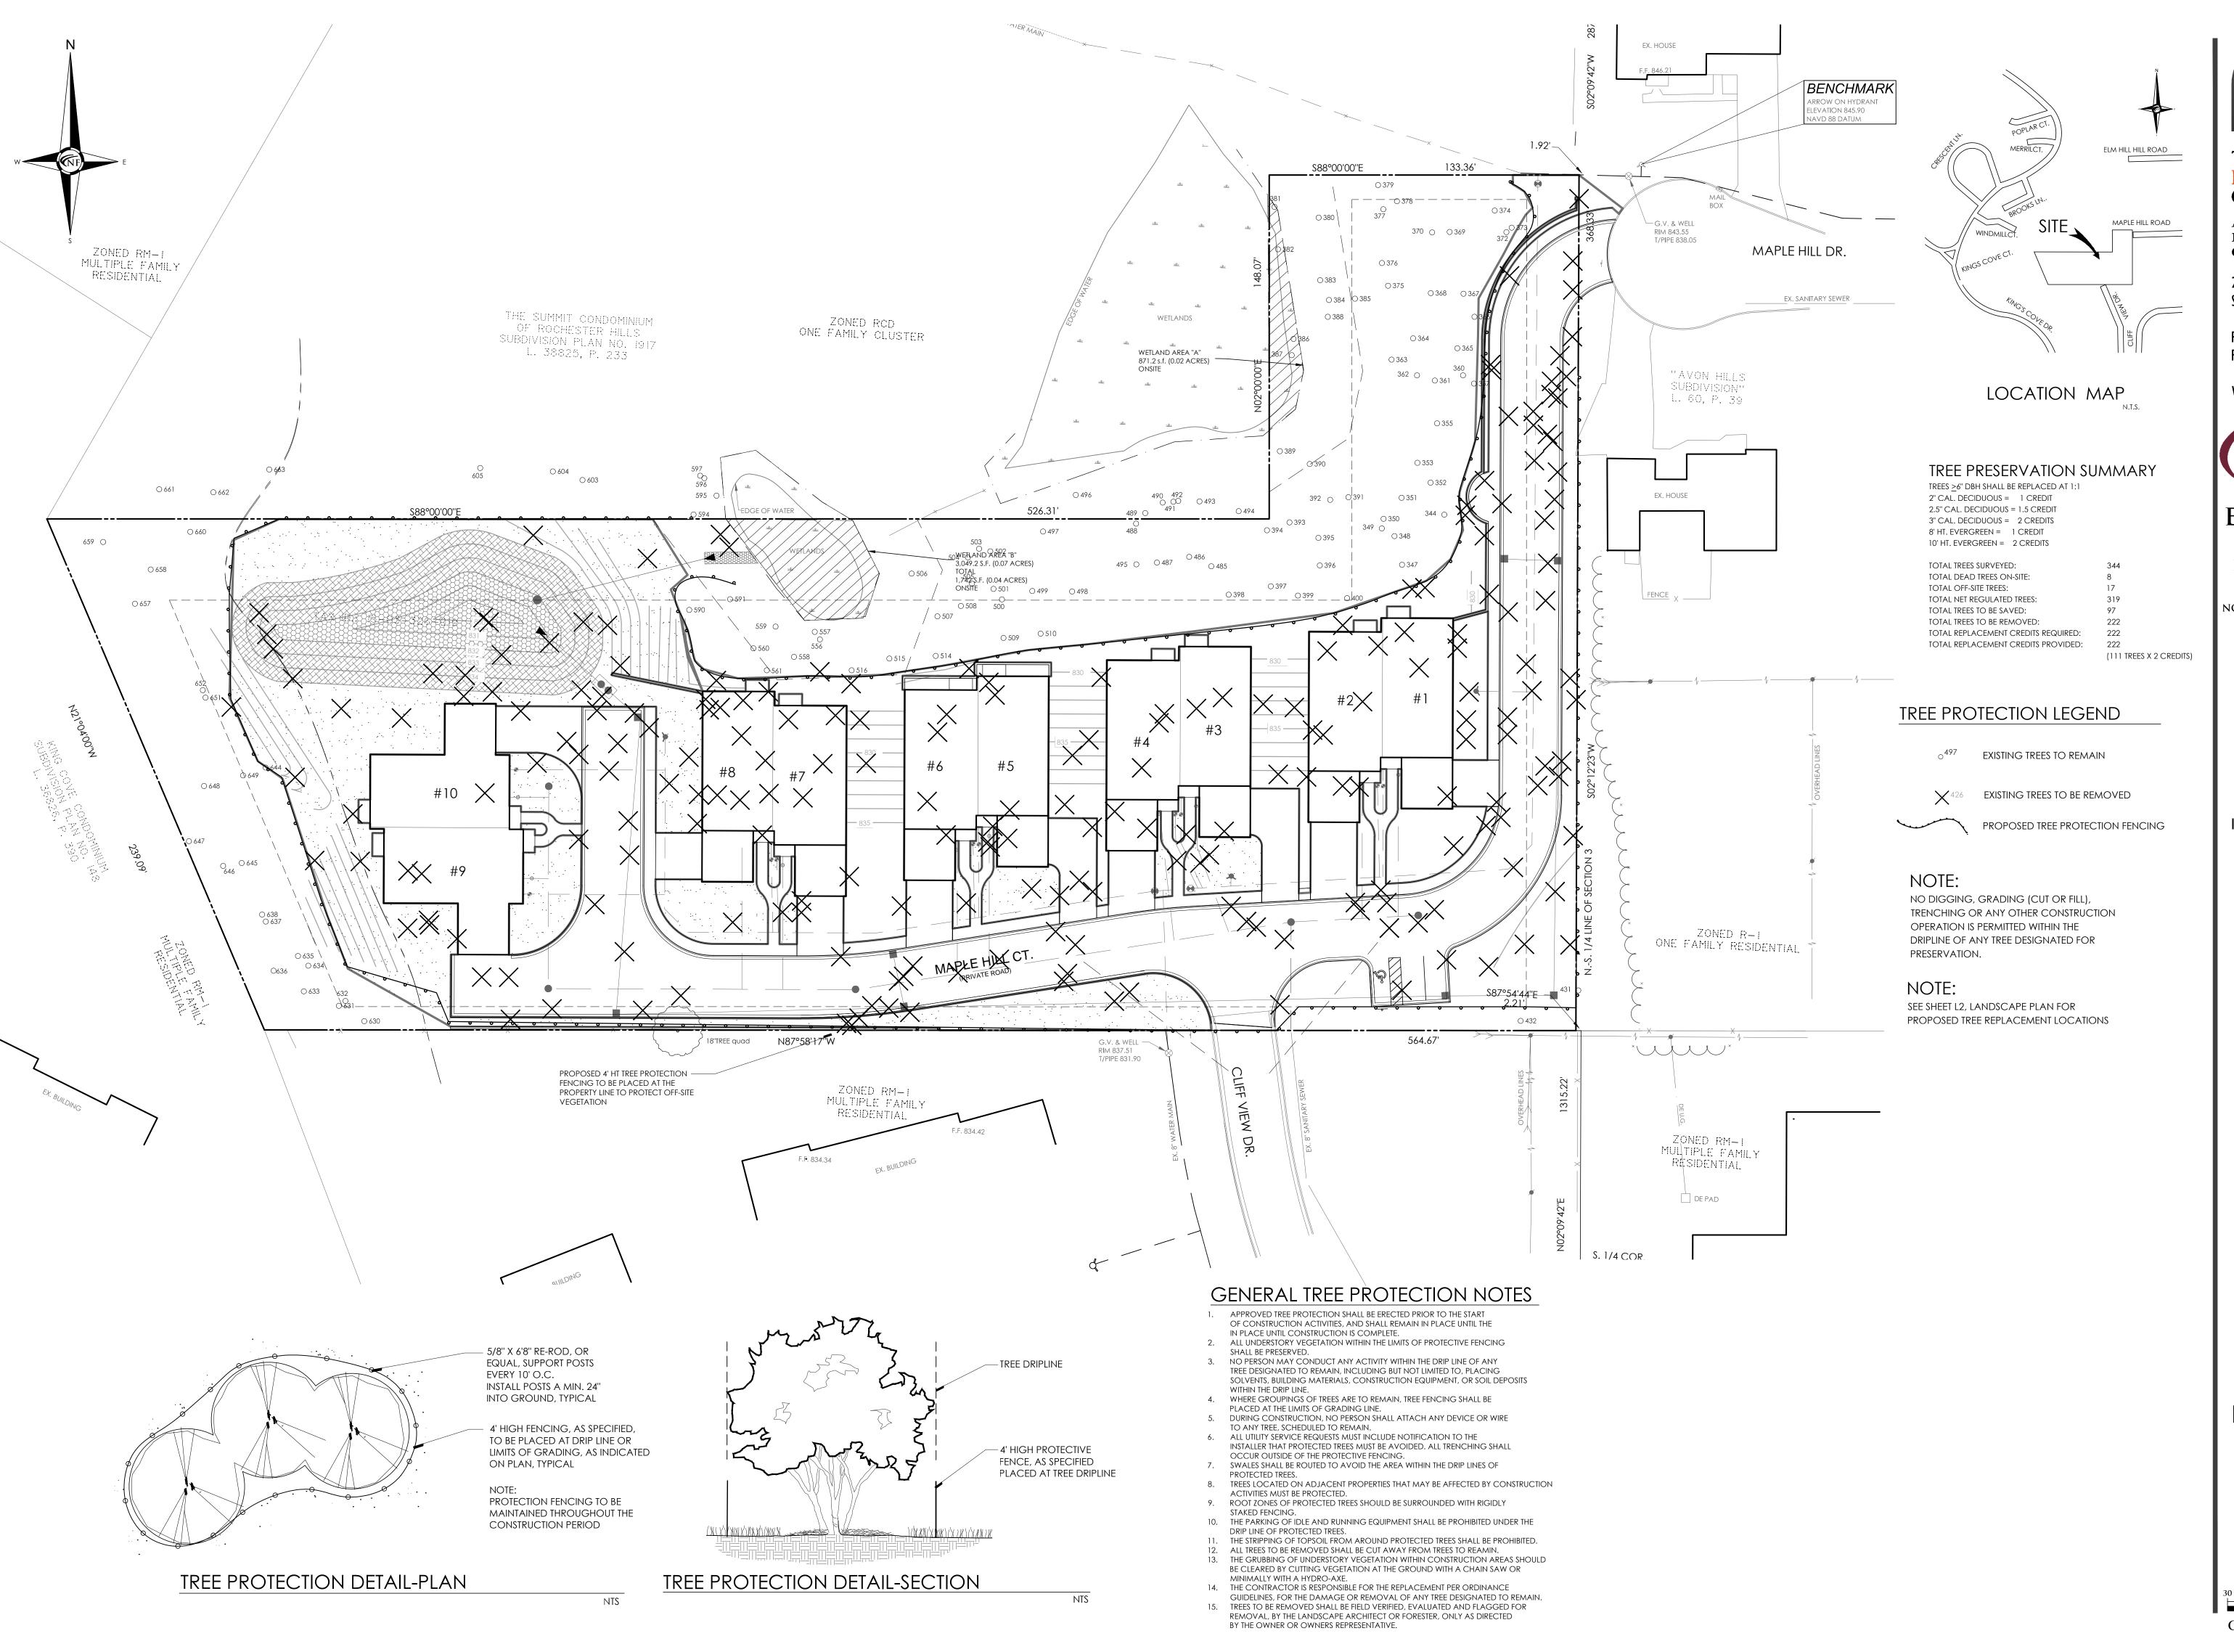



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8.27.15 SITE PLAN REV.

DRAWN G. Ostrowski
CHECKED G. Ostrowski

AL



CLIENT
MILESTONE DEVELOPMENT
29110 INKSTER RD
STE 150
SOUTHFIELD, MI
248.357.3600

PROJECT
THE TOWNHOMES ON MAPLEHILL
A MULTIFAMILY DEVELOPMENT

ROCHESTER HILLS, MI

JOB NO.


H845

SHEET

TREE PRESERVATION PLAN

SHEET NO.

1" = 30'

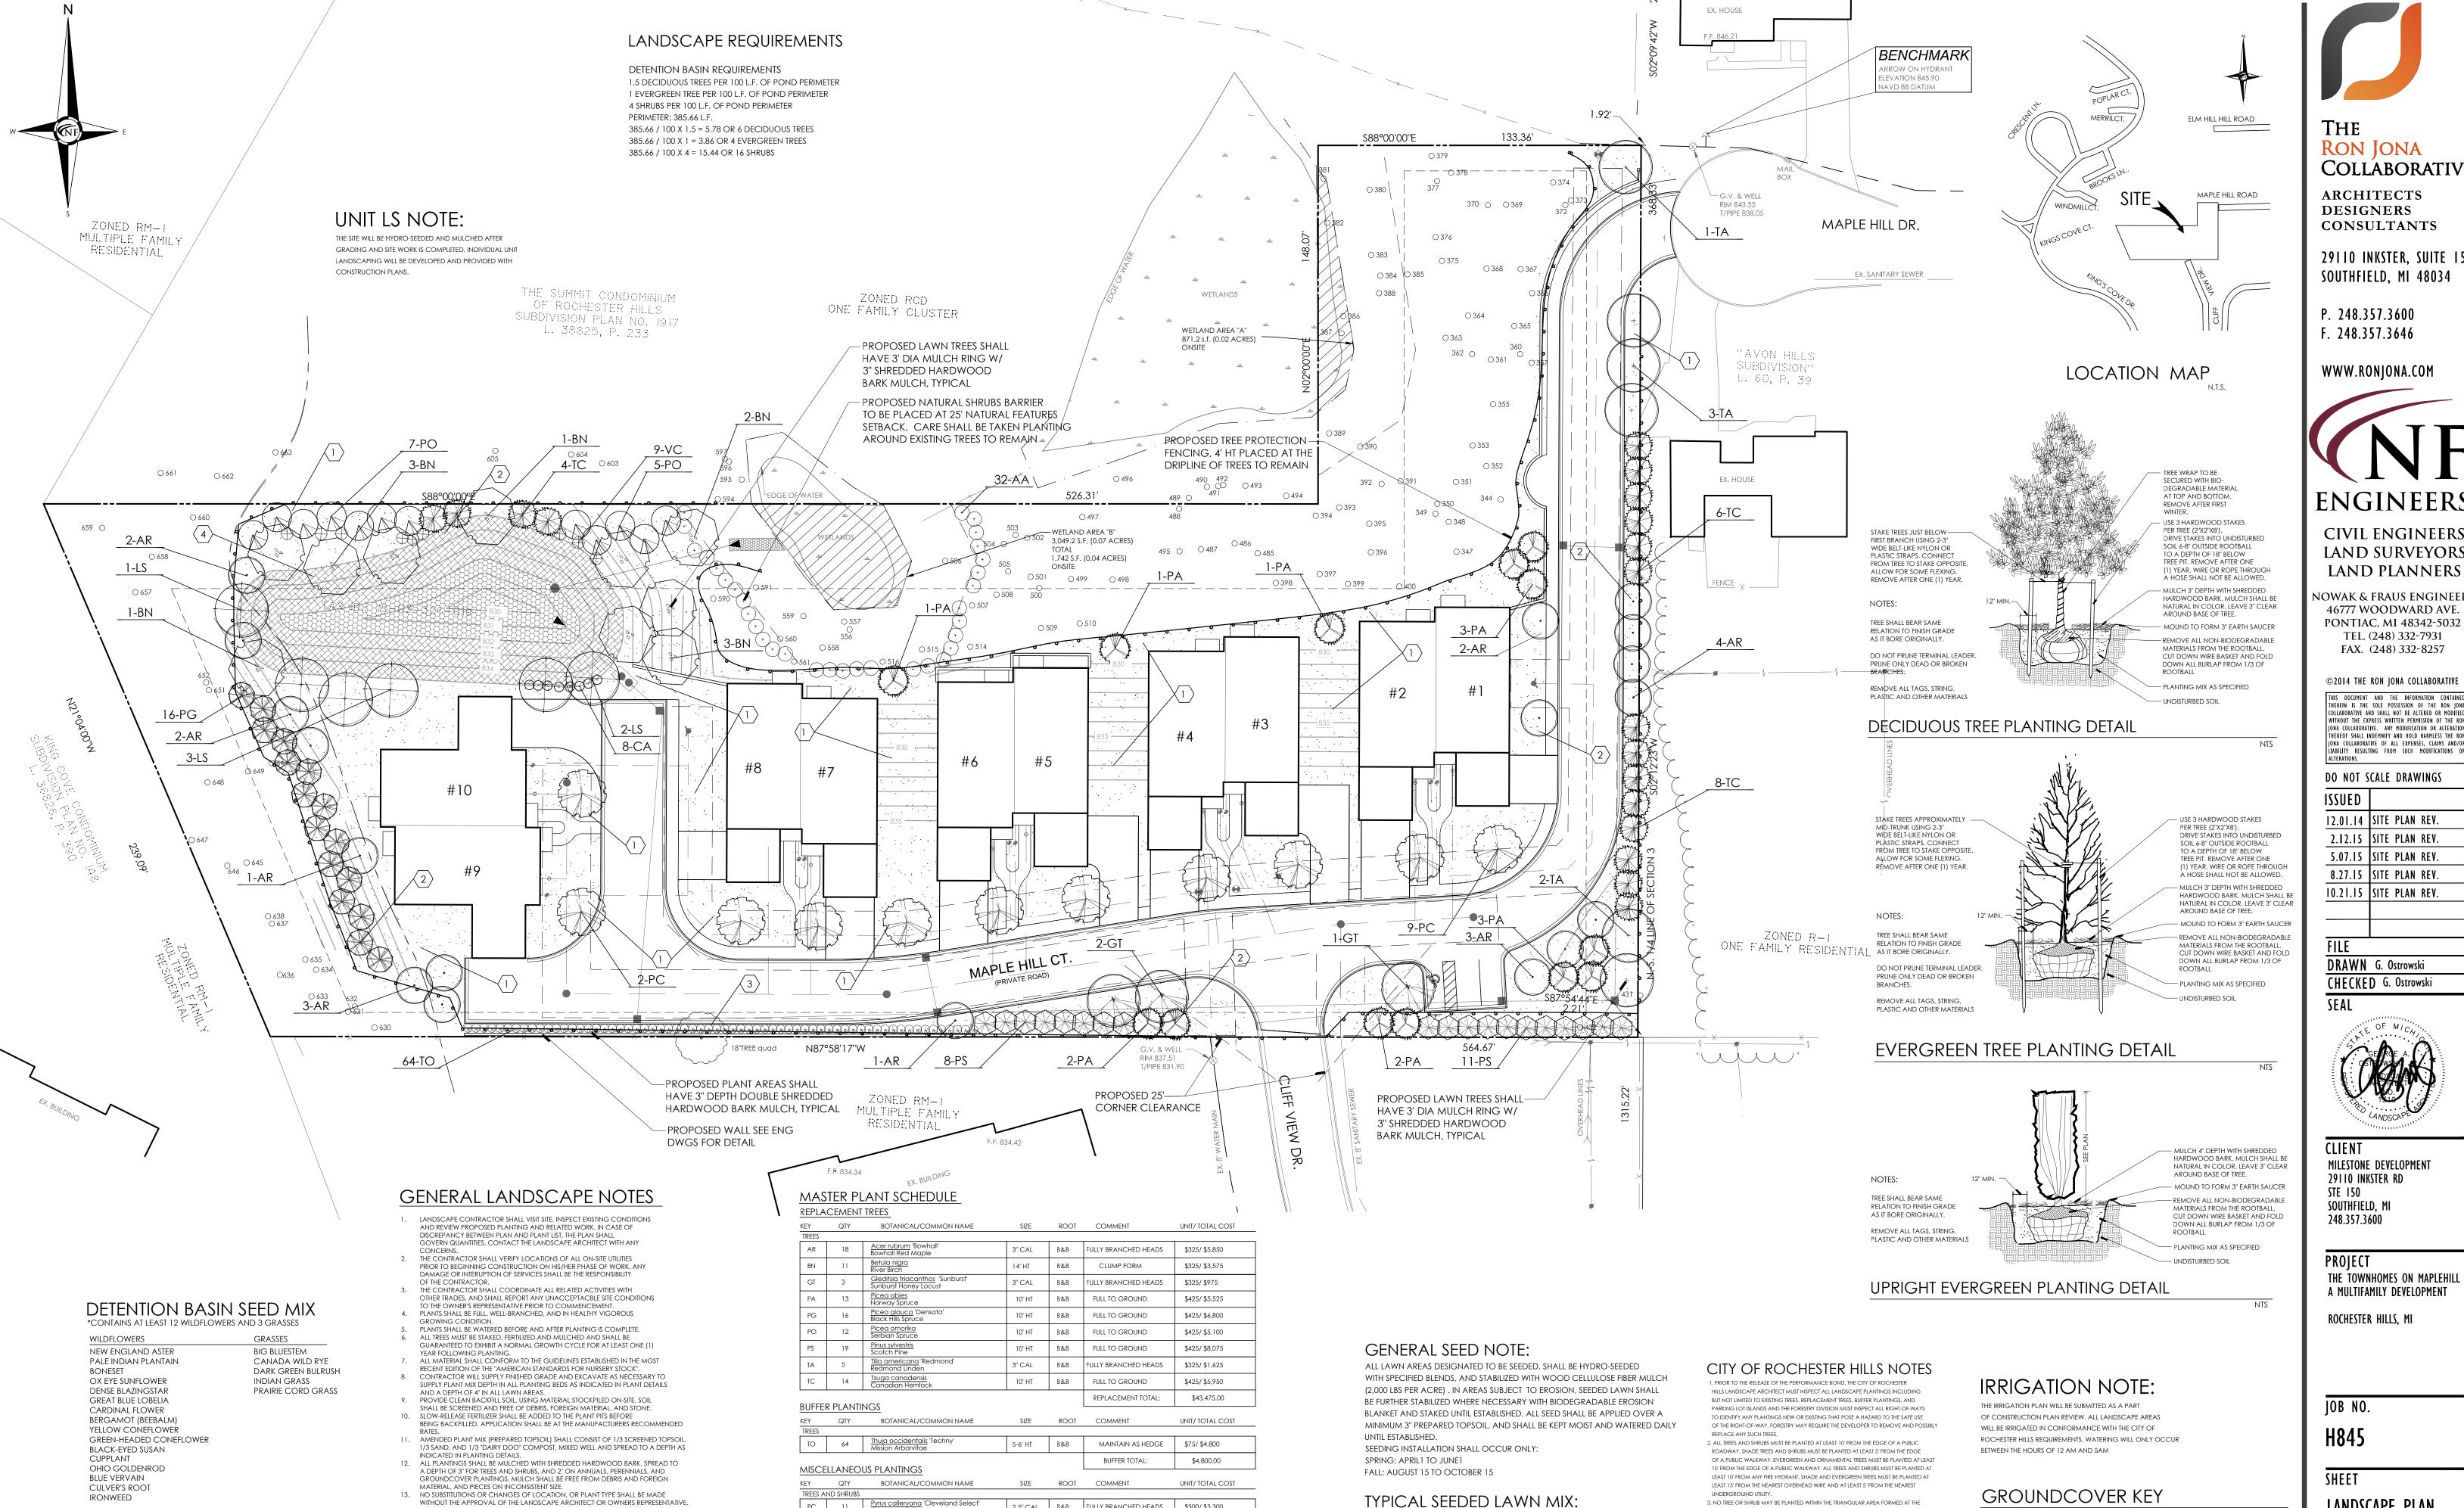

2.5" CAL B&B FULLY BRANCHED HEADS

ROOT COMMENT

2.5" CAL B&B FULLY BRANCHED HEADS

8' HT B&B

30" HT B&B

36" HT B&B

DETENTION BASIN PLANTINGS

WELL-ROOTED

MISC. TOTAL:

FULL TO GROUND

WELL-ROOTED

WELL-ROOTED

DETENTION BASIN TOTAL

THE LANDSCAPE ARCHITECT SHALL BE NOTIFIED OF ANY DISCREPANCIES BETWEEN THE PLANS AND FIELD CONDITIONS PRIOR TO INSTALLATION.

16. THE LANDSCAPE ARCHITECT OR OWNERS REPRESENTATIVE SHALL HAVE THE RIGHT

THE PLANS AND/OR SPECIFICATIONS.

GREATER CONDITION.

15. THE LANDSCAPE CONTRACTOR SHALL BE RESPONSIBLE FOR MAINTAINING ALL PLANT

MATERIAL IN A VERTICAL CONDITION THROUGHOUT THE GUARANTEED PERIOD.

17. THE LANDSCAPE CONTRACTOR SHALL SEED AND MULCH OR SOD (AS INDICATED ON

18. ALL LANDSCAPE AREAS SHALL HAVE PROPER DRAINAGE THAT PREVENTS EXCESSIVE

WATER FROM PONDING ON LAWN AREAS OR AROUND TREES AND SHRUBS. 19. ALL LANDSCAPE AREAS SHALL BE IRRIGATED WITH AN AUTOMATIC UNDERGROUND

TO REJECT ANY WORK OR MATERIAL THAT DOES NOT MEET THE REQUIREMENTS OF

PLANS) ALL AREAS DESIGNATED AS SUCH ON THE PLANS, THROUGHOUT THE CONTRAC

LIMITS. FURTHER, THE CONTRACTOR SHALL BE RESPONSIBLE FOR RESTORING AREAS

DISTURBED DURING CONSTRUCTION, NOT IN THE CONTRACT LIMITS, TO EQUAL OR

RECOMMENDED SEEDING RATE: 35 LBS/ACRE

SEED MIX AVAILABLE:

NATIVESCAPE, LLC

T 517.456.9696

PO BOX 122 MANCHESTER, MI 48158

\$300/\$3,300

\$50/ \$1,600

\$4,900.00

UNIT/ TOTAL COST

\$300/\$1,800

\$400/\$1,600

\$50/ \$400

\$50/ \$450

\$4,250.00

ALL LAWN AREAS DESIGNATED TO BE SEEDED, SHALL BE HYDROSEEDED

WITH TYPICAL DROUGHT TOLERANT, DURABLE BLENDED SEED MIX, AT

30% NITE HAWK PERENNIAL RYE

10% MERIT KENTUCKY BLUEGRASS

10% NEWPORT KENTUCKY BLUEGRASS

30% KENTUCKY BLUEGRASS

20% CREEPING RED FESCUE

A RATE OF 220 LBS PER ACRE

MIX IS COMPRISED OF

RON JONA COLLABORATIVE

ARCHITECTS DESIGNERS CONSULTANTS

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5.07.15	SITE PLAN REV.
8.27.15	SITE PLAN REV.

10.21.15 SITE PLAN REV.

DRAWN G. Ostrowski CHECKED G. Ostrowski



CLIENT MILESTONE DEVELOPMENT 29110 INKSTER RD STE 150

PROJECT THE TOWNHOMES ON MAPLEHILL A MULTIFAMILY DEVELOPMENT

ROCHESTER HILLS, MI

(1) RESTORE DISTURBED AREAS W/ HYDROSEED AND MULCH

 \langle 2 \rangle 4' DIA SPADE CUT EDGE W/ 3" SHREDDED BARK MULCH

 \langle 3 \rangle 3" DEPTH DOUBLE SHREDDED HARDWOOD BARK MULCH

4 DETENTION BASIN SEED MIX SOWN AT 35 LBS/ACRE

INTERSECTION OF ANY STREET RIGHT-OF-WAY AT A DISTANCE OF 25' FROM THEIR POINT

EACH LINE OF 15' FROM THEIR POINT OF INTERSECTION.

OF INTERSECTION. NO TREE OR SHRUB MAY BE PLANTED IN THE TRIANGULAR AREA FORMED

AT THE INTERSECTION OF ANY DRIVEWAY WITH A PUBLIC SIDEWALK AT A DISTANCE ALONG

4. PRIOR APPROVAL IS REQUIRED TO PLANT ANY TREE OR SHRUB IN THE PUBLIC RIGHT-OF-WAY.

APPROVAL OF THE DEVELOPER AND THE CITY OF ROCHESTER HILLS LANDSCAPE ARCHITECT.

6. THE DEVELOPER AND/OR THE CITY OF ROCHESTER HILLS LANDSCAPE ARCHITECT SHALL HAVE

THE RIGHT. AT ANY STAGE OF THE INSTALLATION, TO REJECT ANY WORK OR MATERIAL THAT


DOES NOT MEET THE REQUIREMENTS OF THE PLANS OR SPECIFICATIONS.

7. REPLACMENT TREES MAY NOT BE PLANTED WITHIN THE DRIP LINE OF EXISTING TREES.

8. TREES MUST BE AT LEAST 5' FROM UNDERGROUND UTILITIES AND 15' FROM OVERHEAD

LANDSCAPE PLAN

SHEET NO.

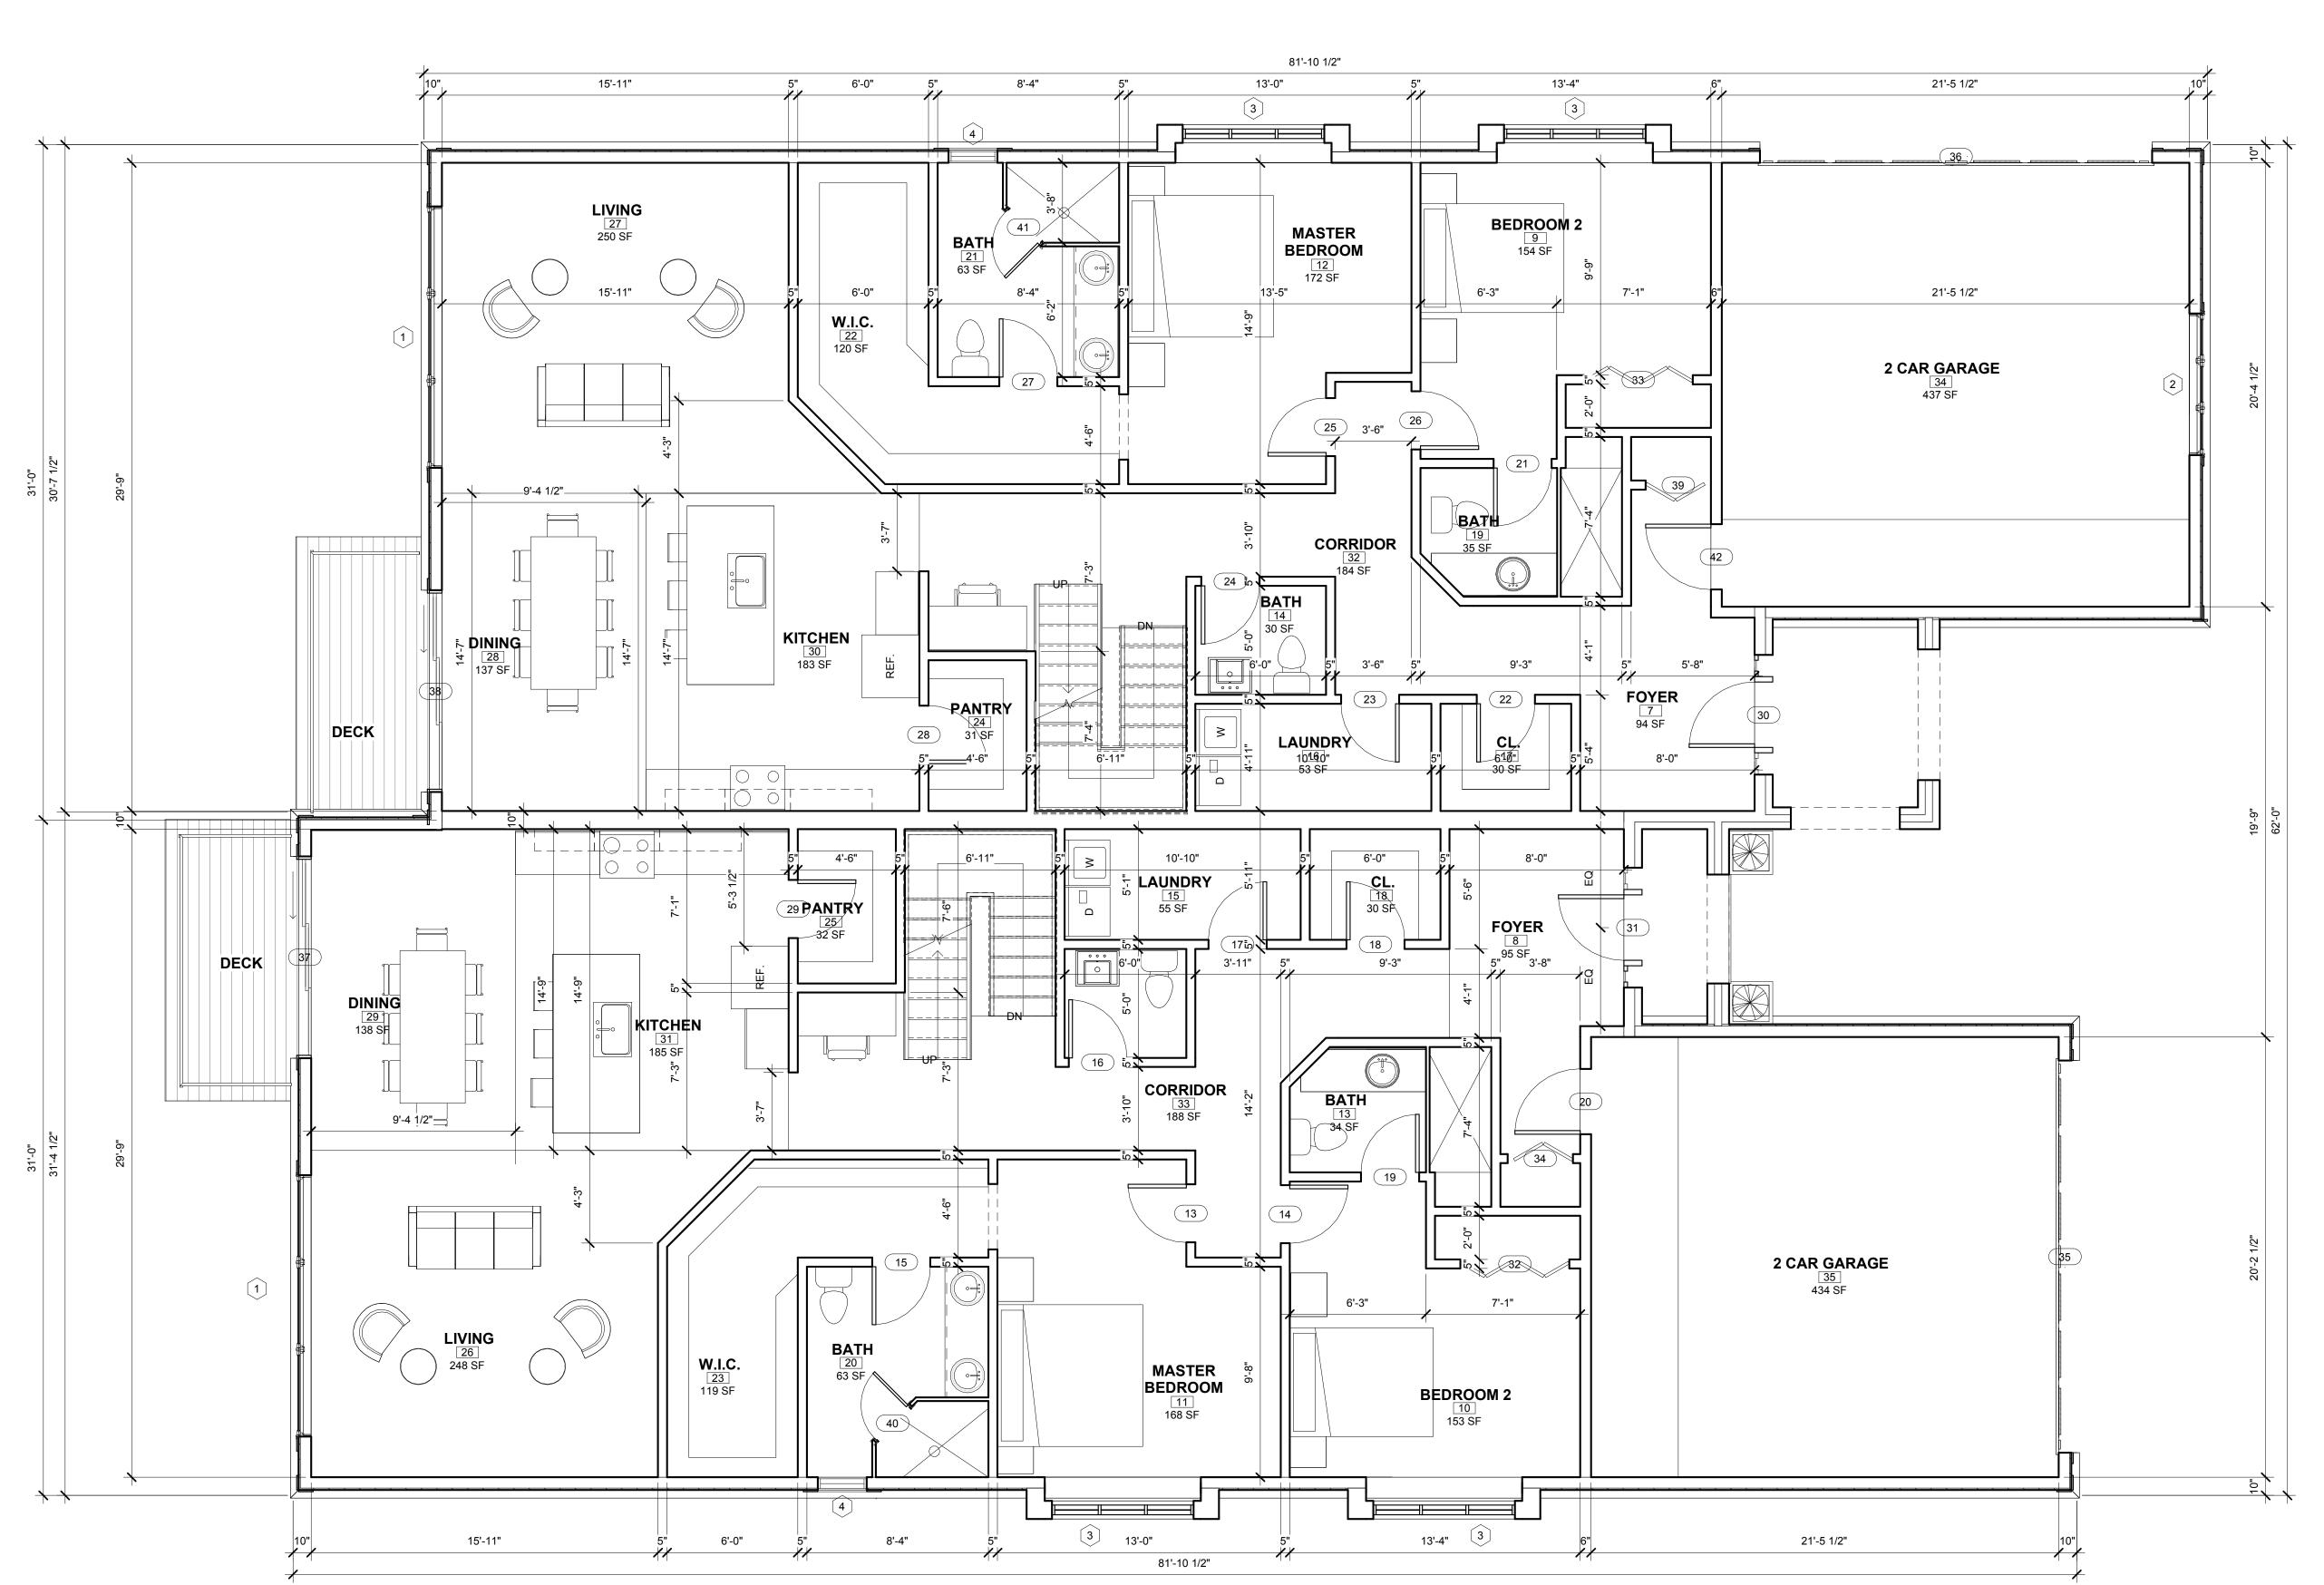

1 First Floor
1/4" = 1'-0"

1862 S.F. PER UNIT

Door			
Number	Level	Width	Description
1	Garden Level	2' - 8"	INTERIOR DOOR
2	Garden Level	2' - 8"	INTERIOR DOOR
3	Garden Level	2' - 8"	INTERIOR DOOR
4	Garden Level	2' - 8"	INTERIOR DOOR
5	Garden Level	5' - 8"	INTERIOR DOUBLE DOOR
6	Garden Level	5' - 8"	INTERIOR DOUBLE DOOR
7	Garden Level	9' - 0"	EXTERIOR TRIPLE SLIDING DOOR
8	Garden Level	9' - 0"	EXTERIOR TRIPLE SLIDING DOOR
9	Garden Level	2' - 2"	GLASS SHOWER DOOR
10	Garden Level	2' - 2"	GLASS SHOWER DOOR
11	Garden Level	2' - 8"	BI-FOLD DOOR
12	Garden Level	2' - 8"	BI-FOLD DOOR
13	First Floor	2' - 8"	INTERIOR DOOR
14	First Floor	2' - 8"	INTERIOR DOOR
15	First Floor	2' - 8"	INTERIOR DOOR
16	First Floor	2' - 8"	INTERIOR DOOR
17	First Floor	2' - 8"	INTERIOR DOOR
18	First Floor	2' - 8"	INTERIOR DOOR
19	First Floor	2' - 8"	INTERIOR DOOR
20	First Floor	3' - 0"	20 MIN. FIRE RATED
21	First Floor	2' - 8"	INTERIOR DOOR
22	First Floor	2' - 8"	INTERIOR DOOR
23	First Floor	2' - 8"	INTERIOR DOOR
24	First Floor	2' - 8"	INTERIOR DOOR
25	First Floor	2' - 8"	INTERIOR DOOR
26	First Floor	2' - 8"	INTERIOR DOOR
27	First Floor	2' - 8"	INTERIOR DOOR
28	First Floor	2' - 8"	INTERIOR DOOR
29	First Floor	2' - 8"	INTERIOR DOOR
30	First Floor	3' - 0"	ENTRANCE
31	First Floor	3' - 0"	ENTRANCE
32	First Floor	5' - 0"	BI-FOLD
33	First Floor	5' - 0"	BI-FOLD
34	First Floor	3' - 0"	BI-FOLD
35	First Floor	18' - 0"	16' X 8' GARAGE DOOR
36	First Floor	18' - 0"	16' X 8' GARAGE DOOR
37	First Floor	9' - 0"	EXTERIOR TRIPLE SLIDING DOOR
38	First Floor	9' - 0"	EXTERIOR TRIPLE SLIDING DOOR
39	First Floor	3' - 0"	BI-FOLD
40	First Floor	2' - 2"	GLASS SHOWER DOOR
41	First Floor	2' - 2"	GLASS SHOWER DOOR

	WINDOW SCHEDULE							
Type Mark	Level	Count	Description	Width	Heigh			
1	Garden Level	1	TRIPLE SLIDING WINDOW	12' - 0"	6' - 0"			
1	Garden Level	1	TRIPLE SLIDING WINDOW	12' - 0"	6' - 0"			
2	First Floor	1	GARAGE FIXED WINDOW	6' - 6"	5' - 0"			
1	First Floor	1	TRIPLE SLIDING WINDOW	12' - 0"	6' - 0"			
1	First Floor	1	TRIPLE SLIDING WINDOW	12' - 0"	6' - 0"			
3	First Floor	1	FIXED - CASEMENT- FIXED (EGRESS)	6' - 0"	4' - 6"			
3	First Floor	1	FIXED - CASEMENT- FIXED (EGRESS)	6' - 0"	4' - 6"			
3	First Floor	1	FIXED - CASEMENT- FIXED (EGRESS)	6' - 0"	4' - 6"			
3	First Floor	1	FIXED - CASEMENT- FIXED (EGRESS)	6' - 0"	4' - 6"			
4	First Floor	1	CASEMENT	2' - 0"	3' - 6"			
4	First Floor	1	CASEMENT	2' - 0"	3' - 6"			
5	Roof Level	1	ARCH OVER CASEMENT	3' - 0"	4' - 5"			
5	Roof Level	1	ARCH OVER CASEMENT	3' - 0"	4' - 5"			

Room			Finish	
Number	Level	Room Name	Floor	Area
	Ta	0	T	
1	Garden Level	SITTING		742 SF
2	Garden Level	SITTING		747 SF
3	Garden Level	BEDROOM		165 SF
4	Garden Level	BEDROOM		164 SF
5	Garden Level	BATH		77 SF
6	Garden Level	BATH		77 SF
7	First Floor	FOYER		94 SF
8	First Floor	FOYER		95 SF
9	First Floor	BEDROOM 2		154 SF
10	First Floor	BEDROOM 2		153 SF
11	First Floor	MASTER BEDROOM		168 SF
12	First Floor	MASTER BEDROOM		172 SF
13	First Floor	BATH		34 SF
14	First Floor	BATH		30 SF
15	First Floor	LAUNDRY		55 SF
16	First Floor	LAUNDRY		53 SF
17	First Floor	CL.		30 SF
18	First Floor	CL.		30 SF
19	First Floor	BATH		35 SF
20	First Floor	BATH		63 SF
21	First Floor	BATH		63 SF
22	First Floor	W.I.C.		120 SF
23	First Floor	W.I.C.		119 SF
24	First Floor	PANTRY		31 SF
25	First Floor	PANTRY		32 SF
26	First Floor	LIVING		248 SF
27	First Floor	LIVING		250 SF
28	First Floor	DINING		137 SF
29	First Floor	DINING		138 SF
30	First Floor	KITCHEN		183 SF
31	First Floor	KITCHEN		185 SF
32	First Floor	CORRIDOR		184 SF
33	First Floor	CORRIDOR		188 SF
34	First Floor	2 CAR GARAGE		437 SF
35	First Floor	2 CAR GARAGE		434 SF
36	Roof Level	ATTIC		551 SF
37	Roof Level	ATTIC		610 SF



The Ron Jona Collaborative

ARCHITECTS
DESIGNERS
CONSULTANTS

1066 COMMERCE ST BIRMINGHAM, MI

P. 248.357.3600 F. 248.357.3646

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06/25/15

6/22/2015

Addendum

FILE

DRAWN Author

CHECKED Checker

CLIENT

MILE STONE DEVELOPMENT


PROJECT

THE TOWNHOMES ON MAPLEHILL

JOB NO.

1ST FLOOR PLAN

SHEET NO.

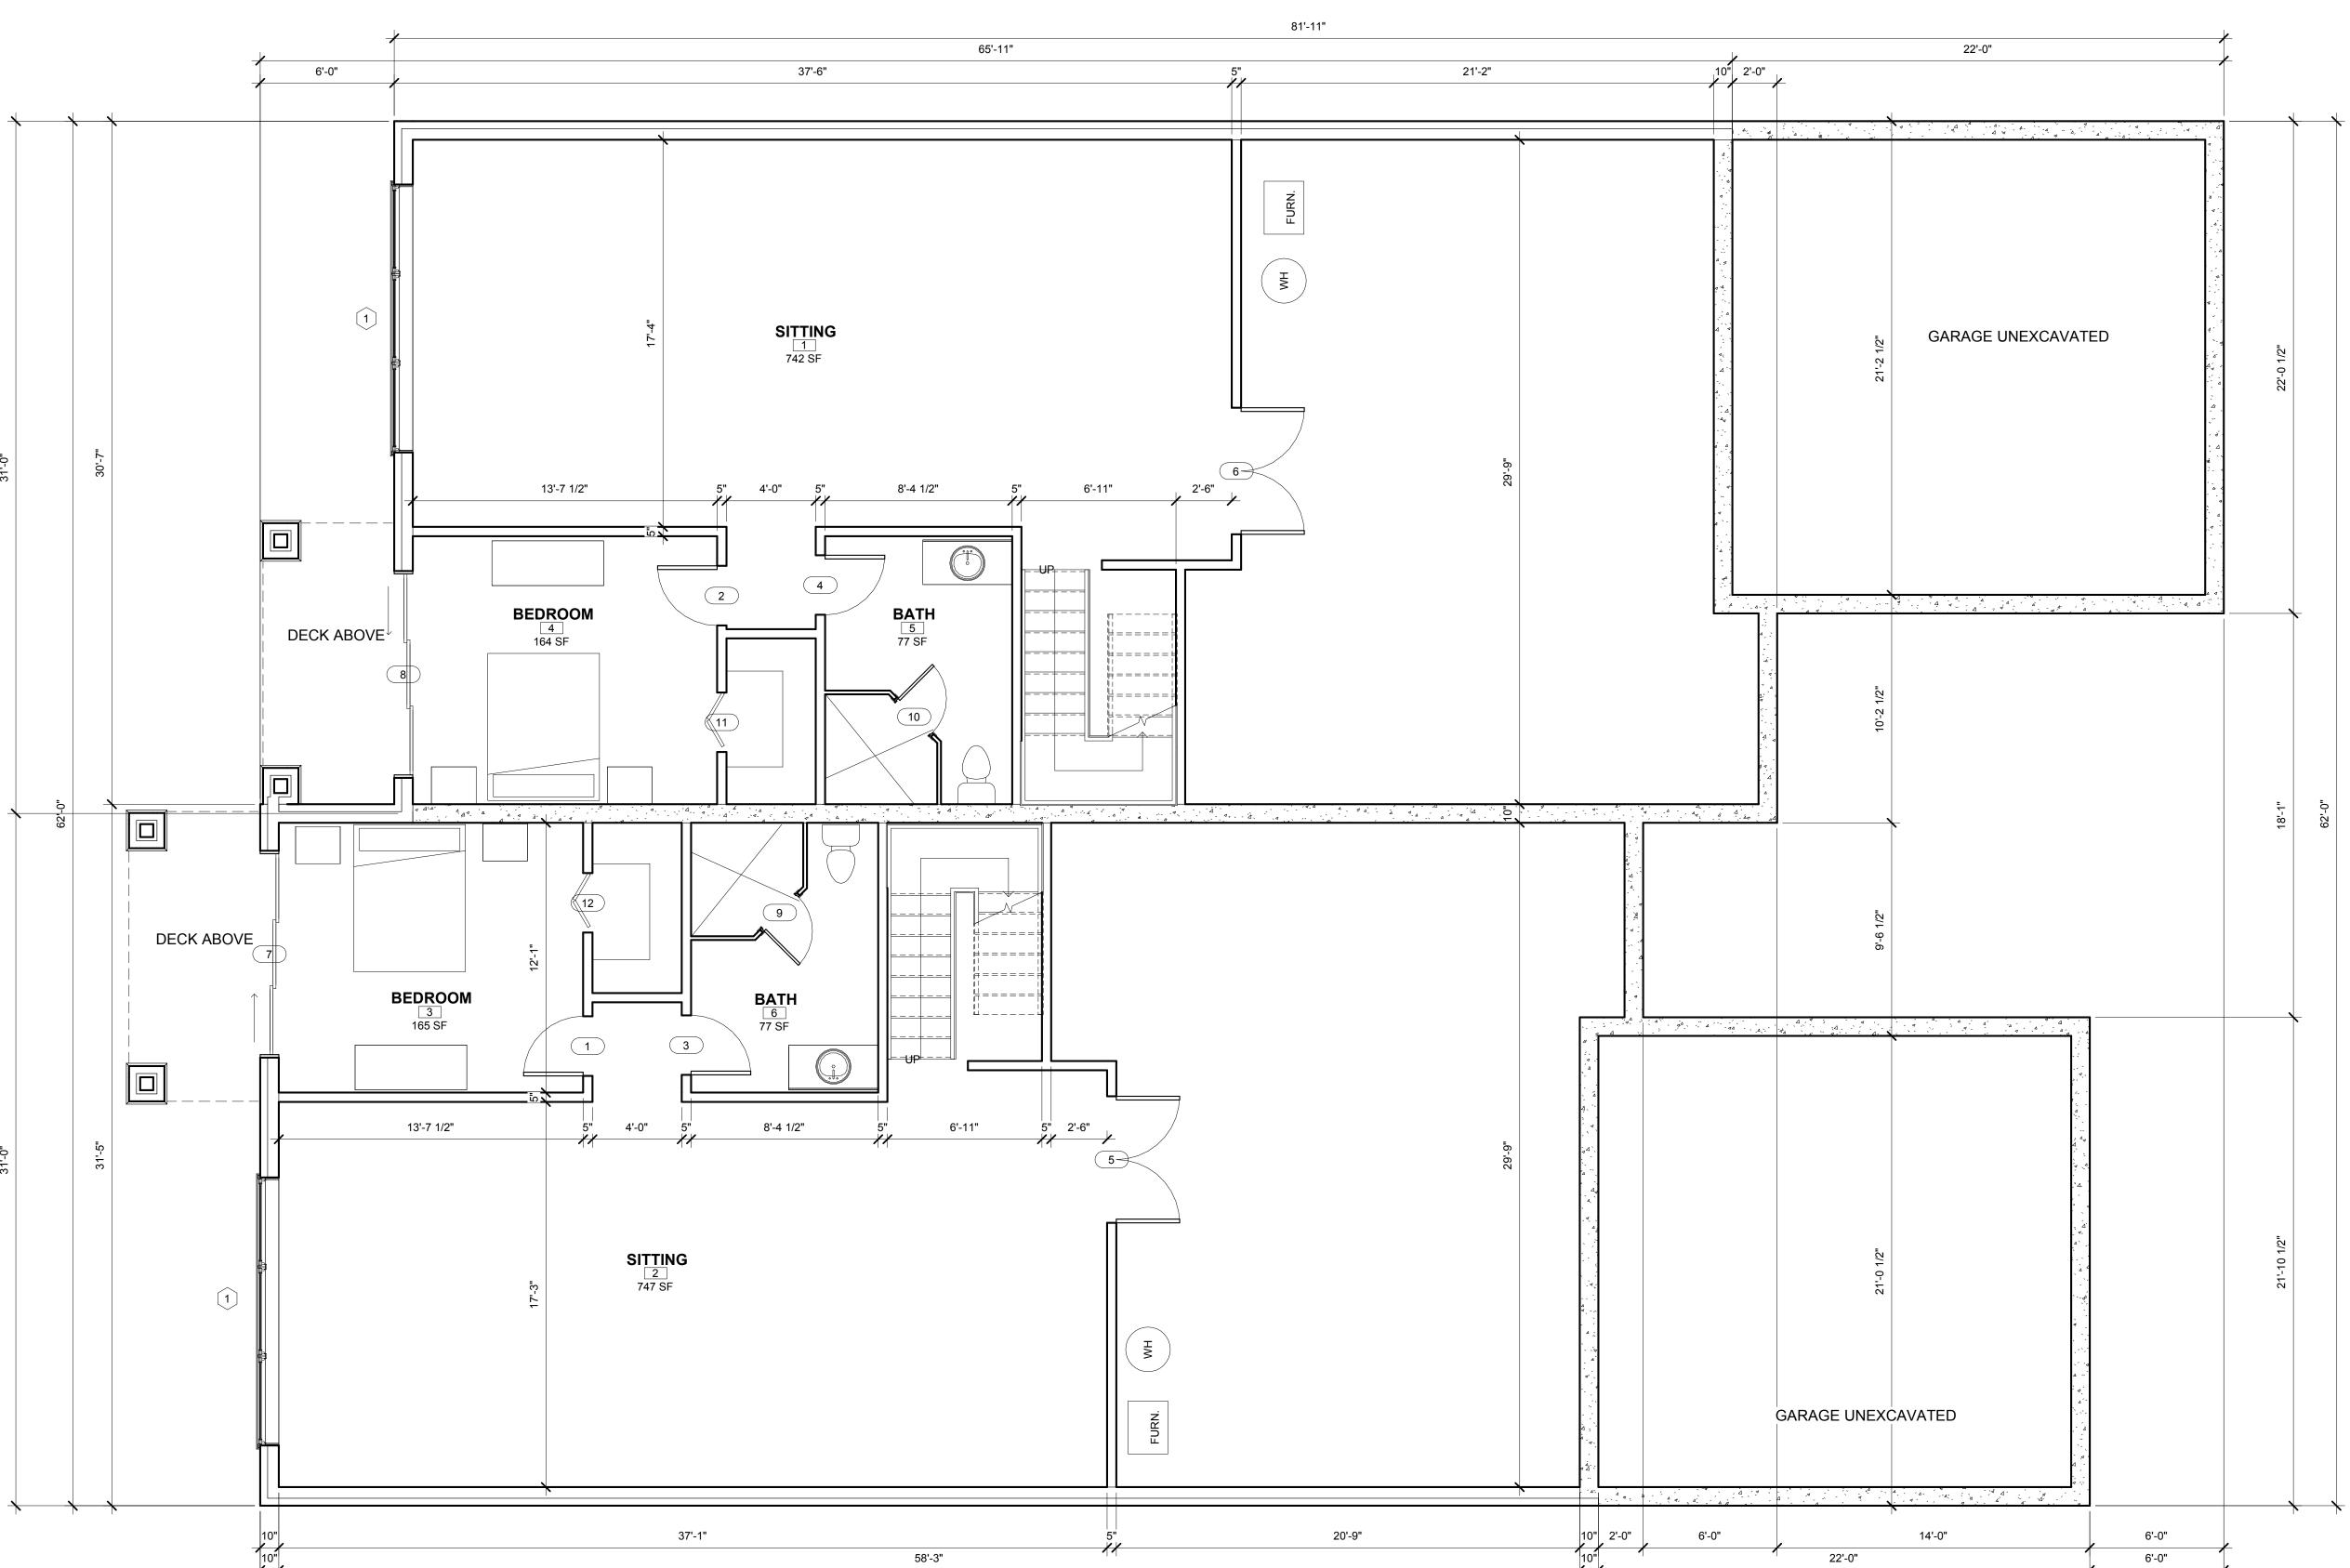

87'-11"

1879 S.F. PER UNIT

Garden Level

Door Number	Level	Width	Description		
1	Garden Level	2' - 8"	INTERIOR DOOR		
<u>. </u>	Garden Level	2' - 8"	INTERIOR DOOR		
- 3	Garden Level	2' - 8"	INTERIOR DOOR		
<u> </u>	Garden Level	2' - 8"	INTERIOR DOOR		
<u>.</u> 5	Garden Level	5' - 8"	INTERIOR DOUBLE DOOR		
3	Garden Level	5' - 8"	INTERIOR DOUBLE DOOR		
7	Garden Level	9' - 0"	EXTERIOR TRIPLE SLIDING DOOR		
3	Garden Level	9' - 0"	EXTERIOR TRIPLE SLIDING DOOR		
9	Garden Level	2' - 2"	GLASS SHOWER DOOR		
10	Garden Level	2' - 2"	GLASS SHOWER DOOR		
11	Garden Level	2' - 8"	BI-FOLD DOOR		
12	Garden Level	2' - 8"	BI-FOLD DOOR		
13	First Floor	2' - 8"	INTERIOR DOOR		
14	First Floor	2' - 8"	INTERIOR DOOR		
15	First Floor	2' - 8"	INTERIOR DOOR		
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20	First Floor	3' - 0"	20 MIN. FIRE RATED		
21	First Floor	2' - 8"	INTERIOR DOOR		
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38	First Floor	9' - 0"	EXTERIOR TRIPLE SLIDING DOOR		
39	First Floor	3' - 0"	BI-FOLD		
40	First Floor	2' - 2"	GLASS SHOWER DOOR		
41 42	First Floor First Floor	2' - 2" 3' - 0"	GLASS SHOWER DOOR 20 MIN. FIRE RATED		

			WINDOW SCHEDULE		
Type Mark	Level	Count	Description	Width	Heigh
1	Garden Level	1	TRIPLE SLIDING WINDOW	12' - 0"	6' - 0"
1	Garden Level	1	TRIPLE SLIDING WINDOW	12' - 0"	6' - 0"
2	First Floor	1	GARAGE FIXED WINDOW	6' - 6"	5' - 0"
1	First Floor	1	TRIPLE SLIDING WINDOW	12' - 0"	6' - 0"
1	First Floor	1	TRIPLE SLIDING WINDOW	12' - 0"	6' - 0"
3	First Floor	1	FIXED - CASEMENT- FIXED (EGRESS)	6' - 0"	4' - 6"
3	First Floor	1	FIXED - CASEMENT- FIXED (EGRESS)	6' - 0"	4' - 6"
3	First Floor	1	FIXED - CASEMENT- FIXED (EGRESS)	6' - 0"	4' - 6"
3	First Floor	1	FIXED - CASEMENT- FIXED (EGRESS)	6' - 0"	4' - 6"
4	First Floor	1	CASEMENT	2' - 0"	3' - 6"
4	First Floor	1	CASEMENT	2' - 0"	3' - 6"
5	Roof Level	1	ARCH OVER CASEMENT	3' - 0"	4' - 5"
5	Roof Level	1	ARCH OVER CASEMENT	3' - 0"	4' - 5"

Room			Finish	
Number	Level	Room Name	Floor	Area
1	Garden Level	SITTING		742 SF
2	Garden Level	SITTING		747 SF
3	Garden Level	BEDROOM		165 SF
4	Garden Level	BEDROOM		164 SF
5	Garden Level	BATH		77 SF
6	Garden Level	BATH		77 SF
7	First Floor	FOYER		94 SF
8	First Floor	FOYER		95 SF
9	First Floor	BEDROOM 2		154 SF
10	First Floor	BEDROOM 2		153 SF
11	First Floor	MASTER BEDROOM		168 SF
12	First Floor	MASTER BEDROOM		172 SF
13	First Floor	BATH		34 SF
14	First Floor	BATH		30 SF
15	First Floor	LAUNDRY		55 SF
16	First Floor	LAUNDRY		53 SF
17	First Floor	CL.		30 SF
18	First Floor	CL.		30 SF
19	First Floor	BATH		35 SF
20	First Floor	BATH		63 SF
21	First Floor	BATH		63 SF
22	First Floor	W.I.C.		120 SF
23	First Floor	W.I.C.		119 SF
24	First Floor	PANTRY		31 SF
25	First Floor	PANTRY		32 SF
26	First Floor	LIVING		248 SF
27	First Floor	LIVING		250 SF
28	First Floor	DINING		137 SF
29	First Floor	DINING		138 SF
30	First Floor	KITCHEN		183 SF
31	First Floor	KITCHEN		185 SF
32	First Floor	CORRIDOR		184 SF
33	First Floor	CORRIDOR		188 SF
34	First Floor	2 CAR GARAGE		437 SF
35	First Floor	2 CAR GARAGE		434 SF
36	Roof Level	ATTIC		551 SF
37	Roof Level	ATTIC		610 SF



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DESIGNERS
CONSULTANTS

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MILE STONE DEVELOPMENT


PROJECT

THE TOWNHOMES ON MAPLEHILL

JOB NO.

SHEET
LOWER LEVEL

SHEET NO.

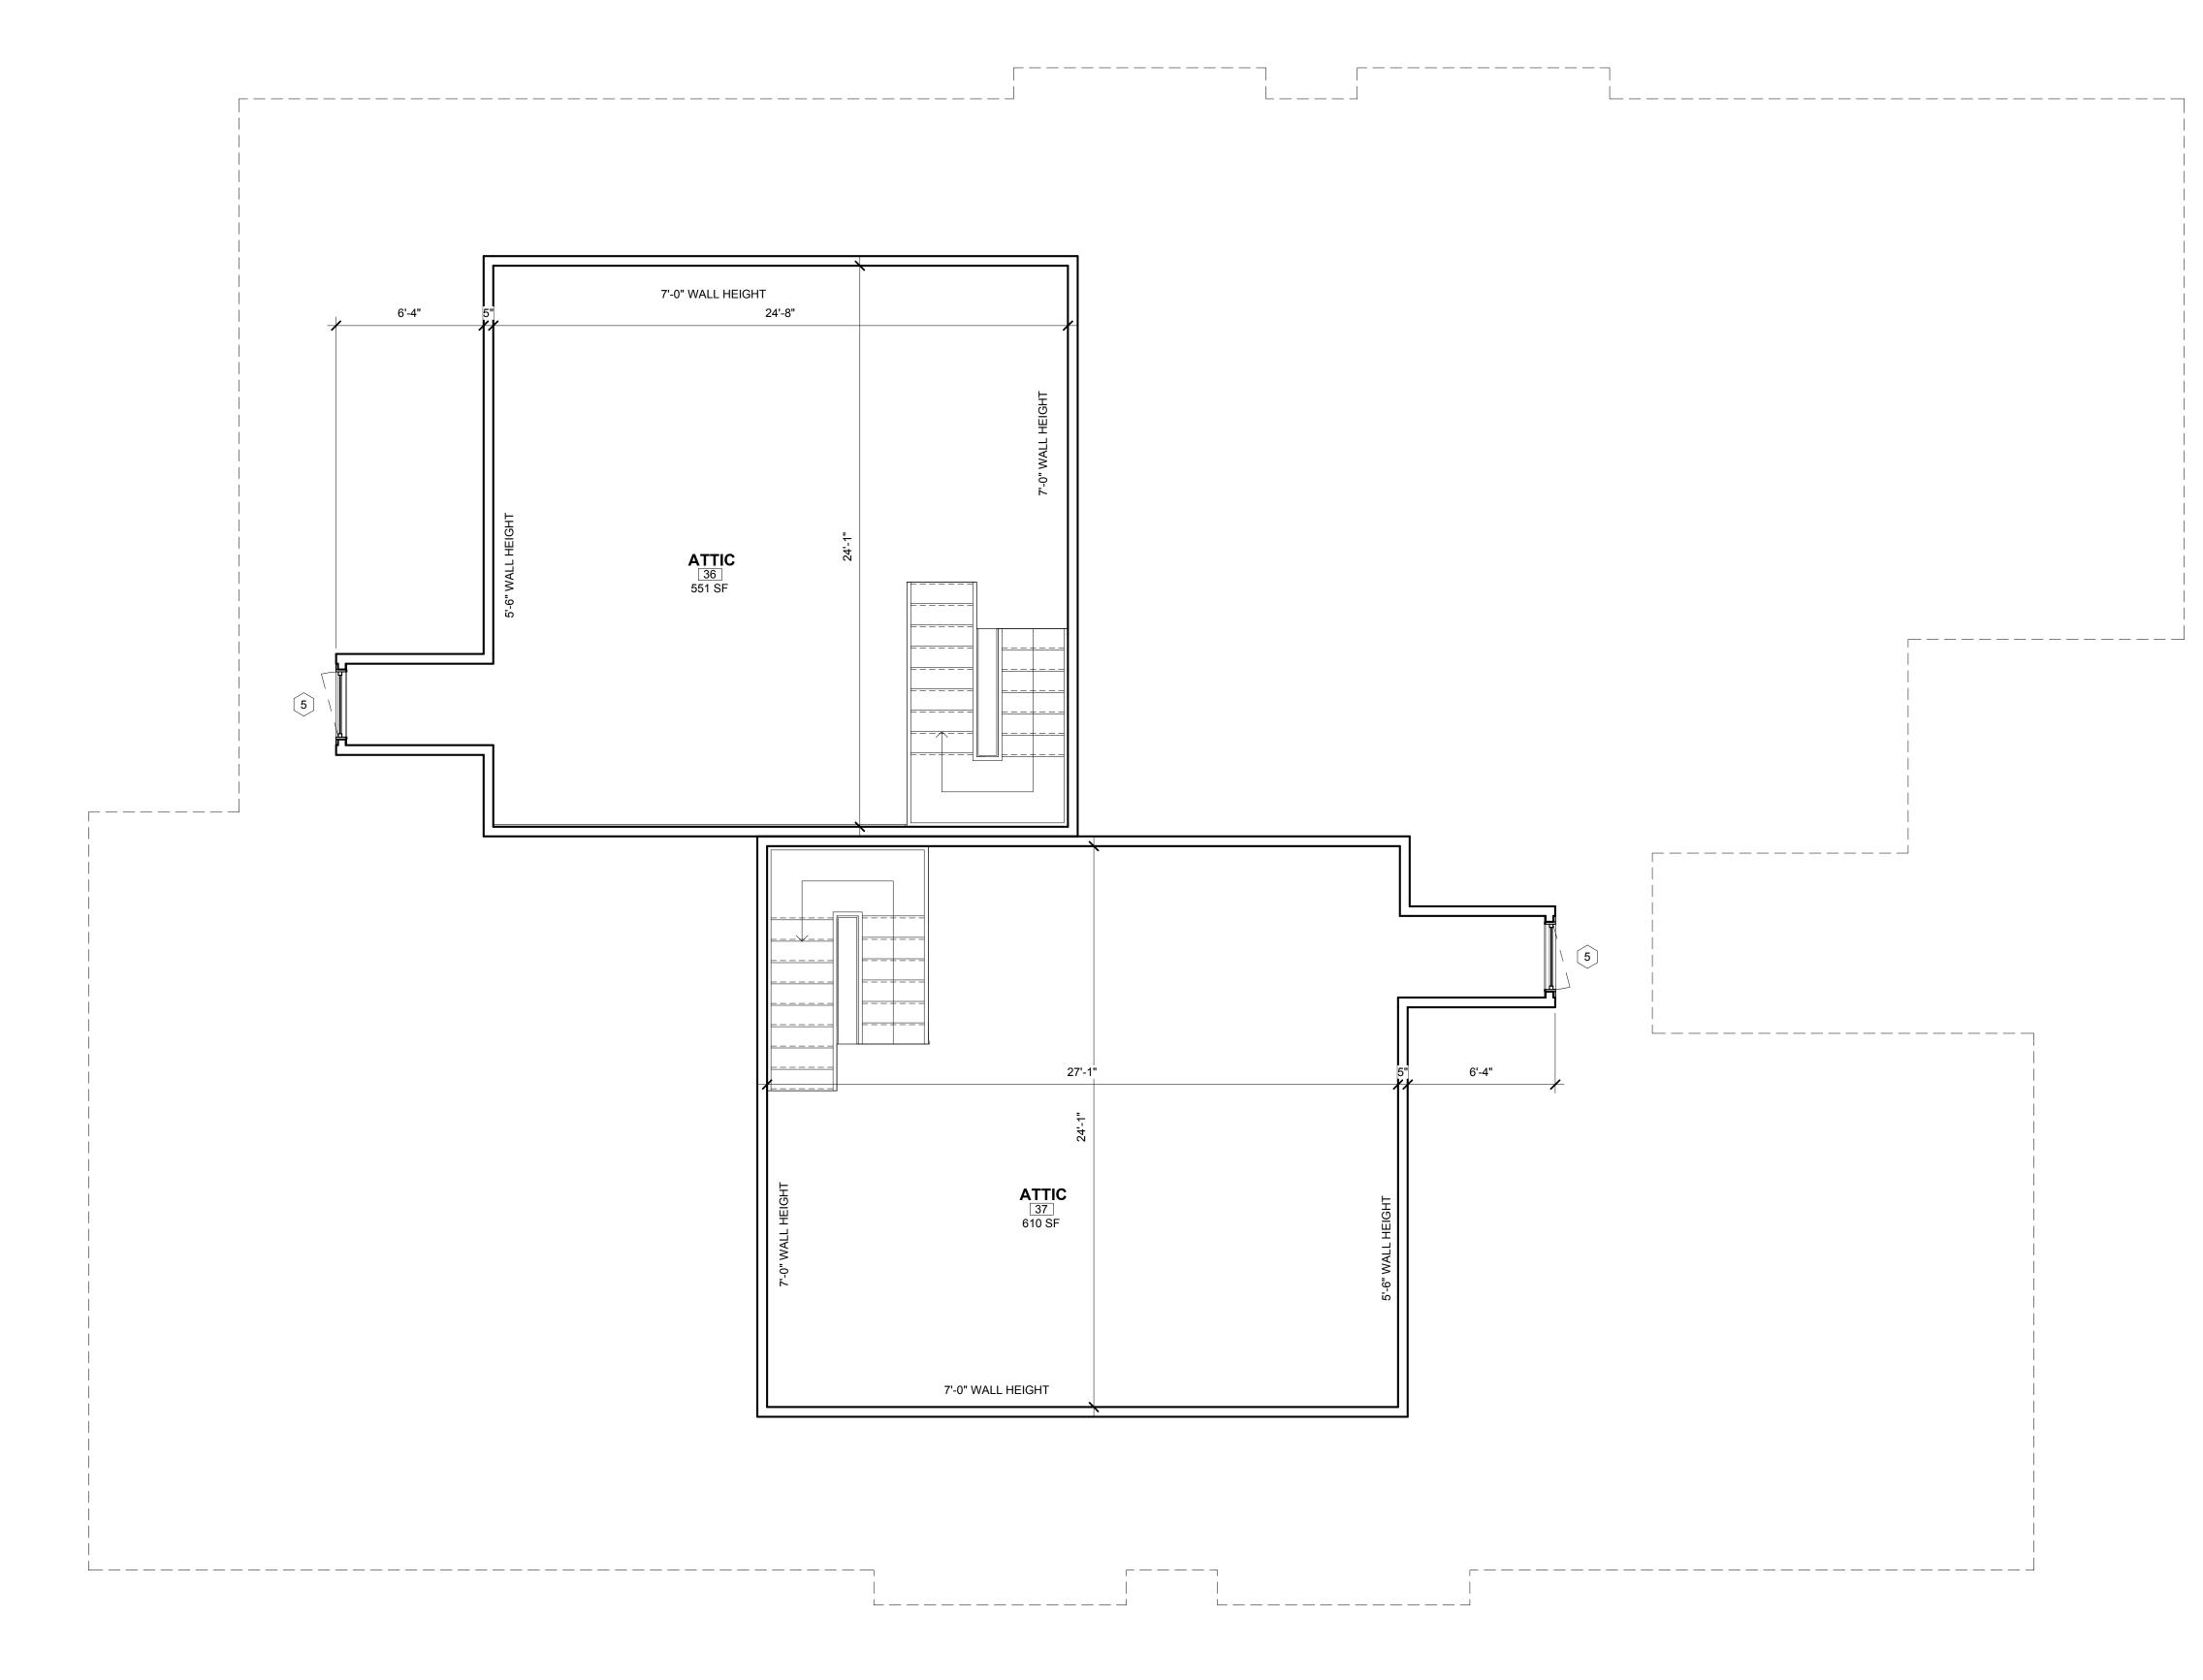

			WINDOW SCHEDULE		
Type Mark	Level	Count	Description	Width	Height
1	Garden Level	1	TRIPLE SLIDING WINDOW	12' - 0"	6' - 0"
1	Garden Level	1	TRIPLE SLIDING WINDOW	12' - 0"	6' - 0"
2	First Floor	1	GARAGE FIXED WINDOW	6' - 6"	5' - 0"
1	First Floor	1	TRIPLE SLIDING WINDOW	12' - 0"	6' - 0"
1	First Floor	1	TRIPLE SLIDING WINDOW	12' - 0"	6' - 0"
3	First Floor	1	FIXED - CASEMENT- FIXED (EGRESS)	6' - 0"	4' - 6"
3	First Floor	1	FIXED - CASEMENT- FIXED (EGRESS)	6' - 0"	4' - 6"
3	First Floor	1	FIXED - CASEMENT- FIXED (EGRESS)	6' - 0"	4' - 6"
3	First Floor	1	FIXED - CASEMENT- FIXED (EGRESS)	6' - 0"	4' - 6"
4	First Floor	1	CASEMENT	2' - 0"	3' - 6"
4	First Floor	1	CASEMENT	2' - 0"	3' - 6"
5	Roof Level	1	ARCH OVER CASEMENT	3' - 0"	4' - 5"
5	Roof Level	1	ARCH OVER CASEMENT	3' - 0"	4' - 5"

592 S.F. PER UNIT

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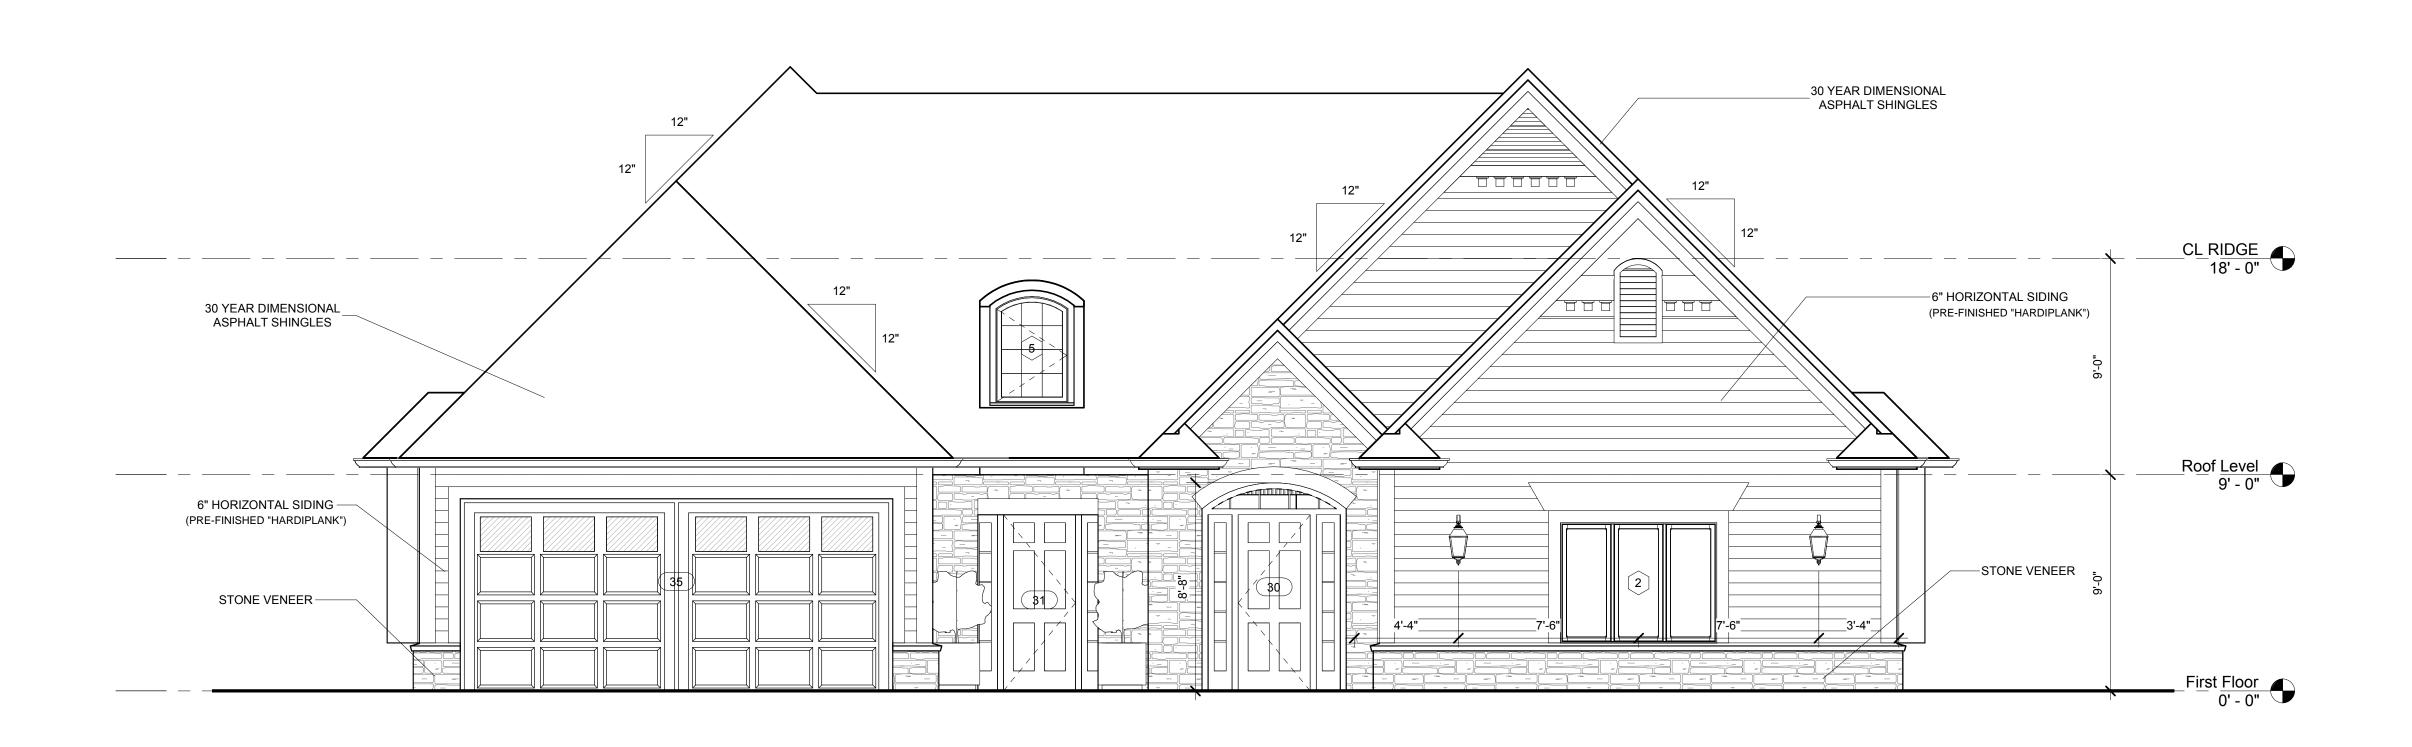
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MILE STONE DEVELOPMENT

PROJECT

THE TOWNHOMES ON MAPLEHILL

ROOF / ATTIC PLAN



1) FRONT ELEVATION 1/4" = 1'-0"



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MILE STONE DEVELOPMENT


PROJECT


THE TOWNHOMES ON MAPLEHILL

JOB NO.

SHEET ELEVATIONS



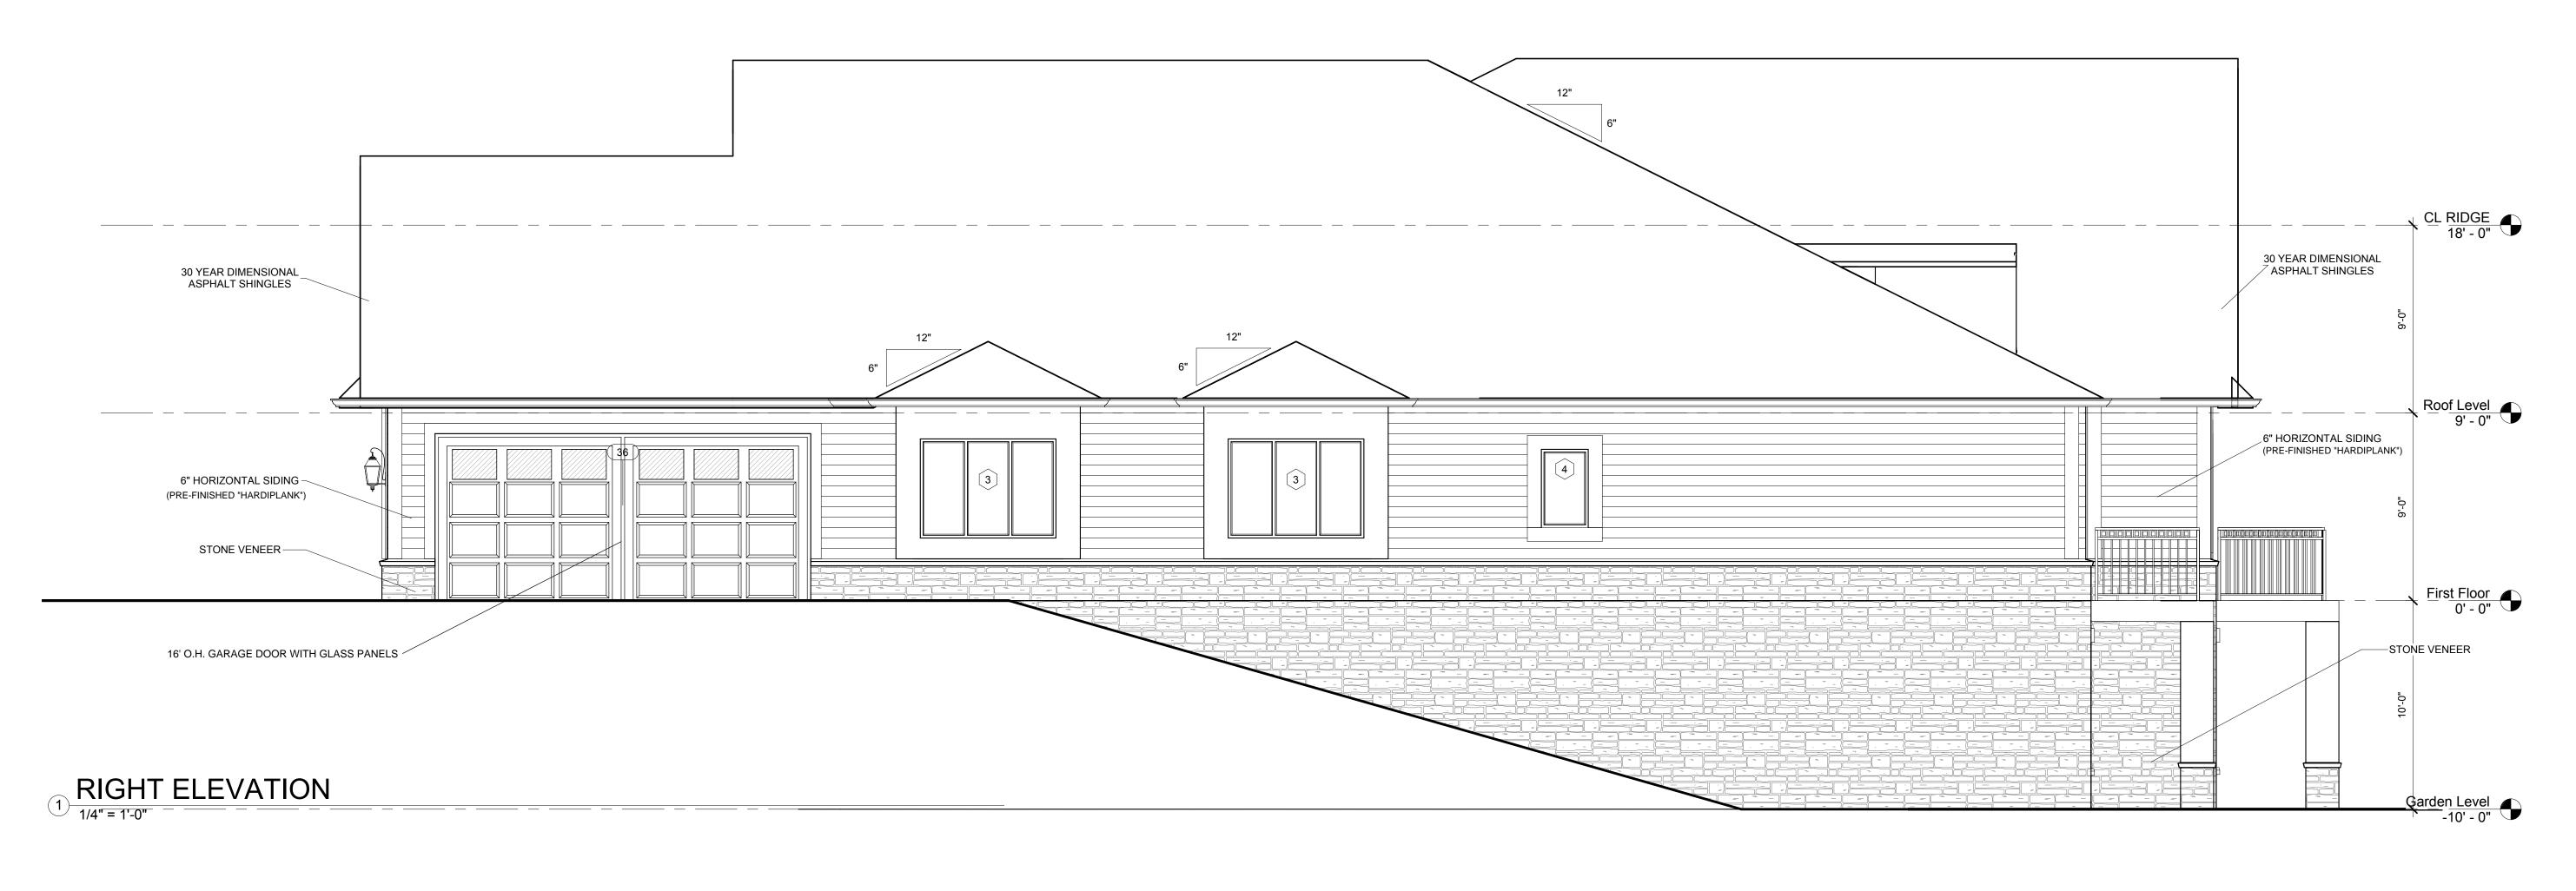

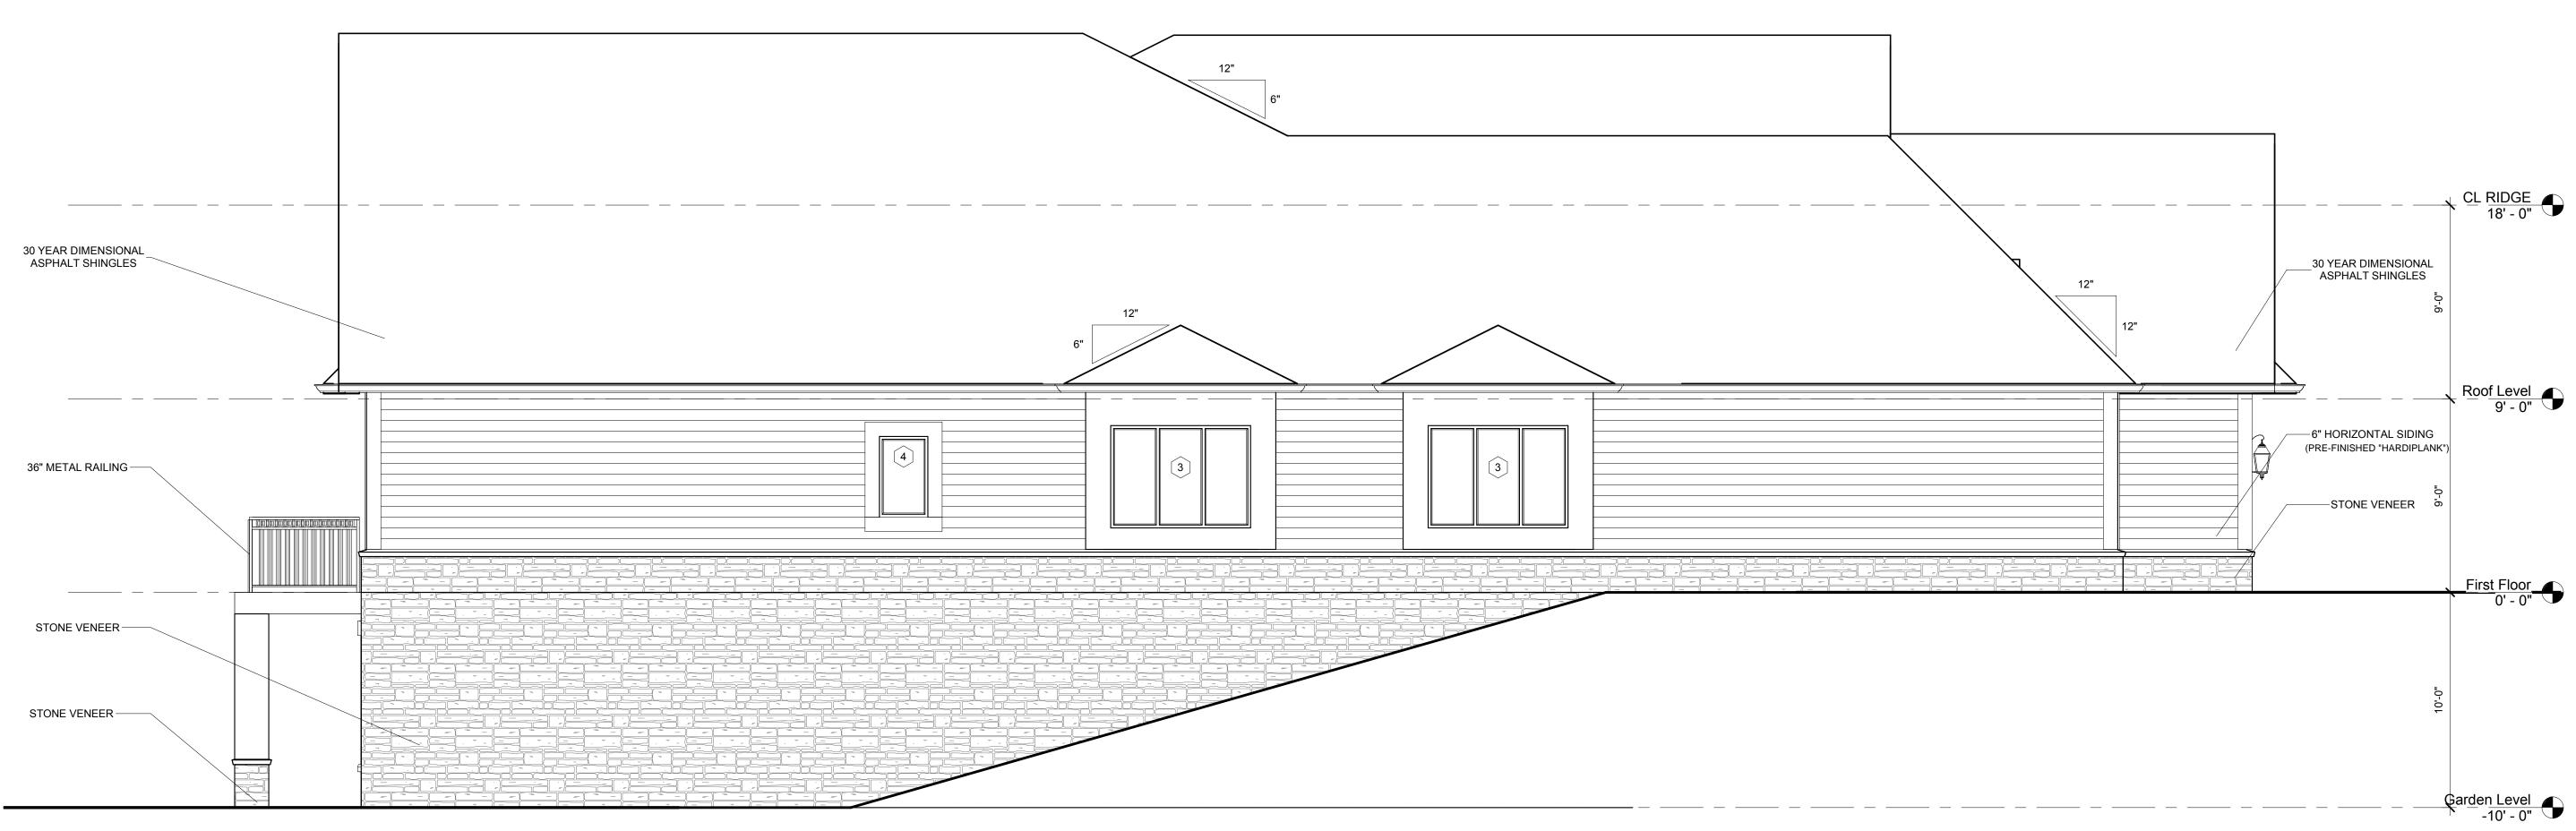

2 LEFT ELEVATION
1/4" = 1'-0"

THE

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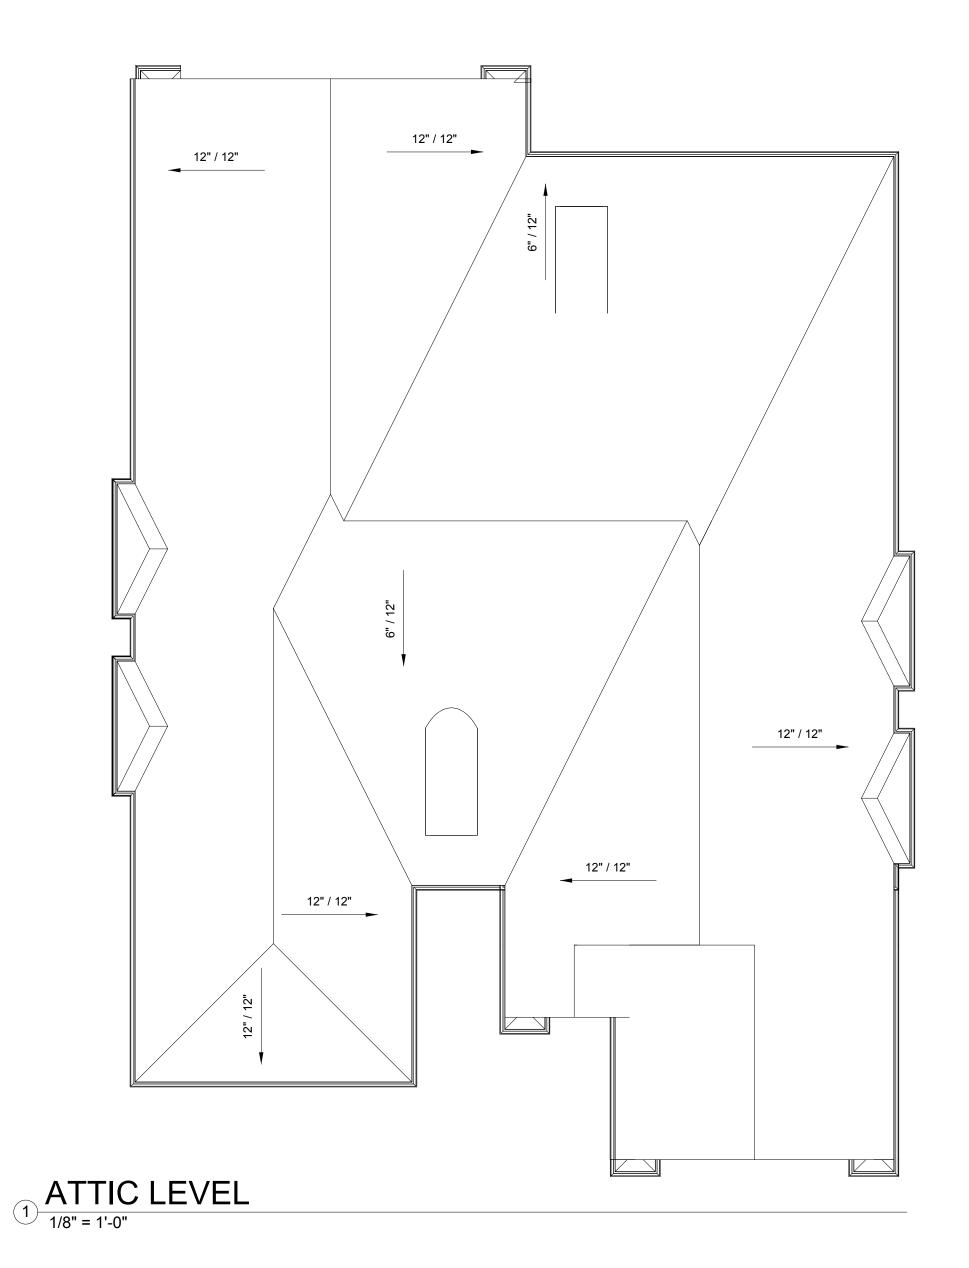
THE TOWNHOMES ON MAPLEHILL


SHEET

ELEVATIONS


SHEET NO.

JOB NO.



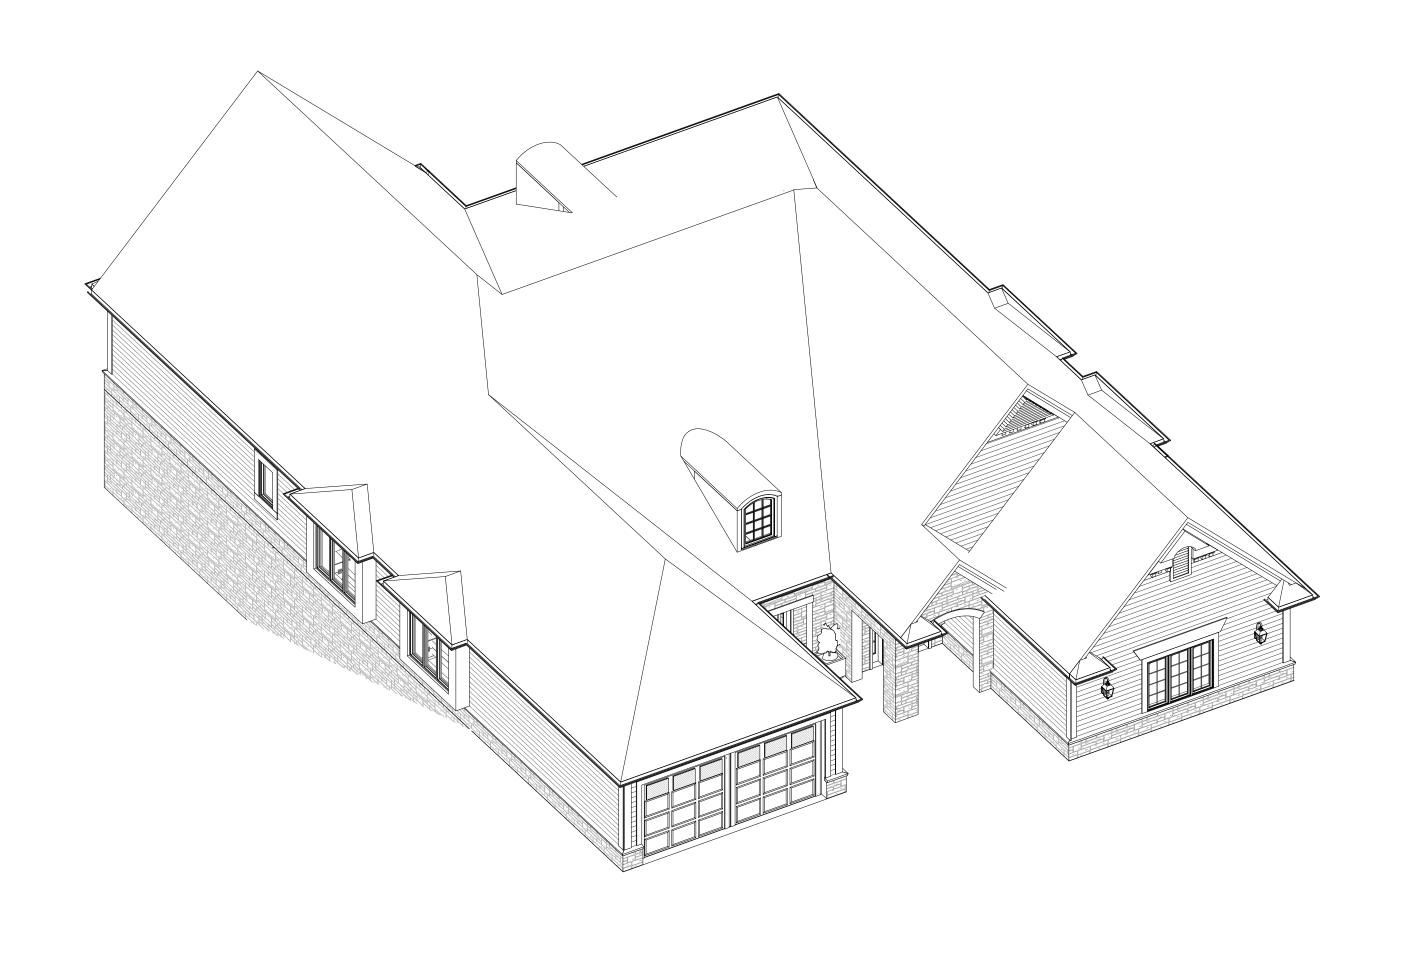

2 VIEW 1

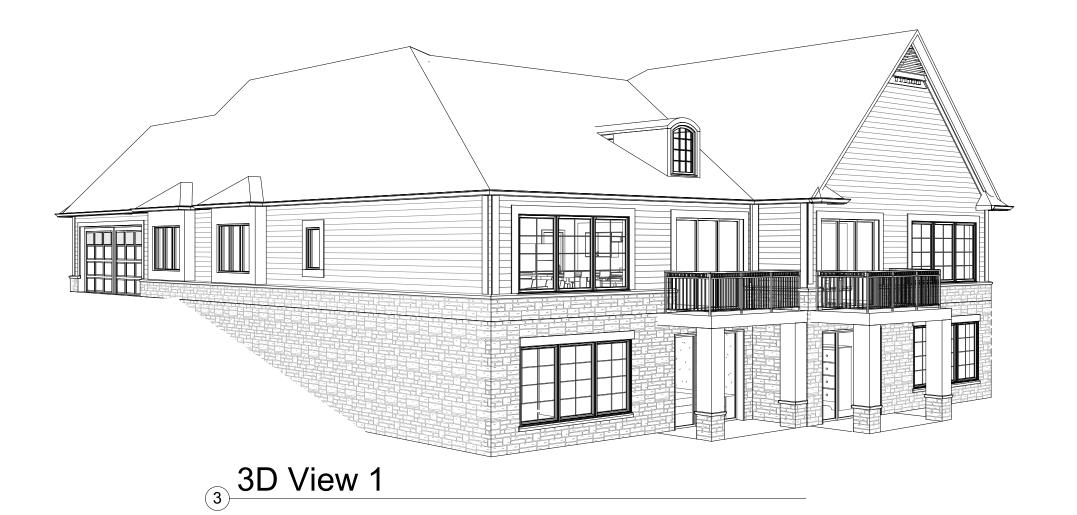



3D View 2

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MILE STONE DEVELOPMENT

PROJECT

THE TOWNHOMES ON MAPLEHILL


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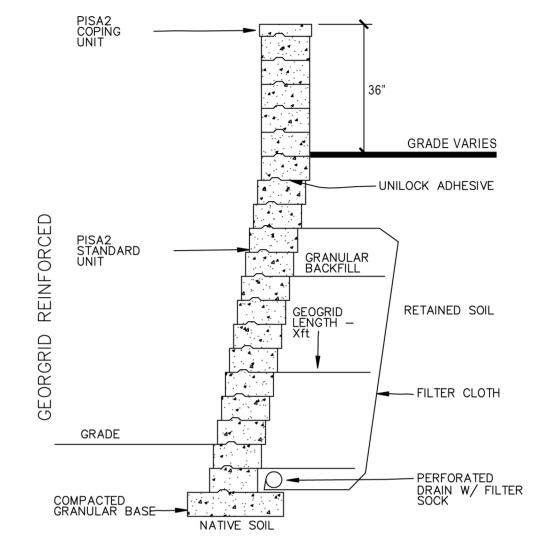
ROOF PLANS AND VIEWS OPTION B

SHEET NO.

STONES & BUNDLING	FACE FT/ BUNDLE	FACE FT/ UNIT	LIN FT/ BUNDLE	LIN FT/ UNIT	UNITS/ BUNDLE	UNITS/ FACE	SECTIONS/ BUNDLE	LBS/ UNIT		
STANDARD	20	0.67	40	1.33	30	1.5	2	85.6	Г	
TAPERED	20	0.67	40	1.33	30	1.5	2	76.8		
XL TAPERED *	21.34	0.67 *	42.67	1.33 *	32 *	1.5 *	_	72		
CORNER - DOUBLE UNIT	15	1.67	_	_	9	0.83	3	104.8	Г	
12" COPING **	21	0.25	84	2	42	4	2	64.6		
NOTES: *ALL XL TAPERED DATA IS BASED ON SPLIT UNITS. MAXIMUM HEIGHT -48" (UNDER OPTIMUM CONDITIONS). HIGHER WALLS CAN BE ACHIEVED USING GEOGRID REINFORCEMENT. TAPERED UNITS WILL ALLOW FOR A MINIMUM 5FT OUTSIDE RADIUS. XL TAPERED UNITS ALLOW FOR AN 8FT. OUTSIDE RADIUS. **12" COPING BUNDLE HAS 7 DOUBLE UNITS OF CLOSED-END COPING. ALL MEASUREMENTS ARE NOMINAL.										


UNILOCK, THROUGH RISI STONE SYSTEMS INTERNATIONAL, CAN PROVIDE PRELIMINARY SITE ENGINEERING FOR MOST COMMERCIAL PROJECTS. SOILS INFORMATION, SITE DRAWINGS AND LOADING REQUIREMENTS ARE SOME OF THE INFORMATION DETAILS REQUIRED IN ORDER TO PROVIDE THIS PRELIMINARY SITE ENGINEERING. CONTACT YOUR LOCAL UNILOCK REPRESENTATIVE FOR DETAILS. RETAINING WALL ENGINEERING SOFTWARE IS ALSO AVAILABLE FREE OF CHARGE AT UNILOCK.COM



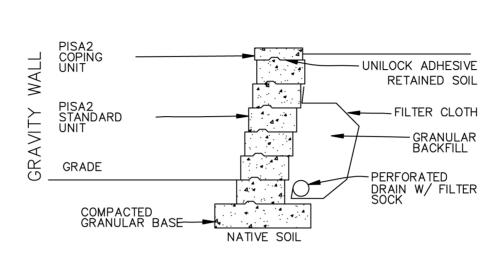

PRECAST GRAVITY RETAINING WALL DETAIL (UNILOCK PISA2) SCALE: 1/2" = 1'-0"

(ALL WALLS TO BE BUILT ON SUBJECT PROPERTY)

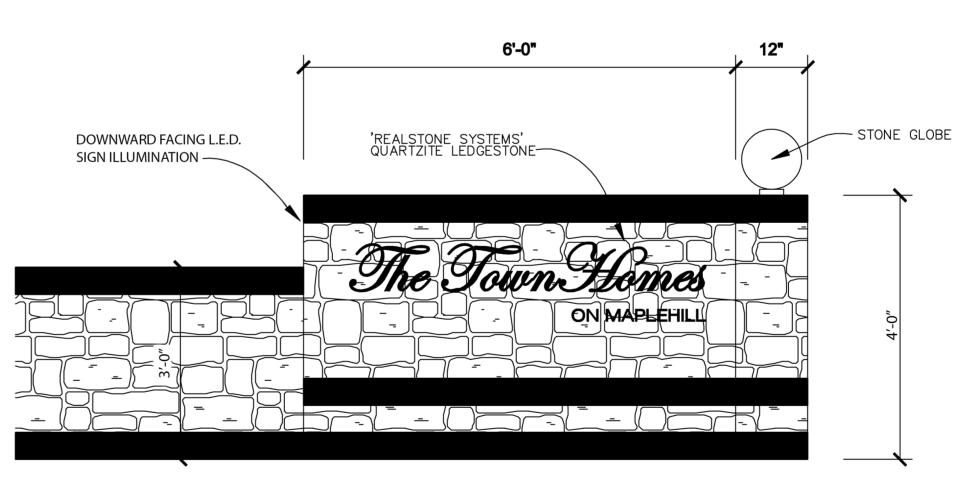

ENTRY SIGNAGE

SCALE: N.T.S.

2570

2570

2305

943

2714

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DRAWN **CHECKED** KDH

CLIENT MILESTONE DEVELOPMENT 1066 COMMERCE ST. BIRMINGHAM, MI

PROJECT THE TOWNHOMES ON MAPLEHILL A MULTIFAMILY DEVELOPMENT ROCHESTER HILLS, MI

1328

SHEET

SITE DETAILS



Scale
Not to Scale
Drawing No. 1 of 1



DETENTION BASIN SEED MIX

*CONTAINS AT LEAST 12 WILDFLOWERS AND 3 GRASSES WILDFLOWERS **GRASSES NEW ENGLAND ASTER BIG BLUESTEM** CANADA WILD RYE PALE INDIAN PLANTAIN BONESET DARK GREEN BULRUSH OX EYE SUNFLOWER INDIAN GRASS DENSE BLAZINGSTAR PRAIRIE CORD GRASS

GREAT BLUE LOBELIA CARDINAL FLOWER BERGAMOT (BEEBALM) YELLOW CONEFLOWER GREEN-HEADED CONEFLOWER BLACK-EYED SUSAN CUPPLANT OHIO GOLDENROD **BLUE VERVAIN**

CULVER'S ROOT IRONWEED

RECOMMENDED SEEDING RATE: 35 LBS/ACRE SEED MIX AVAILABLE:

NATIVESCAPE, LLC MANCHESTER, MI 48158 T 517.456.9696

OTHER TRADES, AND SHALL REPORT ANY UNACCEPTACBLE SITE CONDITIONS TO THE OWNER'S REPRESENTATIVE PRIOR TO COMMENCEMENT. 4. PLANTS SHALL BE FULL, WELL-BRANCHED, AND IN HEALTHY VIGOROUS

PLANTS SHALL BE WATERED BEFORE AND AFTER PLANTING IS COMPLETE. ALL TREES MUST BE STAKED, FERTILIZED AND MULCHED AND SHALL BE
 GUARANTEED TO EXHIBIT A NORMAL GROWTH CYCLE FOR AT LEAST ONE (1) YEAR FOLLOWING PLANTING.
ALL MATERIAL SHALL CONFORM TO THE GUIDELINES ESTABLISHED IN THE MOST

RECENT EDITION OF THE "AMERICAN STANDARDS FOR NURSERY STOCK". CONTRACTOR WILL SUPPLY FINISHED GRADE AND EXCAVATE AS NECESSARY TO SUPPLY PLANT MIX DEPTH IN ALL PLANTING BEDS AS INDICATED IN PLANT DETAILS AND A DEPTH OF 4" IN ALL LAWN AREAS.

PROVIDE CLEAN BACKFILL SOIL, USING MATERIAL STOCKPILED ON-SITE. SOIL SHALL BE SCREENED AND FREE OF DEBRIS, FOREIGN MATERIAL, AND STONE. 10. SLOW-RELEASE FERTILIZER SHALL BE ADDED TO THE PLANT PITS BEFORE BEING BACKFILLED. APPLICATION SHALL BE AT THE MANUFACTURERS RECOMMENDED

 AMENDED PLANT MIX (PREPARED TOPSOIL) SHALL CONSIST OF 1/3 SCREENED TOPSOIL,
 1/3 SAND, AND 1/3 "DAIRY DOO" COMPOST, MIXED WELL AND SPREAD TO A DEPTH AS INDICATED IN PLANTING DETAILS.

12. ALL PLANTINGS SHALL BE MULCHED WITH SHREDDED HARDWOOD BARK, SPREAD TO A DEPTH OF 3" FOR TREES AND SHRUBS, AND 2" ON ANNUALS, PERENNIALS, AND GROUNDCOVER PLANTINGS. MULCH SHALL BE FREE FROM DEBRIS AND FOREIGN

MATERIAL, AND PIECES ON INCONSISTENT SIZE. NO SUBSTITUTIONS OR CHANGES OF LOCATION, OR PLANT TYPE SHALL BE MADE
 WITHOUT THE APPROVAL OF THE LANDSCAPE ARCHITECT OR OWNERS REPRESENTATIVE. 14. THE LANDSCAPE ARCHITECT SHALL BE NOTIFIED OF ANY DISCREPANCIES BETWEEN

THE PLANS AND FIELD CONDITIONS PRIOR TO INSTALLATION 15. THE LANDSCAPE CONTRACTOR SHALL BE RESPONSIBLE FOR MAINTAINING ALL PLANT MATERIAL IN A VERTICAL CONDITION THROUGHOUT THE GUARANTEED PERIOD.

16. THE LANDSCAPE ARCHITECT OR OWNERS REPRESENTATIVE SHALL HAVE THE RIGHT TO REJECT ANY WORK OR MATERIAL THAT DOES NOT MEET THE REQUIREMENTS OF

THE PLANS AND/OR SPECIFICATIONS. THE LANDSCAPE CONTRACTOR SHALL SEED AND MULCH OR SOD (AS INDICATED ON PLANS) ALL AREAS DESIGNATED AS SUCH ON THE PLANS, THROUGHOUT THE CONTRACT LIMITS. FURTHER, THE CONTRACTOR SHALL BE RESPONSIBLE FOR RESTORING AREAS ISTURBED DURING CONSTRUCTION, NOT IN THE CONTRACT LIMITS, TO EQUAL OR GREATER CONDITION.

18. ALL LANDSCAPE AREAS SHALL HAVE PROPER DRAINAGE THAT PREVENTS EXCESSIVE WATER FROM PONDING ON LAWN AREAS OR AROUND TREES AND SHRUBS.

19. ALL LANDSCAPE AREAS SHALL BE IRRIGATED WITH AN AUTOMATIC UNDERGROUND

\$425/\$6,800 10' HT B&B FULL TO GROUND 10' HT B&B FULL TO GROUND \$425/\$5,100 \$425/\$8,075 10' HT B&B FULL TO GROUND Tilia americana 'Redr Redmond Linden 3" CAL B&B FULLY BRANCHED HEADS \$325/\$1,625 \$425/\$5,950 10' HT B&B **FULL TO GROUND**

DIIEEEI	R PLANTI	NCC			REPLACEMENT TOTAL:	\$43,475.00
KEY	QTY	BOTANICAL/COMMON NAME	SIZE	ROOT	COMMENT	UNIT/ TOTAL COST
TREES						
TO	64	Thuja occidentalis 'Techny' Mission Arborvitae	5-6' HT	B&B	MAINTAIN AS HEDGE	\$75/ \$4,800
MISCE	LLANEO	US PLANTINGS			BUFFER TOTAL:	\$4,800.00
KEY	QTY	BOTANICAL/COMMON NAME	SIZE	ROOT	COMMENT	UNIT/ TOTAL COST
TREES A	ND SHRUBS		100	59		
PC	11	Pyrus calleryana 'Cleveland Select' Cleveland Select Pear	2.5" CAL	B&B	FULLY BRANCHED HEADS	\$300/ \$3,300
AA	32	Aronia arbutifolia Red Chokeberry	36" HT	B&B	WELL-ROOTED	\$50/ \$1,600
DETEN	ITIONI DA	SIN PLANTINGS			MISC. TOTAL:	\$4,900.00
DETEN	IIION BA	SIIN FLAINIINGS				
KEY	QTY	BOTANICAL/COMMON NAME	SIZE	ROOT	COMMENT	UNIT/ TOTAL COST
TREES						
LS	6	<u>Liquidambar styraciflua</u> Sweet Gum	2.5" CAL	B&B	FULLY BRANCHED HEADS	\$300/ \$1,800
TC	4	Tsuga canadensis Canadian Hemlock	8' HT	B&B	FULL TO GROUND	\$400/\$1,600
CA	8	<u>Cornus alba</u> 'Baileyii' Red Twig Dogwood	30" HT	B&B	WELL-ROOTED	\$50/\$400
VC	9	Viburnum carlesii Koreanspice Viburnum	36" HT	B&B	WELL-ROOTED	\$50/ \$450
				•		

DETENTION BASIN TOTAL: \$4,250.00

GENERAL SEED NOTE:

ALL LAWN AREAS DESIGNATED TO BE SEEDED, SHALL BE HYDRO-SEEDED WITH SPECIFIED BLENDS, AND STABILIZED WITH WOOD CELLULOSE FIBER MULCH (2,000 LBS PER ACRE) . IN AREAS SUBJECT TO EROSION, SEEDED LAWN SHALL BE FURTHER STABILIZED WHERE NECESSARY WITH BIODEGRADABLE EROSION BLANKET AND STAKED UNTIL ESTABLISHED. ALL SEED SHALL BE APPLIED OVER A MINIMUM 3" PREPARED TOPSOIL, AND SHALL BE KEPT MOIST AND WATERED DAILY UNTIL ESTABLISHED.

SEEDING INSTALLATION SHALL OCCUR ONLY: SPRING: APRIL1 TO JUNE1 FALL: AUGUST 15 TO OCTOBER 15

TYPICAL SEEDED LAWN MIX:

ALL LAWN AREAS DESIGNATED TO BE SEEDED, SHALL BE HYDROSEEDED WITH TYPICAL DROUGHT TOLERANT, DURABLE BLENDED SEED MIX, AT A RATE OF 220 LBS PER ACRE MIX IS COMPRISED OF

> 30% NITE HAWK PERENNIAL RYE 30% KENTUCKY BLUEGRASS 20% CREEPING RED FESCUE 10% MERIT KENTUCKY BLUEGRASS 10% NEWPORT KENTUCKY BLUEGRASS

CITY OF ROCHESTER HILLS NOTES

1. PRIOR TO THE RELEASE OF THE PERFORMANCE BOND, THE CITY OF ROCHESTER HILLS LANDSCAPE ARCHITECT MUST INSPECT ALL LANDSCAPE PLANTINGS INCLUDING BUT NOT LIMITED TO EXISTING TREES, REPLACEMENT TREES, BUFFER PLANTINGS, AND PARKING LOT ISLANDS AND THE FORESTRY DIVISION MUST INSPECT ALL RIGHT-OF-WAYS TO IDENTIFY ANY PLANTINGS NEW OR EXISTING THAT POSE A HAZARD TO THE SAFE USE OF THE RIGHT-OF-WAY. FORESTRY MAY REQUIRE THE DEVELOPER TO REMOVE AND POSSIBLY

REPLACE ANY SUCH TREES. 2. ALL TREES AND SHRUBS MUST BE PLANTED AT LEAST 10' FROM THE EDGE OF A PUBLIC ROADWAY, SHADE TREES AND SHRUBS MUST BE PLANTED AT LEAST 5' FROM THE EDGE OF A PUBLIC WALKWAY. EVERGREEN AND ORNAMENTAL TREES MUST BE PLANTED AT LEAST 10' FROM THE EDGE OF A PUBLIC WALKWAY. ALL TREES AND SHRUBS MUST BE PLANTED AT LEAST 10' FROM ANY FIRE HYDRANT. SHADE AND EVERGREEN TREES MUST BE PLANTED AT LEAST 15' FROM THE NEAREST OVERHEAD WIRE AND AT LEAST 5' FROM THE NEAREST

UNDERGROUIND UTILITY. 3. NO TREE OR SHRUB MAY BE PLANTED WITHIN THE TRIANGULAR AREA FORMED AT THE INTERSECTION OF ANY STREET RIGHT-OF-WAY AT A DISTANCE OF 25' FROM THEIR POINT OF INTERSECTION. NO TREE OR SHRUB MAY BE PLANTED IN THE TRIANGULAR AREA FORMED AT THE INTERSECTION OF ANY DRIVEWAY WITH A PUBLIC SIDEWALK AT A DISTANCE ALONG EACH LINE OF 15' FROM THEIR POINT OF INTERSECTION

4. PRIOR APPROVAL IS REQUIRED TO PLANT ANY TREE OR SHRUB IN THE PUBLIC RIGHT-OF-WAY 5. NO SUBSTITUTIONS OR CHANGES OF LOCATION OR PLANT TYPES SHALL BE MADE WITHOUT THE APPROVAL OF THE DEVELOPER AND THE CITY OF ROCHESTER HILLS LANDSCAPE ARCHITECT. ${\it 6.}$ The Developer and/or the city of rochester Hills landscape architect shall have THE RIGHT, AT ANY STAGE OF THE INSTALLATION, TO REJECT ANY WORK OR MATERIAL THAT DOES NOT MEET THE REQUIREMENTS OF THE PLANS OR SPECIFICATIONS. 7. REPLACMENT TREES MAY NOT BE PLANTED WITHIN THE DRIP LINE OF EXISTING TREES. 8. TREES MUST BE AT LEAST 5' FROM UNDERGROUND UTILITIES AND 15' FROM OVERHEAD

IRRIGATION NOTE:

THE IRRIGATION PLAN WILL BE SUBMITTED AS A PART OF CONSTRUCTION PLAN REVIEW. ALL LANDSCAPE AREAS WILL BE IRRIGATED IN CONFORMANCE WITH THE CITY OF ROCHESTER HILLS REQUIREMENTS. WATERING WILL ONLY OCCUR BETWEEN THE HOURS OF 12 AM AND 5AM

GROUNDCOVER KEY

- \langle 1 \rangle restore disturbed areas W/ hydroseed and mulch
- $\langle 2 \rangle$ 4' DIA SPADE CUT EDGE W/3" SHREDDED BARK MULCH
- (3) 3" DEPTH DOUBLE SHREDDED HARDWOOD BARK MULCH
- 4 DETENTION BASIN SEED MIX SOWN AT 35 LBS/ACRE



COLLABORATIVE

CONSULTANTS 29110 INKSTER, SUITE 150

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CIVIL ENGINEERS LAND SURVEYORS LAND PLANNERS

NOWAK & FRAUS ENGINEERS 46777 WOODWARD AVE. PONTIAC, MI 48342-5032 TEL. (248) 332-7931 FAX. (248) 332-8257

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12.01.14	SITE	PLAN	REV.
2.12.15	SITE	PLAN	REV.
5.07.15	SITE	PLAN	REV.
8.27.15	SITE	PLAN	REV.

10.21.15 | SITE PLAN REV.

DRAWN G. Ostrowski CHECKED G. Ostrowski





MILESTONE DEVELOPMENT

29110 INKSTER RD

STE 150 SOUTHFIELD, MI 248.357.3600

PROIECT THE TOWNHOMES ON MAPLEHILL A MULTIFAMILY DEVELOPMENT

ROCHESTER HILLS, MI

JOB NO.

H845


SHEET LANDSCAPE PLAN

SHEET NO.







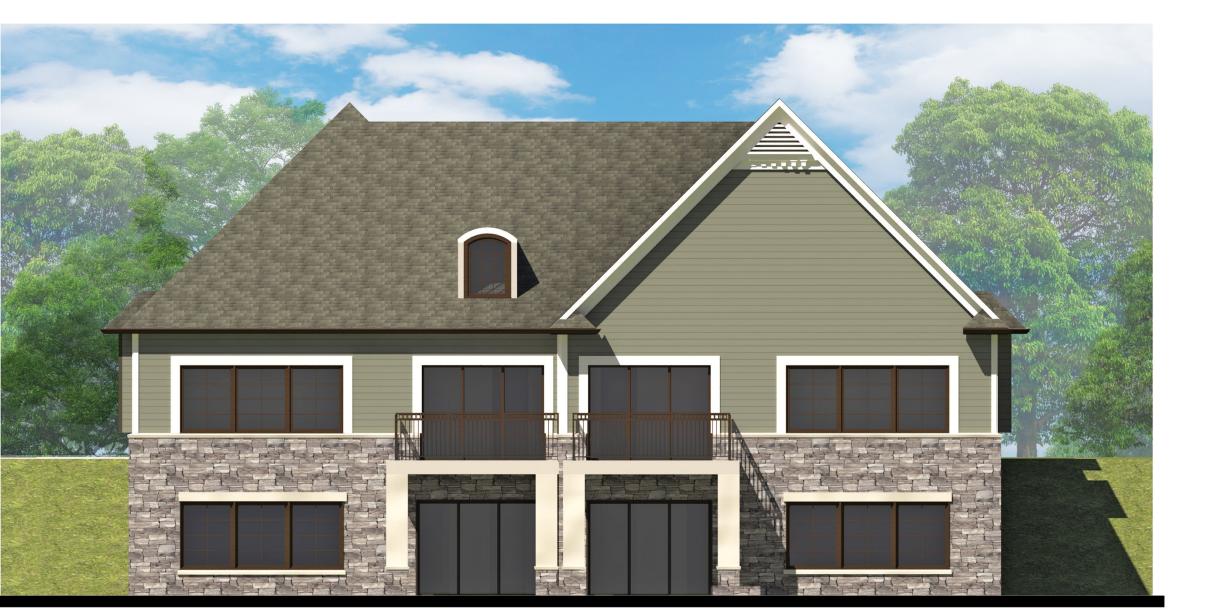



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A MULTIFAMILY DEVELOPMENT

ROCHESTER HILLS, MI

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